Robert Starkey

Nathan Dunlop

robert@aryze.ca 250.208.1996

Gregory Damant, Architect AIBC

greg@cascadiaarchitects.ca 250.590.3223

Bianca Bodley bianca@biophiliacollective.ca 250.590.1156

ndunlop@mcelhanney.com 778.746.7417

Revisions

Bubbled areas indicate revisions compared to the previously submitted plans

**Received Date:** 

July 26, 2022





## LIST OF DRAWINGS

ARCHITECTURAL

A-000	COVER

PERSPECTIVES A-009

A-010 PERSPECTIVE & WINDOW OVERLA CONTEXT ELEVATIONS & PERSPECTIVES

SHADOW STUDIES

SITE PLAN & PROJECT DATA ZONING CALCULATIONS

CODE REVIEW SPATIAL SEPARATION

LEVEL 1 PROPOSED PLAN LEVEL 2 PROPOSED PLAN

LEVEL 3 PROPOSED PLAN LEVEL 4 PROPOSED PLAN **EXTERIOR ELEVATIONS** 

**EXTERIOR ELEVATIONS BUILDING SECTIONS** 

CIVIL

## LANDSCAPE

C-1

TREE REMOVAL & PROTECTION PLAN

PRELIMINARY CIVIL PLAN

LANDSCAPE SITE PLAN TREE PLANTING PLAN

GROUND FLOOR PLANTING PLAN UPPER LEVEL PLANTING PLANS L-4

L-5 **DETAILS** 

PROJECT LOCATION PLAN (NTS)

PROJECT SITE (NTS)



1 BEECHWOOD ELEVATION PERSPECTIVE SCALE = 1:100



July 20, 2022 April 29, 2022 March 7, 2022 DATE DP/RZ Rev1 DP/RZ Submission Development Tracker Application DESCRIPTION

CASCADIA ARCHITECTS INC

Copyright reserved. These drawings and the design contained therein or which may be inferred therefrom are, and at all times remain, the exclusive property of Cascadia Architects Inc. Cascadia Architects holds the copyright and ownership in the said drawings, which cannot be used for any purpose without the express written consent of Cascadia Architects.

1733-1737 Fairfield Rd

PERSPECTIVES


JULY 20, 2022

2123

7/20/2022 4:44:44 PM





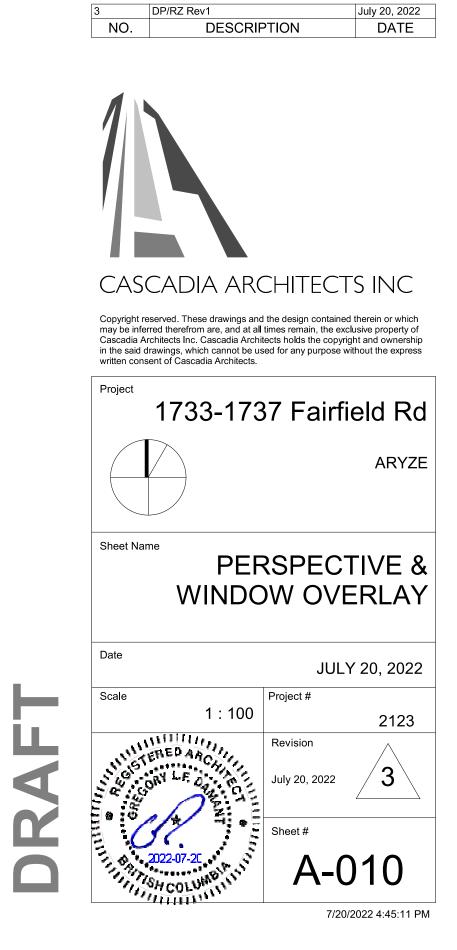







1 CONTEXT PERSPECTIVE FAIRFIELD ROAD
SCALE = 1:100


2 CONTEXT PERSPECTIVE BEECHWOOD AVE SCALE = 1:100



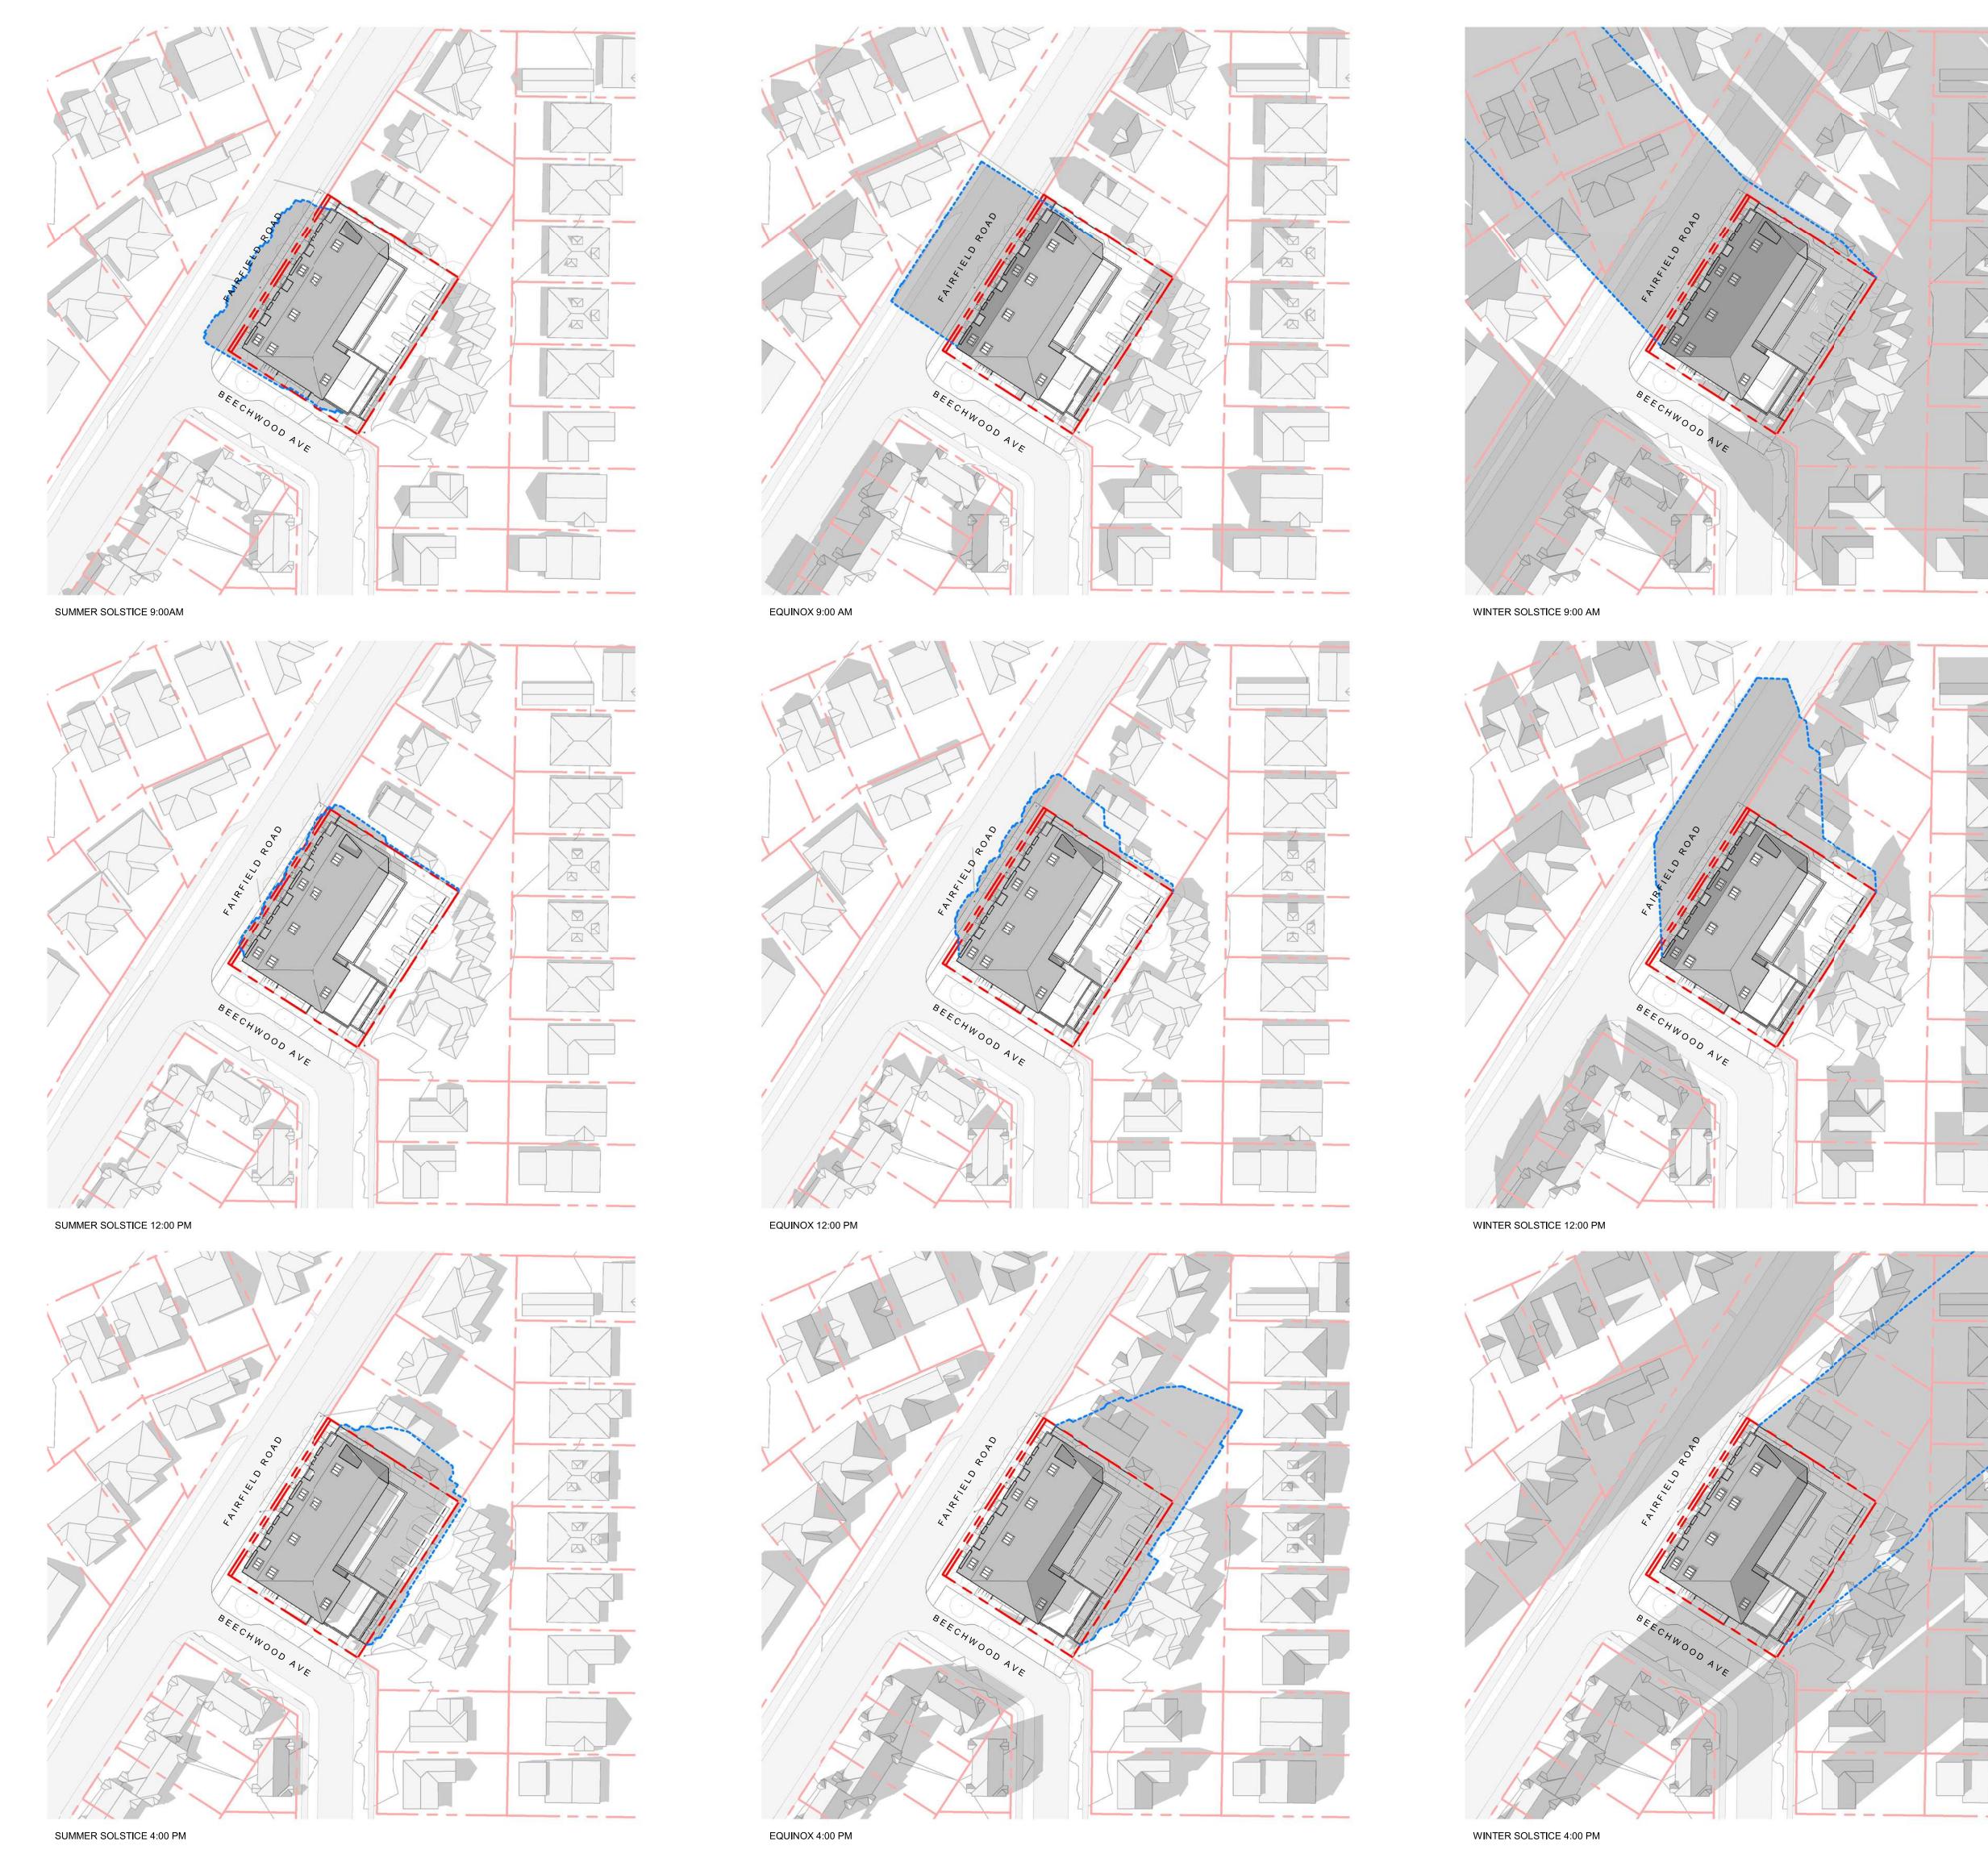



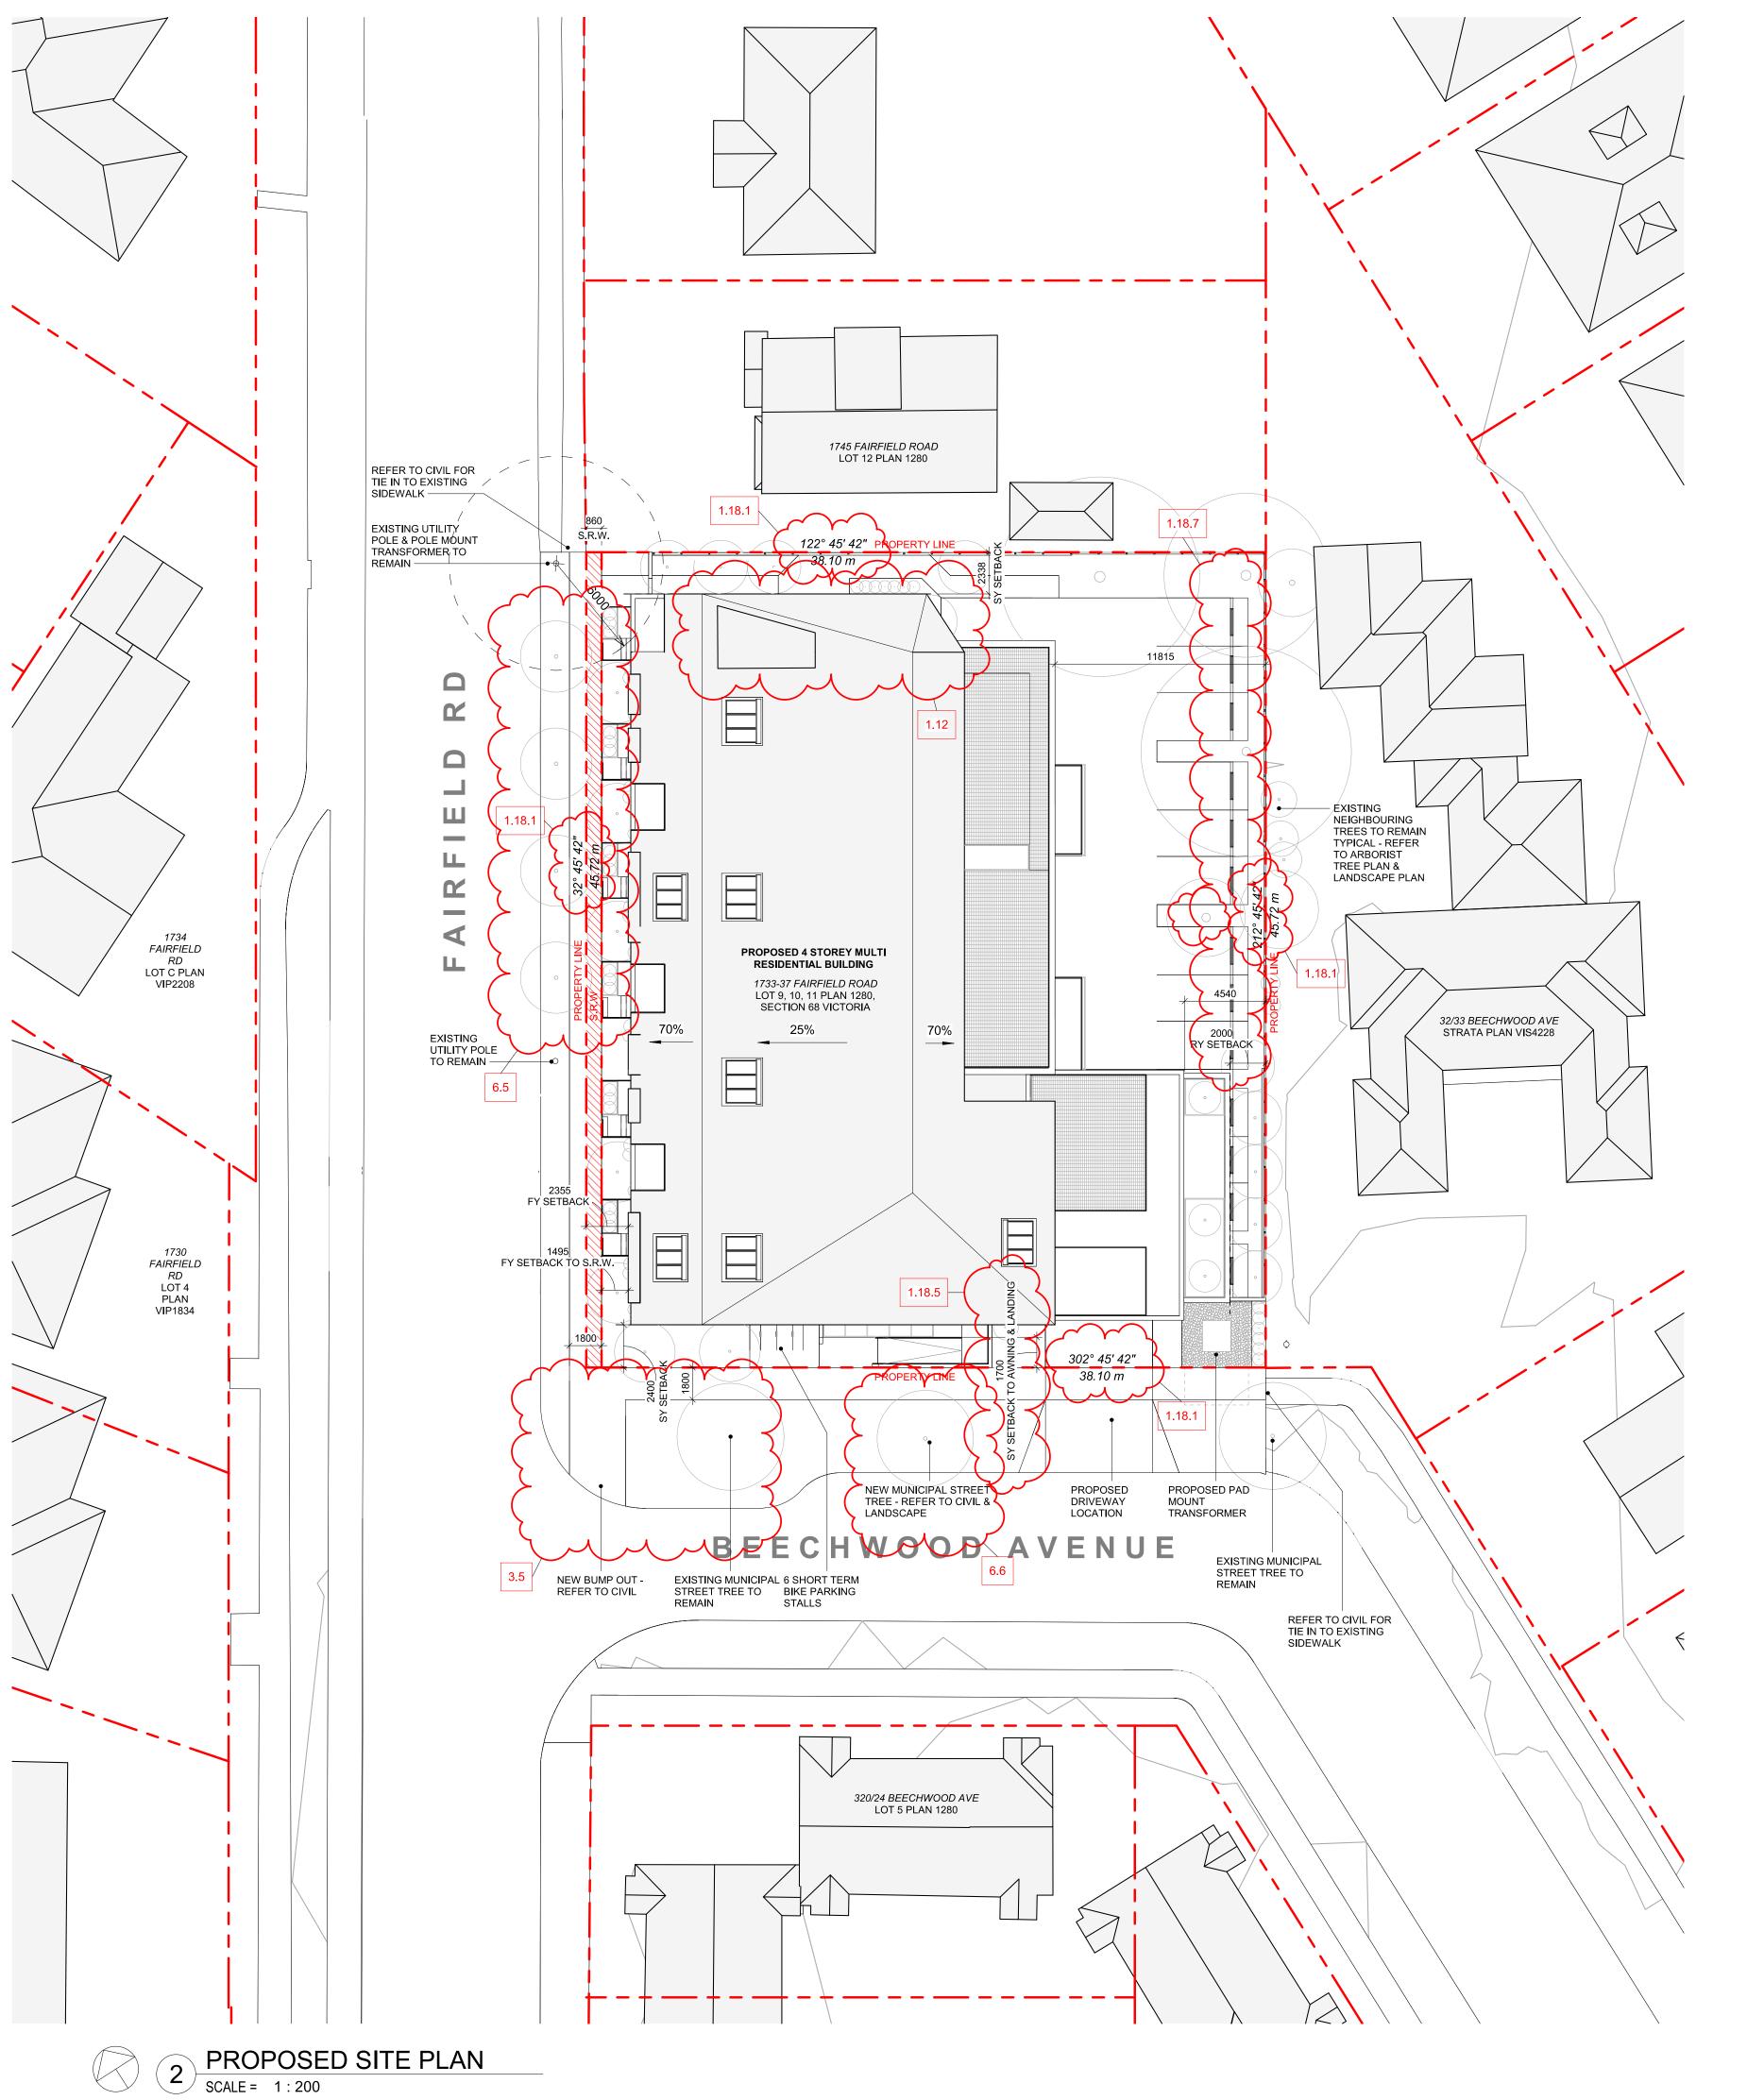


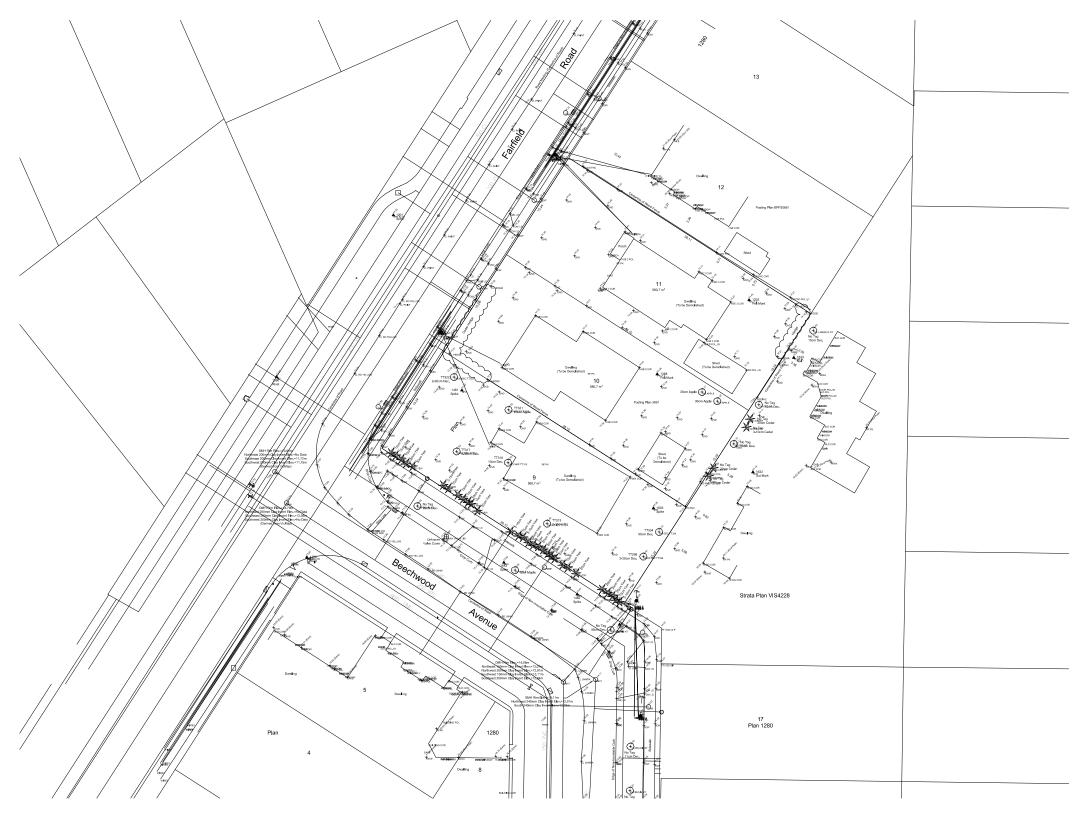

1 EXISTING SURVEY
SCALE = 1:500

DATA	
MUNICIPALITY	CITY OF VICTORIA
MUNICIPAL ADDRESS	1733-37 FAIRFIELD ROAD, VICTORIA BC
LEGAL DESCRIPTION	LOT 9, 10, 11, PLAN 1280, SECTION 68 VICTORIA
PROJECT DESCRIPTION	4 STOREY MULTI UNIT RESIDENTIAL BUILDING

ZONE (EXISTING)	R1-G
PROPOSED ZONE	UNKNOWN
SITE AREA (m²)	1,741.93m²
TOTAL FLOOR AREA (m²)	2931.43m <sup>2</sup> 1.12
COMMERCIAL FLOOR AREA (m²)	
FLOOR SPACE RATIO	1.67:1
SITE COVERAGE (%)	65%
OPEN SITE SPACE (%)	23%
HEIGHT (m)	14.45m
NUMBER OF STOREYS	4
	REQUIRED PROVIDED
PARKING STALLS (#) ON SITE	28 20
PARKING STALLS - VISITOR (#) ON SITE	2 2
BICYCLE PARKING (#) SHORT TERM	6
BICYCLE PARKING (#) LONG TERM	24 30
BUILDING SETBACKS (m)	
FRONT YARD	2.36m
REAR YARD (TO BALCONY) 1.18.5	2.00m
REAR YARD (TO BUILDING FACE)	4.54m
INTERNAL SIDE YARD	2.34m
SIDE YARD (TO AWNING/LANDING)	1.70m
SIDE YARD (TO BUILDING FACE)	2.40m
SIDE YARD (TO BUILDING FACE)  COMBINED SIDE YARDS	2.40m 4.74m
COMBINED SIDE YARDS	
COMBINED SIDE YARDS  RESIDENTIAL USE DETAILS	4.74m 19 3BD+DEN(1), 3BD(1), 2BD(11)
COMBINED SIDE YARDS  RESIDENTIAL USE DETAILS  TOTAL NUMBER OF UNITS	4.74m 19 3BD+DEN(1), 3BD(1), 2BD(11)
COMBINED SIDE YARDS  RESIDENTIAL USE DETAILS  TOTAL NUMBER OF UNITS  UNIT TYPE	4.74m 19 3BD+DEN(1), 3BD(1), 2BD(11) 2BD+DEN(1), 1 BD(1), 1BD +D

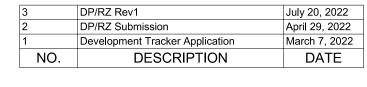




Copyright reserved. These drawings and the design contained therein or which may be inferred therefrom are, and at all times remain, the exclusive property of Cascadia Architects Inc. Cascadia Architects holds the copyright and ownership in the said drawings, which cannot be used for any purpose without the express written consent of Cascadia Architects.

1733-1737 Fairfield Rd

ARYZE

SITE PLAN & PROJECT DATA

JULY 20, 2022

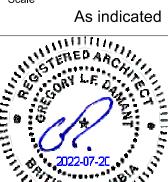

2123 July 20, 2022




POINT NAME	NATURAL	PROPOSED	DISTANCE BET	WEEN POINTS	AVE. OF POINTS
Α	14.209	14.42	Point A & B	10.207	144.73
В	14.422	14.15	Point B & C	1.072	15.15
C	14.393	14.11	Point C & D	3.143	44.24
D	14.04	14.75	Point D & E	1.7	23.83
E	13.995	14.09	Point E & F	6.4	89.95
F	14.238	14.11	Point F & G	3.2	45.62
G	14.397	14.44	Point G & H	10.809	154.46
Н	14.183	14.39	Point H & I	0.403	5.72
1	14.194	14.28	Point I & J	2.541	36.18
J	14.345	14.28	Point J & K	12.88	184.17
K	14.315	14.41	Point K & L	13.503	194.09
L	14.432	14.72	Point L & M	5.7	82.06
M	14.362	14.69	Point M & N	0.905	12.99
N	14.344	14.67	Point N & O	12.159	173.53
0	14.199	14.64	Point O & S	6.114	87.00
S	14.259	14.76	Point S & T	2.904	41.34
Т	14.209	14.76	Point T & U	5.629	80.18
U	14.279	14.75	Point U & V	0.319	4.56
V	14.287	14.75	Point V & W	9.885	141.83
W	14.408	14.64	Point W & X	0.4	5.77
Х	14.417	14.64	Point X & Y	2.14	30.88
Y	14.447	14.61	Point Y & Z	2.96	42.72
Z	14.421	14.57	Point Z & A1	2.14	30.86
A1	14.419	14.70	Point A1 & A2	3.554	51.15
A2	14.365	14.75	Point A2 & A3	2.14	30.68
A3	14.311	14.54	Point A3 & A4	3.14	45.03
A4	14.371	14.52	Point A4 & A5	2.14	30.73
A5	14.348	14.75	Point A5 & A6	3.545	51.00
A6	14.425	14.75	Point A6 & A7	2.14	30.79
A7	14.352	14.49	Point A7 & A8	3.13	44.93
A8	14.359	14.47	Point A8 & A9	2.14	30.90
A9	14.523	14.75	Point A9 & A10	3.54	51.48
A10	14.56	14.75	Point A10 & A11	2.14	30.98
A11	14.393	14.43	Point A11 & A12	3.125	44.90
A12	14.345	14.44	Point A12 & A13	2.142	30.96
A13	14.562	14.75	Point A13 & A14	3.545	51.50
A14	14.491	14.75	Point A14 & A15	2.142	30.84
A15	14.306	14.34	Point A15 & A16	3.15	44.96
A16	14.242	14.31	Point A16 & A17	2.14	30.59
A17	14.344	14.75	Point A17 & A18	3.507	50.20
A18	14.287	14.75	Point A18 & A19	3	42.72
A19	14.193	14.26	Point A19 & A20	3.145	44.60
A20	14.171	14.20	Point A20 & A21	3.00	42.72
A21	14.301	14.75	Point A21 & A	3.534	50.74

Average Grade


177.15

14.31


2534.26

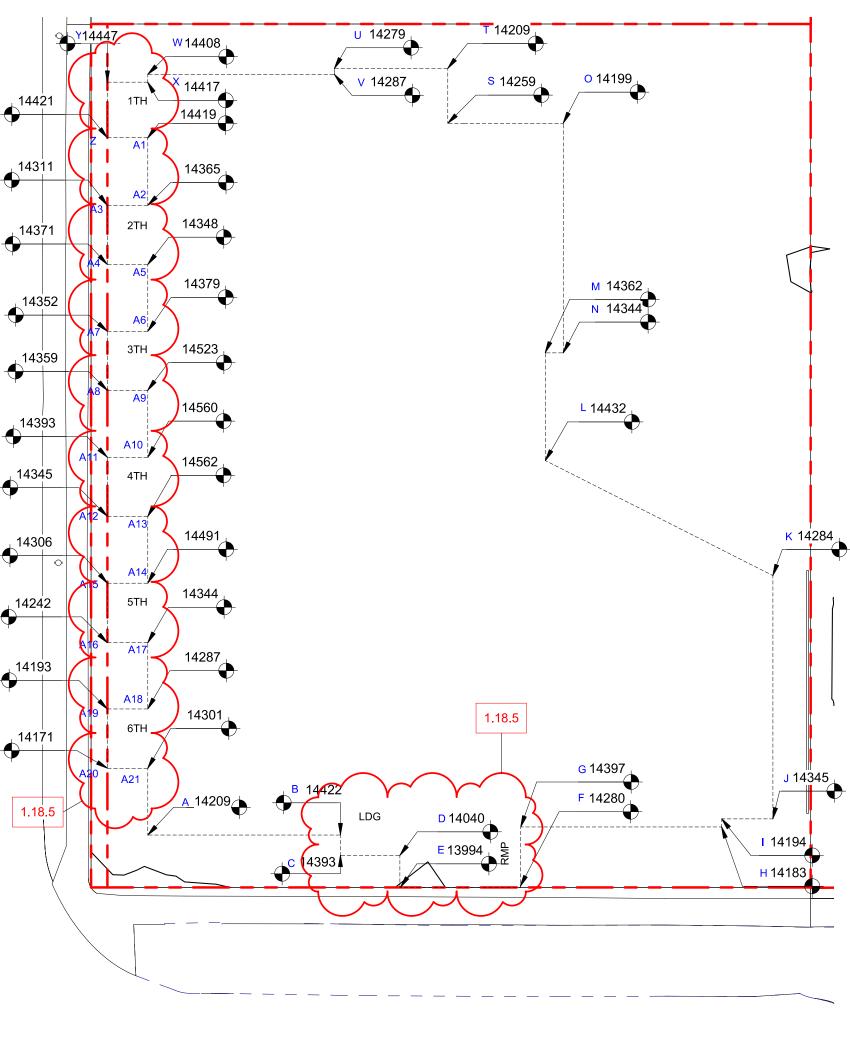


2 NATURAL GRADE KEY PLAN
SCALE = 1:200

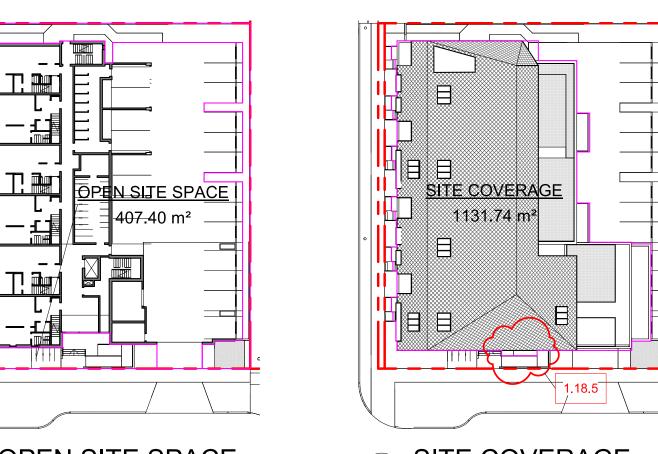




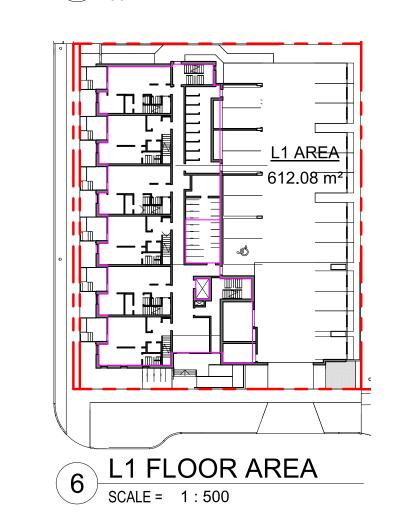

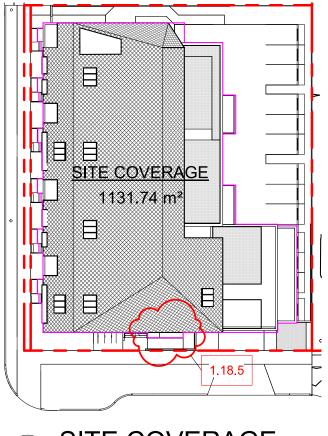


SITE COVERAGE


SCALE = 1:500

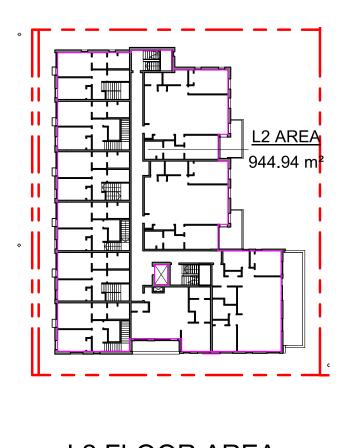



7 L2 FLOOR AREA SCALE = 1:500

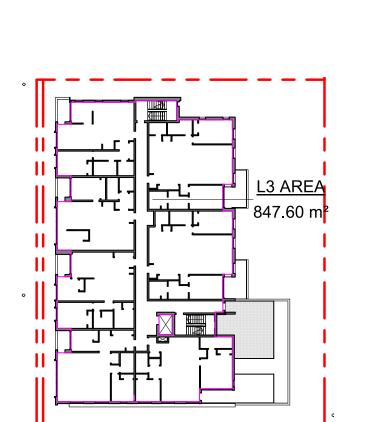

8 L3 FLOOR AREA SCALE = 1:500

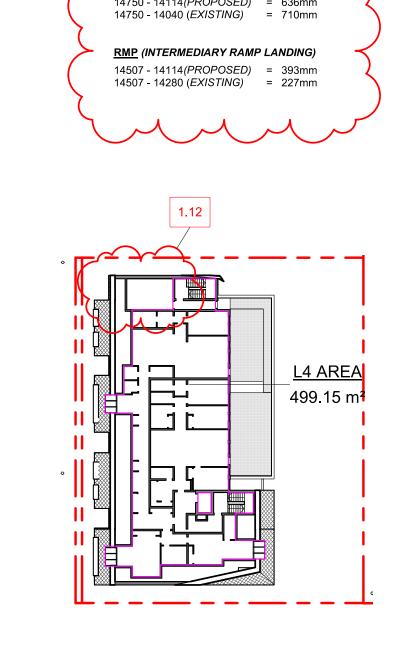

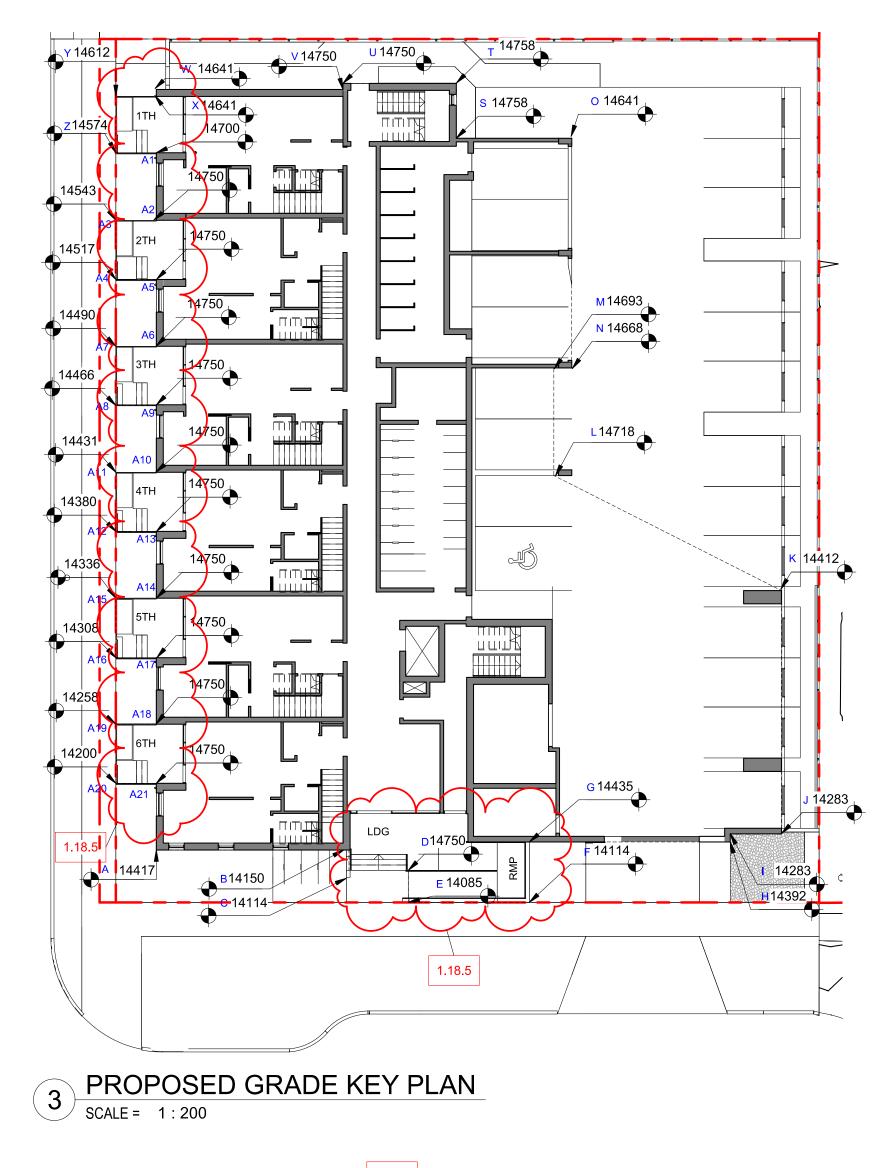

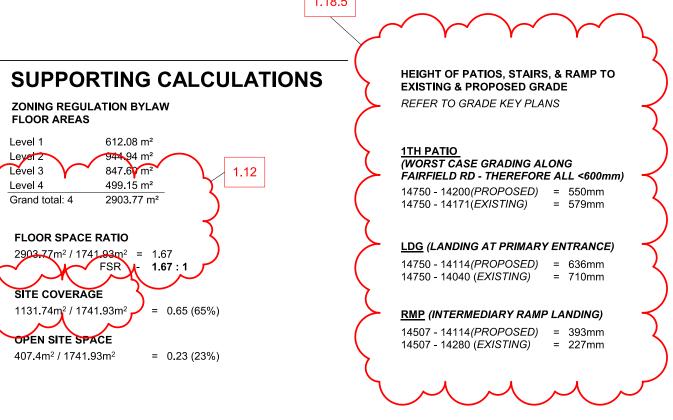

9 L4 FLOOR AREA SCALE = 1:500

3	DP/RZ Rev1	July 20, 2022
2	DP/RZ Submission	April 29, 2022
1	Development Tracker Application	March 7, 2022
NO.	DESCRIPTION	DATE



Copyright reserved. These drawings and the design contained therein or which may be inferred therefrom are, and at all times remain, the exclusive property of Cascadia Architects Inc. Cascadia Architects holds the copyright and ownership in the said drawings, which cannot be used for any purpose without the express written consent of Cascadia Architects.

1733-1737 Fairfield Rd


ARYZE

**ZONING CALCULATIONS** 

JULY 20, 2022 As indicated 2123

July 20, 2022

7/20/2022 4:46:28 PM

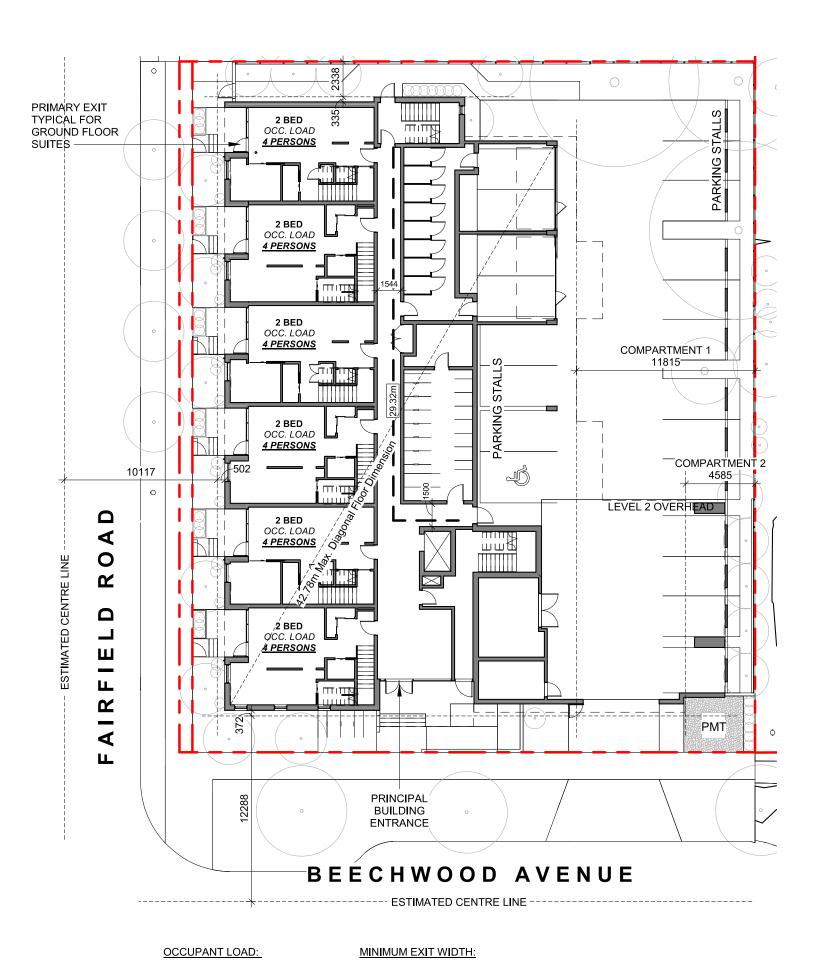


Occupancy: Group C
12 Bedrooms x 2 persons/bedroom = 24 persons

MINIMUM EXIT WIDTH: Ramps, Corridors, Passageways
the greater of 6.1mm x 24 = 146.4mm
or 1100mm (minimum 1500mm for accessible path of travel)

Stairs
the greater of 8mm x 24 = 192.0mm
or 1100mm

## 1 L1 CODE REVIEW KEY PLAN SCALE = 1:250

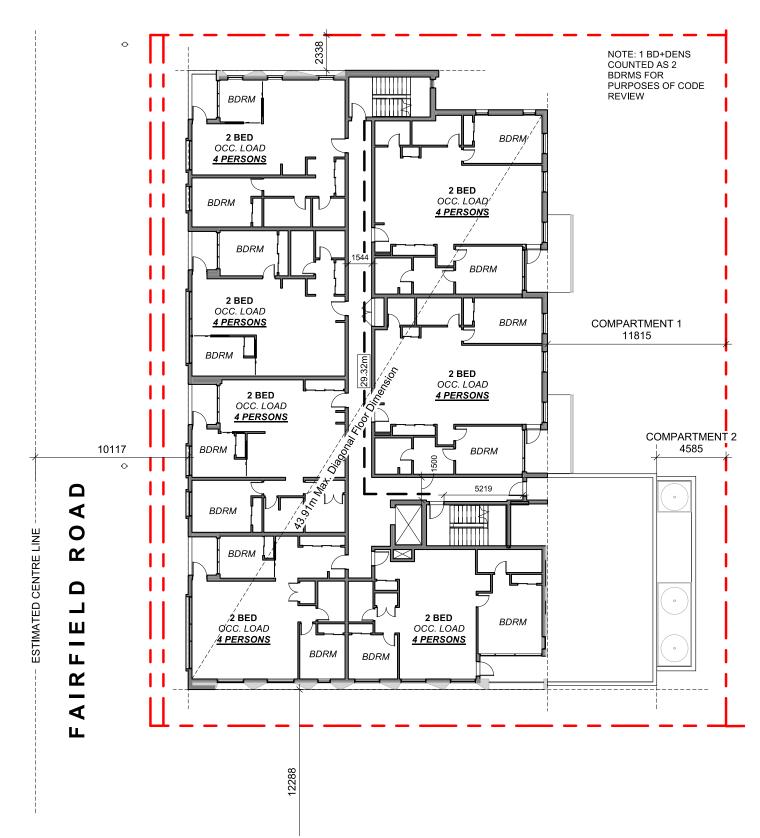


## BEECHWOOD AVENUE

----- ESTIMATED CENTRE LINE

OCCUPANT LOAD: MINIMUM EXIT WIDTH: Occupancy: Group C
14 Bedrooms x 2 persons/bedroom = 28 persons

Ramps, Corridors, Passageways the greater of 6.1mm x 28 = 170.8mm the greater of 8mm x 28 = 224.0mm or 1100mm (minimum 1500mm for or 1100mm accessible path of travel)

3 L3 CODE REVIEW KEY PLAN
SCALE = 1:250

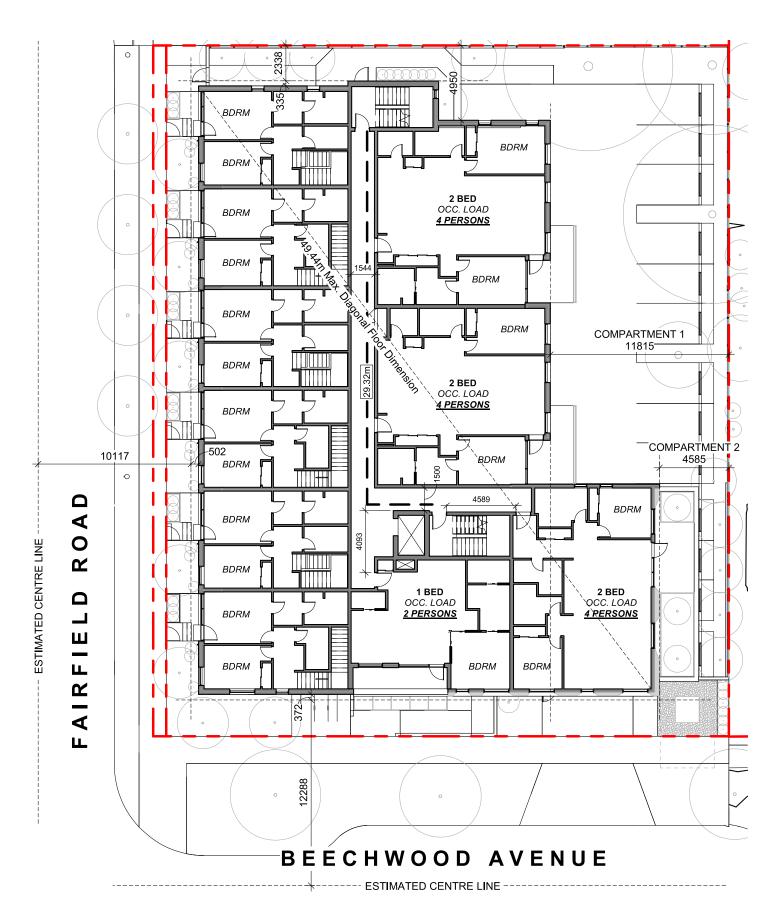


OCCUPANT LOAD: Occupancy: Group C 7 Bedrooms x 2 persons/bedroom

= 14 persons

MINIMUM EXIT WIDTH: accessible path of travel)

Ramps, Corridors, Passageways
the greater of 6.1mm x 14 = 85.4mm
or 1100mm (minimum 1500mm for or 1100mm

## 2 L2 CODE REVIEW KEY PLAN SCALE = 1:250

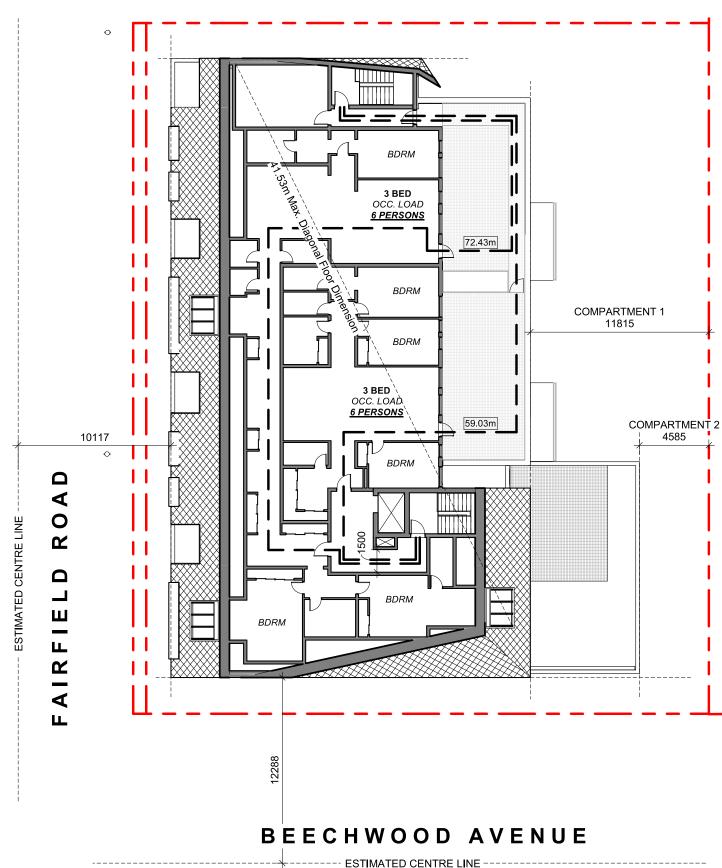

------ ESTIMATED CENTRE LINE -

OCCUPANT LOAD: Occupancy: Group C
6 Bedrooms x 2 persons/bedroom = 12 persons

MINIMUM EXIT WIDTH: Ramps, Corridors, Passageways
the greater of 6.1mm x 12 = 73.2mm

Stairs
the greater of 8mm x 12 = 96mm or 1100mm (minimum 1500mm for accessible path of travel)

L4 CODE REVIEW KEY PLAN SCALE = 1:250

### **BUILDING CODE ANALYSIS**

PROJECT TYPE	NEW CONSTRUCTION RENOVATION ADDITIO	N
GOVERNING BUILDING CODE	2018 BC BUILDING CODE	
MAJOR OCCUPANCY	A1 A2 A3 A4 B1 B2 B3 C D E F1 F2 F3	3.1.2.1
BUILDING AREA	I05I m <sup>2</sup> (approx)	1.4.1.2
GRADE	I8.75 m geodetic	1.4.1.2
BUILDING HEIGHT (STOREYS)	4 STOREYS ABOVE GRADE  0 STOREYS BELOW GRADE	1.4.1.2

### **BUILDING FIRE SAFETY & CONSTRUCTION CLASSIFICATION**

CLASSIFICATION	GROUP C, UP TO 4 STOREYS, SPRINKLERED	3.2.2.51
MAXIMUM BUILDING AREA	1800 m <sup>2</sup>	3.2.2.51
No. OF STREETS FACING	I (BEECHWOOD AVE UNDER 9M MINIMUM STREET WIDTH)	3.2.2.10
CONSTRUCTION TYPES PERMITTED	✓ COMBUSTIBLE NON-COMBUSTIBLE	3.2.2.51
FIRE ALARM SYSTEM	YES NO	3.2.4.1
STANDPIPE SYSTEM	YES NO	3.2.5.8
HIGH BUILDING	YES NO	3.2.6.1
INTERCONNECTED FLOOR SPACE	YES NO EXCEPT WITHIN AT GRADE RESIDENTIAL UNITS	3.2.8

#### FIRE RESISTANCE RATINGS


HORIZONTAL SEPARATIONS	I hr FLOORS I hr MEZZANINE Unrated ROOF	3.2.2.51
LOADBEARING WALLS, COLUMNS & ARCHES	I hr (NOT LESS THAN THAT REQUIRED FOR SUPPORTED STRUCTURE)	3.2.2.51
EXITS	I hr	3.4.4.1

#### **EXITS FROM FLOOR AREAS**

NUMBER OF EXITS REQUIRED	2	3.4.2.1
SEPARATION OF EXITS (MIN.)	1/2 MAX. DIAGONAL FLOOR AREA, BUT NEED NOT BE > 9 m	3.4.2.3
MAX. TRAVEL DISTANCE ALLOWED	m, GROUP C	3.4.2.5
MEZZANINE	YES NO	3.2.8




- - - - - - UNRATED FIRE SEPERATIONS **—----** 1.5 HOUR •••••••• 2 HOUR

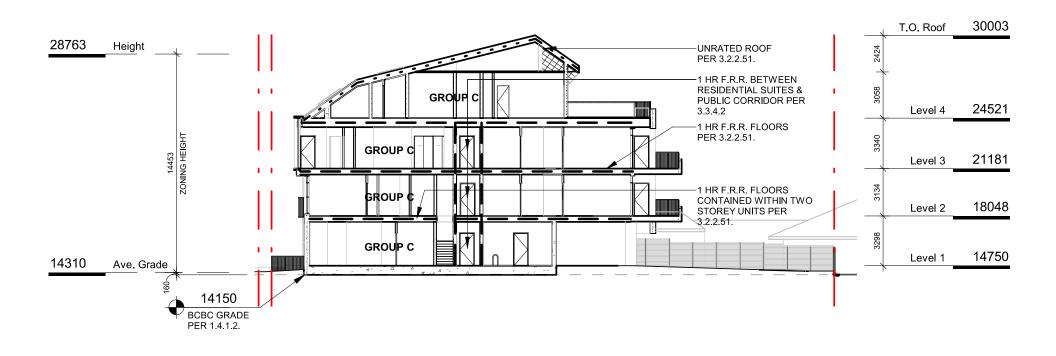

5 CODE REVIEW KEY SECTION

SCALE = 1:250

April 29, 2022 DATE DESCRIPTION

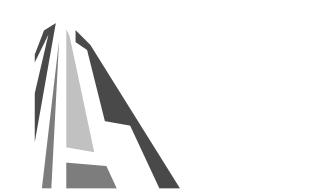

CASCADIA ARCHITECTS INC

Copyright reserved. These drawings and the design contained therein or which may be inferred therefrom are, and at all times remain, the exclusive property of Cascadia Architects Inc. Cascadia Architects holds the copyright and ownership in the said drawings, which cannot be used for any purpose without the express written consent of Cascadia Architects.

1733-1737 Fairfield Rd

**CODE REVIEW** 


As indicated

2123 April 29, 2022


JULY 20, 2022

7/20/2022 4:46:37 PM

ARYZE

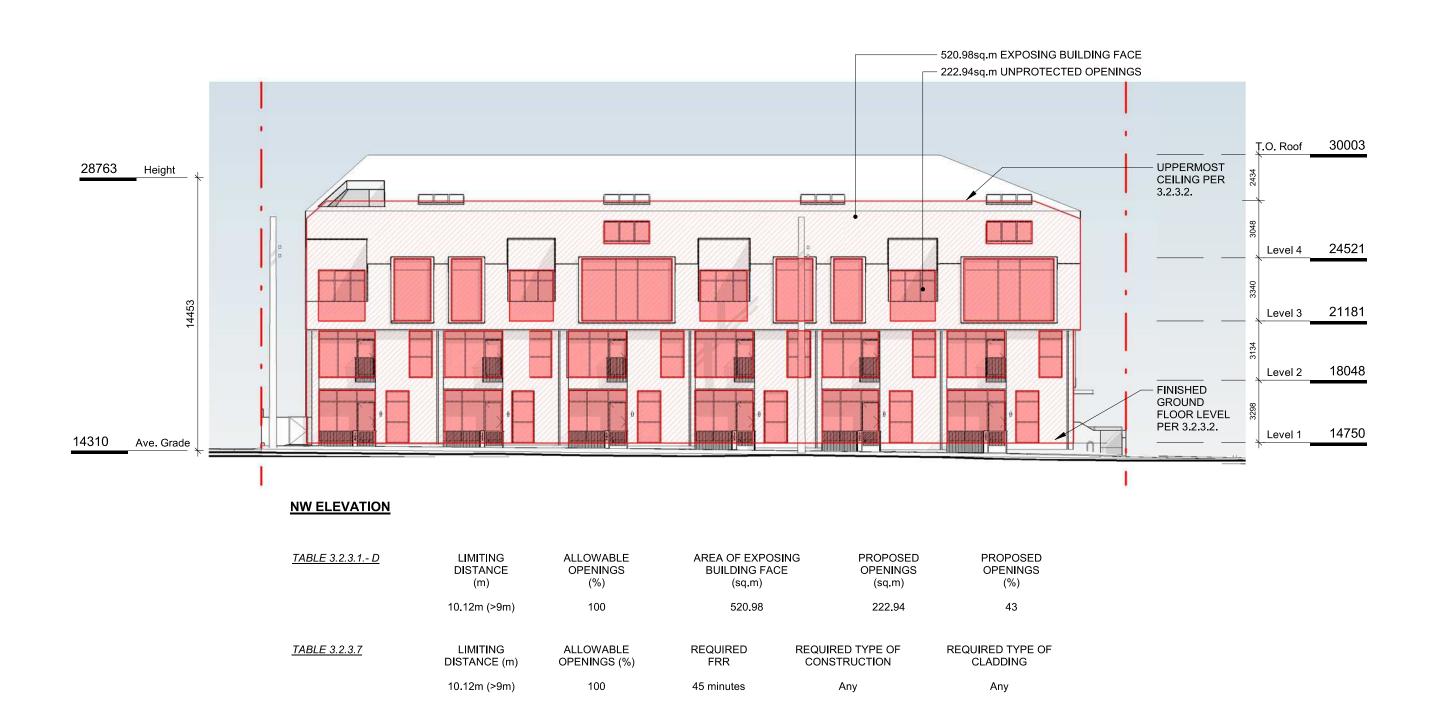


1 NW ELEVATION - LD KEY
SCALE = 1:200

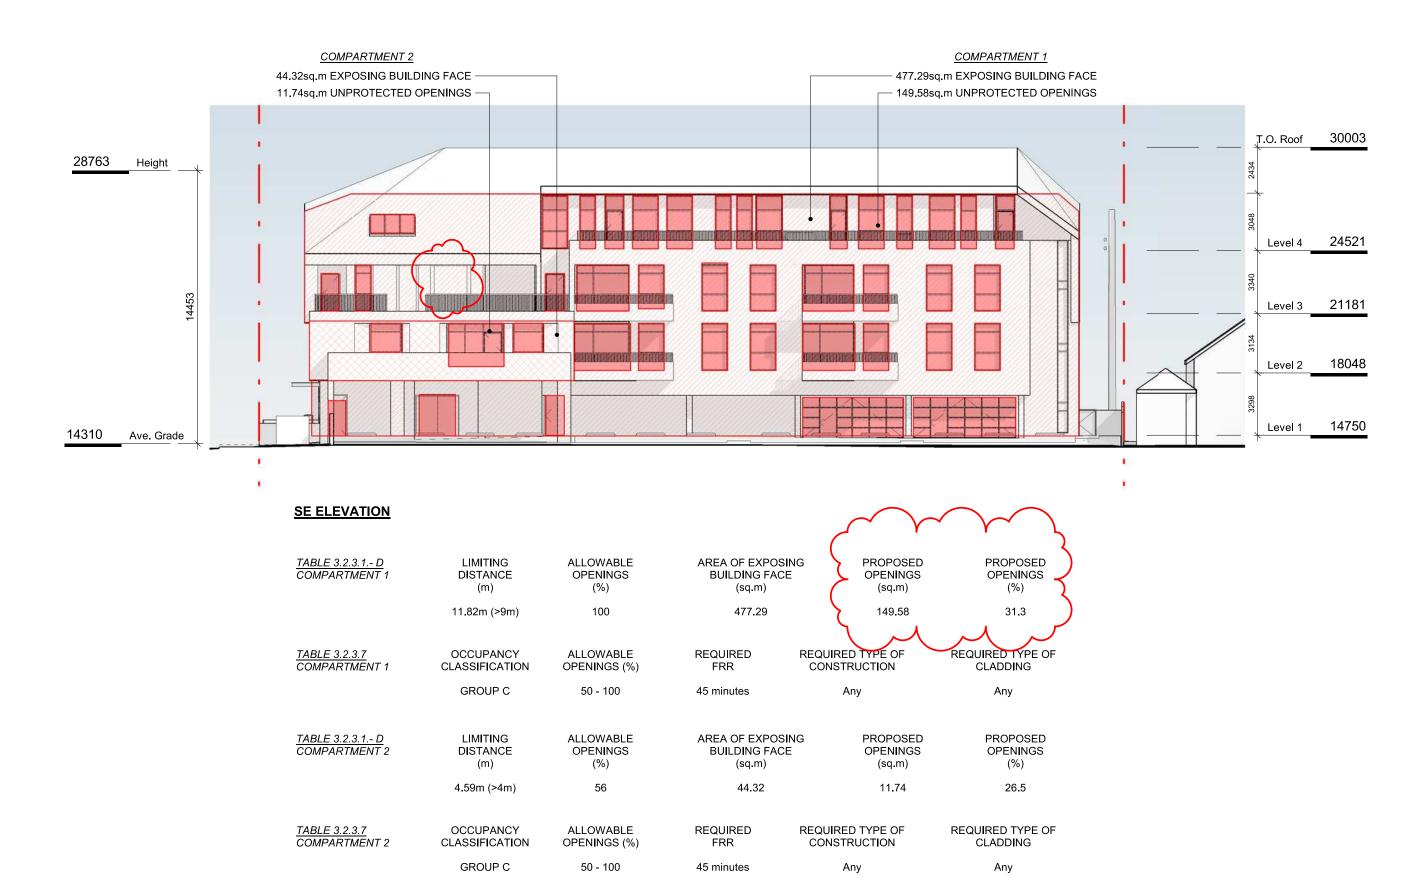


SE ELEVATION - LD KEY

SCALE = 1:200

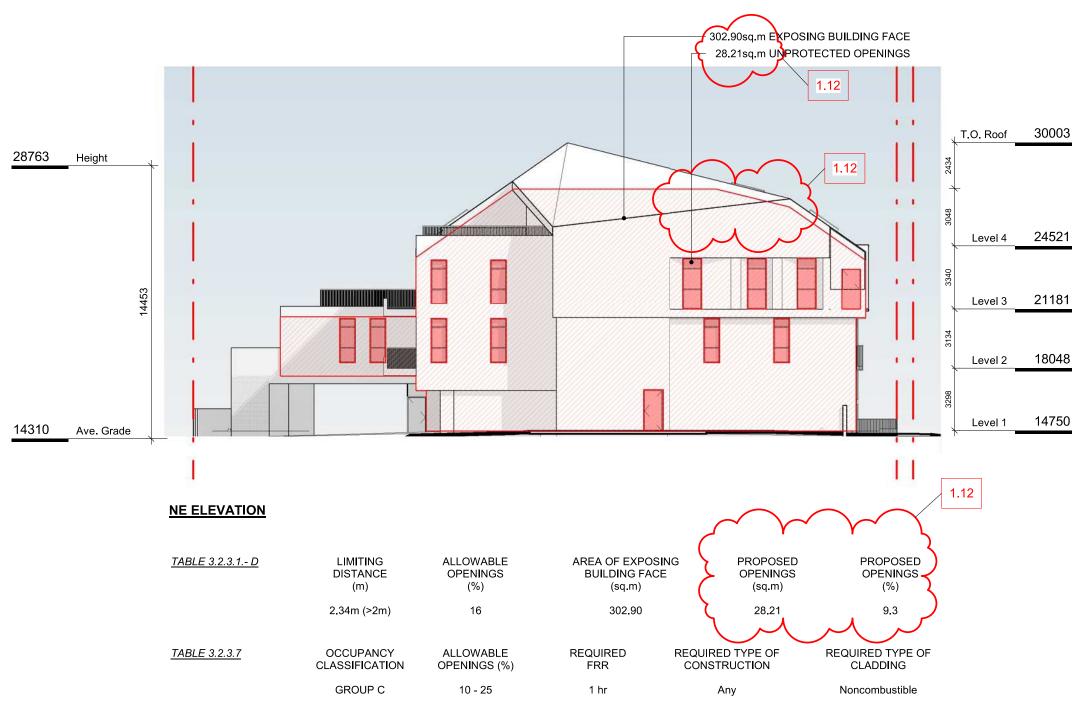

2 NE ELEVATION - LD KEY
SCALE = 1:200

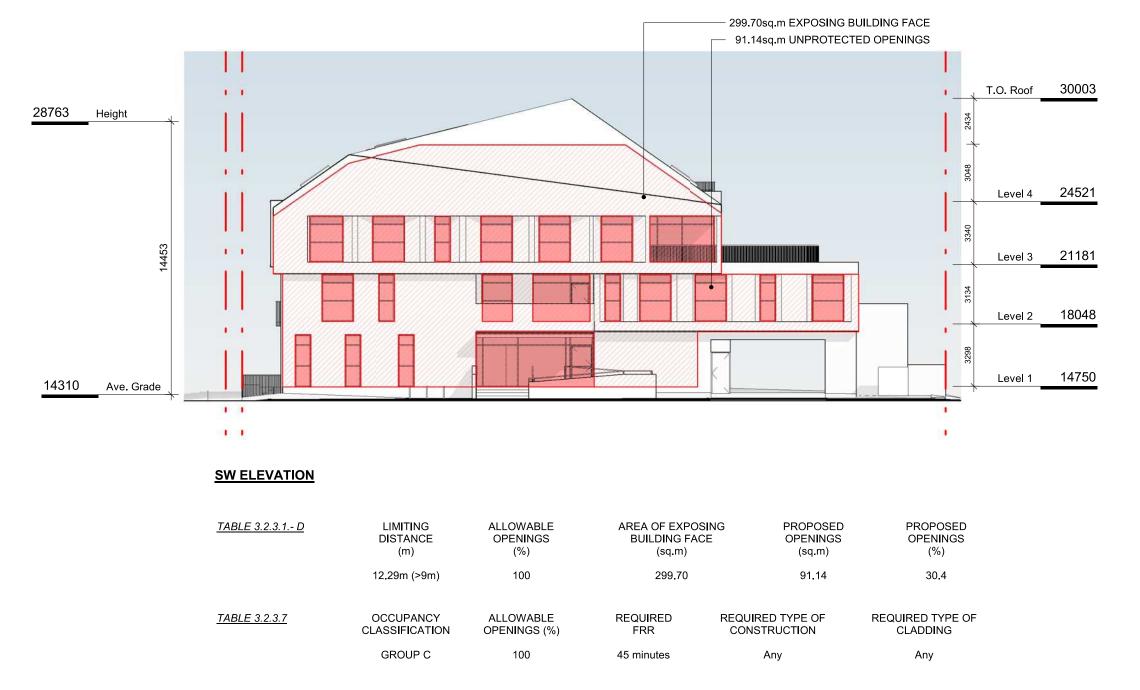

3 SW ELEVATION - LD KEY
SCALE = 1:200



DP/RZ Rev1 DP/RZ Submission


DESCRIPTION

NO.

July 20, 2022 April 29, 2022

DATE



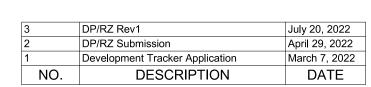



Copyright reserved. These drawings and the design contained therein or which may be inferred therefrom are, and at all times remain, the exclusive property of Cascadia Architects Inc. Cascadia Architects holds the copyright and ownership in the said drawings, which cannot be used for any purpose without the express written consent of Cascadia Architects.


1733-1737 Fairfield Rd

ARYZE

LEVEL 1 PROPOSED

PLAN

JULY 20, 2022

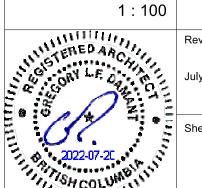

A-101

7/20/2022 4:47:26 PM

2123



April 29, 2022 March 7, 2022 DATE DP/RZ Submission Development Tracker Application NO. DESCRIPTION



CASCADIA ARCHITECTS INC

Copyright reserved. These drawings and the design contained therein or which may be inferred therefrom are, and at all times remain, the exclusive property of Cascadia Architects Inc. Cascadia Architects holds the copyright and ownership in the said drawings, which cannot be used for any purpose without the express written consent of Cascadia Architects.


1733-1737 Fairfield Rd

ARYZE

2123

LEVEL 2 PROPOSED PLAN


JULY 20, 2022

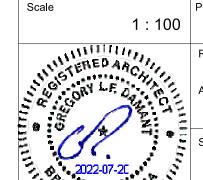

April 29, 2022

7/20/2022 4:47:38 PM



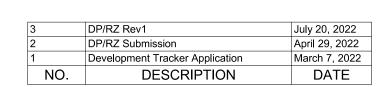




Copyright reserved. These drawings and the design contained therein or which may be inferred therefrom are, and at all times remain, the exclusive property of Cascadia Architects Inc. Cascadia Architects holds the copyright and ownership in the said drawings, which cannot be used for any purpose without the express written consent of Cascadia Architects.

1733-1737 Fairfield Rd

LEVEL 3 PROPOSED PLAN


JULY 20, 2022

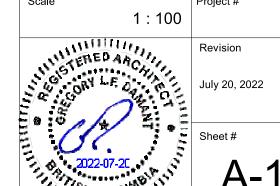


7/20/2022 4:47:45 PM

2123

ARYZE

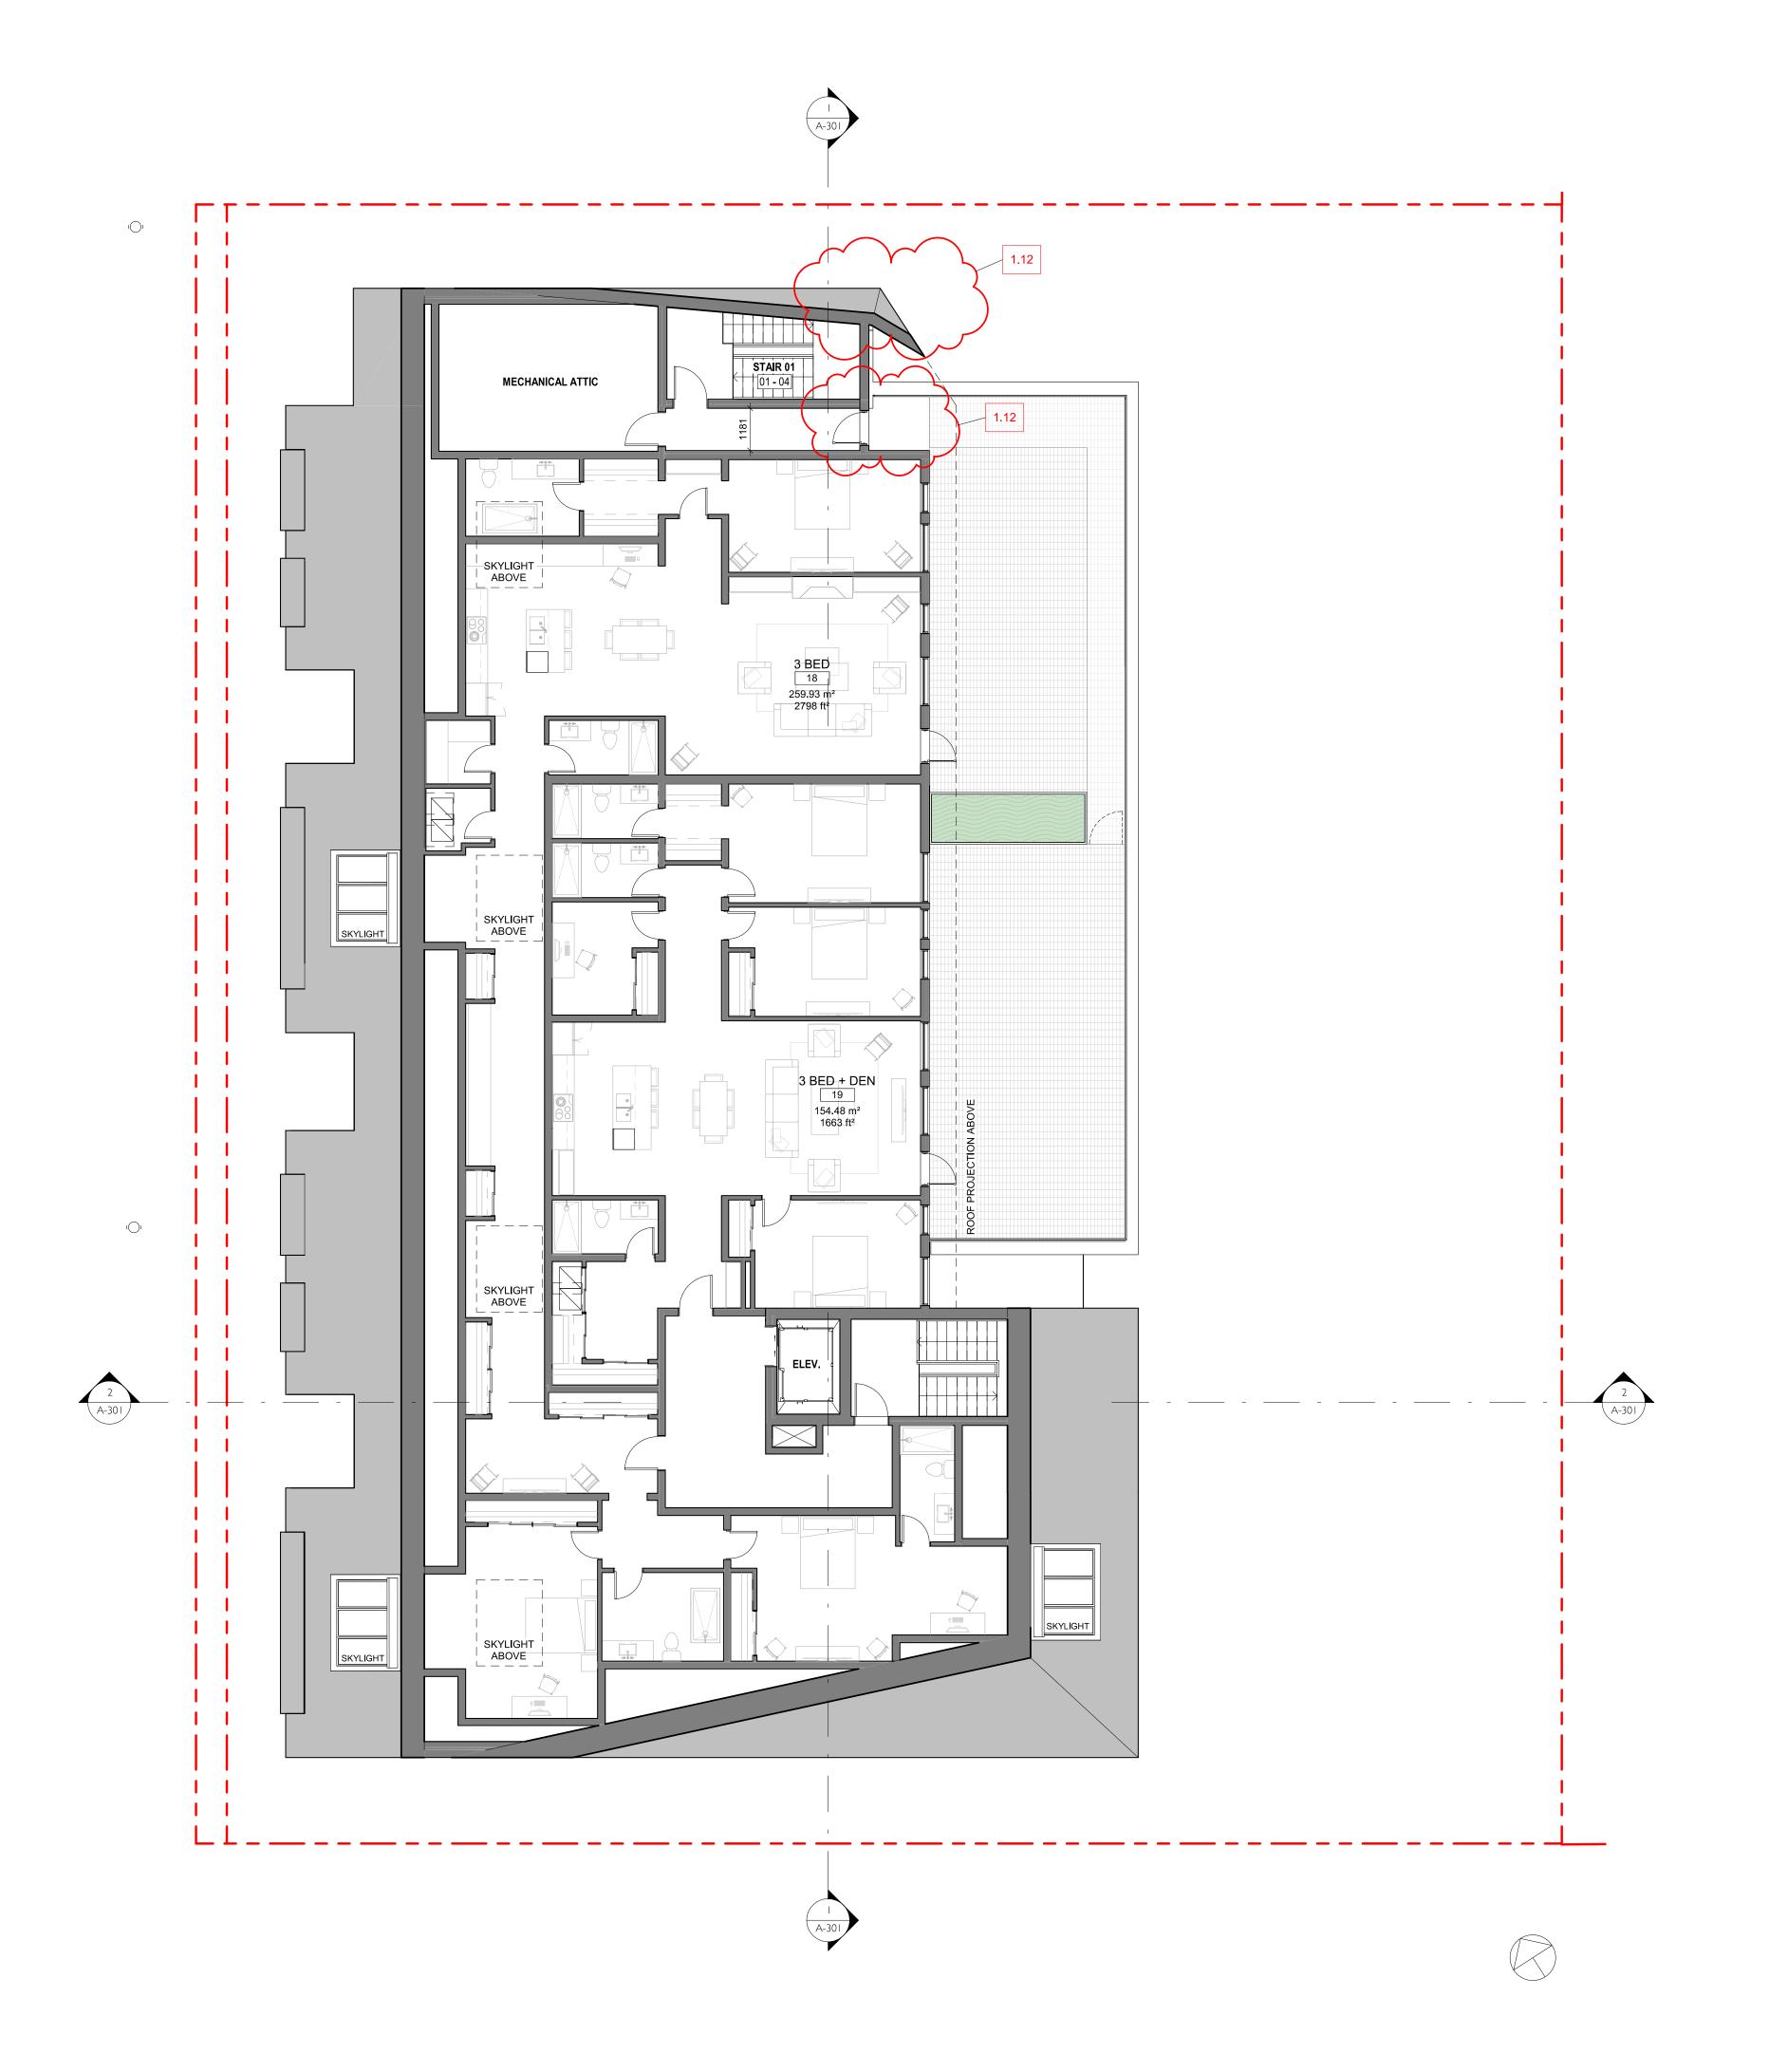

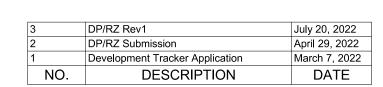




Copyright reserved. These drawings and the design contained therein or which may be inferred therefrom are, and at all times remain, the exclusive property of Cascadia Architects Inc. Cascadia Architects holds the copyright and ownership in the said drawings, which cannot be used for any purpose without the express written consent of Cascadia Architects.

1733-1737 Fairfield Rd

LEVEL 4 PROPOSED

Date
JULY 20, 2022

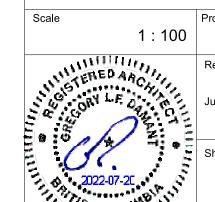


A-104

7/20/2022 4:47:50 PM

2123



# 1 NW ELEVATION SCALE = 1:100

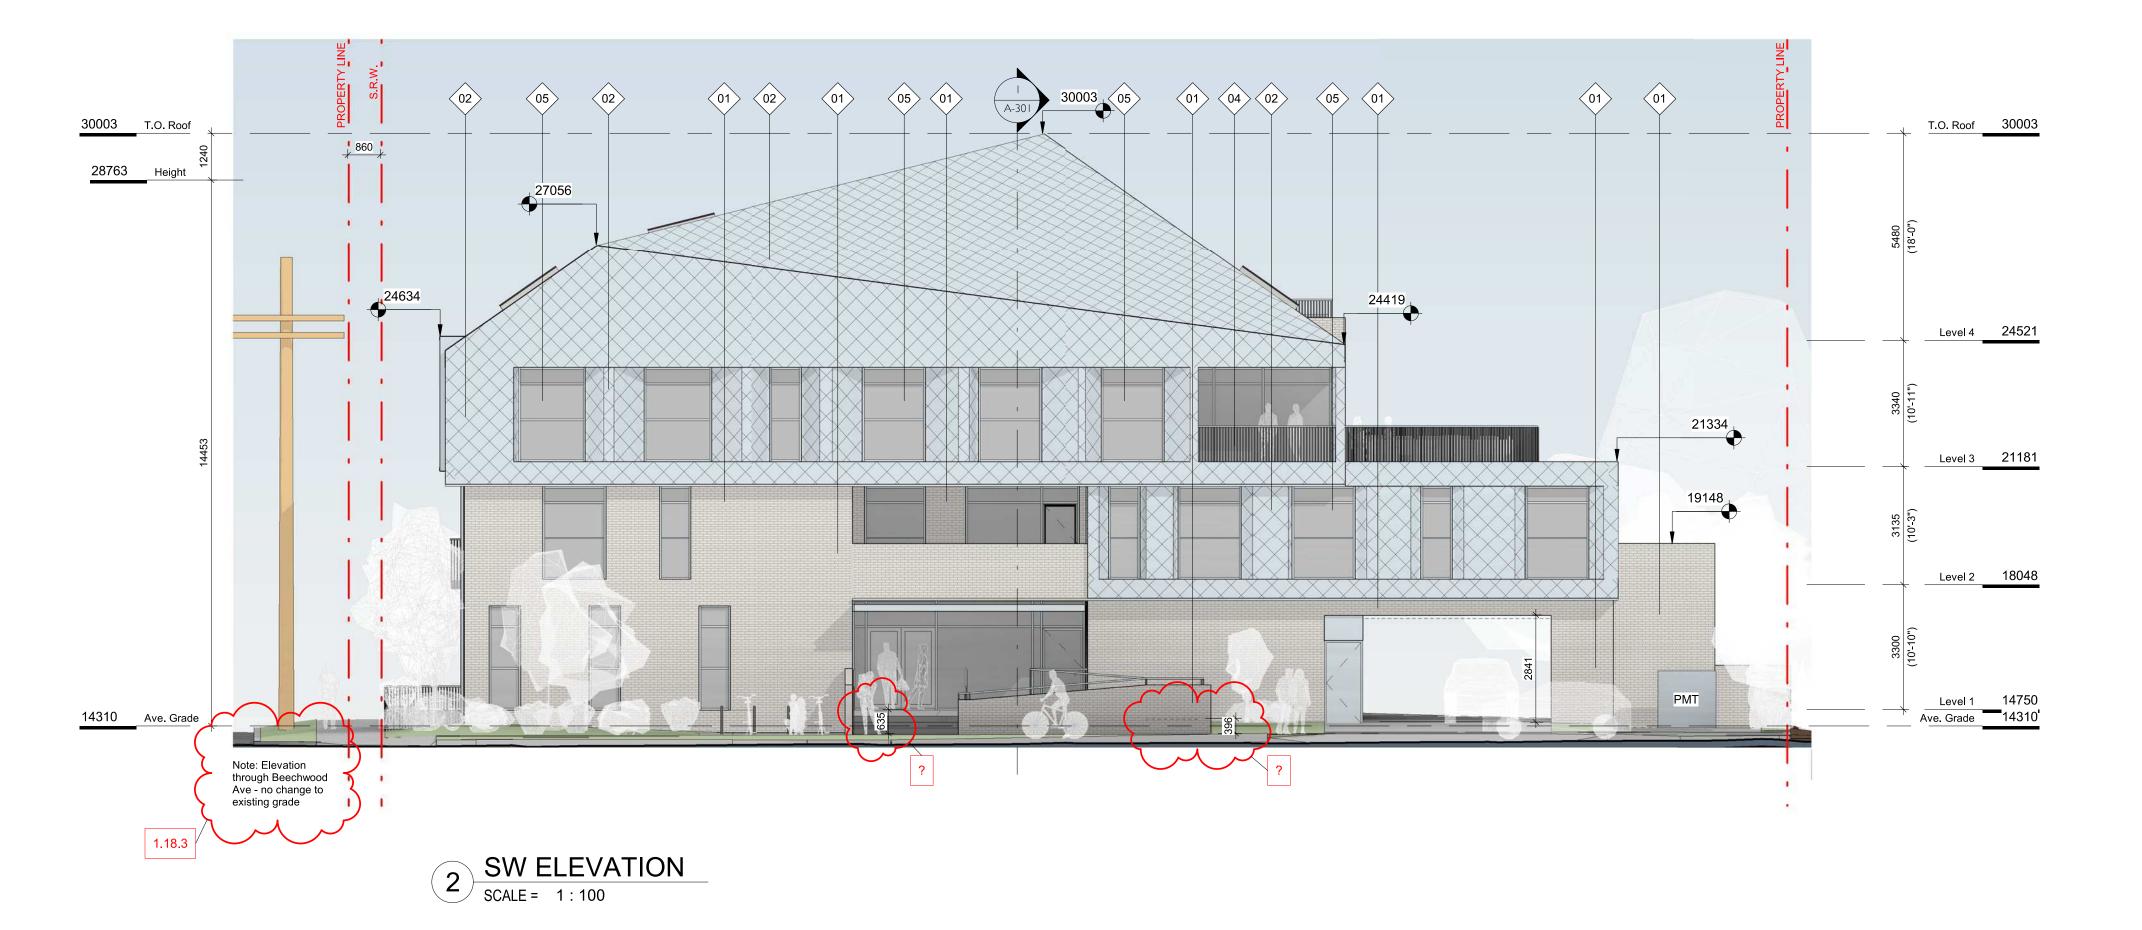

### FINISH SCHEDULE

- 01. BRICK LIGHT FINISH
- 02. PREFINISHED METAL FISHSCALE SHINGLE ZINC FINISH
- 03. PREFINISHED METAL ZINC FINISH
- 04. METAL PICKET GUARD ZINC FINISH
- 05. GLAZING TRANSPARENT
- 06. T&G WOOD CLEAR FINISH

07. HORIZONTAL WOOD FENCE CLEAR FINISH

CASCADIA ARCHITECTS INC
Copyright reserved. These drawings and the design contained therein or which may be inferred therefrom are, and at all times remain, the exclusive property of Cascadia Architects Inc. Cascadia Architects holds the copyright and ownership in the said drawings, which cannot be used for any purpose without the express written consent of Cascadia Architects.

DP/RZ Rev1 DP/RZ Submission

NO.

Development Tracker Application

DESCRIPTION

July 20, 2022 April 29, 2022 March 7, 2022 DATE


1733-1737 Fairfield Rd

ARYZE

EXTERIOR ELEVATIONS

JULY 20, 2022


July 20, 2022

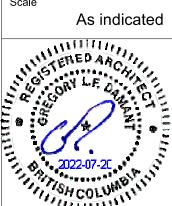

7/20/2022 4:48:22 PM

2123



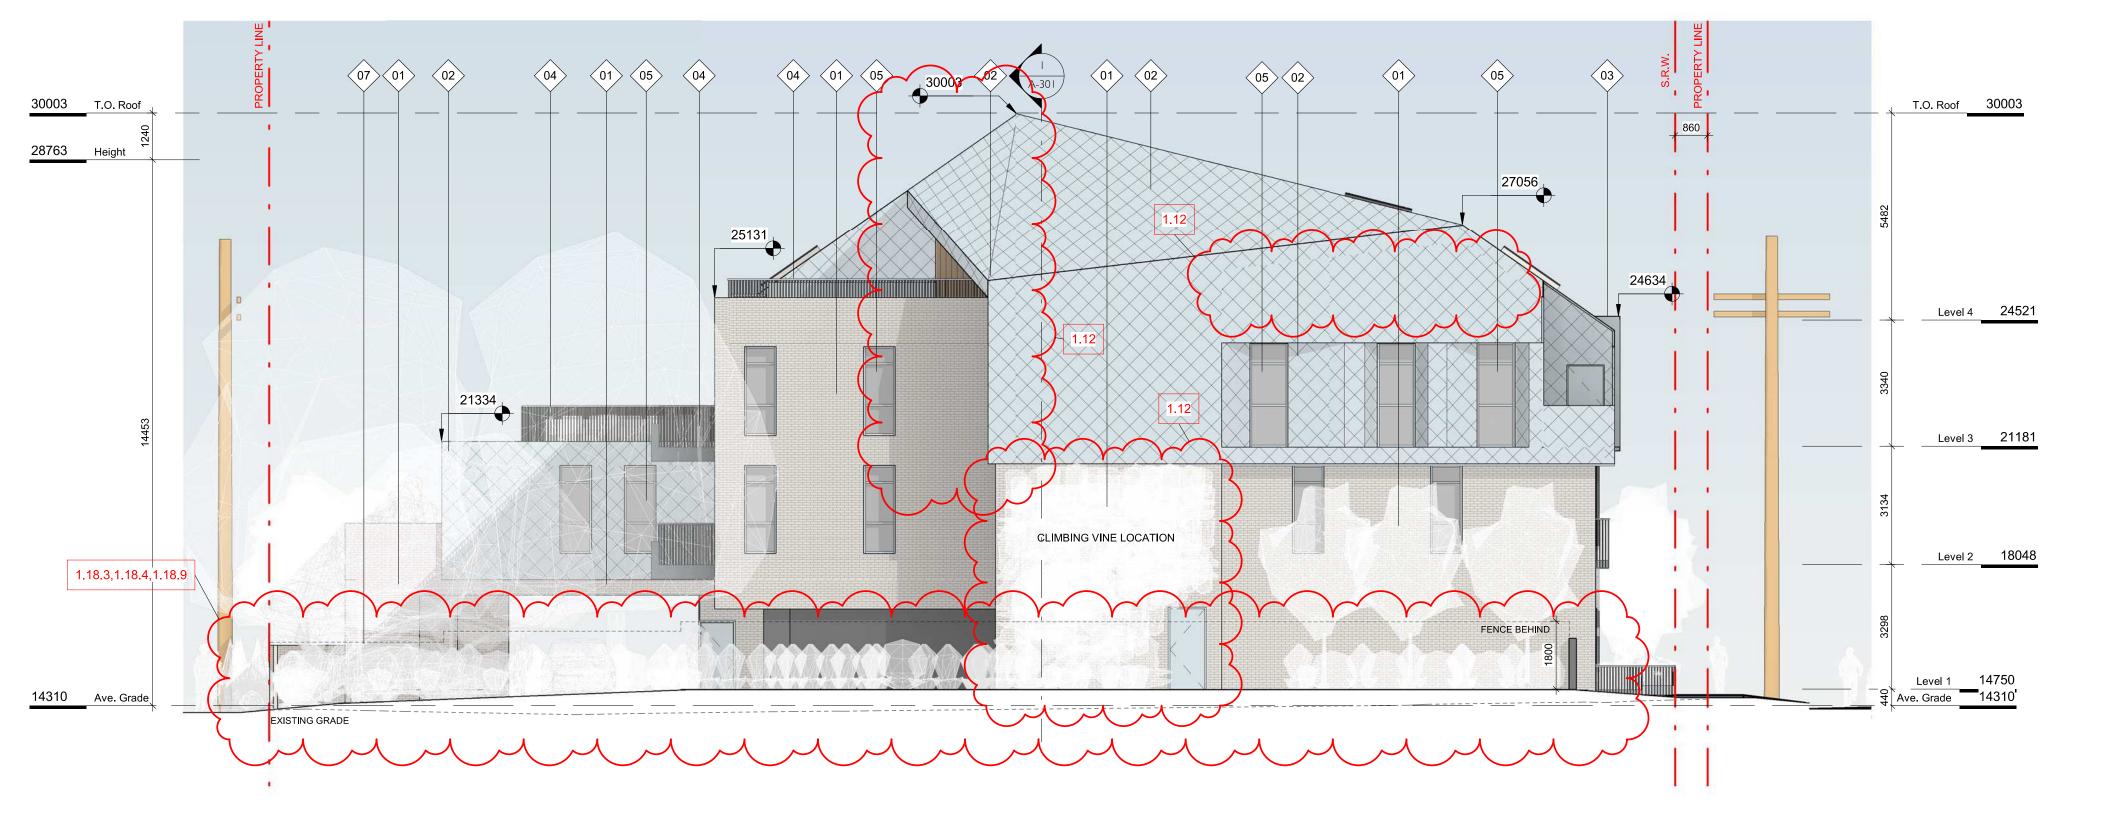

FINISH SCHEDULE

01. BRICK LIGHT FINISH

02. PREFINISHED METAL FISHSCALE SHINGLE ZINC FINISH

03. PREFINISHED METAL ZINC FINISH

04. METAL PICKET GUARD ZINC FINISH

05. GLAZING TRANSPARENT

06. T&G WOOD

CLEAR FINISH

07. HORIZONTAL WOOD FENCE

**CLEAR FINISH** 

2 NE ELEVATION
SCALE = 1:100



DP/RZ Submission

NO.

Development Tracker Application


DESCRIPTION

July 20, 2022 April 29, 2022 March 7, 2022 DATE


EXTERIOR ELEVATIONS


As indicated Project #


July 20, 2022

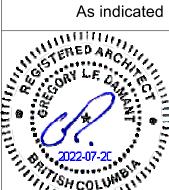


7/20/2022 4:49:05 PM

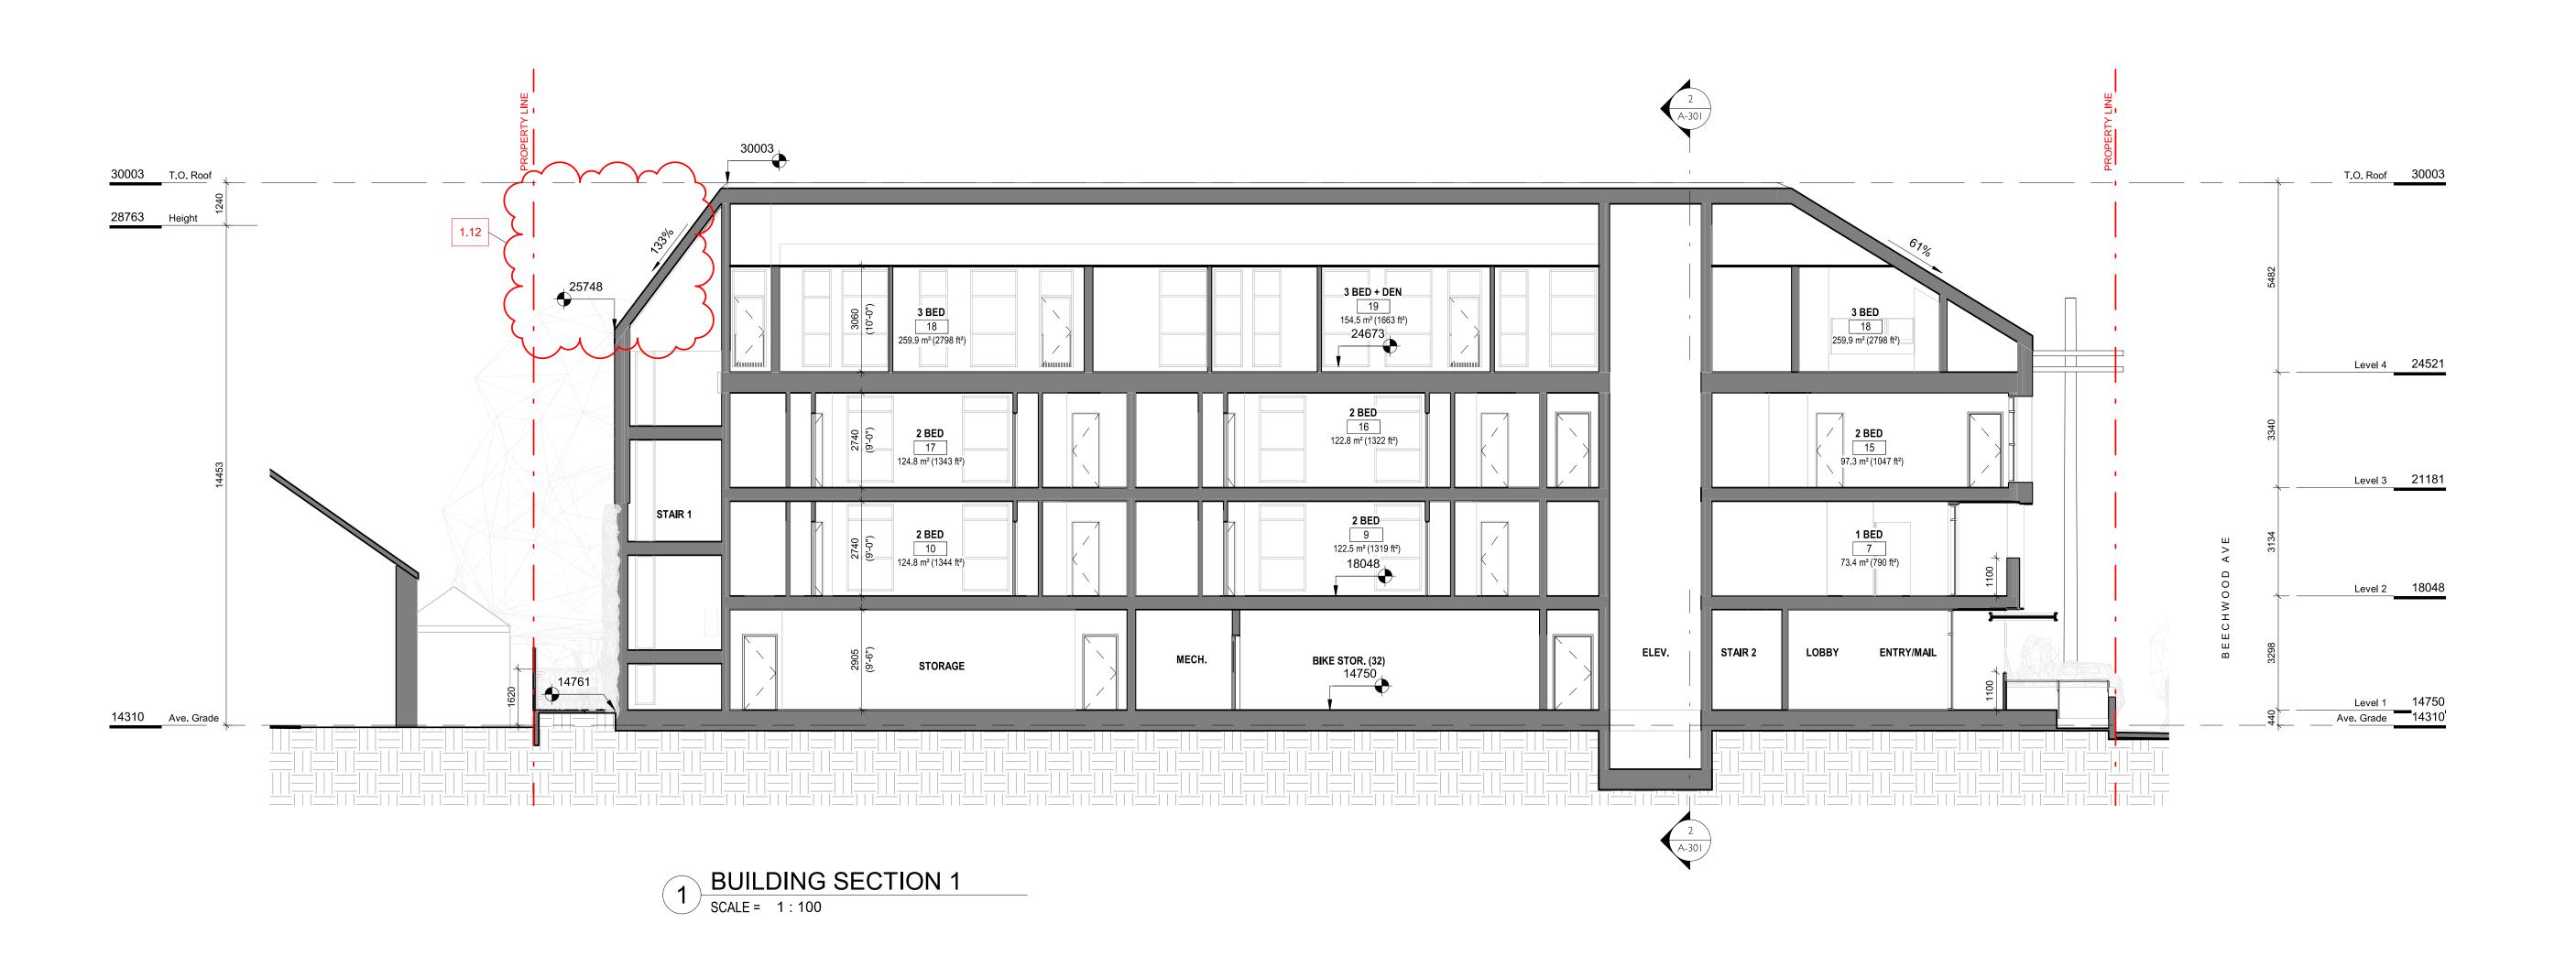


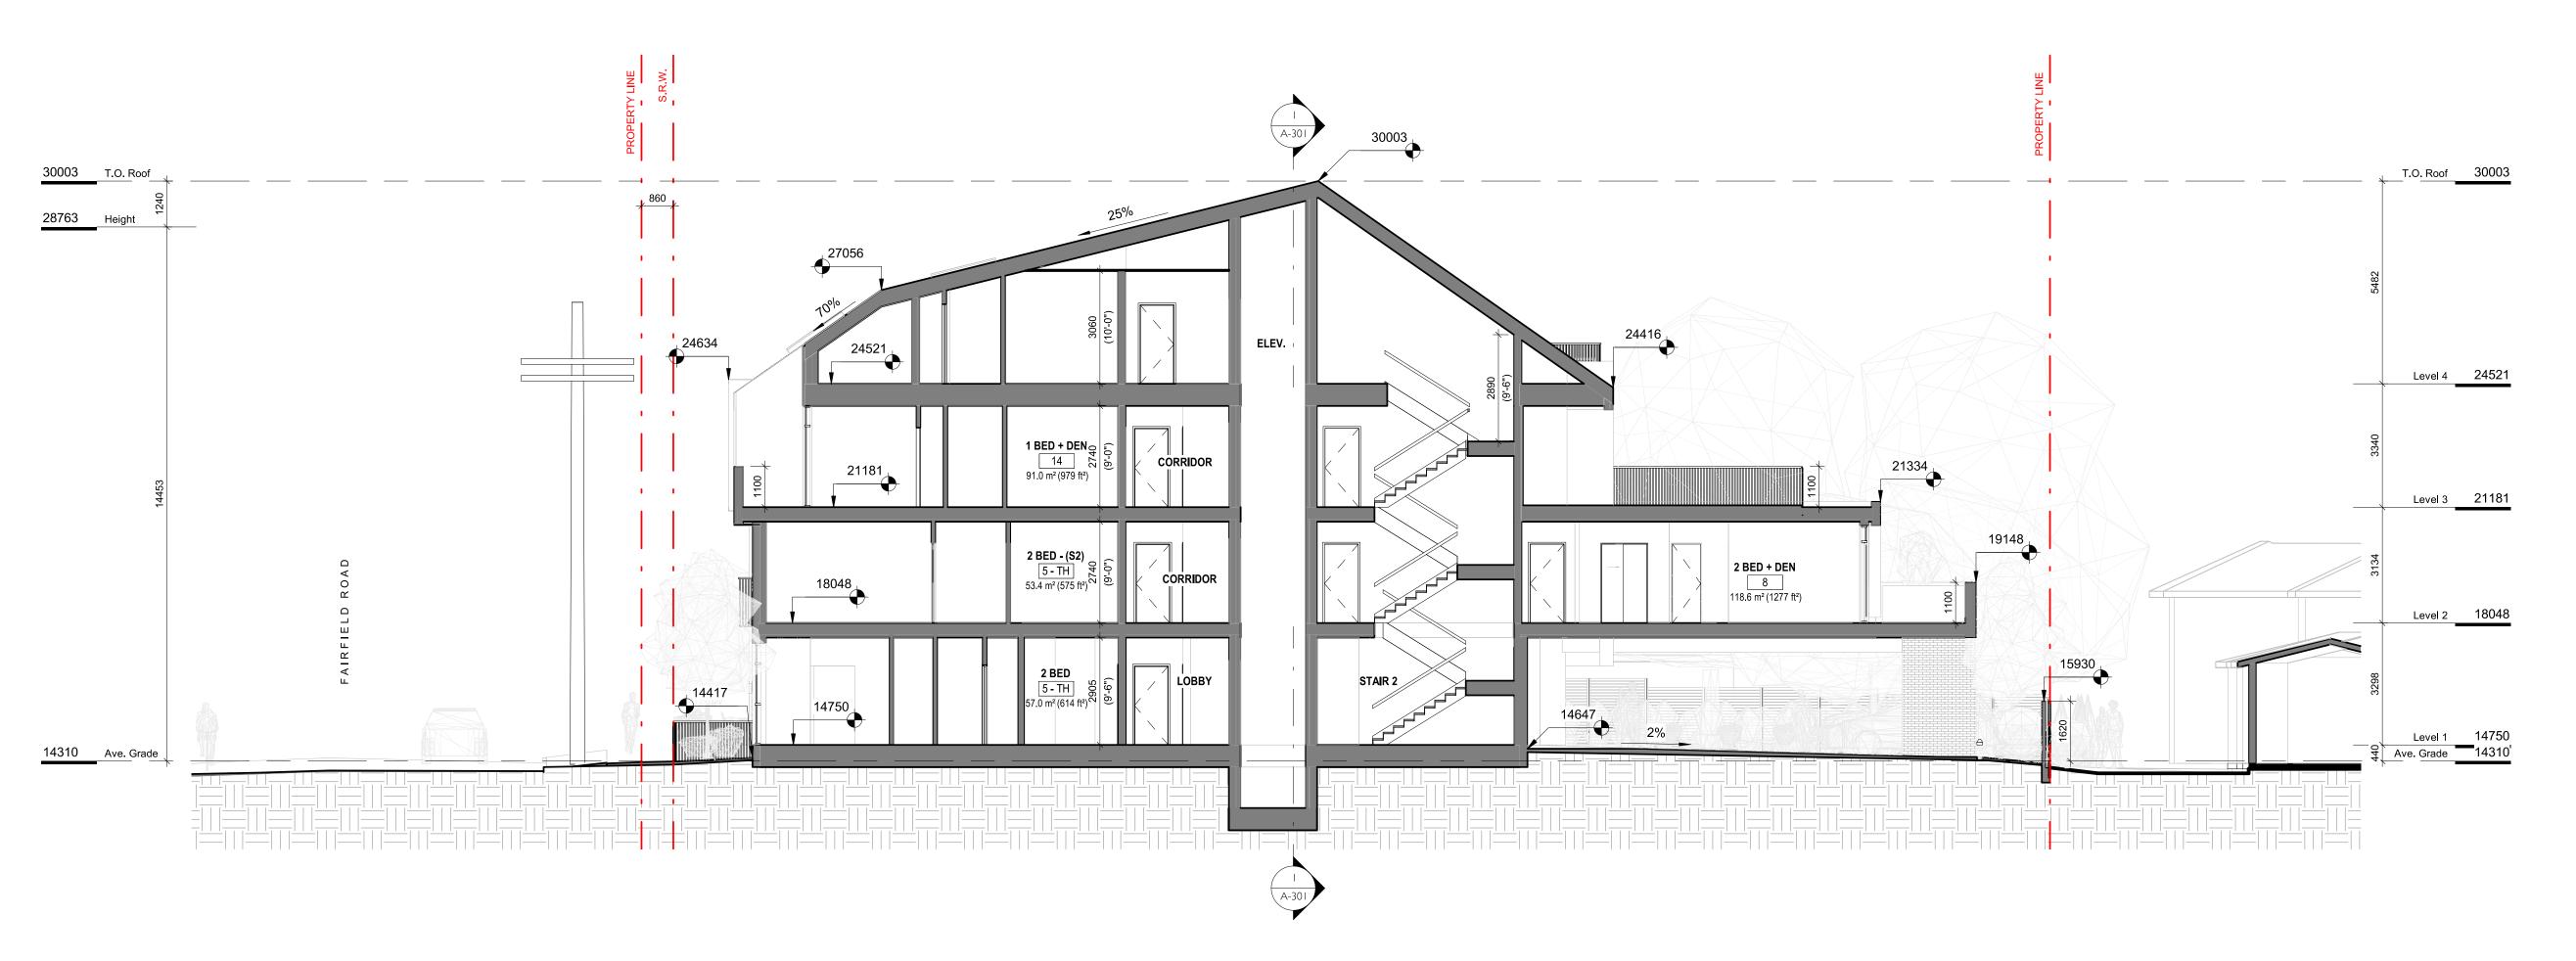


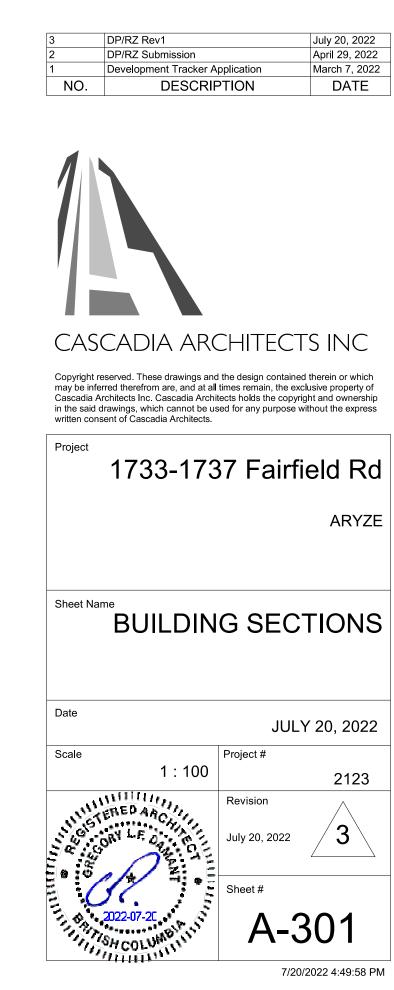


2 BUILDING SECTION 2
SCALE = 1:100

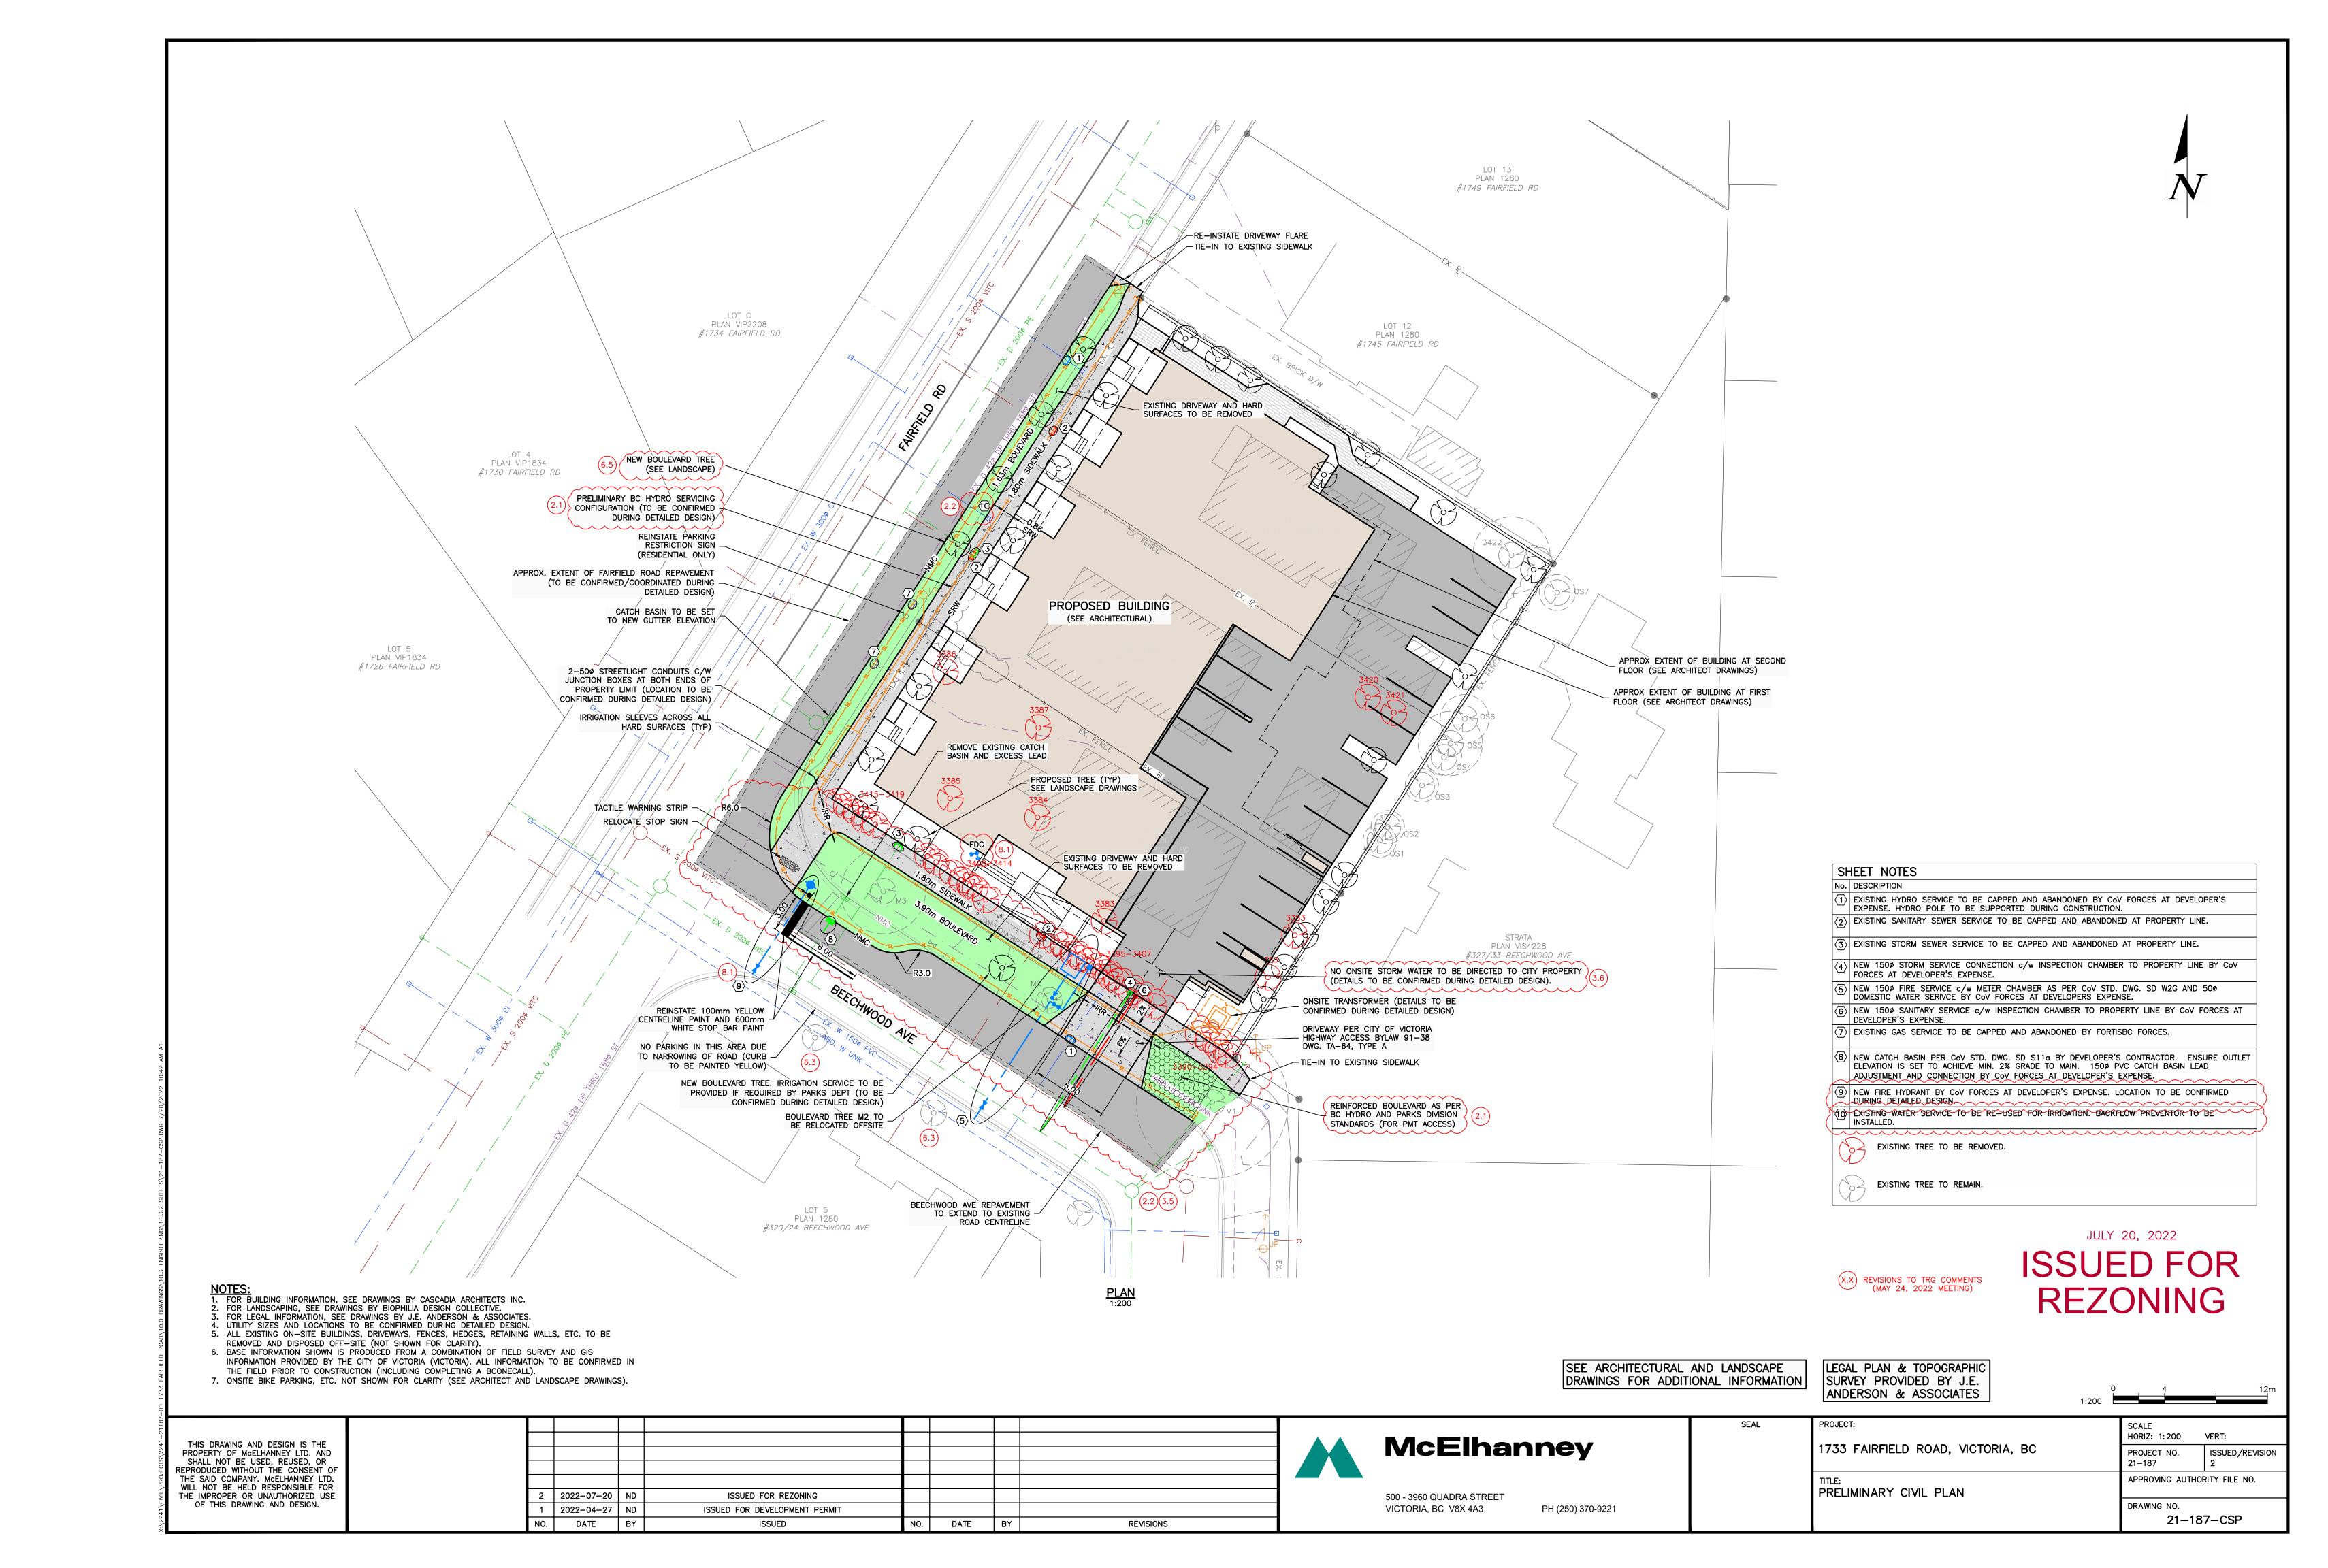

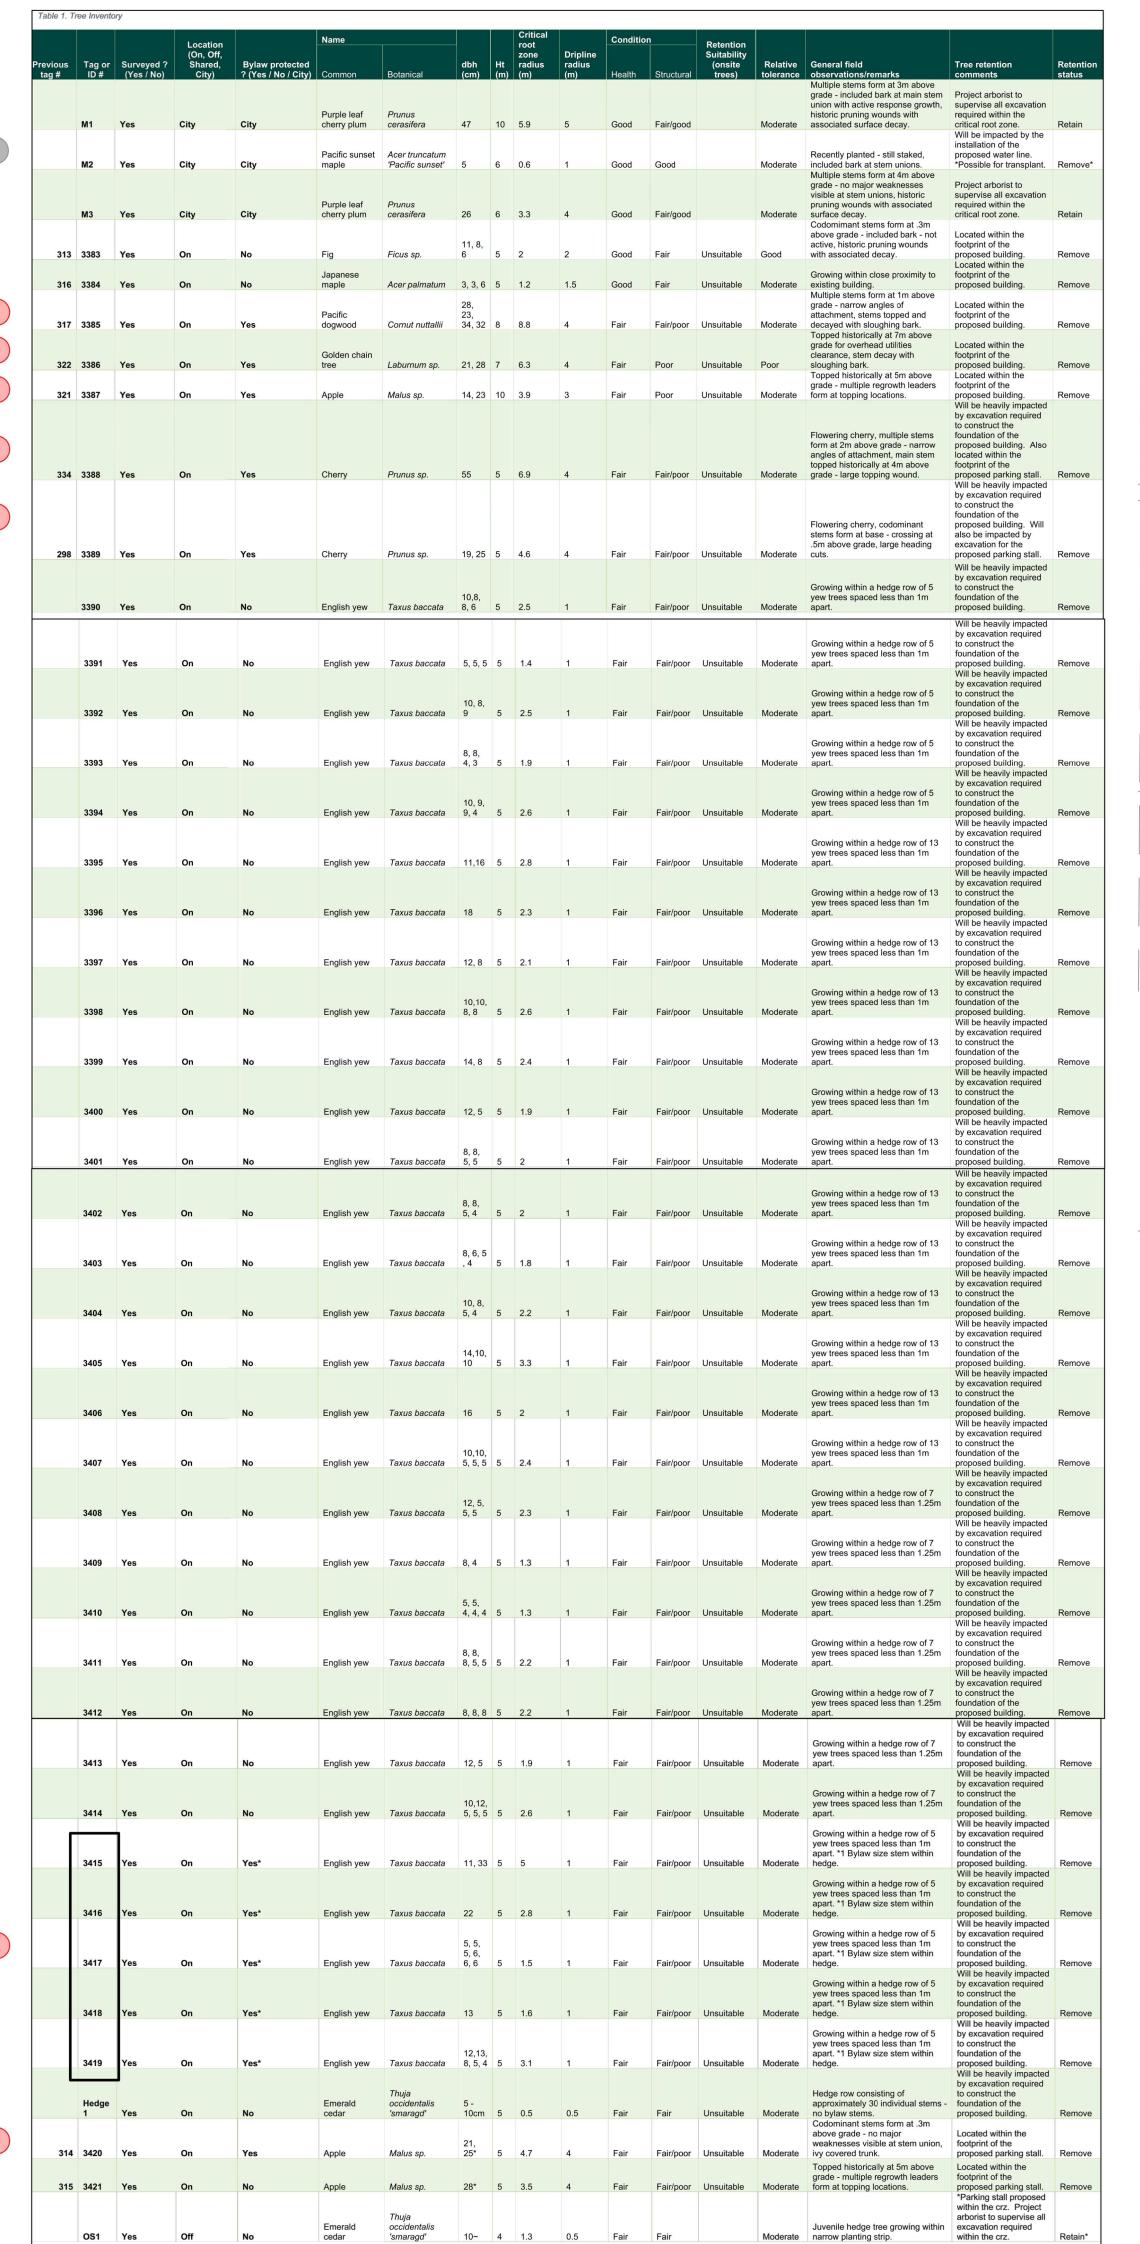

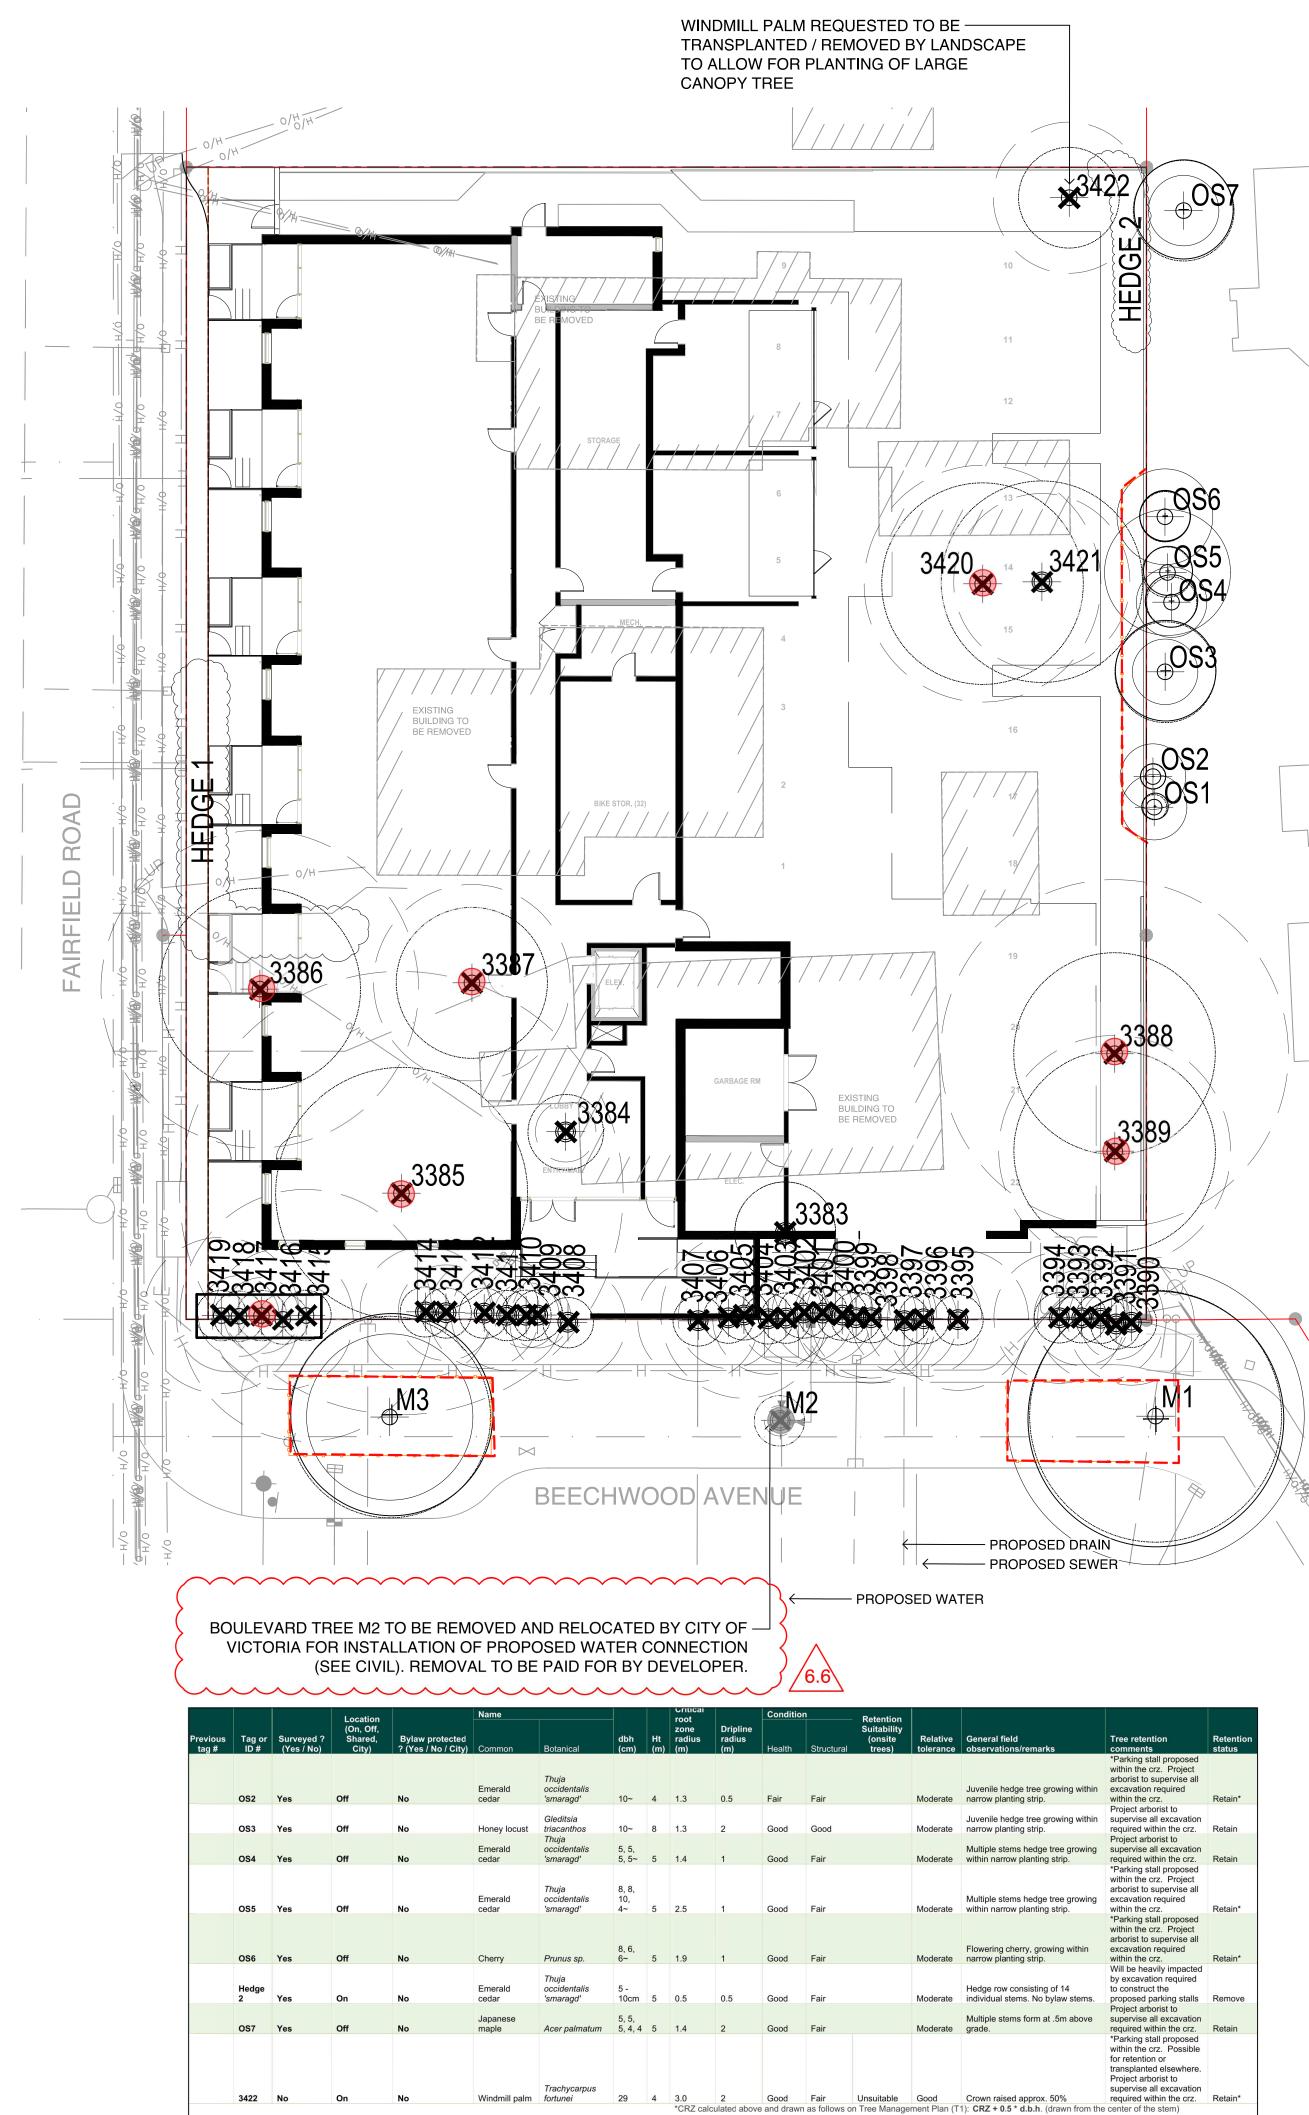

NOTE: SEE ORIGINAL TREE INVENTORY AND TABLES IN REPORT PREPARED BY TALBOT & MACKENZIE

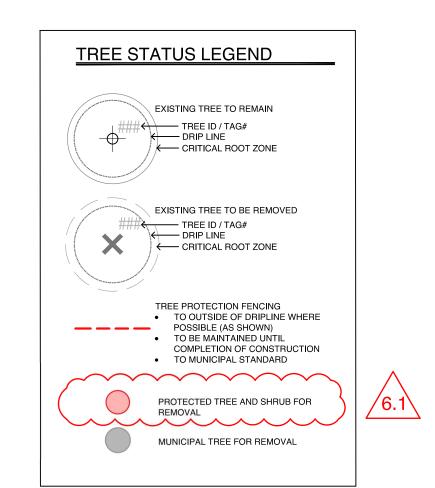



1608 Camosun Street, Victoria BC V8T 3E6 Info@biophiliacollective.ca 250 590 1156

OWNER/CLIENT:


ARYZE DEVELOPMENTS

PROJECT ADDRESS: 1733 FAIRFIELD.

VICTORIA, BC

DESIGNED BY: BIANCA BODLEY
DRAWN BY: KARIANNE HOWARTH

NO.	ISSUE	YY\MM\DD
1	ISSUED FOR DEVELOPMENT TRACKER	22\03\04
2	ISSUED FOR RZ/DP	22\05\02
3	ISSUED FOR COORDINATION	22\07\18
4	ISSUED FOR RZ/ DP	22\07\20

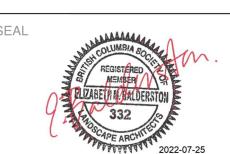


NORTH ARROW

DRAWING TITLE:

TREE REMOVAL & PROTECTION PLAN

DWG NO:

SCALE: 1:150

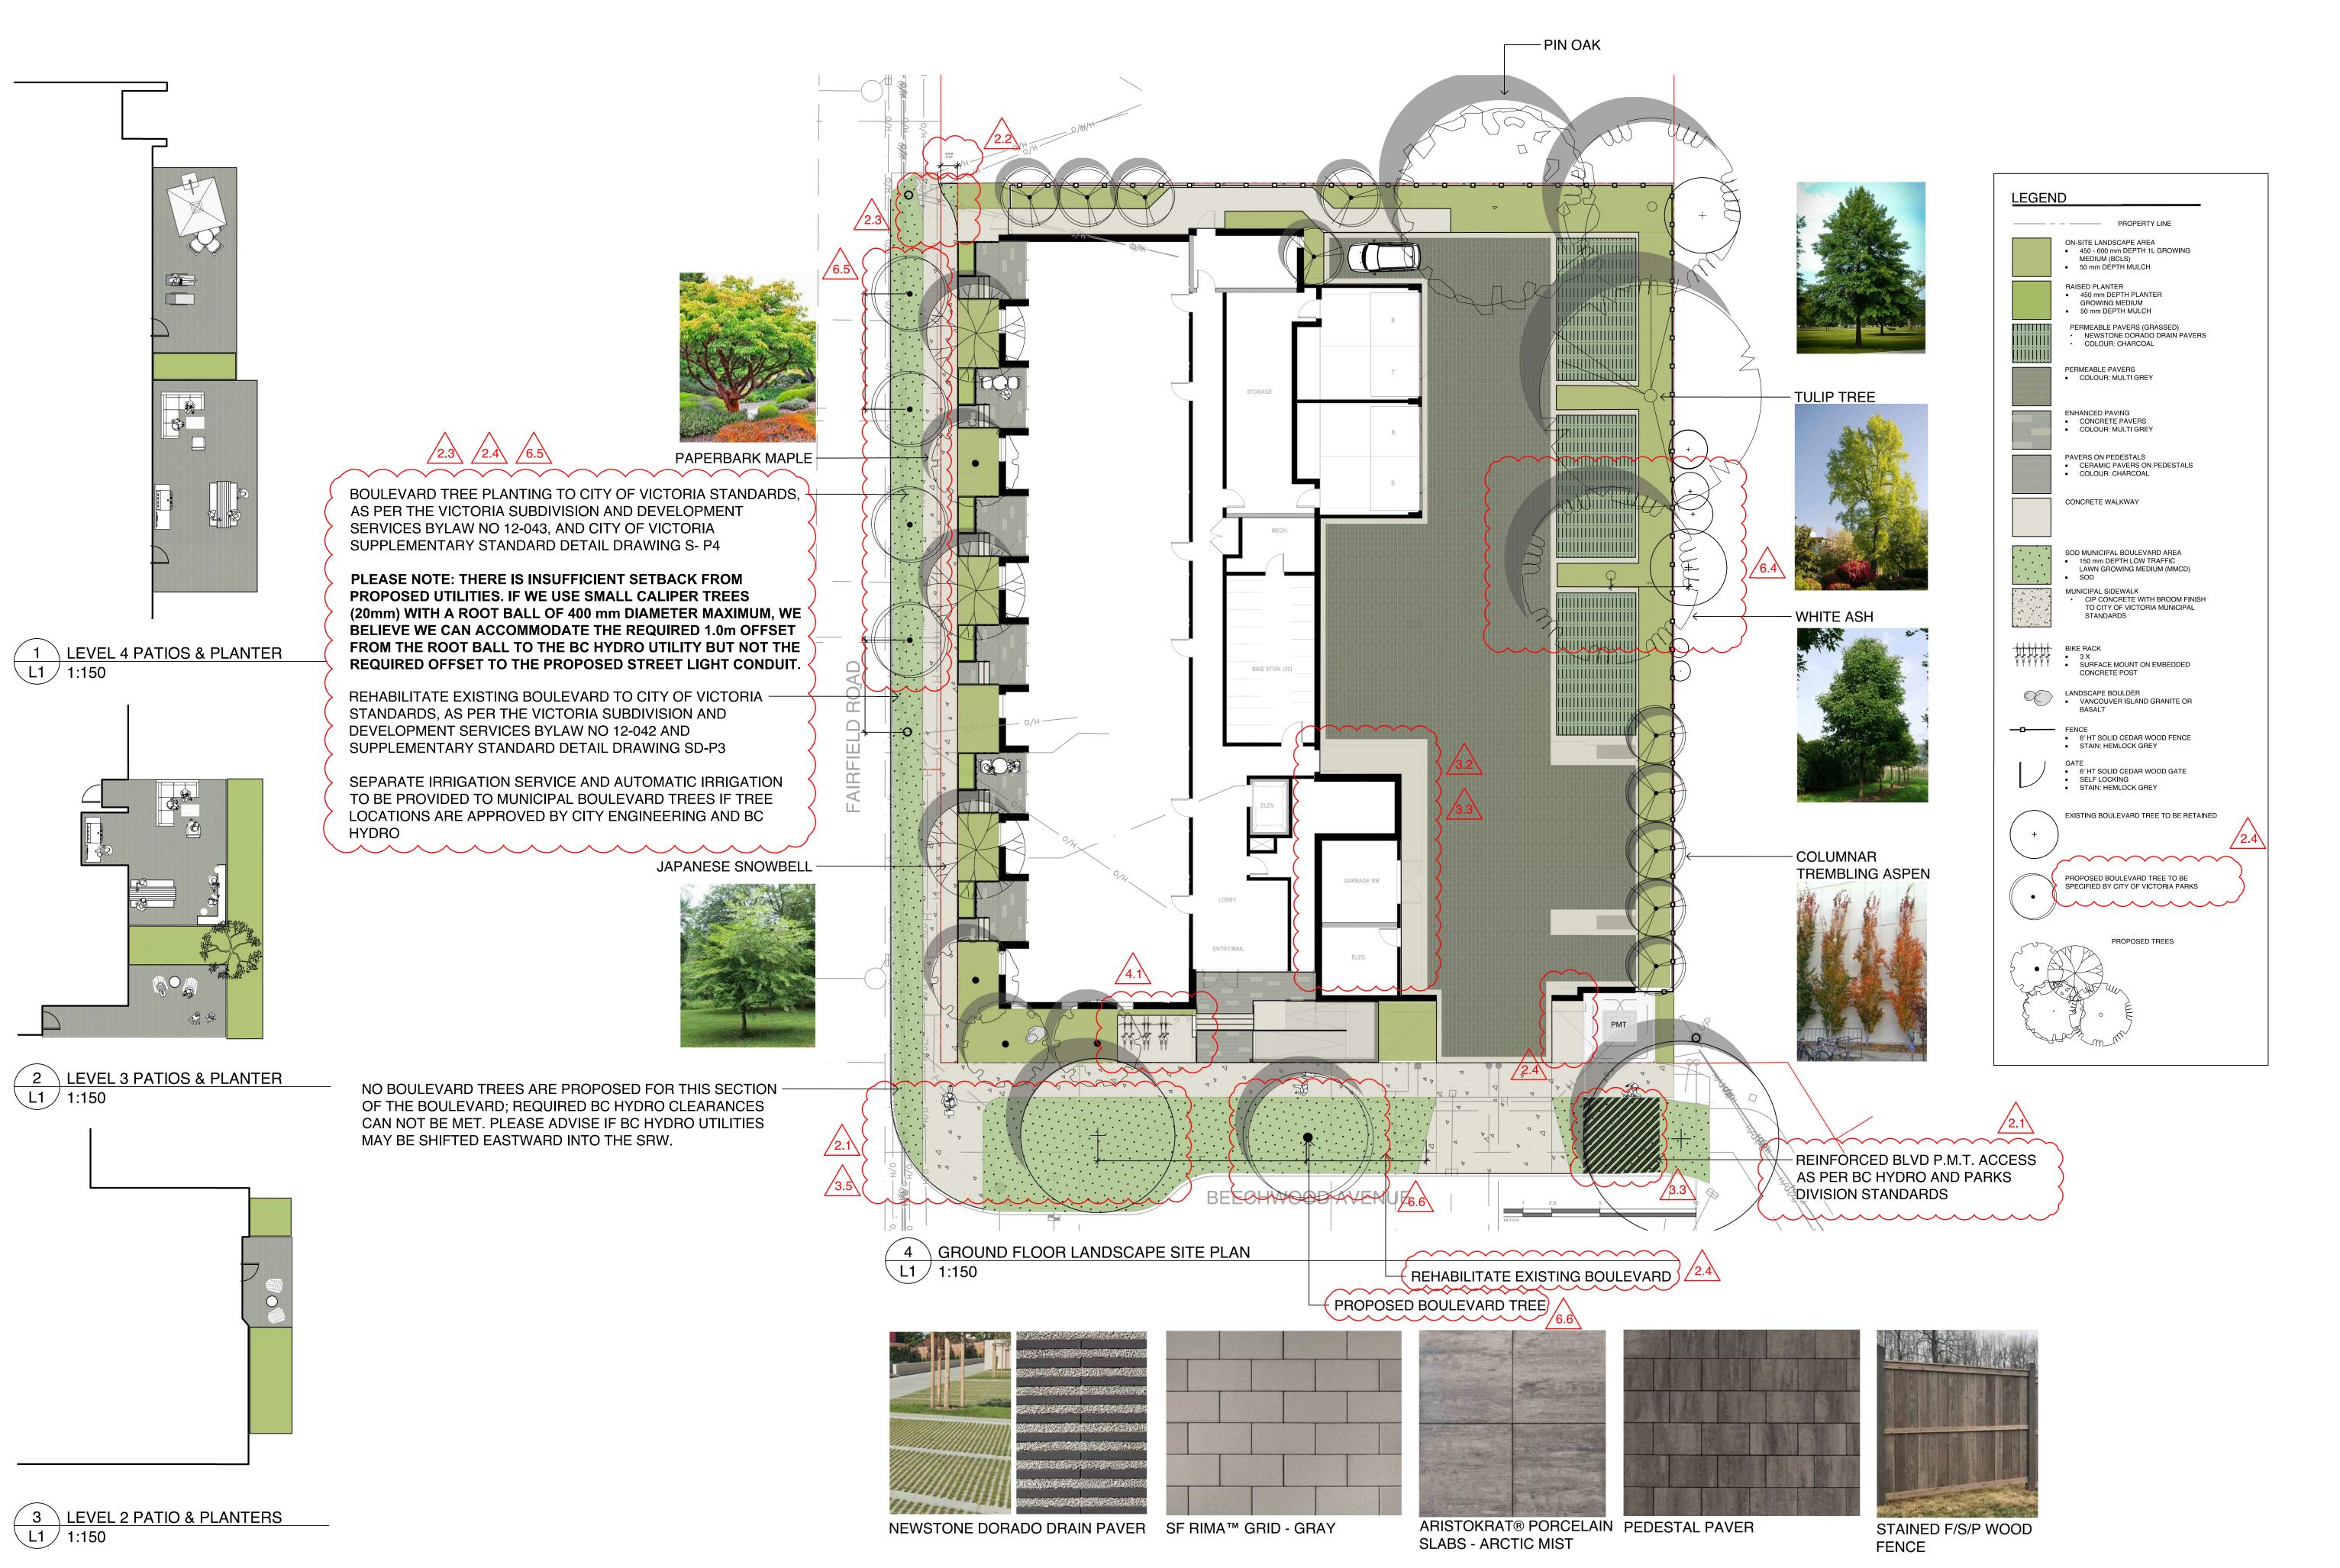



1608 Camosun Street, Victoria BC V8T 3E6 Info@biophiliacollective.ca 250 590 1156

NER/CLIENT:

ARYZE DEVELOPMENTS

PROJECT ADDRESS:

1733 FAIRFIELD, VICTORIA, BC

DESIGNED BY: BIANCA BODLEY
DRAWN BY: KARIANNE HOWARTH

NO. ISSUE

1 ISSUED FOR DEVELOPMENT TRACKER 22\03\04

2 ISSUED FOR RZ/DP 22\05\02

3 ISSUED FOR COORDINATION 22\07\18

4 ISSUED FOR RZ/ DP 22\07\20




NORTH ARROW


DRAWING TITLE:

LANDSCAPE SITE PLAN

DWG NO:

E: AS NOTED

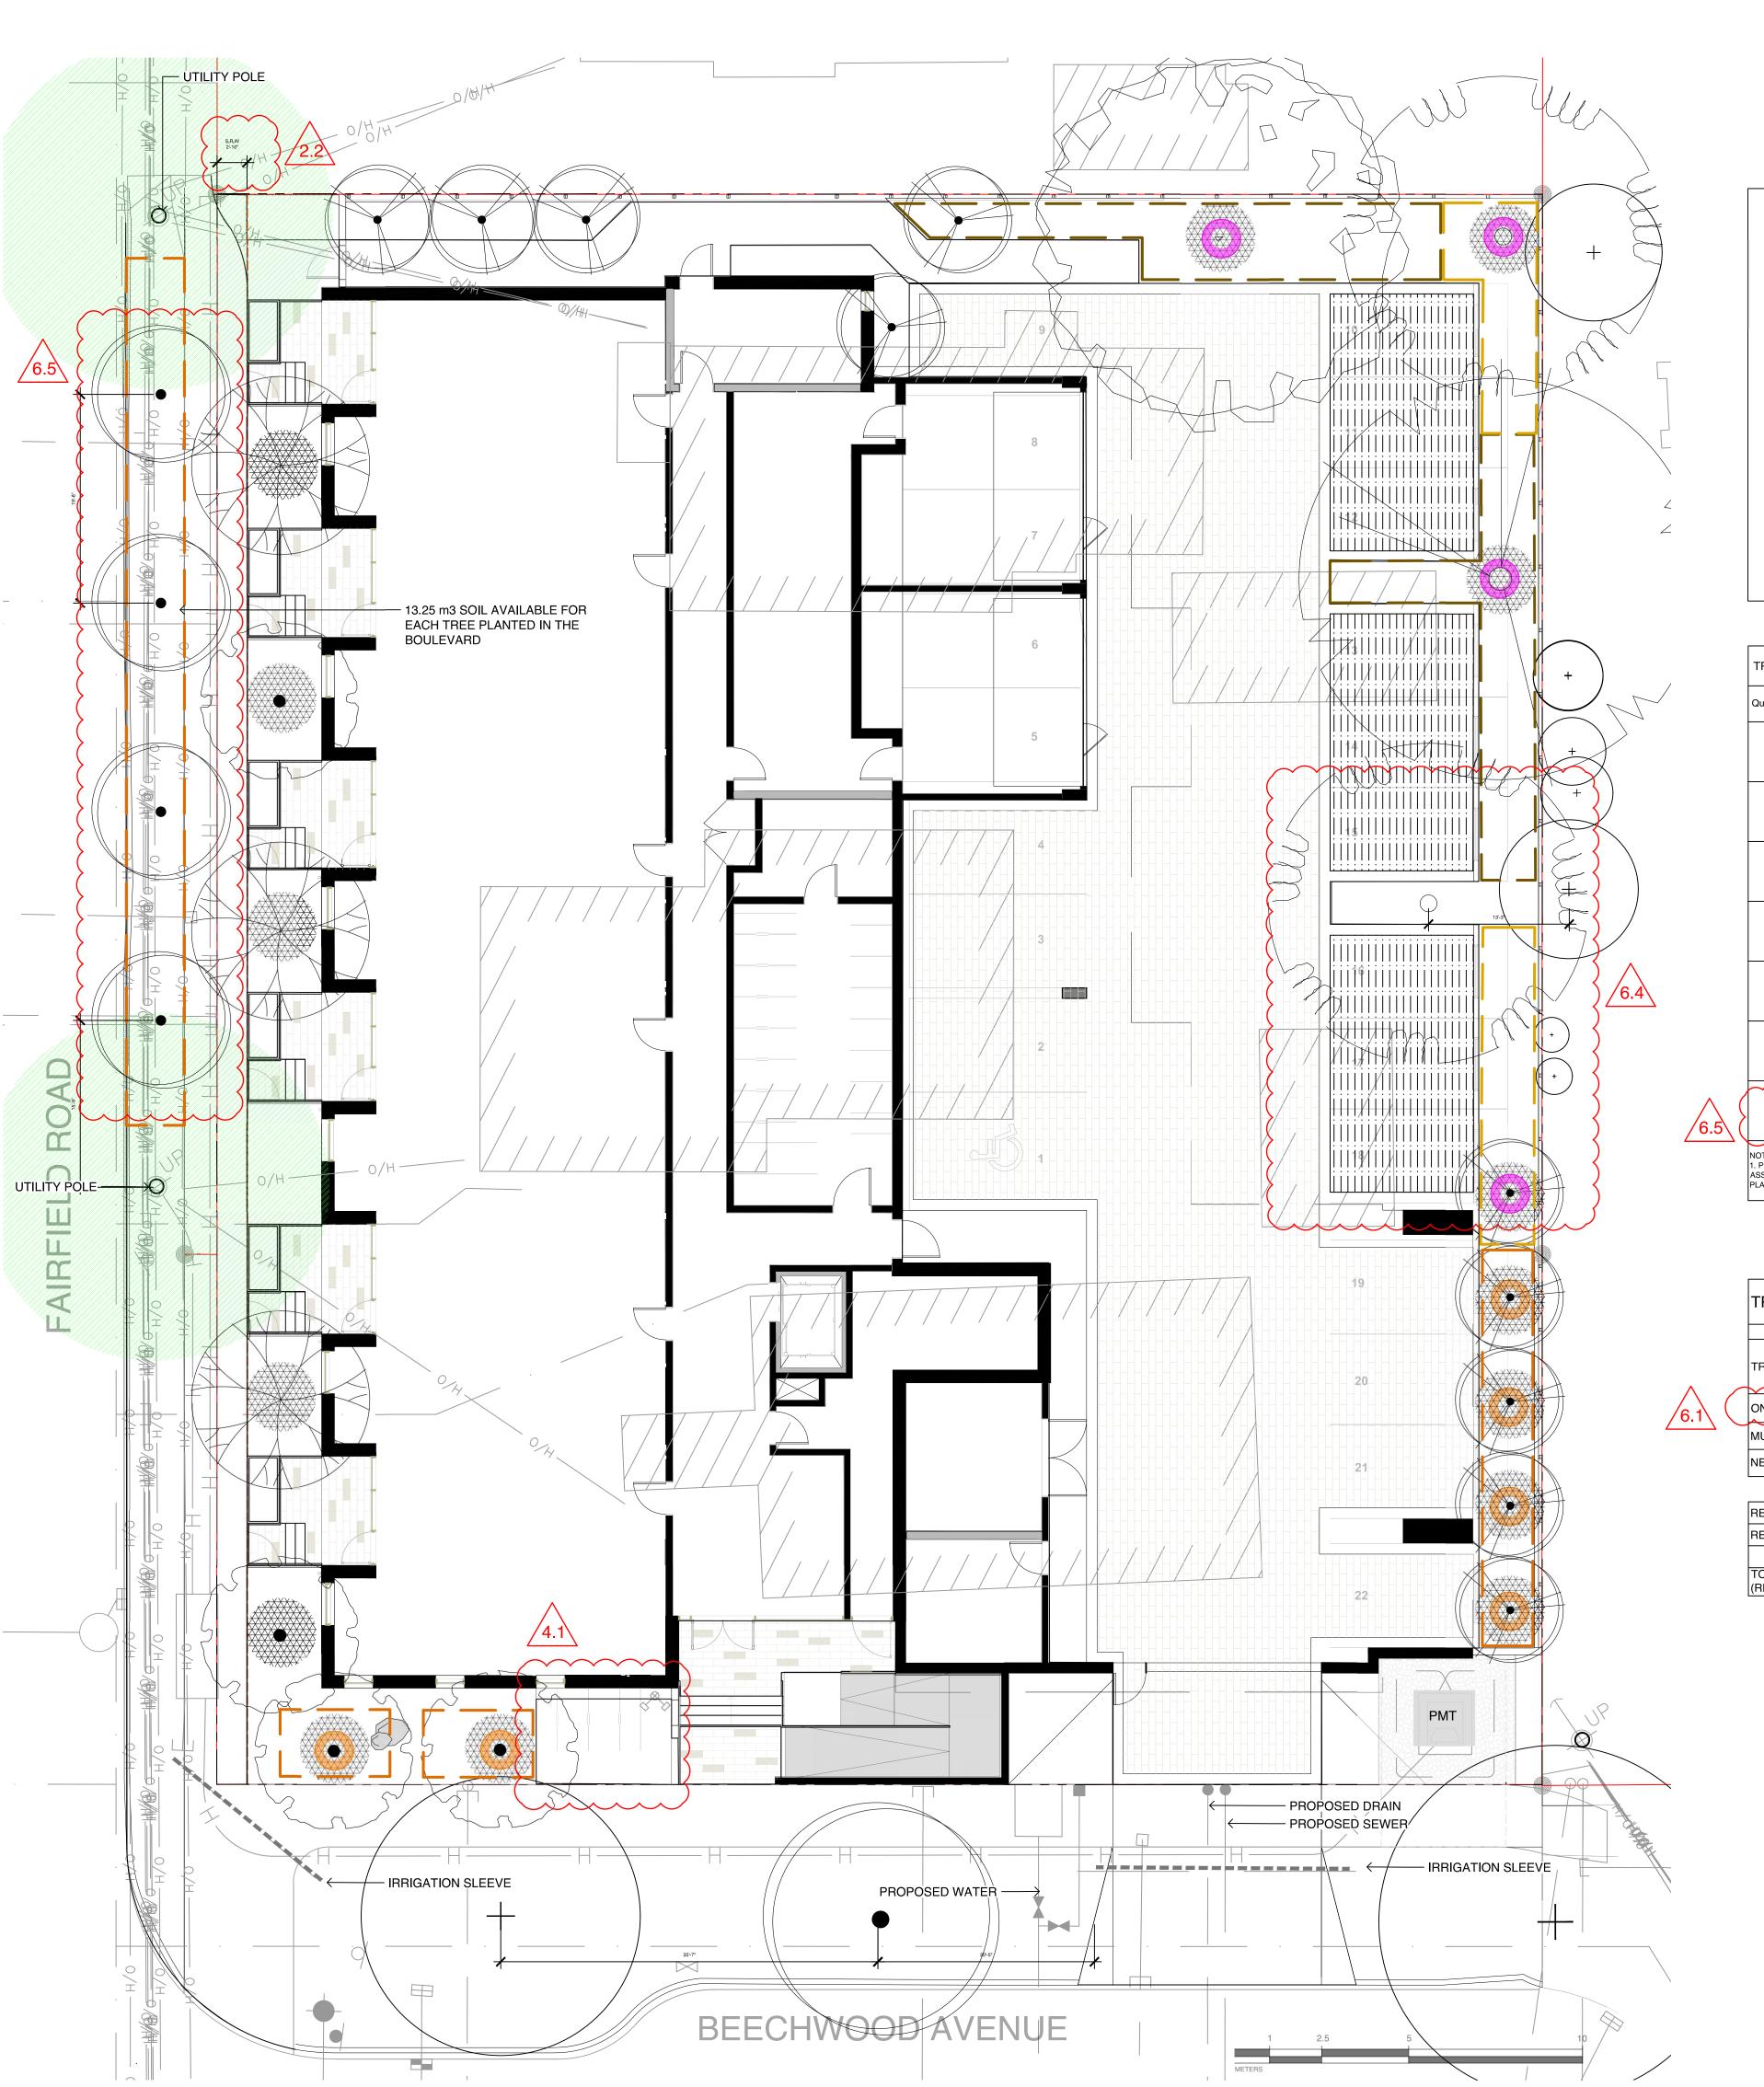

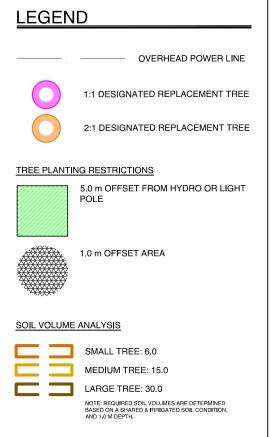

Quantity	Symbol	Latin Name	Common Name	Container	Caliper	Size	Native	Remarks	Height at Maturity (m)	Spread a Maturity (m)
4		Acer griseum	Paperbark Maple	B&B	6 cm	>2 m		full/part sun	6-9	5-7
2	Sam James	Fraxinus americana 'Autumn Applause'	Autumn Applause white ash	B&B	6 cm	>2 m		Medium	12-15	7-9
1	The state of the s	Liriodendron tulipifera	Tulip tree	B&B	6 cm	>2 m		full sun	18-24	9-12
10		Populus tremuloides 'Erecta'	Swedish Columnar Aspen	B&B	6 cm	>2 m		full sun	9-12	1.8-2.5
3		Styrax japonicus	Japanese snowbell	B&B	6 cm	>2 m		full sun - part shade	7.0	7.0
1 .		Quercus palustris	Pin Oak	B&B	6 cm	>2 m		full sun	10	10
5		BOULEVARD TREE TO BE DETERMINED BY PARKS AT BP	2.4	B&B	TBD	}				

	TREE IMPACT SUMMARY TABLE						
_	TREE STATUS	TOTAL	To be RETAINED	To be REMOVED	REPLACEMENTS REQUIRED	MINIMUM REQUIRED FOR LOT SIZE	PROPOSED
	ON-SITE TREES AND SHRUBS BYLAW PROTECTED	7	0	7	7	9	7
_	MUNICIPAL TREES	3	2	1	1		8
	NEIGHBORING TREES, BYLAW PROTECTED	0	0	0	0		0

	$\sim$	
REPLACEMENT TREES TO BE PLANTED ON SITE	7	$\setminus$
REPLACEMENT TREE SHORTFALL	2	/6.4
TOTAL PROPOSED TREES ON SITE (REPLACEMENT(ACTUAL) + OTHER)	21	



1608 Camosun Street, Victoria BC V8T 3E6 Info@biophiliacollective.ca 250 590 1156

OWNER/CLIENT:

ARYZE DEVELOPMENTS

PROJECT ADDRESS:

1733 FAIRFIELD, VICTORIA, BC

DESIGNED BY: **BIANCA BODLEY** DRAWN BY: KARIANNE HOWARTH

NO.	ISSUE	YY\MM\DD
1	ISSUED FOR DEVELOPMENT TRACKER	22\03\04
2	ISSUED FOR RZ/DP	22\05\02
3	ISSUED FOR COORDINATION	22\07\18
4	ISSUED FOR RZ/ DP	22\07\20





NORTH ARROW


 $\sim\sim$ ACTUAL NUMBER: 7 4 x LARGE TREE (1:1) 6 x SMALL TREE (2:1)

DRAWING TITLE:

TREE PLANTING PLAN

DWG NO:

SCALE: 1:100

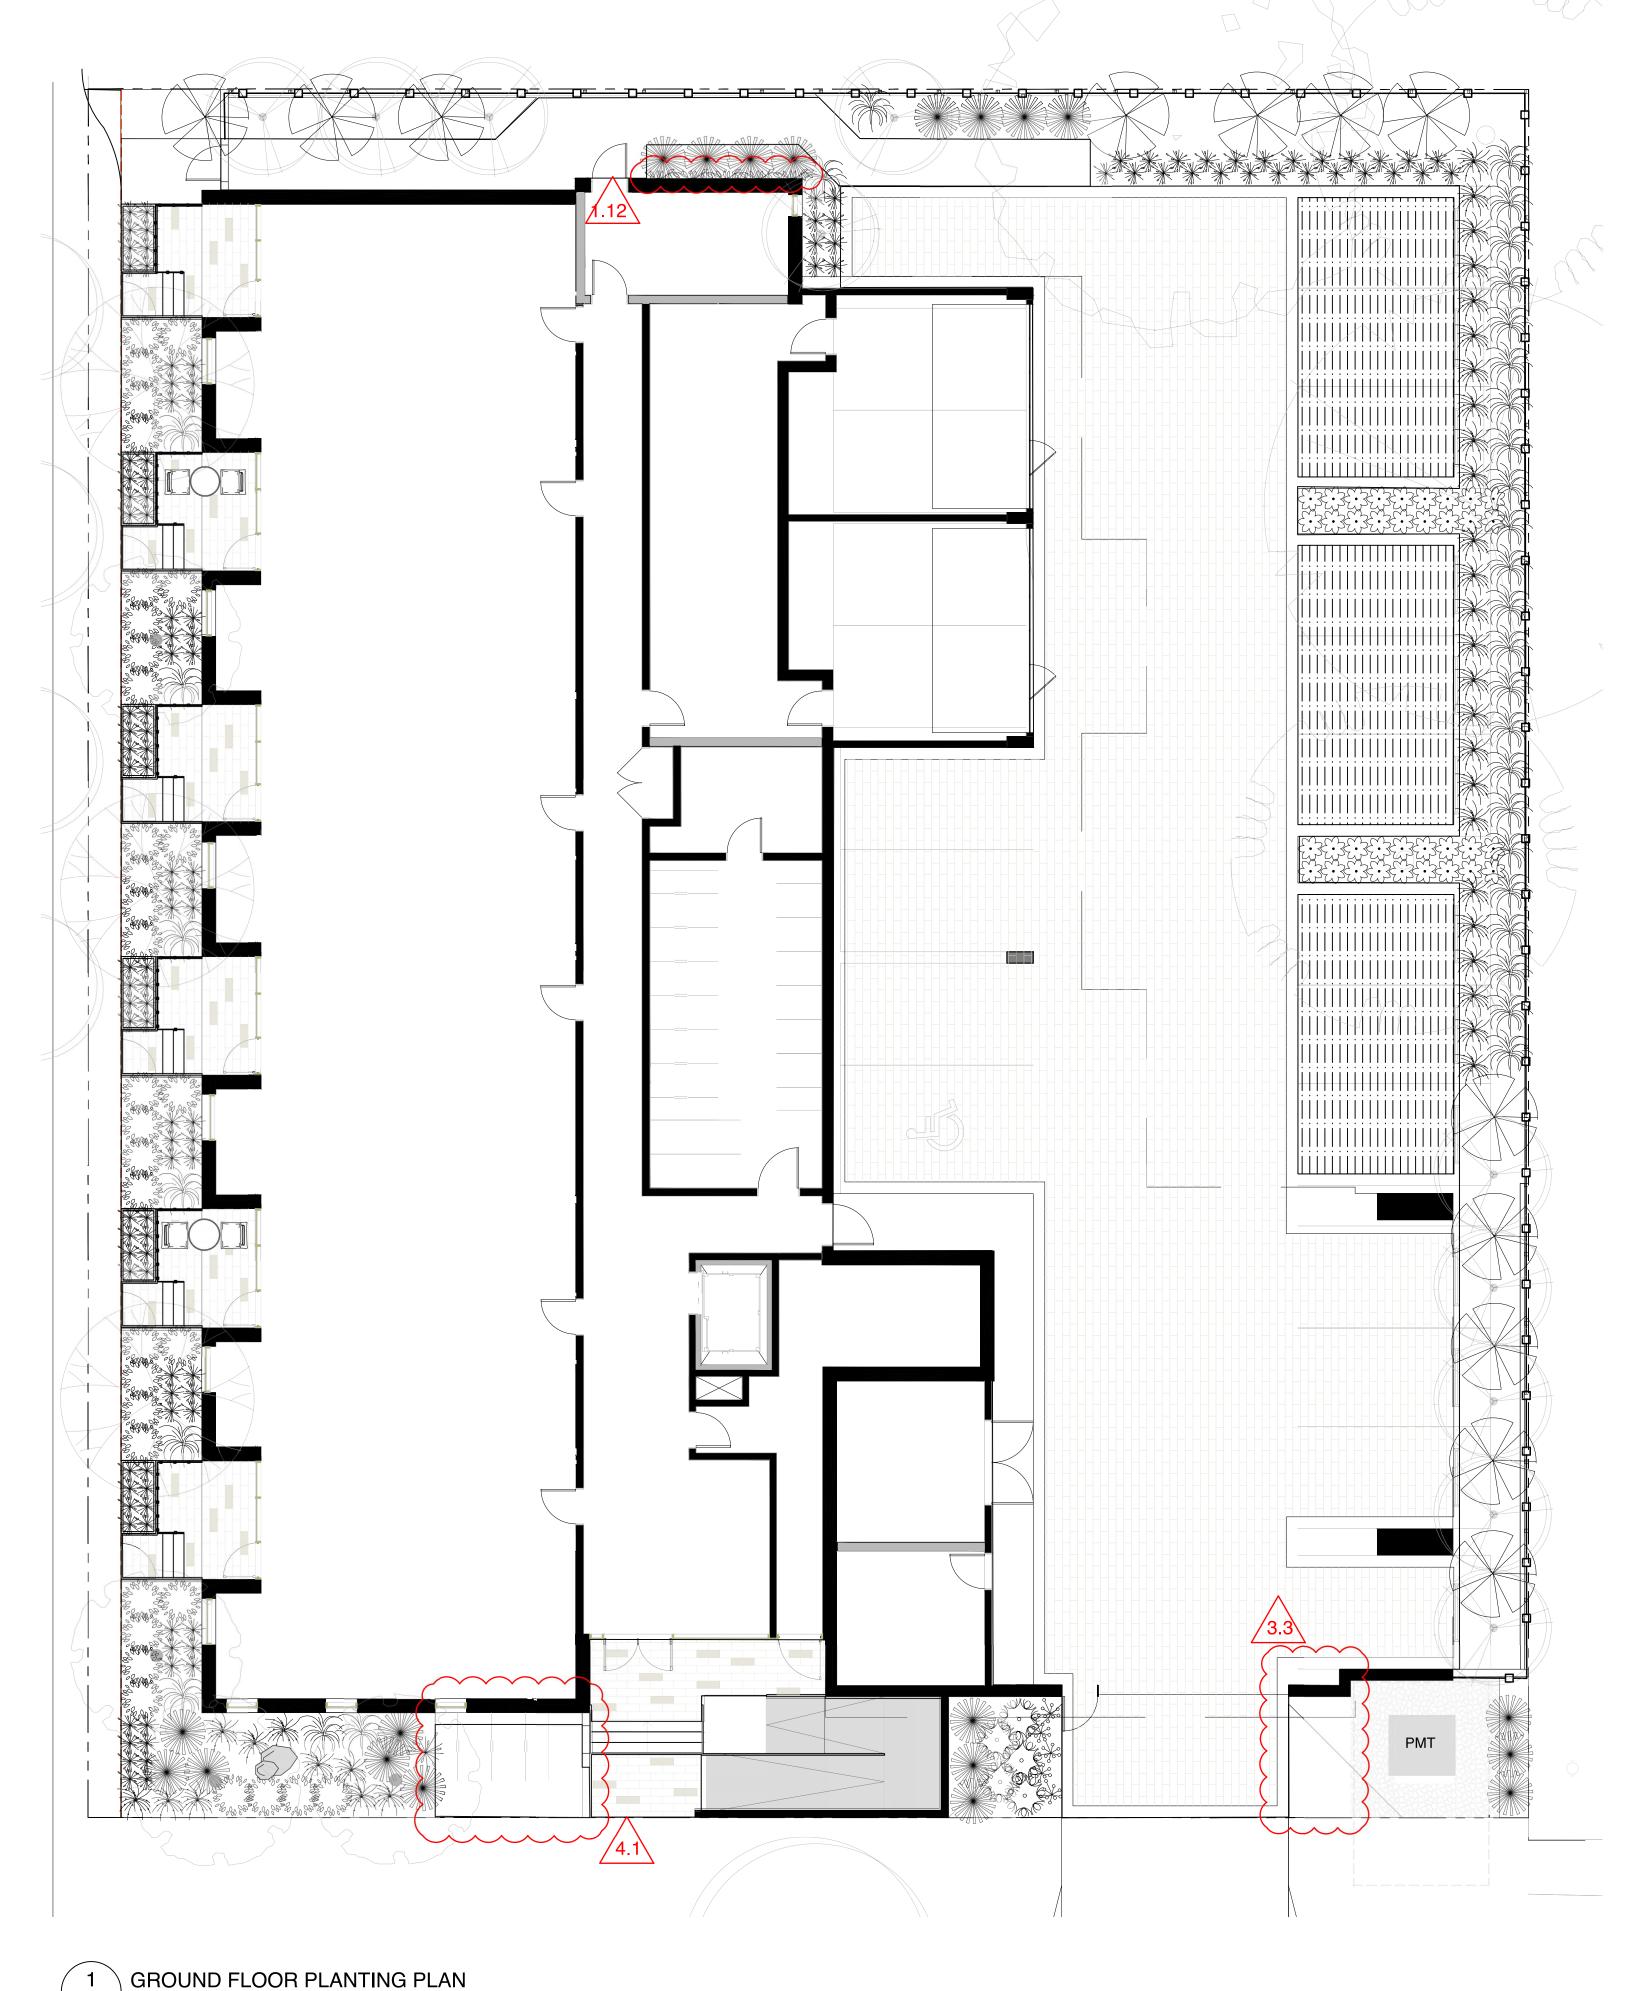















PLANT	SCHEDULE					
Quantity	Symbol	Latin Name	Common Name	Container	Native	Pollinator
1		Amelanchier canadensis	serviceberry	#5	у	у
1		Armeria maritima 'Alba'	White-flowered Thrift	tray		у
2	®:. ∵∕®	Arctostaphylos Uva-Ursi 'Massachusetts'	Kinnikinnick	tray	у	У
130	*	Carex testacea 'Prairie Fire'	New Zealand hair sedge	#1		
20		Cephalotaxus harringtonia 'Prostrata'	Spreading Japanese plum yew	#2		
4	€3	Cerastium tomentosum	Snow in summer	tray		у
12		Choisya ternata	Mexican mock orange	#3		У
20	*	Festuca glauca 'Elijah Blue'	Elijah Blue fescue	#1		
5		Hebe rakaiensis	Shrubby veronica	#1		у
35	88 8 4 8 8 4 8 8 8	llex crenata 'Compacta'	Compact Japanese Holly	#2		
35		Miscanthus sinensis 'Huron Light'	Huron Light maiden grass	#2		
33		Miscanthus sinensis 'Morning Light'	Chinese silver grass Morning Light	#2		
5		Pinus mugo 'Gnom'	Dwarf mountain pine	#2		
10		Pinus strobus 'Horsford Dwarf'	Horsford Dwarf Eastern white pine	#2		
9		Rhododendron x 'Cunningham's White'	Cunningham's white rhododendron	#4		У
5	**	Verbena bonariensis 'Lollipop'	Dwarf purpletop	#1		Y
3	ING-	Hydrangea petiolaris	Climbing hydrangea	#1		Y



NOTES:
1. PLANTS IN PLANT LISTS ARE SPECIFIED ACCORDING TO THE CANADIAN NURSERY LANDSCAPE
ASSOCIATION CANADIAN STANDARDS FOR NURSERY STOCK AND SECTION 12, CONTAINER GROWN PLANTS
FROM THE BC LANDSCAPE STANDARD, CURRENT EDITION.



1608 Camosun Street, Victoria BC V8T 3E6 Info@biophiliacollective.ca 250 590 1156

OWNER/CLIENT:

ARYZE DEVELOPMENTS

PROJECT ADDRESS:

1733 FAIRFIELD, VICTORIA, BC

DESIGNED BY: **BIANCA BODLEY** DRAWN BY: KARIANNE HOWARTH

NO. ISSUE YY\MM\DD

1 ISSUED FOR DEVELOPMENT TRACKER 22\03\04

2 ISSUED FOR RZ/DP 22\05\02

3 ISSUED FOR COORDINATION 22\07\18

4 ISSUED FOR RZ/ DP 22\07\20





NORTH ARROW

H ARROW

DRAWING TITLE:


GROUND FLOOR


PLANTING PLAN


DWG NO:

L3 1:100

SCALE: 1:100

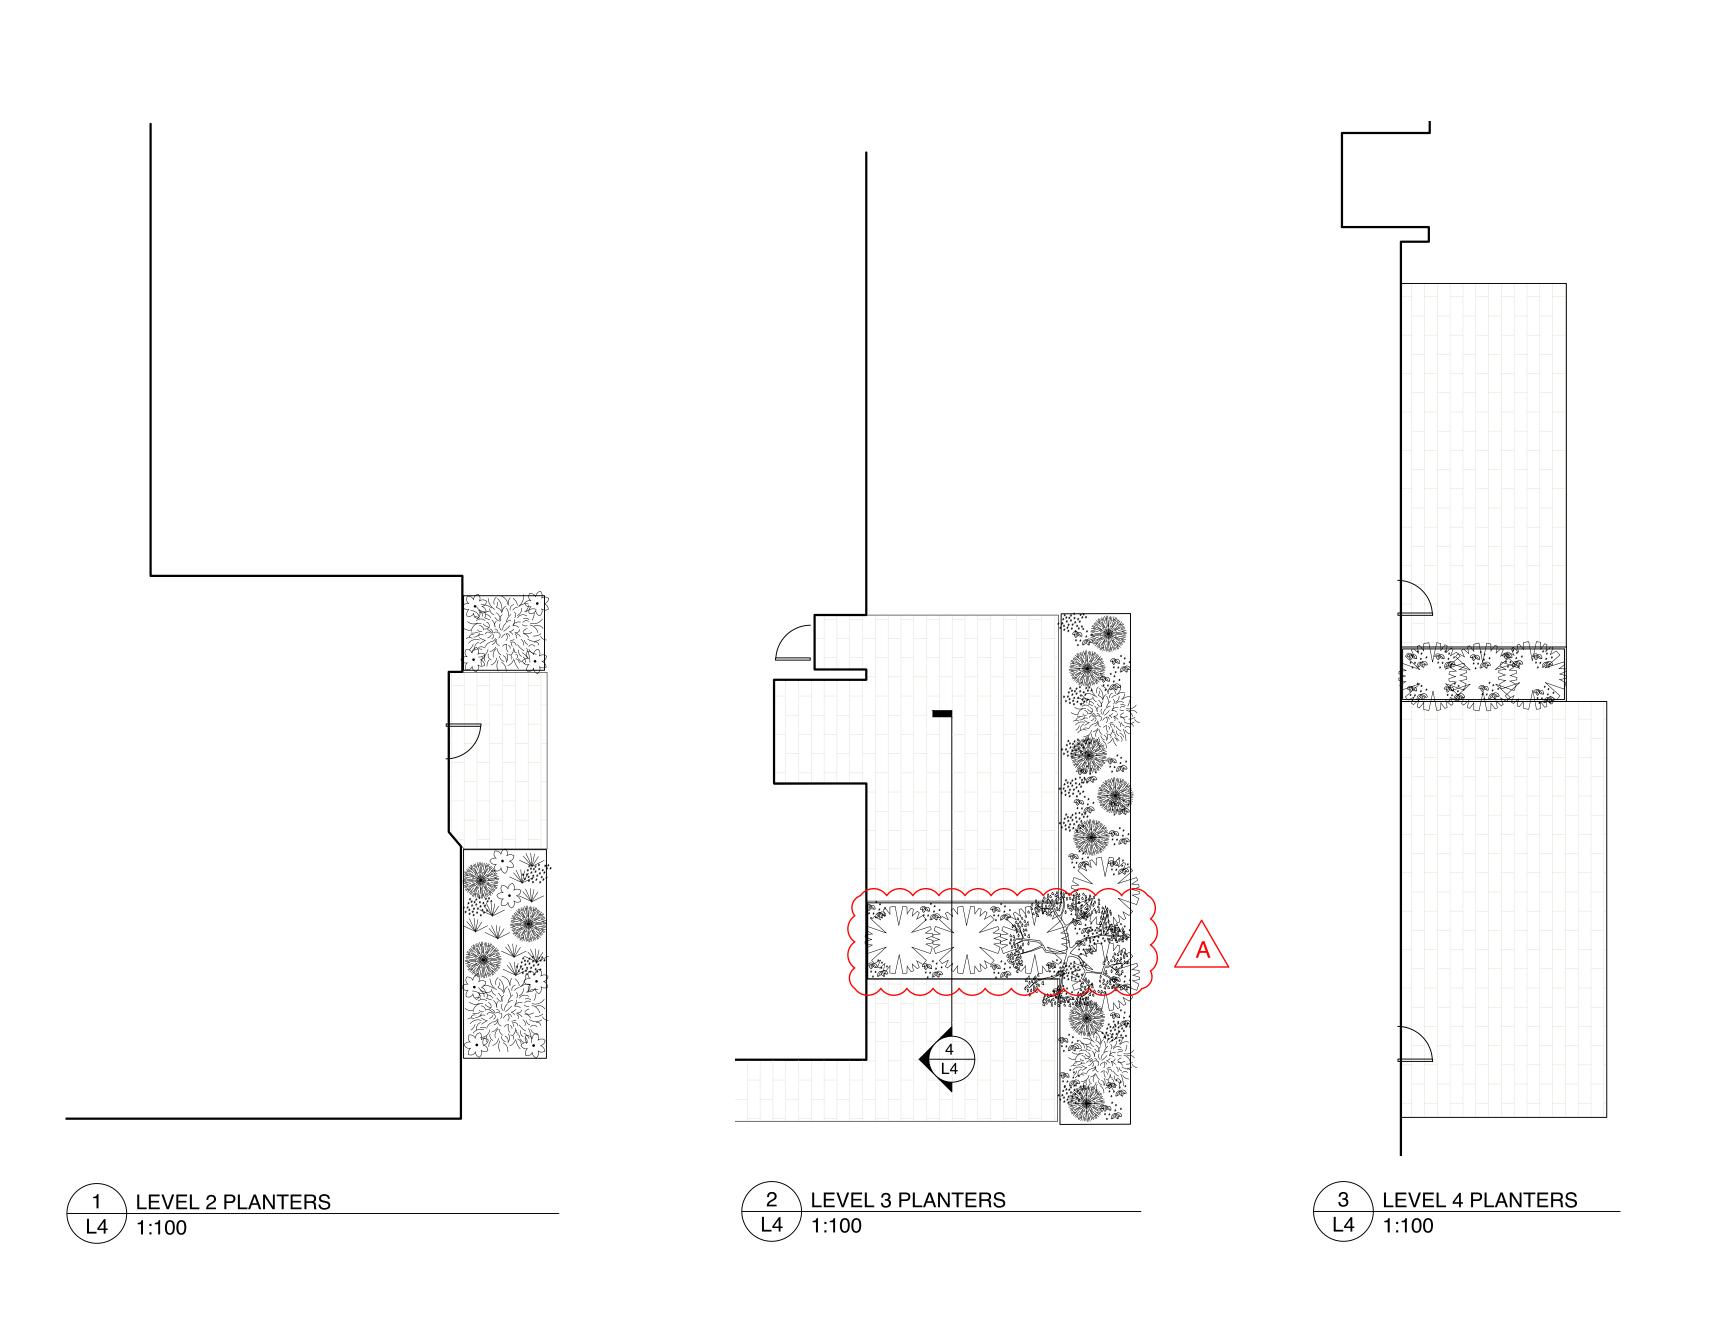

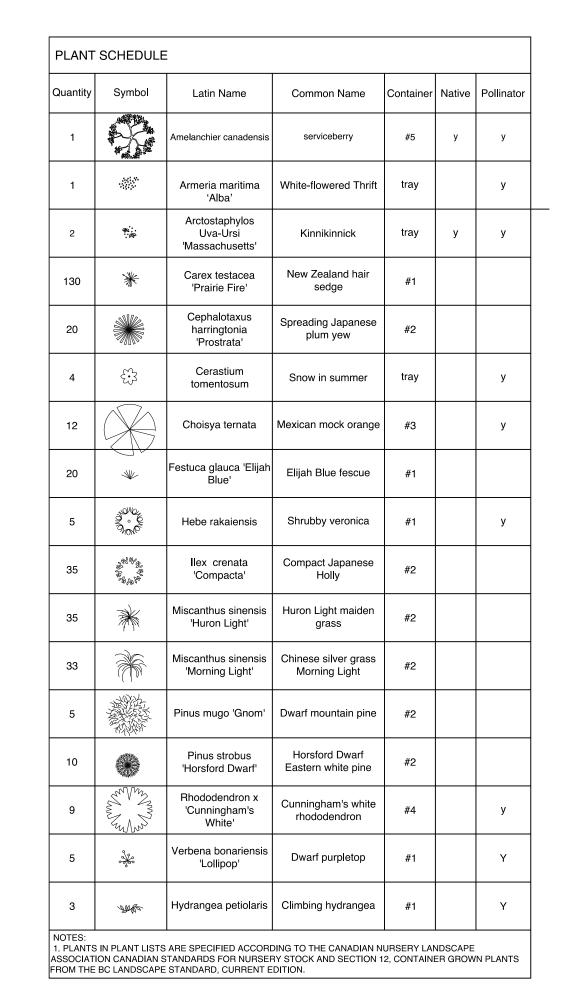

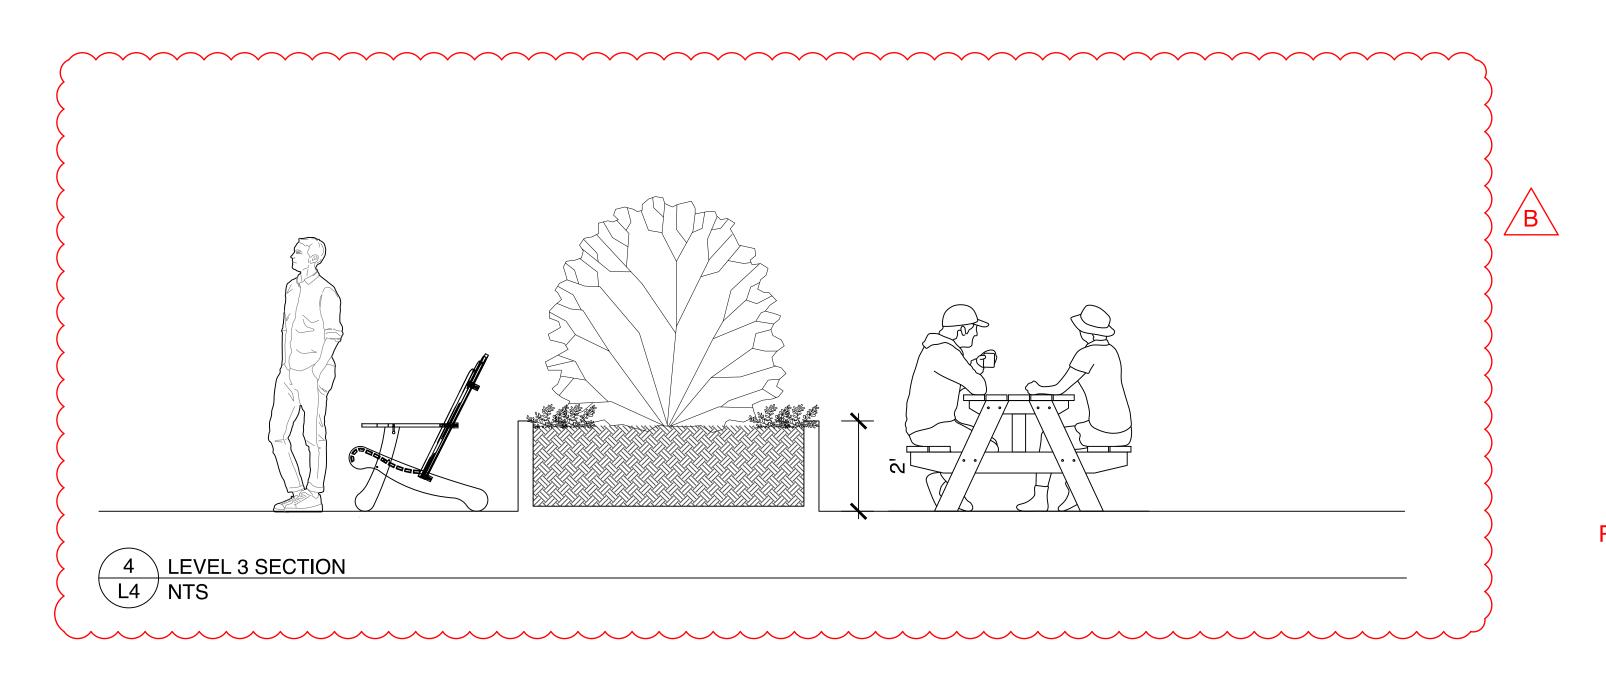

## **REVISIONS:**

- A. TREE WAS MOVED TOWARDS EAST. TALL SHRUBS WERE
- PROPOSED FOR PRIVACY
- B. A SECTION THROUGH THE PATIOS AND PLANTER WAS ADDED.



1608 Camosun Street, Victoria BC V8T 3E6 Info@biophiliacollective.ca 250 590 1156

OWNER/CLIENT:


## ARYZE DEVELOPMENTS

PROJECT ADDRESS:

## 1733 FAIRFIELD, VICTORIA, BC

DESIGNED BY: **BIANCA BODLEY** DRAWN BY: KARIANNE HOWARTH

NO.	ISSUE	YY\MM\DD
1	ISSUED FOR DEVELOPMENT TRACKER	22\03\04
2	ISSUED FOR RZ/DP	22\05\02
3	ISSUED FOR COORDINATION	22\07\18
4	ISSUED FOR RZ/ DP	22\07\20

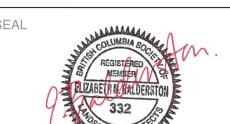




DRAWING TITLE:

UPPER LEVEL
PLANTING PLANS


DWG NO:






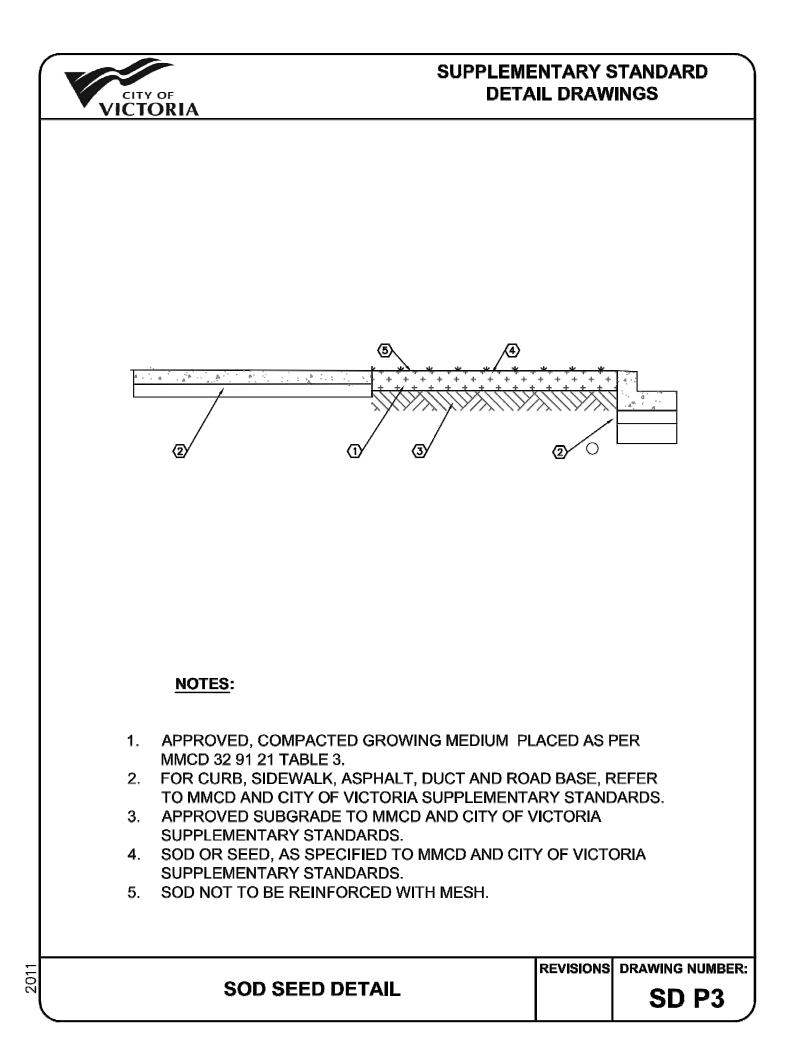



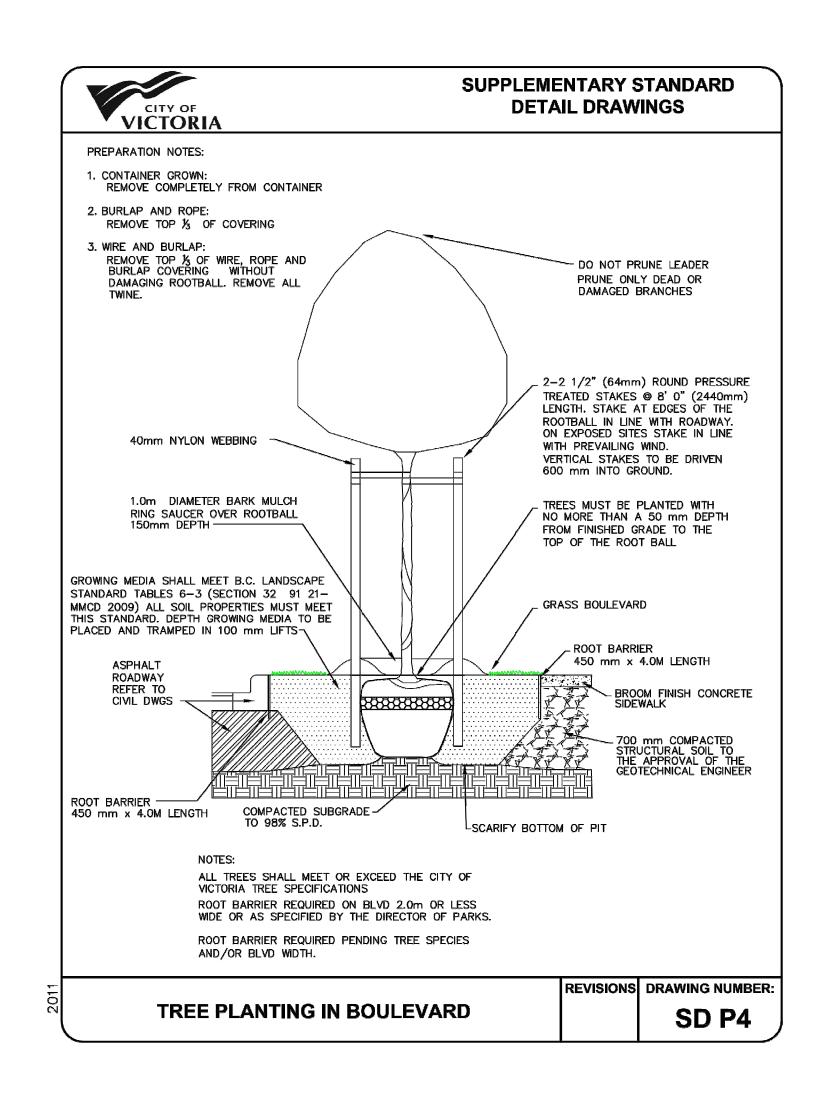

2 TREE PLANTING IN BOULEVARD
L5 NTS

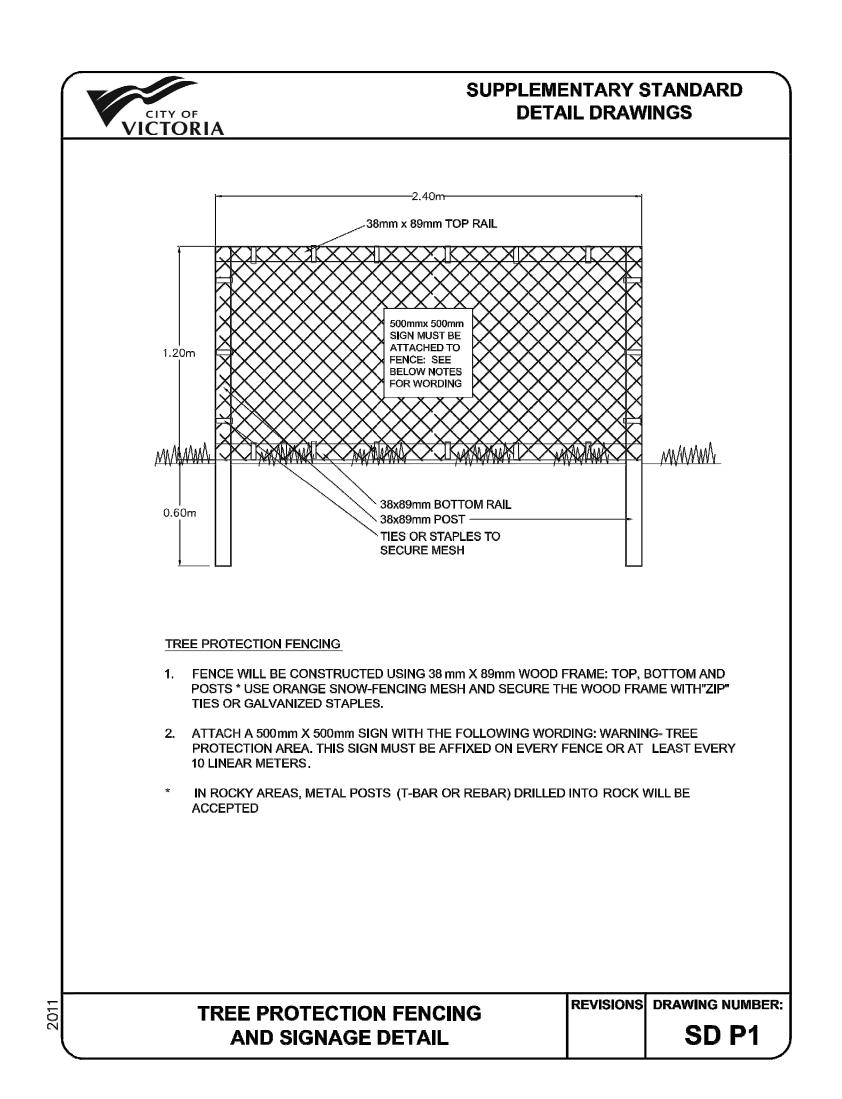

TREE PROTECTION FENCING AND SIGNAGE DETAIL

L5 NTS



1608 Camosun Street, Victoria BC V8T 3E6 Info@biophiliacollective.ca 250 590 1156

OWNER/CLIENT:

ARYZE DEVELOPMENTS

PROJECT ADDRESS:

1733 FAIRFIELD, VICTORIA, BC

DESIGNED BY: BIANCA BODLEY
DRAWN BY: KARIANNE HOWARTH

NO. ISSUE YYVMM\DD

1 ISSUED FOR DEVELOPMENT TRACKER 22\03\04

2 ISSUED FOR RZ/DP 22\05\02

3 ISSUED FOR COORDINATION 22\07\18

4 ISSUED FOR RZ/ DP 22\07\20

l \_\_\_



NORTH ARROW

DETAILS

DWG NO:

OTED

SCALE: AS NOTED