



750 - 780 SUMMIT AVE

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CODE DATA


PRELIMINARY CODE ANALYSIS		
BUILDING AREA (FOOTPRINT):	1661 m ²	
NO. OF STORIES:	4	
BASEMENT:	YES	
USE AND OCCUPANCY		
F3	STORAGE GARAGE	
ARTICLE		
3.2.2.84	F3 UP TO 4 STORIES - SPRINKLERED	
NO. OF STREETS	2	
MAXIMUM BUILDING AREA	3600 m ²	
CONSTRUCTION TYPE	NON - COMBUSTIBLE	
FIRE RESISTANCE RATING	FLOOR TO BE NON-RATED FIRE SEPARATIONS	
OCCUPANT LOAD:	NONE - VEHICLE PARKING ONLY	
SPRINKLERED:	YES	
TRAVEL DISTANCE (45m ALLOWED):	MAXIMUM - 28-37m	

SITE AERIAL VIEW



EXISTING SITE PLAN



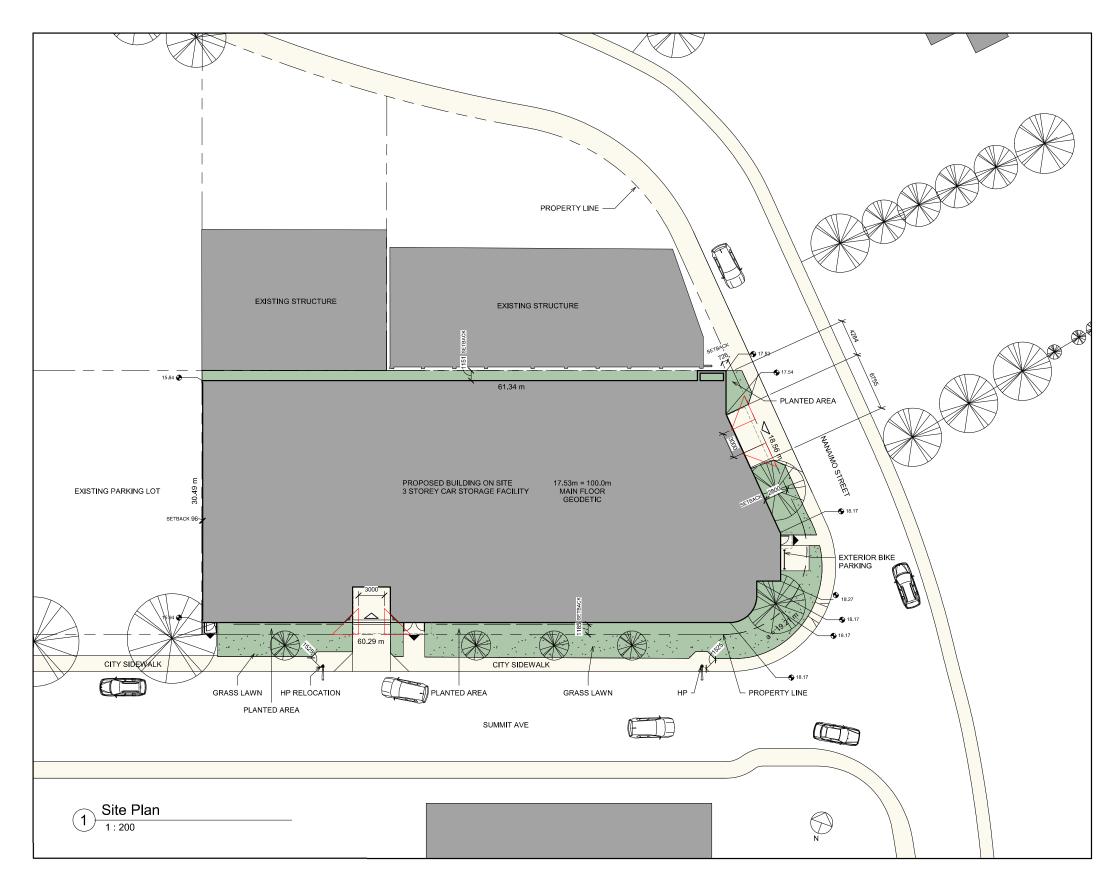



PROJECT INFORMATION

SITE DATA + ZONING			
CIVIC ADDRESS:	750 & 780 SUMMIT AVENUE		
LEGAL DESCRIPTION:	LOT 16 - SECTION 4, VICTORIA, PLAN 21108		
	LOT 15 - SECTION 4, V	ICTORIA, PLAN 21108	
CURRENT USE:	CLUB		
PROPOSED USE :	GARAGE		
ZONE (EXISTING) :	M2 - I		
DP AREA:	DPA 7A - CORRIDOR		
SITE AREA (m ²):	2031 m ²		
LOT WIDTH	30.49m		
FLOOR AREA	m²	APPLICABLE TO FSR	
BASEMENT	SEMENT 638 0		
MAIN FLOOR	1646	1646	
SECOND FLOOR	1679	1679	
THIRD FLOOR	1679	1679	
ROOFTOP STAIRS	32	32	
TOTAL	5674 5036		
FLOOR SPACE RATIO	2.47		
BUILDING HEIGHT	13.451 m		
NUMBER OF STORIES	4		
SETBACKS			
LOT BOUNDARY (SUMMIT):	1185 mm		
LOT BOUNDARY (NANAIMO):	726 mm		
LOT BOUNDARIES - WEST :	96 mm		
LOT BOUNDARIES - NORTH :	1151 mm		
SITE COVERAGE:	m² %		
BUILDING FOOTPRINT	1745	86	
DRIVEWAYS	61	3	
SOFT LANDSCAPE + SIDEWALK	225	11	
TOTAL SITE	2031	100	
LOADING SPACE:	NONE PROVIDED	VARIANCE REQUESTED	
PARKING SPACES:			
BIKE PARKING STALLS:	LONG TERM = 1		
	SHORT TERM = 6		
	TOTAL = 7		

LEGEND



VEHICLE ACCESS

PEDESTRIAN EXIT


EXISTING AVERAGE GRADE

AVERAGE GRADE

GRADE POINTS:	CALCULAT	ONS:	AVERAGE:	DISTANCE:	TOTAL:
A-B	(15.64+17.53	3)/2	16.585	60.45	1002.563
B-C	(17.53+17.54)/2		17.535	3.85	67.510
C-D	(17.54+18.17	')/2	17.855	14.947	266.879
D-E	(18.17+18.27)/2		18.22	5.415	98.661
E-F	(18.27+18.17)/2		18.22	2.64	48.101
F-G	(18.17+18.21)/2	18.19	1.985	36.107
G-H	(18.21+18.19	9)/2	18.2	4.869	88.616
H-J	(18.19+15.94)/2		17.065	60.91	1039.429
J-A	(15.94+15.64)/2		15.79	27.95	441.331
					3089.196
BUILDING PERIMETER				183.016	
AVERAGE GRADE 16.879			16.879		
MAIN FLOOR GEODETIC: 1		17.	53		
MAIN FLOOR SLAB: 100)			
TOP OF STAIR TOWER: 112		.8			
HEIGHT OF STAIR TOWER: 12.1		в			
TOP OF STAIR GEODETIC: 30.		33			
BUILDING HEIGH	BUILDING HEIGHT:		451		

ARCH SITE PLAN



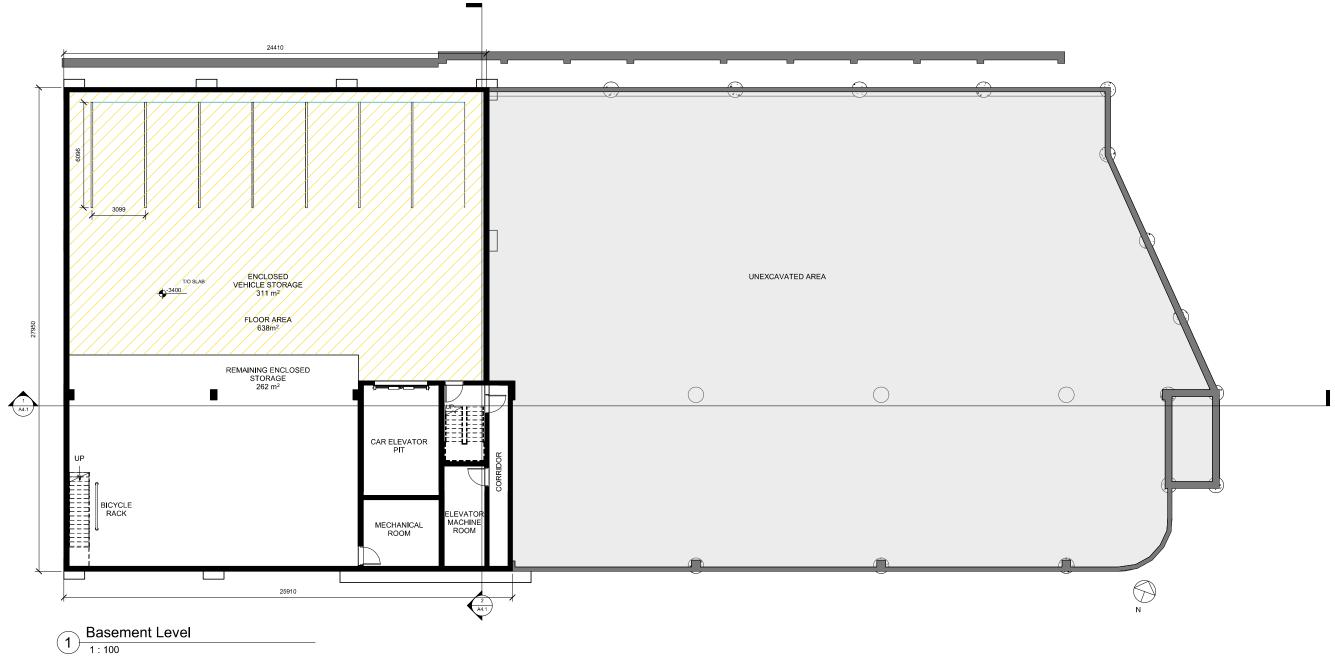







750 - 780 SUMMIT AVE





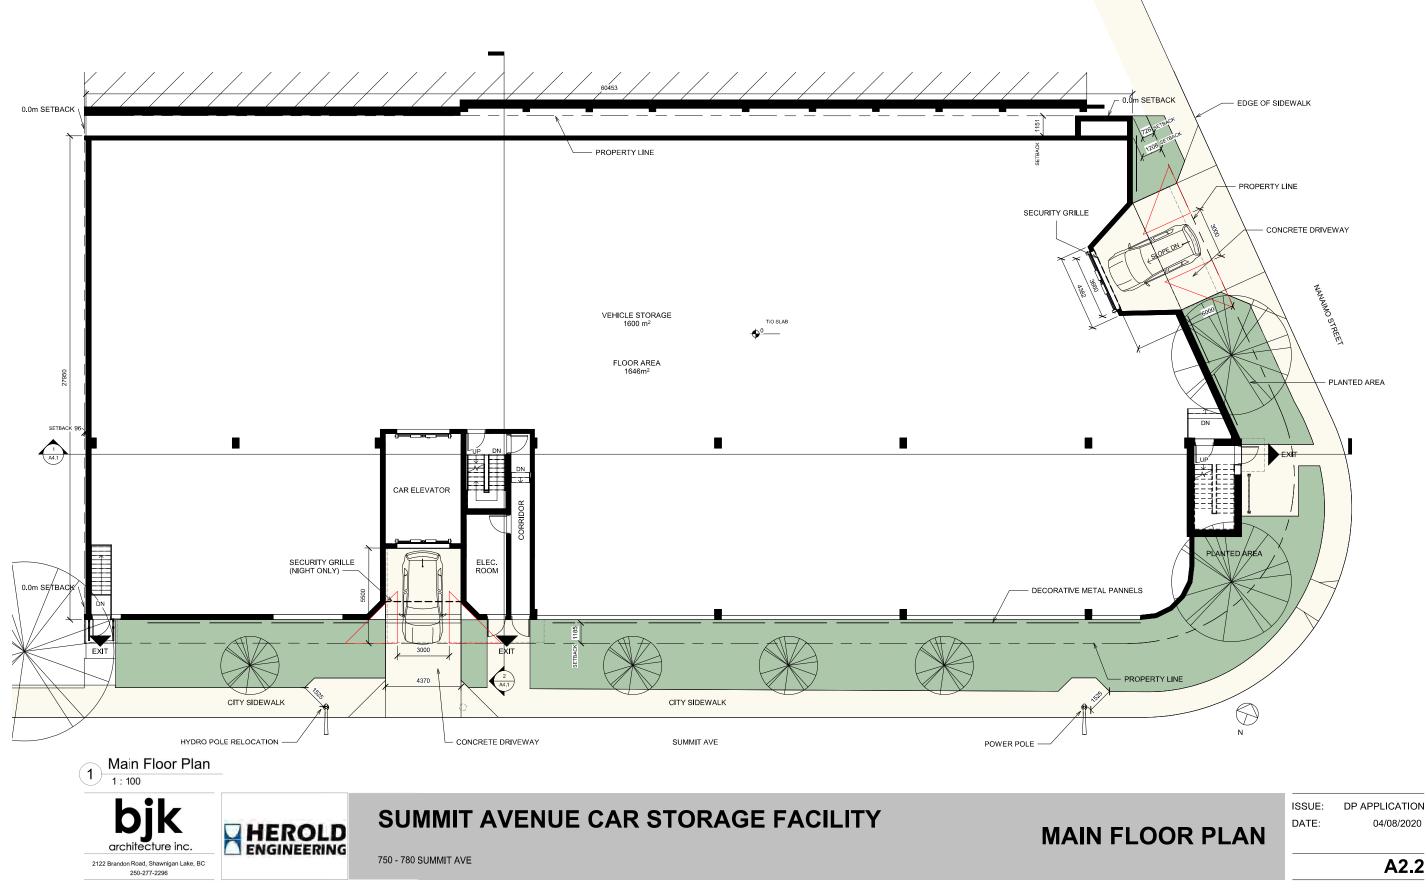

DP APPLICATION 04/08/2020

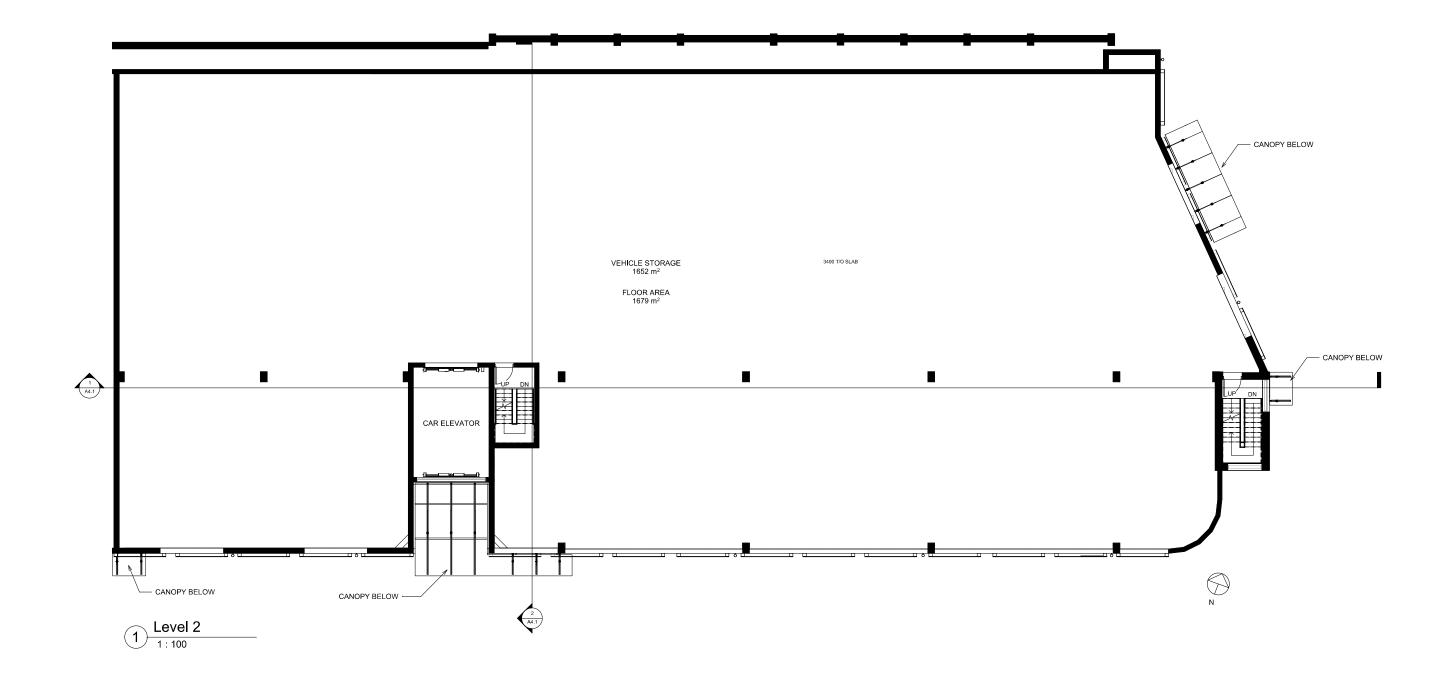




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LEVEL 2 PLAN



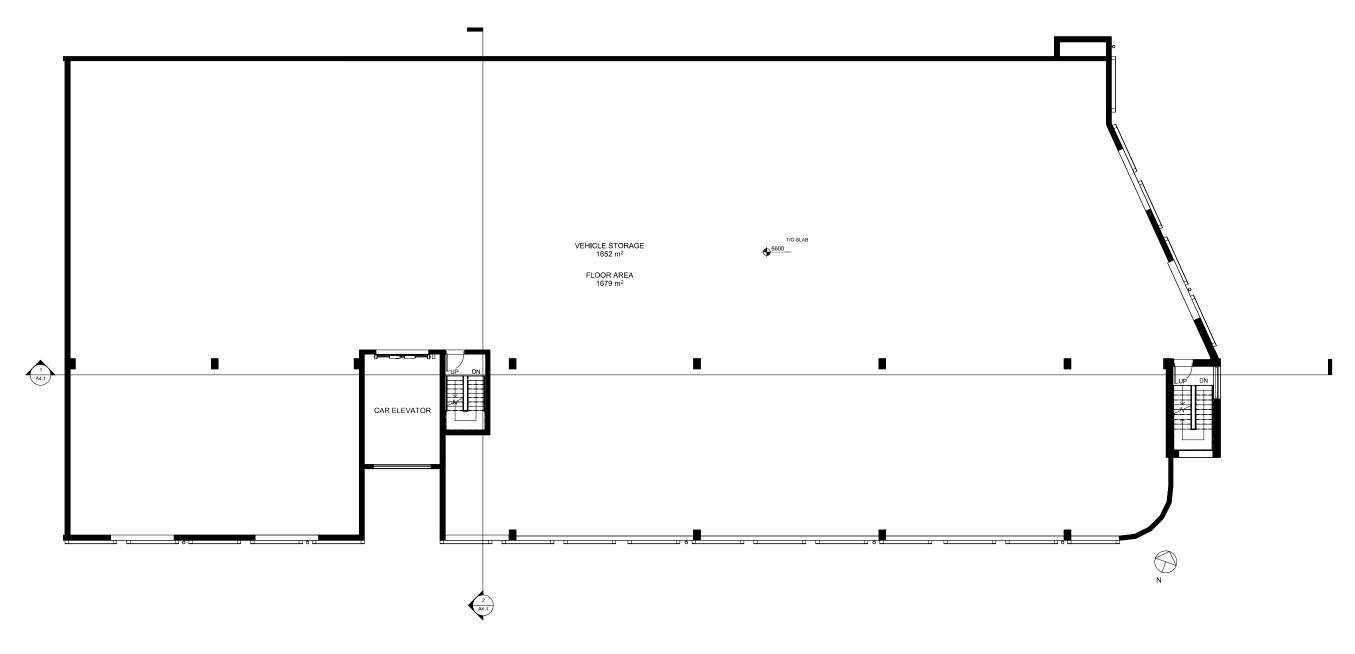

1 Level 3




SUMMIT AVENUE CAR STORAGE FACILITY

750 - 780 SUMMIT AVE





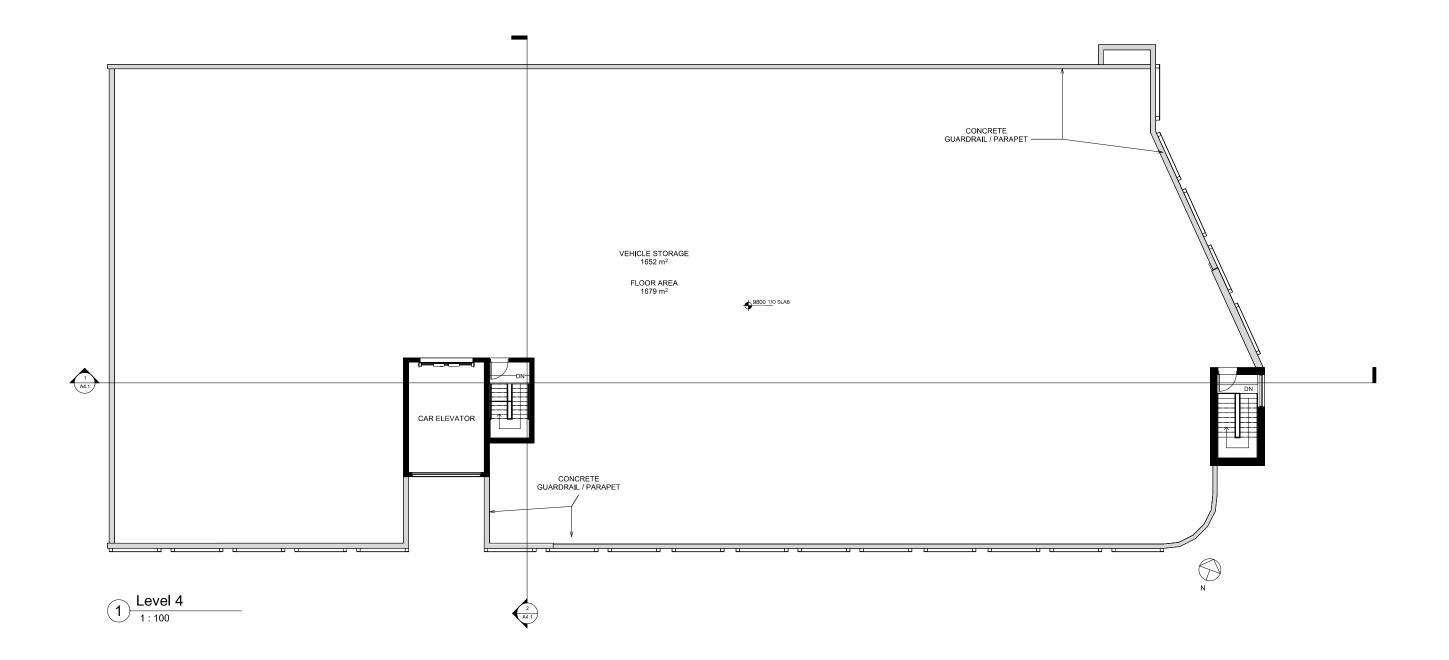



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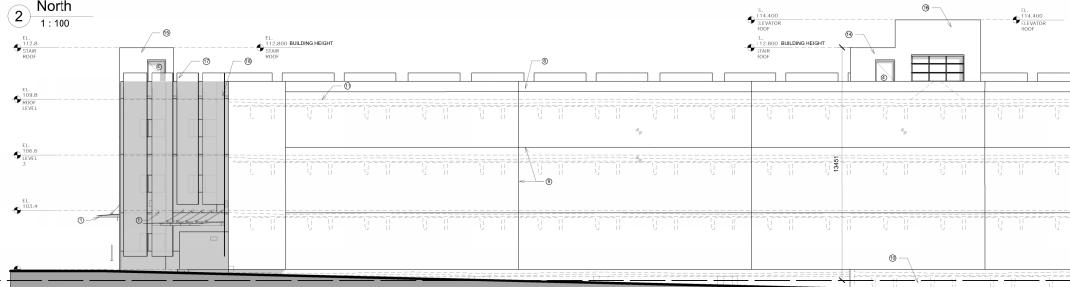
LEVEL 4 - ROOF PLAN


ISSUE: DP APPLICATION DATE: 04/08/2020

A2.5



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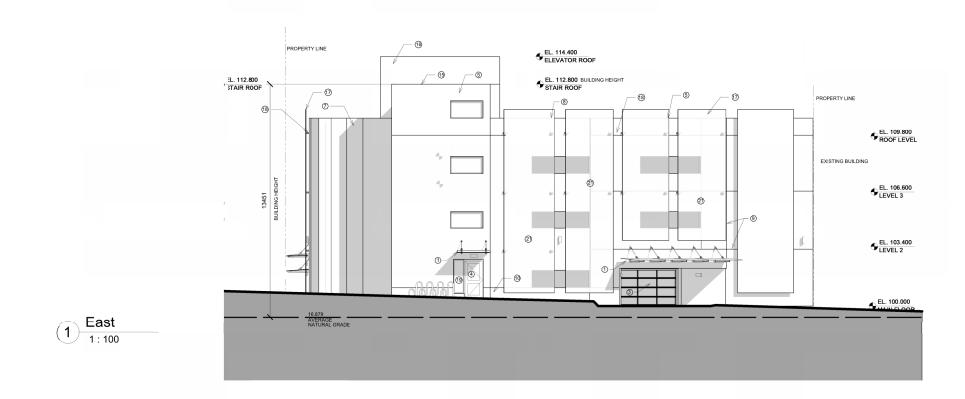


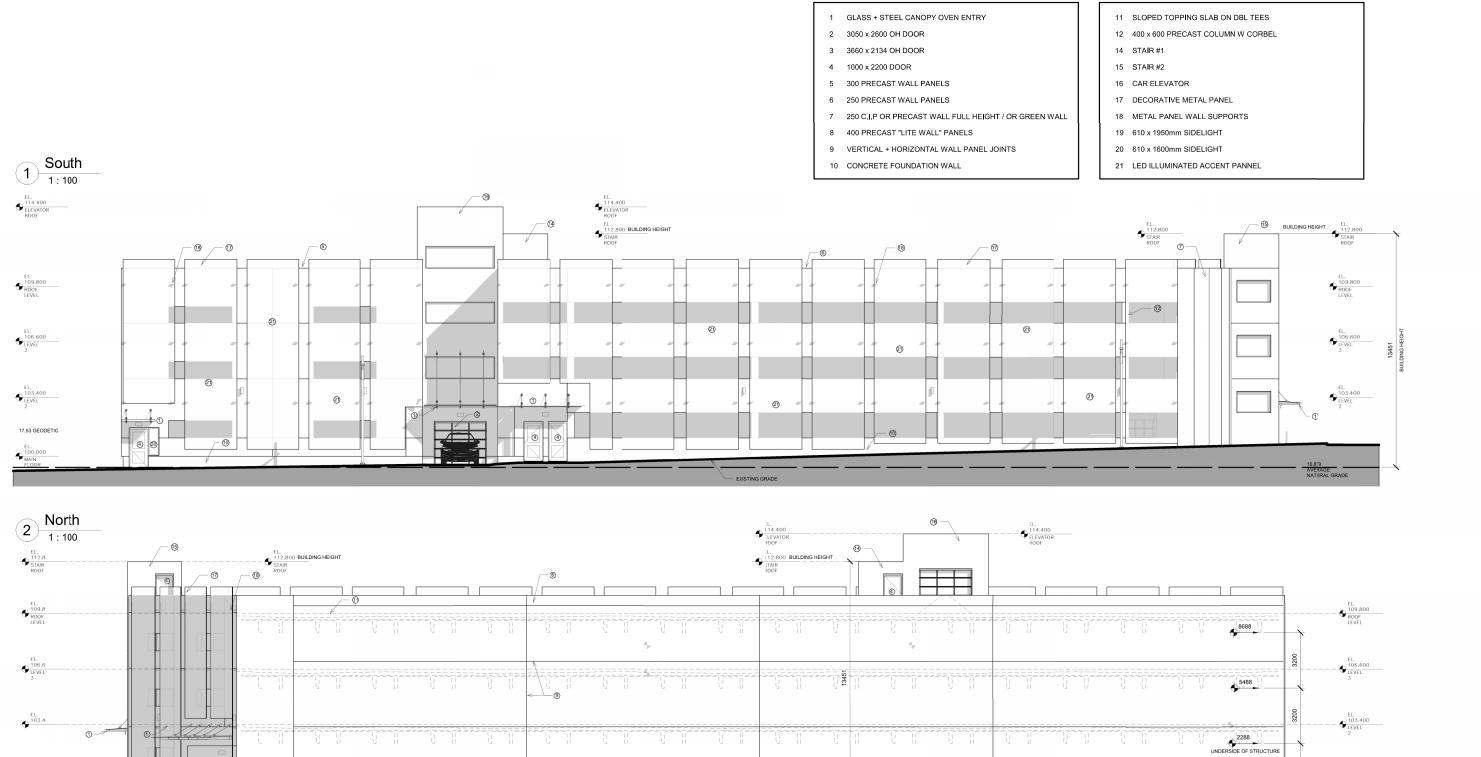


KEY NOTES

AVERAGE GRADE ELEVATION ISSUE: DP APPLICATION DATE: 04/08/2020 **ELEVATIONS** A3.1

ATURAL GRADE



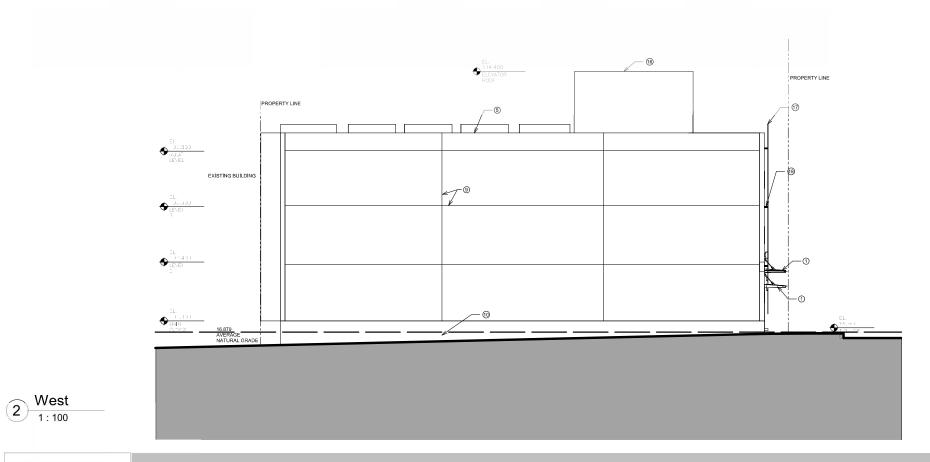

750 - 780 SUMMIT AVE

bjk

architecture inc.

2122 Brandon Road, Shawnigan Lake, BC 250-277-2296

KEY NOTES

- 1 GLASS + STEEL CANOPY OVEN ENTRY
- 2 3050 x 2600 OH DOOR
- 3 3660 x 2134 OH DOOR
- 4 1000 x 2200 DOOR
- 5 300 PRECAST WALL PANELS
- 6 250 PRECAST WALL PANELS
- 7 250 C.I.P OR PRECAST WALL FULL HEIGHT / OR GREEN WALL
- 8 400 PRECAST "LITE WALL" PANELS
- 9 VERTICAL + HORIZONTAL WALL PANNEL JOINTS
- 10 CONCRETE FOUNDATION WALL
- 11 SLOPED TOPPING SLAB ON DBL TEES
- 12 400 x 600 PRECAST COLUMN W CORBEL
- 14 STAIR #1
- 15 STAIR #2
- 16 CAR ELEVATOR
- 17 DECORATIVE METAL PANEL
- 18 METAL PANEL WALL SUPPORTS
- 19 610 x 1950mm SIDELIGHT
- 20 610 x 1600mm SIDELIGHT
- 21 LED LIGHT ILLUMINATED PORTIONS










750 - 780 SUMMIT AVE

MATERIALS BOARD

DATE:



04/08/2020

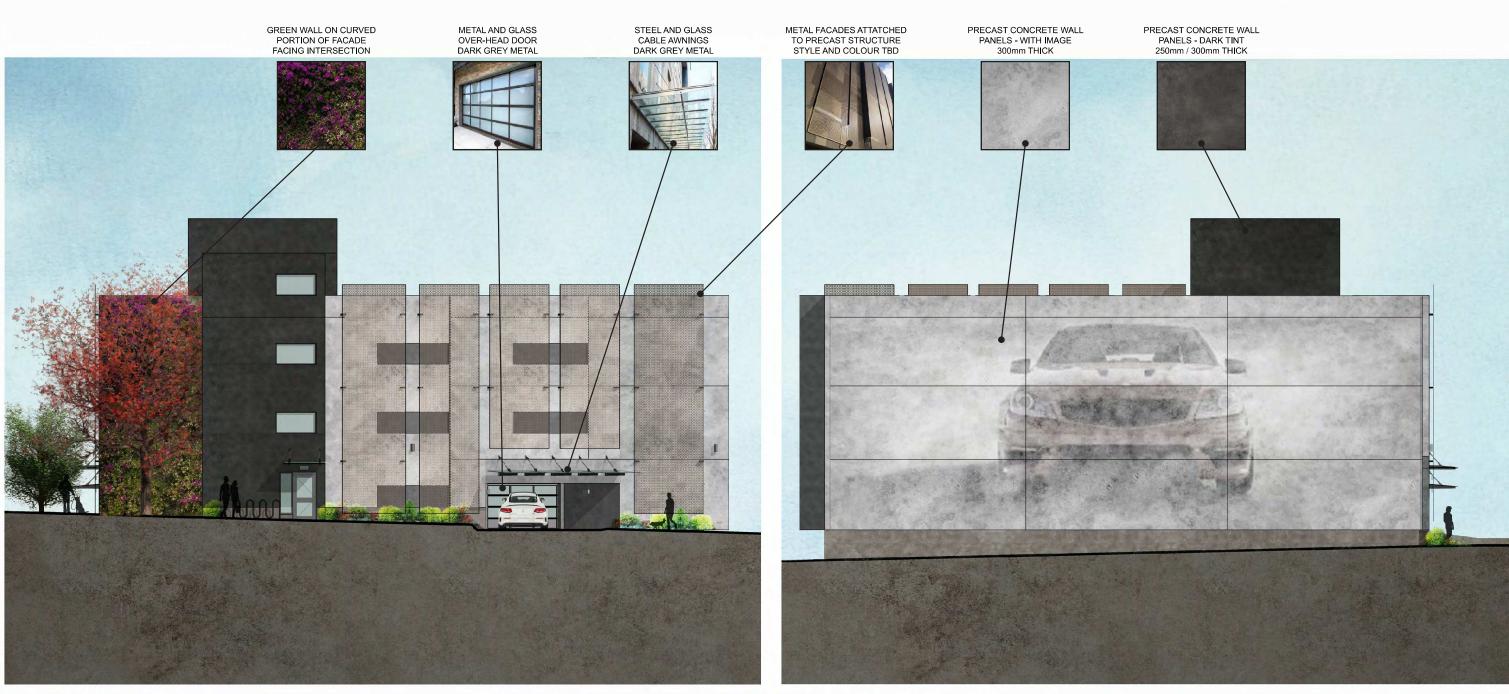

West Elevation

2

1 80

1 East Elevation




SUMMIT AVENUE CAR STORAGE FACILITY

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MATERIALS BOARD

ISSUE: DP APPLICATION DATE: 04/08/2020

A3.4



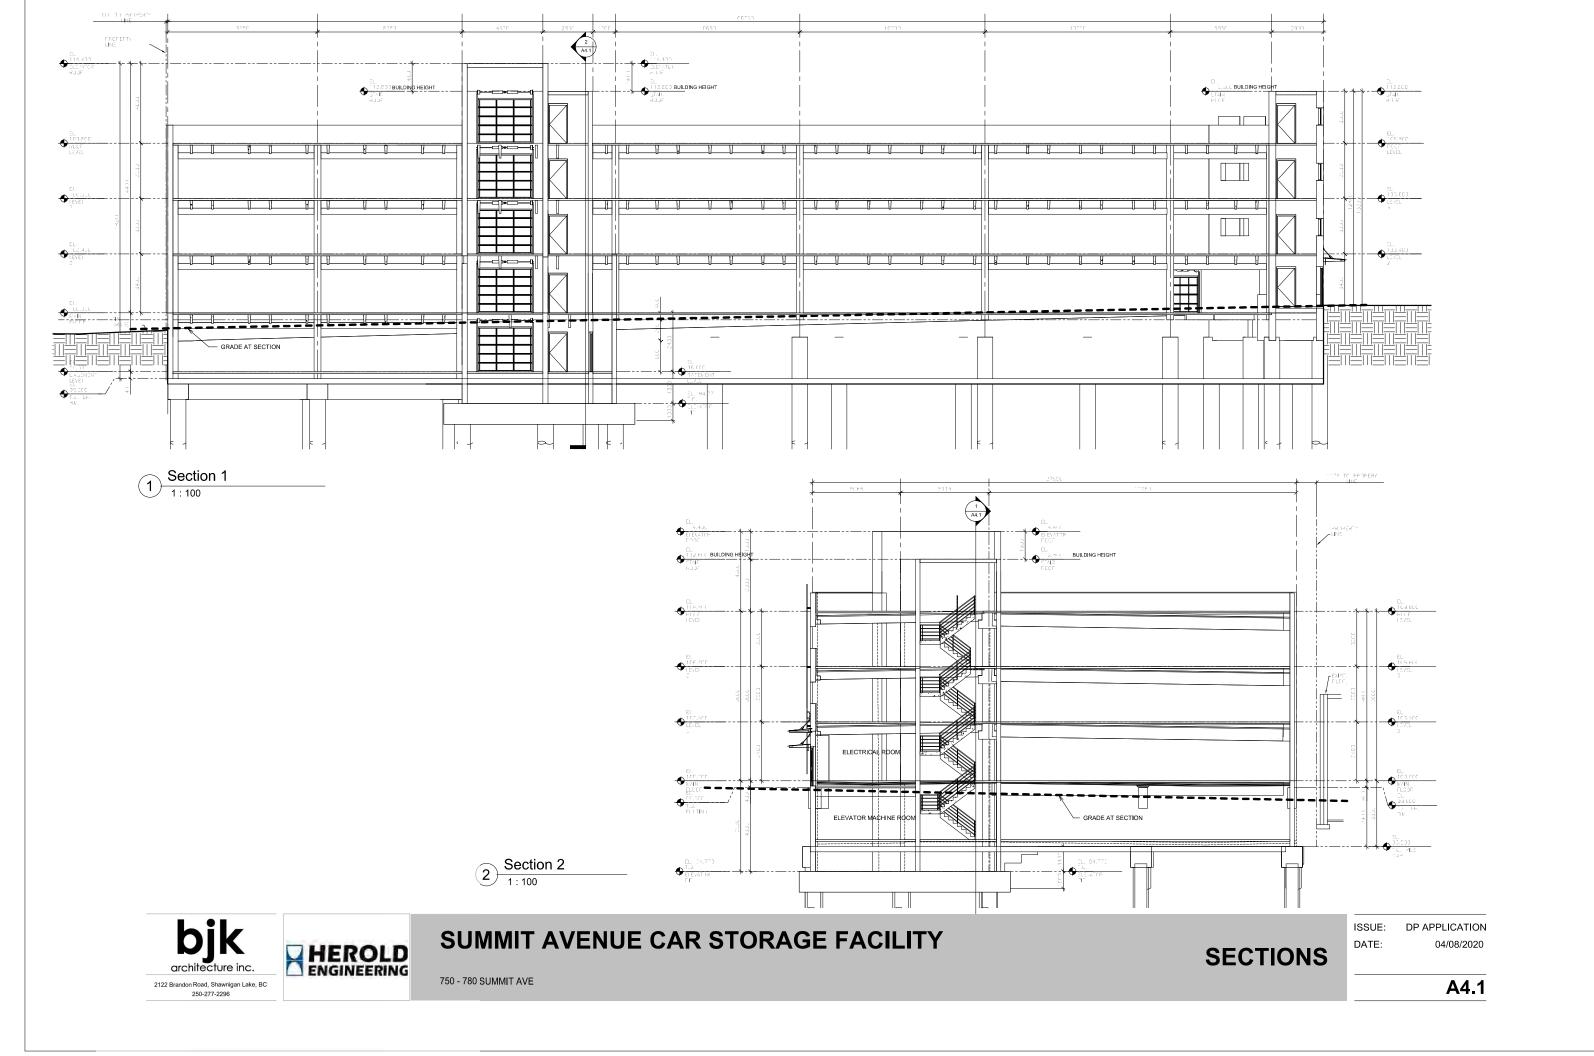



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SITE CONTEXT IMAGES









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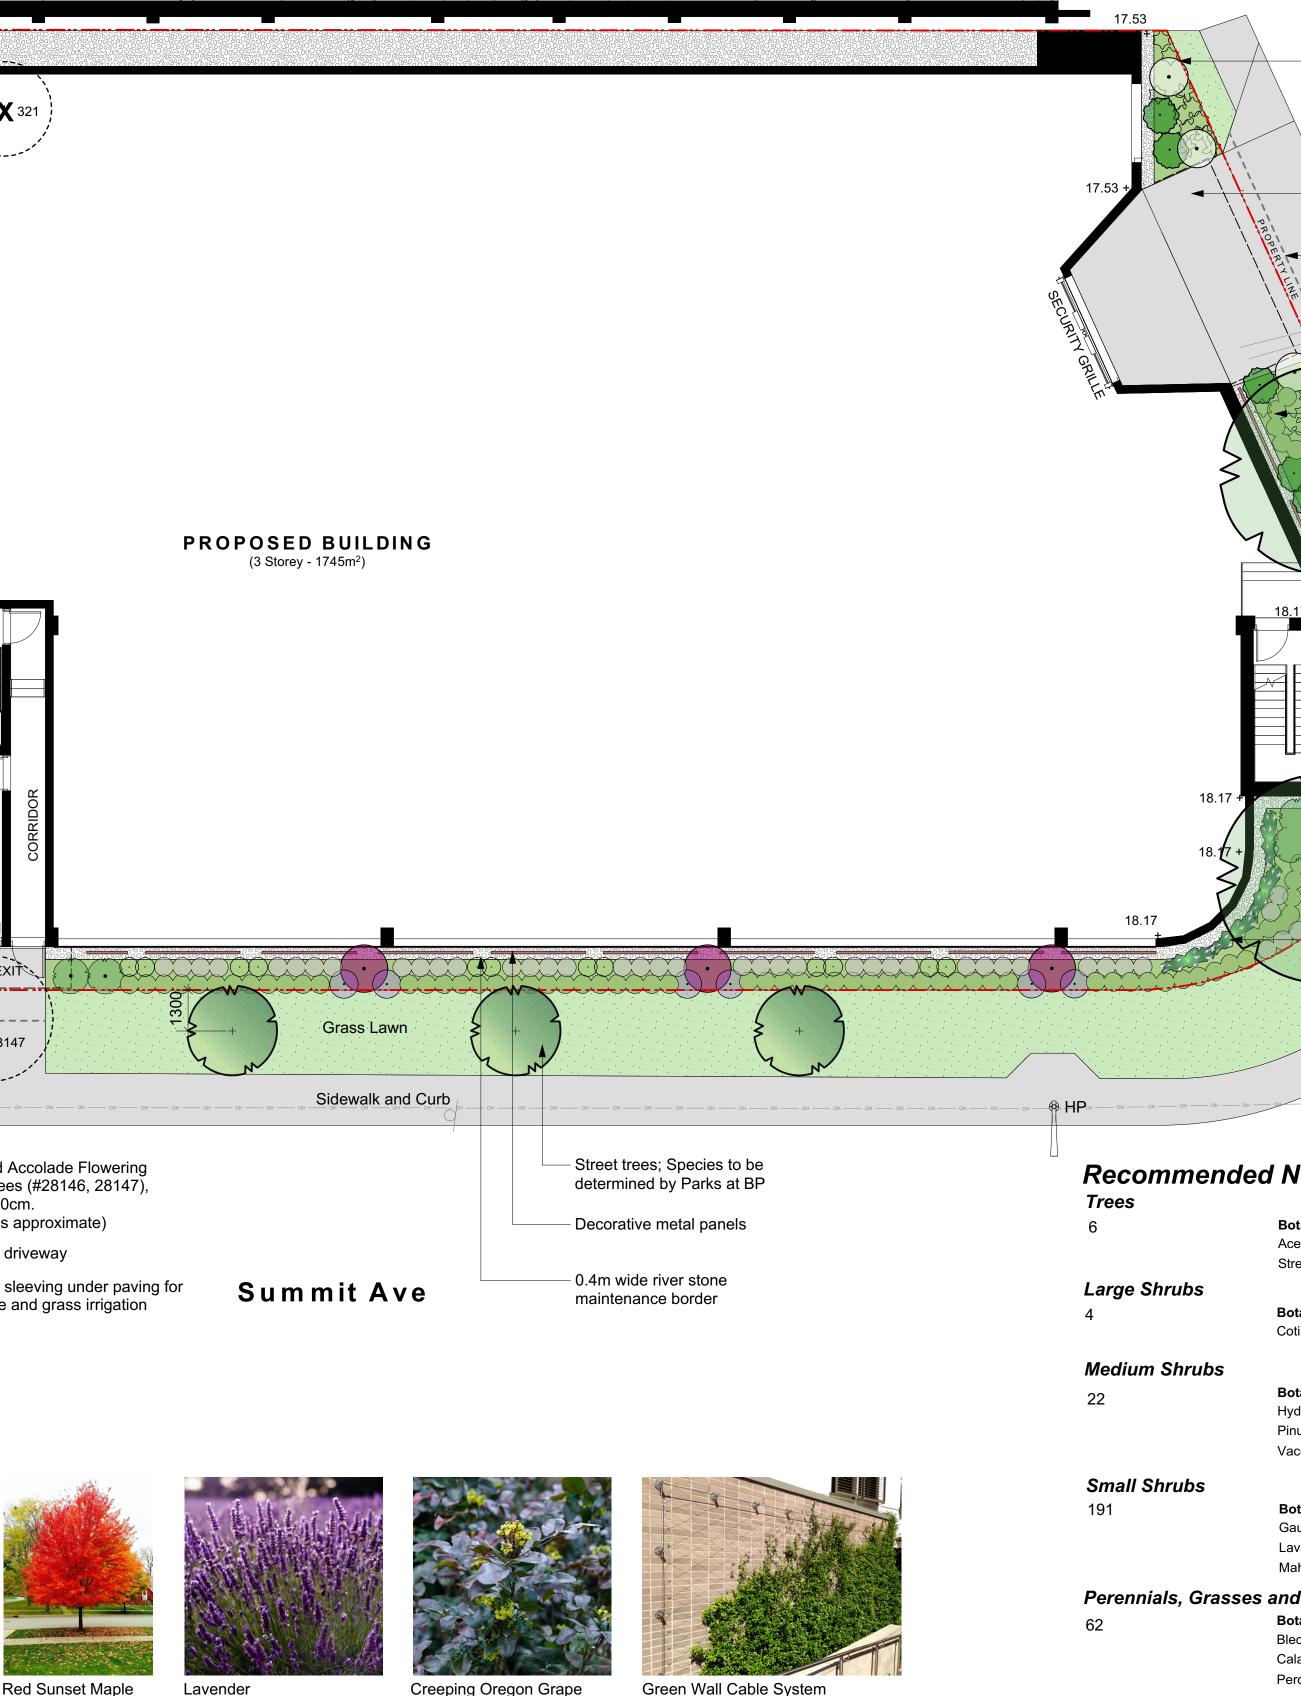




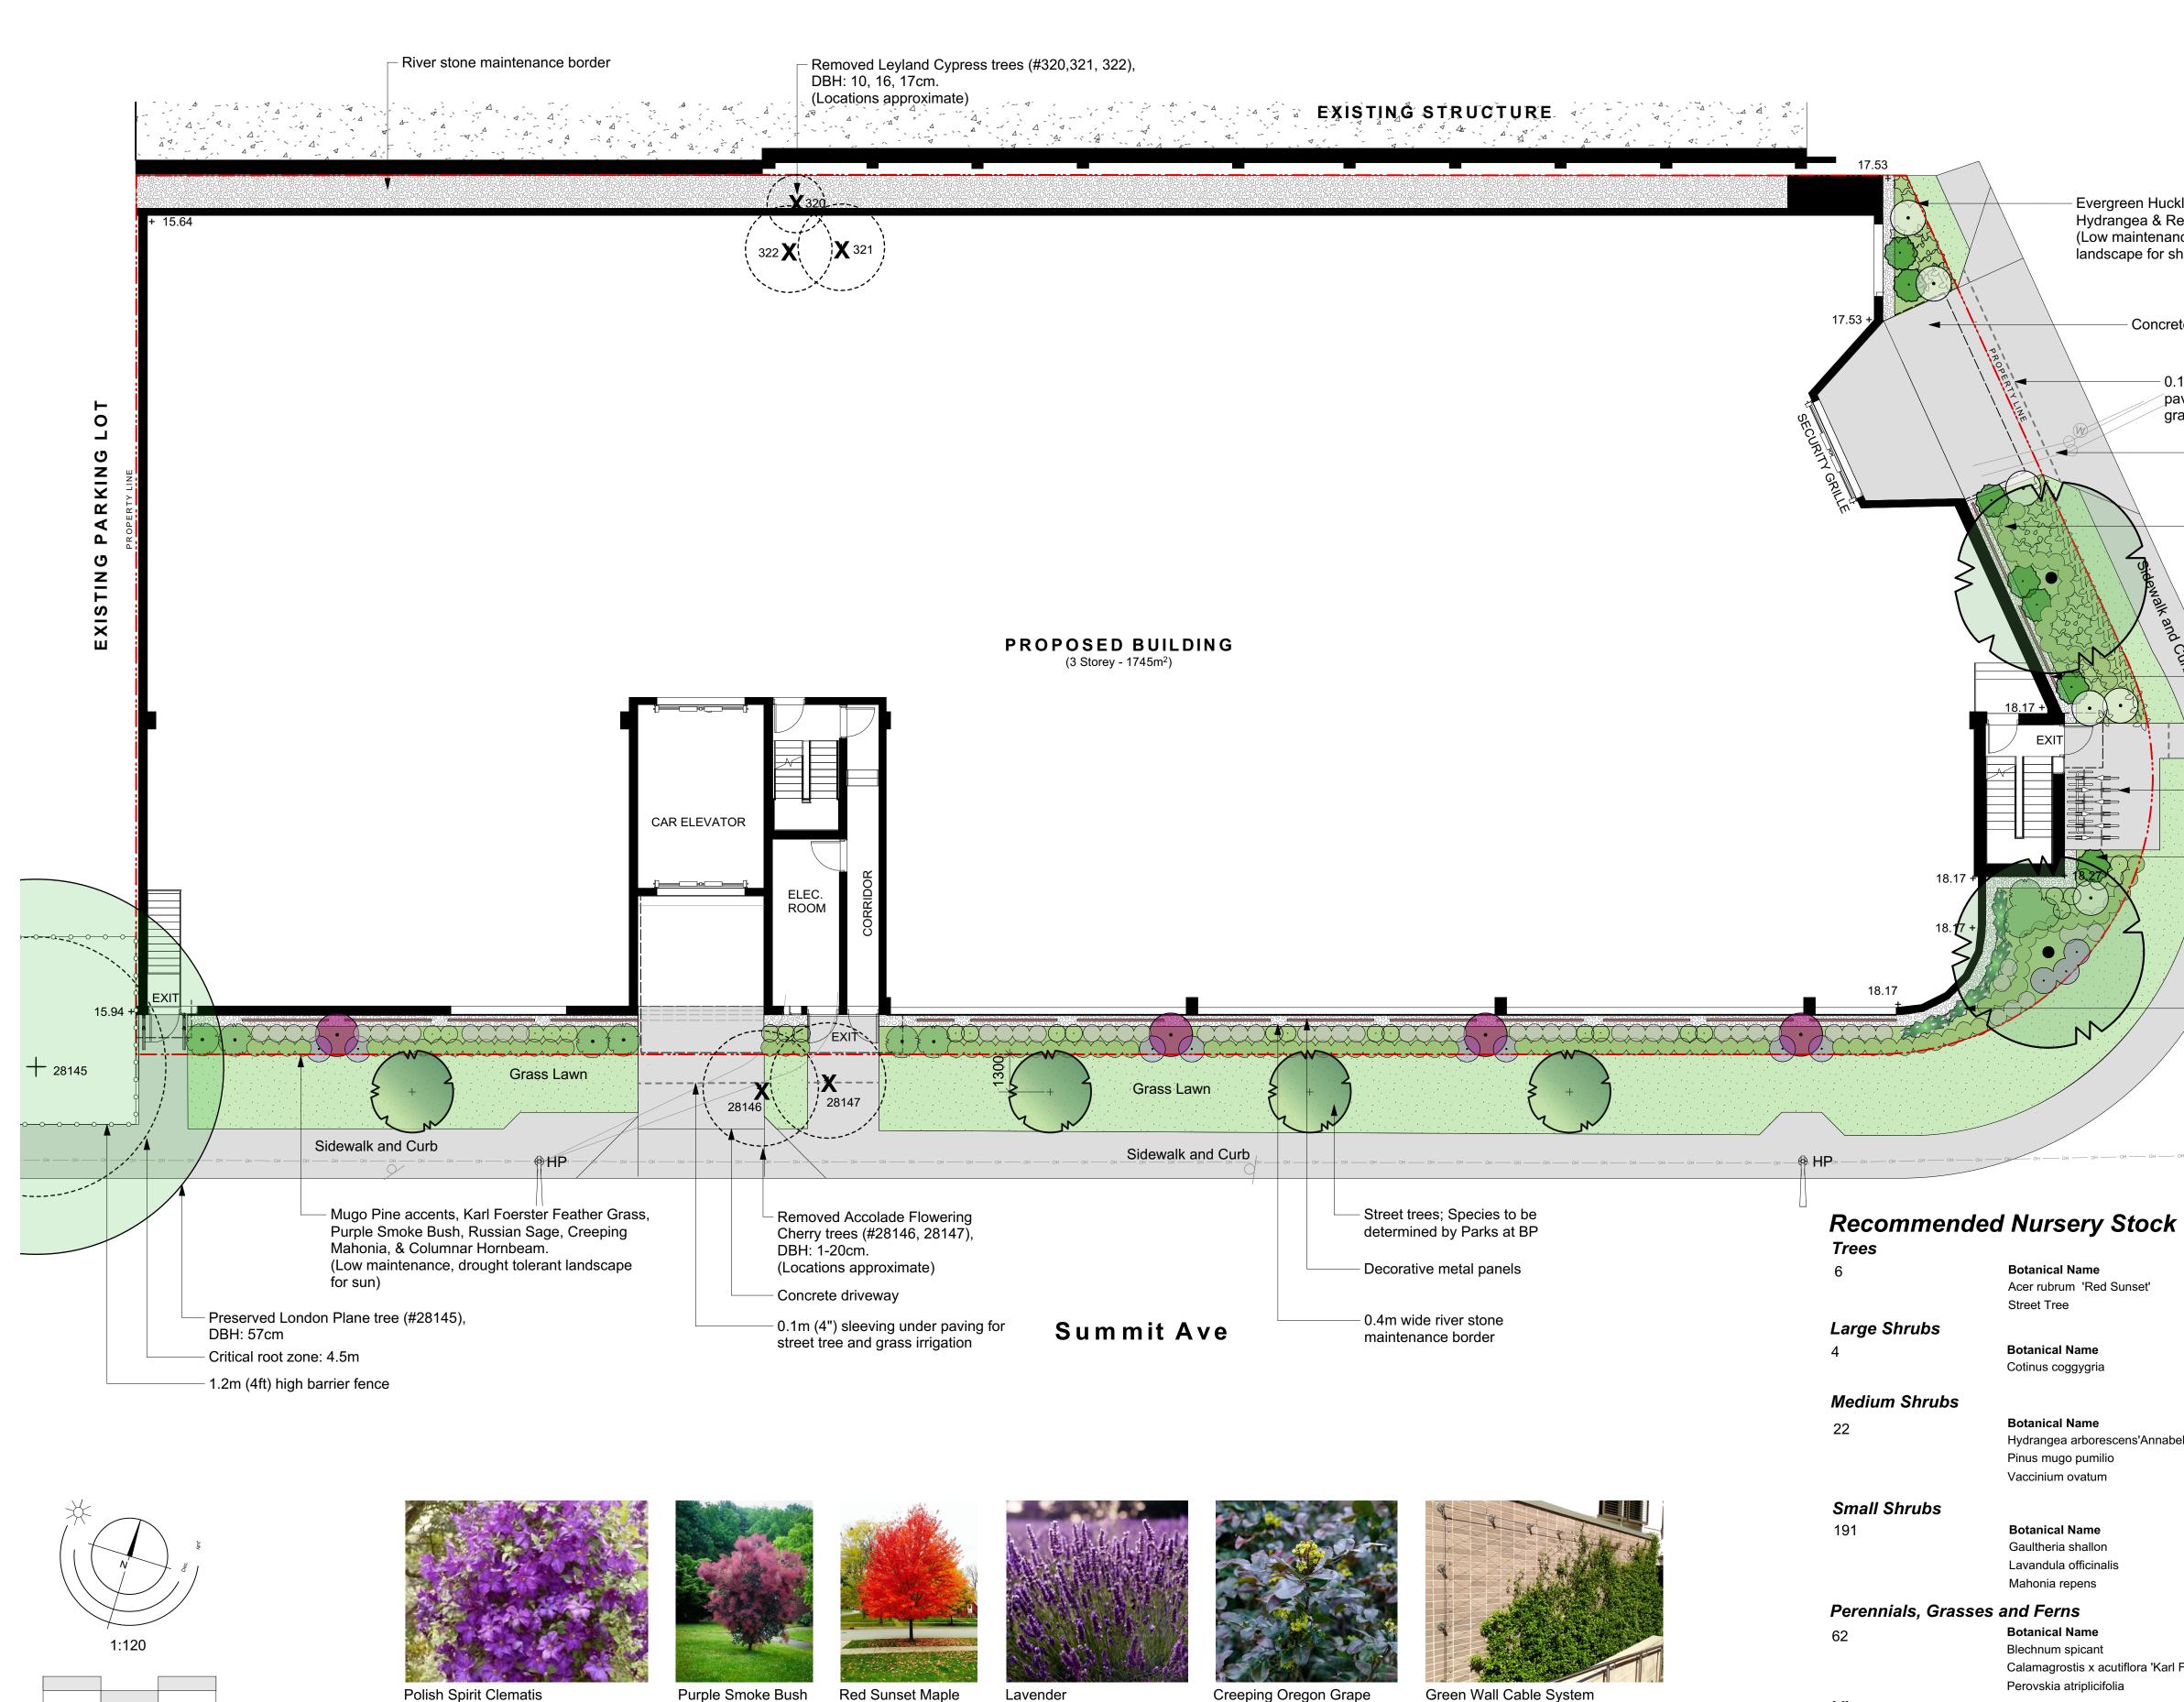

CHARACTER IMAGES

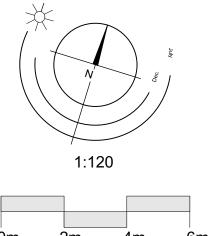



Creeping Oregon Grape

Vines Bota 23 Clem

Notes: 1. All work to be completed to 2. Boulevard soft landscape to

Landscape Concept - Summit Ave. Car Storage Facility

Copyright Reserved. These drawings are at all times the property of the Landscape Architect. Reproduction in whole or in part without written consent of the Landscape Architect is prohibited. Evergreen Huckleberry, Salal, Deer Fern, Hydrangea & Red Sunset Maple. (Low maintenance, drought tolerant landscape for shade). 0 naim - Concrete driveway 0 - 0.1m (4") sleeving under paving for street tree and ~ grass irrigation 0 R Underground utilities Evergreen Huckleberry, Salal, Deer Fern, Hydrangea & Red Sunset Maple. (Low maintenance, drought tolerant landscape for shade). - Decorative metal panels FXIT Bicycle parking (6 spaces) Mugo Pine accents, Karl Foerster Feather Grass, Lavender, Russian Sage, Creeping Mahonia, & Red Sunset Maple. (Low maintenance, drought tolerant landscape for sun). - Green wall cable system with Polish Spirit Clematis

anical Name	Common Name	Size
rubrum 'Red Sunset'	Red Sunset Red Maple	6cm cal
et Tree	TBD	6cm cal.
inical Name	Common Name	Size
nus coggygria	Purple Smoke Bush	#5 pot
inical Name	Common Name	Size
angea arborescens'Annabelle'	Annabelle Hydrangea	#5 pot
s mugo pumilio	Dwarf Mugo Pine	#5 pot
cinium ovatum	Evergreen Huckleberry	#5 pot
anical Name	Common Name	Size
Itheria shallon	Salal	#1 pot
andula officinalis	English Lavender	#1 pot
onia repens	Creeping Oregon Grape	#1 pot
Ferns		
inical Name	Common Name	Size
hnum spicant	Deer Fern	#1 pot
magrostis x acutiflora 'Karl Foerster'	Karl Foerster Feather Reed Grass	#1 pot
vskia atriplicifolia	Russian Sage	#1 pot
anical Name	Common Name	Size
natis viticella 'Polish Spirit'	Polish Spirit Clematis	#5 pot
current BCSLA Landscape St be irrigated with an automati		
5	C J	



Е	Apr 8-20	DP Re-submission
D	Feb 11-20	DP Re-submission
С	Nov 8-19	DP Re-submission
В	Oct 23-19	Minor Plant Rev due to drafting error
А	Sept 9-19	DP Re-submission
REVISIONS		



LADR LANDSCAPE ARCHITECTS

#3-864 Queens Ave. Victoria B.C. V8T 1M5 Phone: (250) 598-0105

PROJECT

750-780 Summit Avenue Car Storage Facility Victoria, BC

TITLE Landscape Concept Plan DRAWN S.L SCALE 1:120 CHECKED B.W. PROJECT No. 1916 DATE of 1 April. 18,2019 SHEET