


1702 QUADRA STREET + 862 FISGARD STREET

VICTORIA, BC

18.07.2025 ISSUED FOR DDP





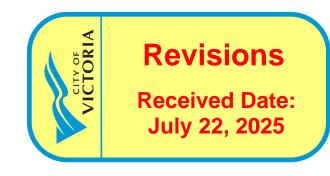

ARCHITECTURAL:

ARCHITECTURE INC

5468796 ARCHITECTURE INC. 266 McDermot Ave Winnipeg, MB. R3B 0S8

P: 204.480.8421 F: 204.480.8876

AG.9

Sasa Radulovic | Principal Architect E: sasa@5468796.ca

Pablo Batista | Architect E: pablo@5468796.ca

COVER **GENERAL NOTES** RENDERINGS AG.2 AG.3 RENDERINGS AG.4 MATERIAL BOARD AG.5 SHADOW STUDIES AG.6 SITE CONTEXT ELEVATIONS AG.7 WINDOW + DOOR SCHEDULE AG.8 ZONING CALCULATIONS

SITE SURVEY

CONTEXT SITE PLAN EXISTING SITE PLAN + DEMOLITION PROPOSED SITE PLAN LEVEL 00 PLAN

LEVEL 01 PLAN LEVEL 02 PLAN LEVEL 03 PLAN LEVEL 04/06/08/10/12 PLAN LEVEL 05/07/09/11 PLAN LEVEL 13 **ROOF PLAN** A1.8

BUILDING ELEVATION BUILDING ELEVATION A2.3 BUILDING ELEVATION BUILDING ELEVATION BUILDING SECTION A3.2 **BUILDING SECTION** A3.3 **BUILDING SECTION BUILDING SECTION**

BUILDING SECTION ENLARGED PLAN - BIKE ROOM

BUILDING SECTION

DEVELOPER:



1839 Fairfield Road Victoria, BC, V8S 1G9 P.250.940.3568 Vinit Jain E: vinit@aryze.ca

ARYZE DEVELOPMENTS INC.

CIVIL:



MCELHANNEY Suite 500 - 3960 Quadra Street Victoria, BC, V8X 4A3 P.778.746.7417

Nathan Dunlop E: ndunlop@mcelhanney.com

CONCEPTUAL SERVICING

ELECTRICAL:



e2 ENGINEERING 549 Herald Street Victoria, BC, V8W 1S5

E: peter.xu@e3eng.ca

MECHANICAL:

Kevin Jackson E: kjackson@avalonmechanical.com

ENVELOPE:



RDH BUILDING SCIENCE 602-740 Hillside Avenue Victoria, BC, V8T 1Z4 P.250.479.1110.

Byron Searle E: bsearle@rdh.com

LANDSCAPE:



BIOPHILIA Victoria, BC, V8T 3E6

P.250.590.1156 Bianca Bodley

Elizabeth Balderson E: elizabeth@biophiliacollective.ca

E: bianca@biophiliacollective.ca

TREE REMOVAL AND PROTECTION PLAN LANDSCAPE SITE PLAN OFF-SITE PLANTING PLAN PRODUCTS AND SITE FURNITURE

ROOFTOP AMENITY AREA

SYMBOL LEGEND:



P.778.433.9391 Peter Xu



AVALON MECHANICAL 300-1245 Esquimalt Road Victoria, BC, V9A 3P2 P.250.940.2976.

BUILDING SECTIONS:

GRIDLINE MARKER

WINDOW TYPE

DOOR NUMBERS

EXISTING DOOR


NEW DOOR

FINIISH TYPE

FLOOR TYPE

ROOF TYPE

NOTES

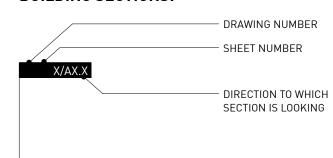


F-1

LABEL


LABEL

SECTIONS: - DRAWING NUMBER - SHEET NUMBER 1/A1.**4** - DIRECTION TO WHICH SECTION IS LOOKING


DETAILS:

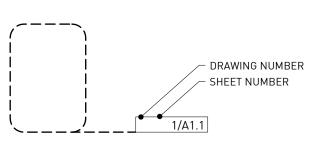


ROOM LABELS:

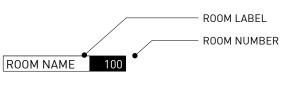



INTERIOR ELEVATIONS:

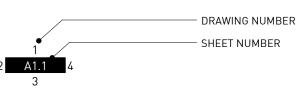

FLOOR CONSTRUCTION ELEVATIONS:

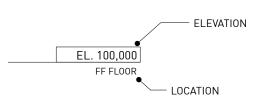

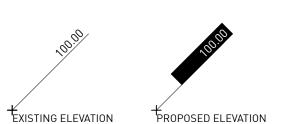

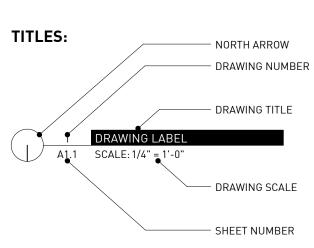

| ABBREVIATIONS: | |
|--|---|
| & ABV AFF ALUM ANOD @ ARCH AT AVB | AND ABOVE ABOVE FINISHED FLOOR ALUMINUM ANODIZED AT ARCHITECTURAL ACOUSTIC TILE AIR/VAPOUR BARRIER |
| BLDG BLKG BRG BS B TO B | BUILDING BLOCKING BEARING BOTH SIDES BACK TO BACK |
| CB CF CG CJ CL CLG CLR COL CONC CONC CONN CONT CORR CT C/W | CATCH BASIN CLEAR FINISH CORNER GUARD CONTROL JOINT CENTRE LINE CEILING CLEAR COLUMN CONCRETE CONNECTION CONTINUOUS CORRIDOR CERAMIC TILE COMPLETE WITH |
| Ø DIM DN DRWG DTL | DIAMETER DIMENSION DOWN DRAWING DETAIL |
| EL EW EA ELEC EQ EXIST EJ EXT | ELEVATION EACH WAY EACH ELECTRICAL EQUAL EXISTING EXPANSION JOINT EXTERIOR |
| FDN FE FEJ FIN FD FFD FF FLEX FO FR FRR | FOUNDATION FIRE EXTINGUISHER FLOOR EXPANSION JOINT FINISHED FLOOR DRAIN FUNNEL DRAIN FINISHED FACE FLEXIBLE FACE OF FRIDGE FIRE RESISTANCE RATING |
| G GA GWB GCB GC | GRILL GAUGE GYPSUM WALL BOARD GYPSUM CEILING BOARD GENERAL CONTRACTOR GLASS |
| HM HMI HORIZ HR HSDG HSS HSTG | HOLLOW METAL HOLLOW METAL INSULATED HORIZONTAL HOUR HERMETICALLY SEALED DOUBLI HOLLOW STEEL SECTION HERMETICALLY SEALED TRIPLE HEIGHT |

BLE GLAZING LE GLAZING HEATING, VENTILATING, AIR CONDITIONING INSIDE DIAMETER INSIDE FACE

INSULATION INTERIOR LENGTH METRE MILLIMETRE MOUNT MATERIAL MAX MAXIMUM MDF MEDIUM DENSITY FIBREBOARD MECH MECHANICAL MINIMUM MISCELLANEOUS MASONRY OPENING NOT IN CONTRACT NUMBER NOM NOMINAL NTS NOT TO SCALE

ON CENTRE

OUTSIDE DIAMETER

OVERHEAD 0PP OPPOSITE OPEN TO ABOVE OTB OPEN TO BELOW OVEN PLAM PLASTIC LAMINATE PLBG PLUMBING PAIR PREFINISHED PRESSED STEEL PRESSURE TREATED PAINTED FINISH PROPERTY LINE RADIUS **ROOF DRAIN** REINF REINFORCED

REQ'D REQUIRED REV REVISION, REVISED, REVERSED ROUGH OPENING SHEET FLOORING SIMILAR SPC'D SPECIFIED SQUARE STEEL STD STANDARD STAIN FINISH STRUCT STRUCTURAL SUSP SUSPENDED TEMP TEMPERED TEMPERED GLASS

TOP OF TYPICAL U/N UNLESS OTHERWISE NOTED UNDERSIDE VARNISHED FINISH VERTICAL

WIDE, WIDTH WASHER/DRYER WHC WOOD HOLLOW CORE WOOD SOLID CORE

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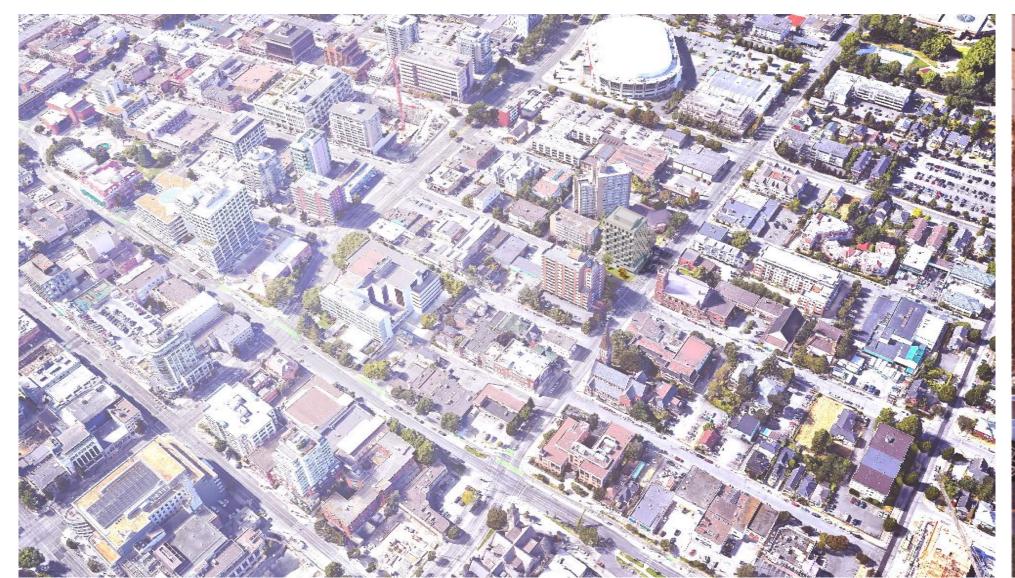
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GENERAL NOTES

0650 Sheet


AG.1






RENDER 5: AERIAL VIEW OF BUILDING

RENDER 3: STREETVIEW EXPERIENCE ALONG QUADRA

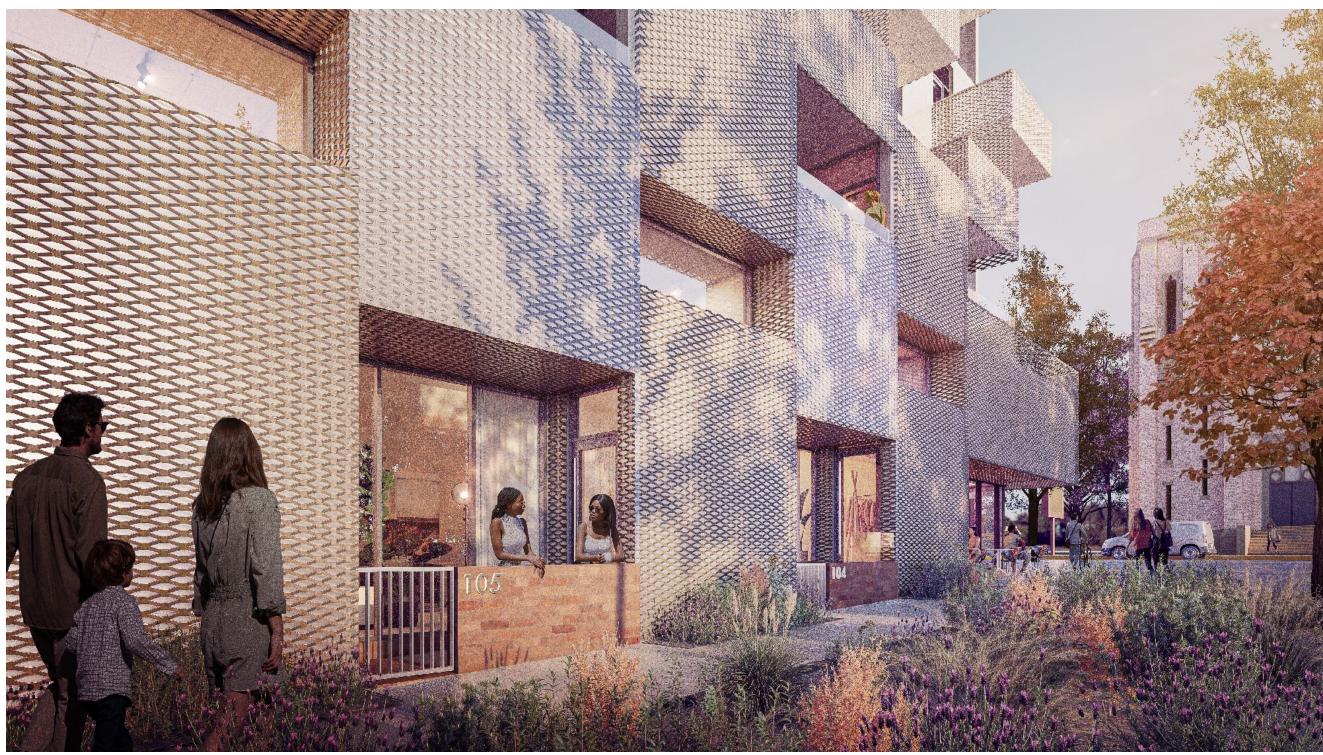

RENDER 4: STREET LEVEL VIEW OF THE BUILDING FROM FISGARD SIDEWALK

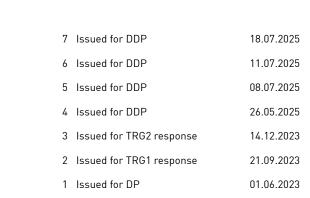

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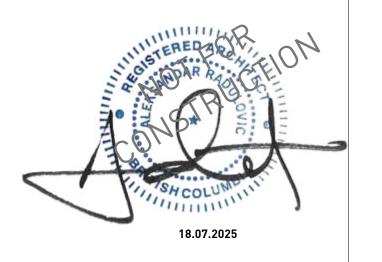
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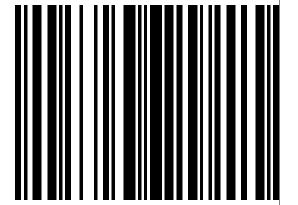
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RENDERINGS

0650 Sheet AG.2

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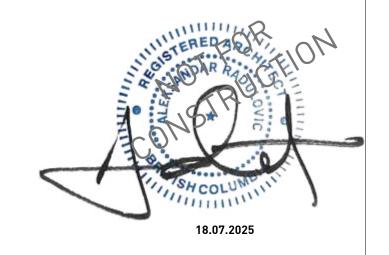
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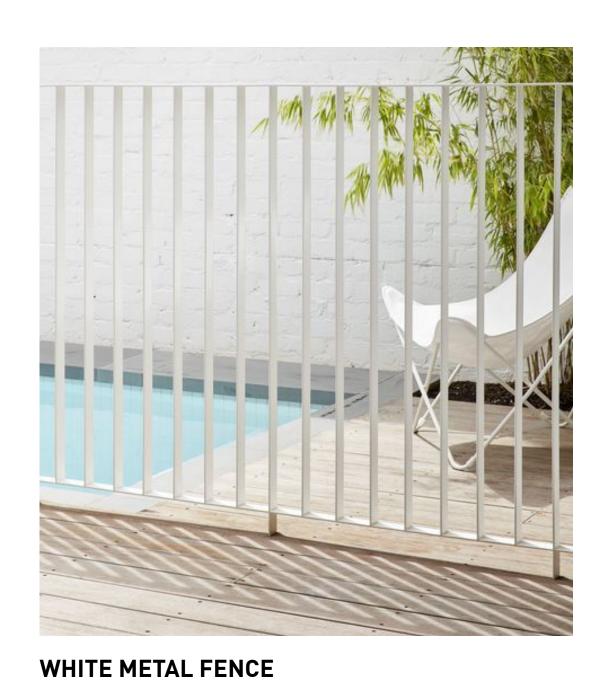
1702 QUADRA STREET + 862 FISGARD STREET

RENDERINGS


Project 0650 Sheet AG.3









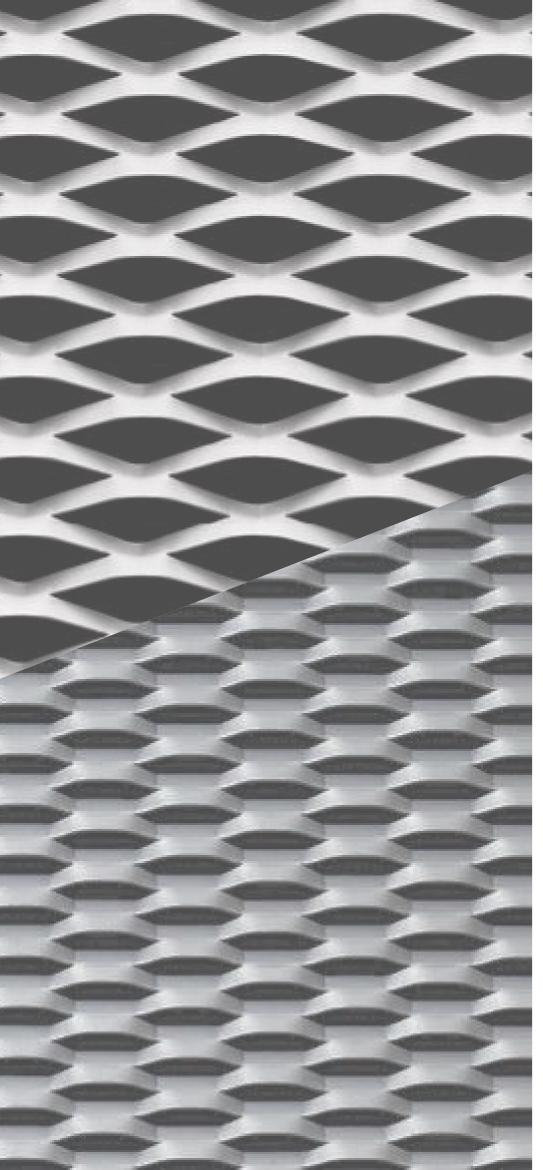







BRICK





EXPANDED METAL [ALUMINUM FINISH]



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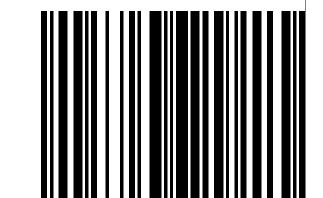
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MATERIALS

Project 0650 Sheet AG.4



MARCH 20 9:00 AM



MARCH 20 12:00 PM



MARCH 20 4:00 PM





JUNE 21 9:00 AM



JUNE 21 12:00 PM



JUNE 21 4:00 PM



SEPTEMBER 22 9:00 AM



SEPTEMBER 22 12:00 PM



SEPTEMBER 22 4:00 PM



DECEMBER 21 9:00 AM




DECEMBER 21 12:00 PM



DECEMBER 21 4:00 PM



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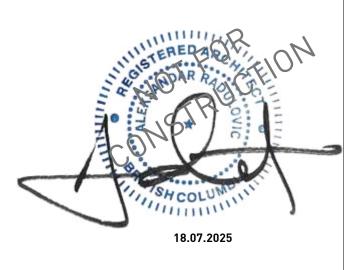
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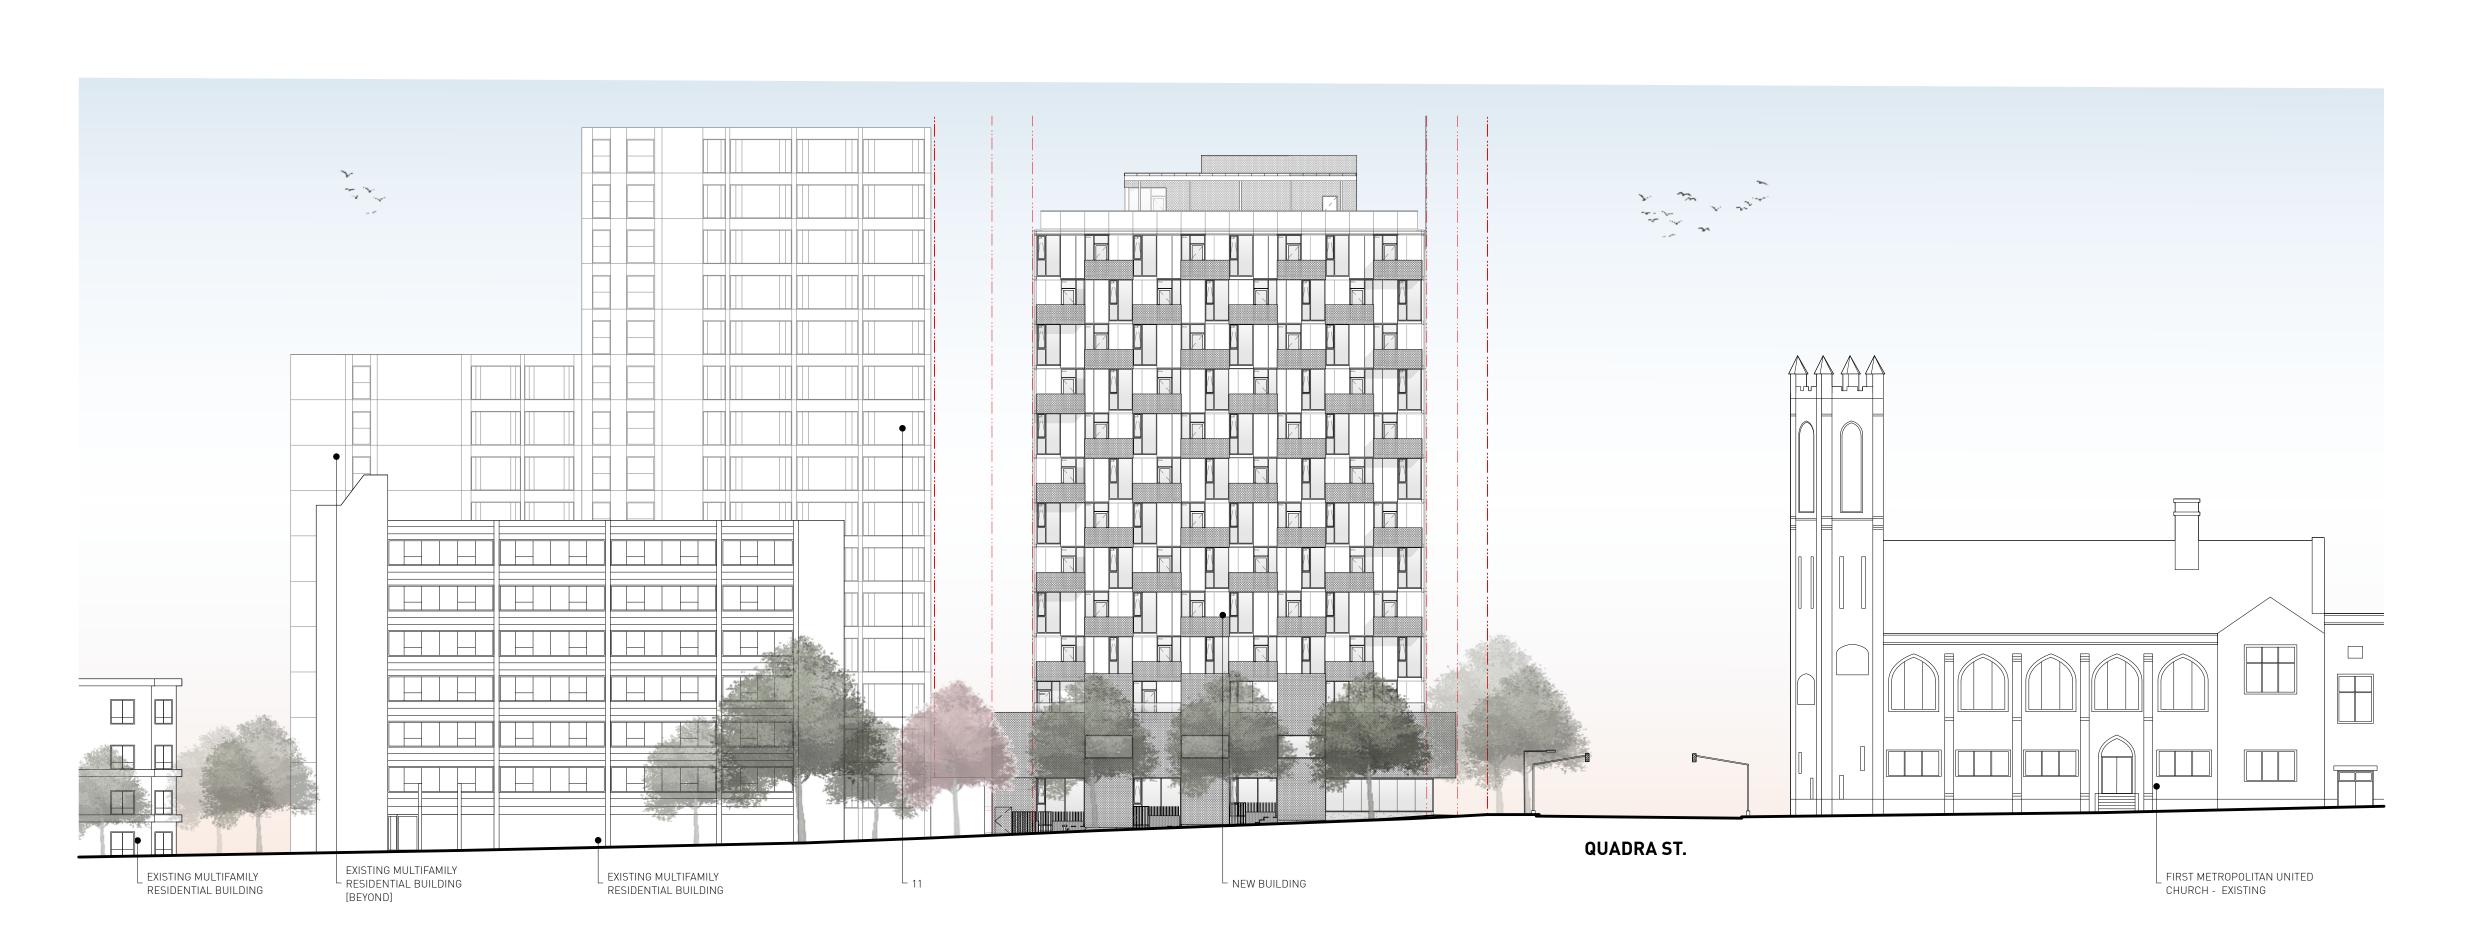
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SHADOW STUDIES

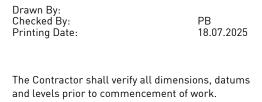Project 0650 Sheet

AG.5





FISGARD ST ELEVATION [SOUTH FACADE]

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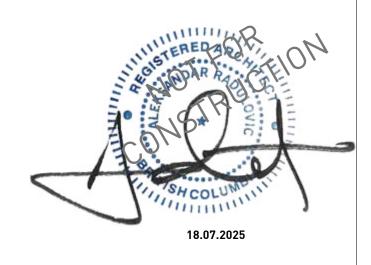
Architect before proceeding.


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CONTEXT ELEVATIONS

Sheet AG.6

RESIDENTIAL WINDOW SCHEDULE

• ALL GLAZING TO BE HSTG, LOW E ON SURFACE 2, ARGON-FILLED W/ SUPERSPACERS, LOW REFLECTIVITY COATING TO REDUCE INTERNAL GLARE

ALUMINUM WINDOW WALL SYSTEM

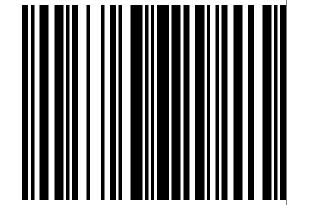• REFER TO WINDOW SUPPLIER CUT SHEETS FOR TEMPERING REQUIREMENTS

PROVIDE PRE-FINISHED ALUMINUM FLASHING AT HEADS AND SILLS, COLOUR TO BE SELECTED BY ARCHITECT
 GLASS TO BE 3mm CLEAR [UNLESS OTHERWISE NOTED OR REQUIRED BY MANUFACTURING ENGINEER]

• ALL INTERIOR CASINGS TO BE GYPSUM BOARD RETURN

ALL WINDOWS TO MEET NAFS-17 & CANADIAN TEST STANDARDS. ENVELOPE CONSULTANT TO REVIEW TESTING DATA.
 ALL WINDOW SPECIFICATIONS MUST COMPLY OR SURPASS ENERGY CODE CONSULTANT'S ENERGY MODEL ASSUMPTIONS

• REFER TO ENVELOPE CONSULTANT WINDOW INSTALLATION GUIDELINES FOR SILL AND THREE SIDES MEMBRANE DETAILING FOR ALL RESIDENTIAL WINDOWS

ENVELOPE CONSULTANT TO REVIEW ALL RESIDENTIAL AND COMMERCIAL GLAZING SHOP DRAWINGS

• ALUMICOR THERMALLY BROKEN STOREFRONT OR APPROVED EQUAL, SSG, ANTI-ROTATION BLOCKS TO BE ALUMINUM OR PVC

• ALL GLAZING TO BE HSTG, LOW E ON SURFACE 2, ARGON-FILLED W/ SUPERSPACERS, LOW REFLECTIVITY COATING TO REDUCE INTERNAL GLARE

ALL EXTERIOR CURTAINWALL TO BE TEMPERED, BLACK FRAME
GLASS TO BE 6mm CLEAR & TEMPERED


COMMERCIAL WINDOW SCHEDULE

ALL WINDOW SPECIFICATIONS MUST COMPLY OR SURPASS ENERGY CODE CONSULTANT'S ENERGY MODEL ASSUMPTIONS


• SUPPLY SPANDREL PANEL AS REQUIRED FOR MECHANICAL GRILLE PENETRATIONS OF CURTAIN WALL.


ENVELOPE CONSULTANT TO REVIEW ALL RESIDENTIAL AND COMMERCIAL GLAZING SHOP DRAWINGS


RESIDENTIAL WINDOW WALL

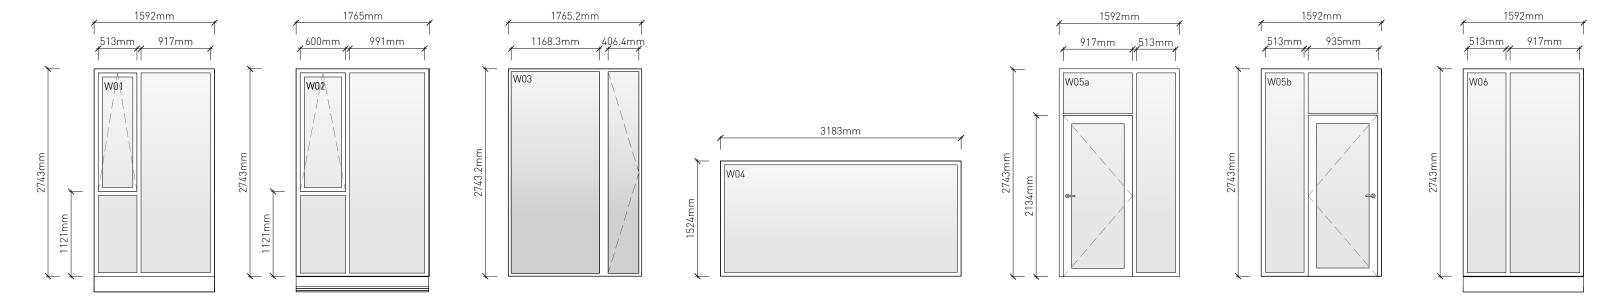


COMMERCIAL STOREFRONT

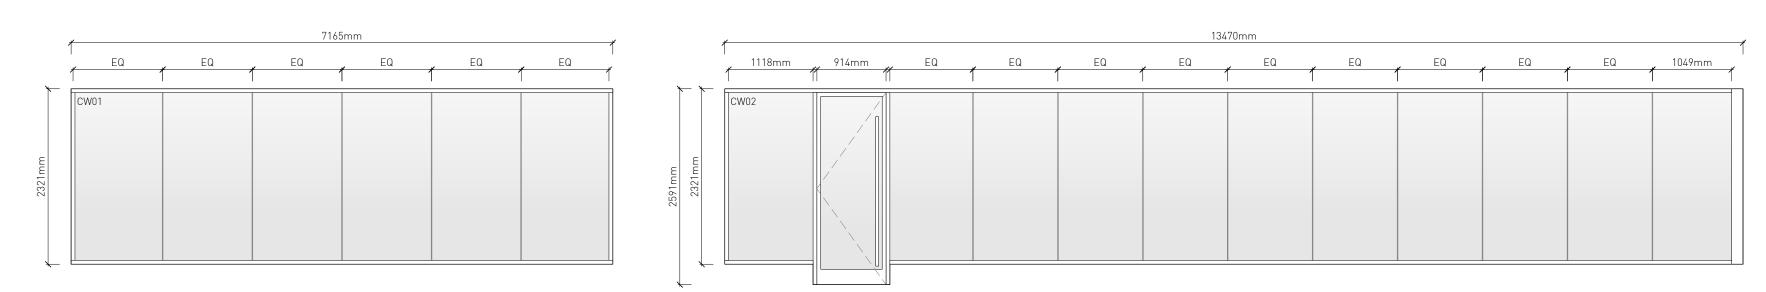

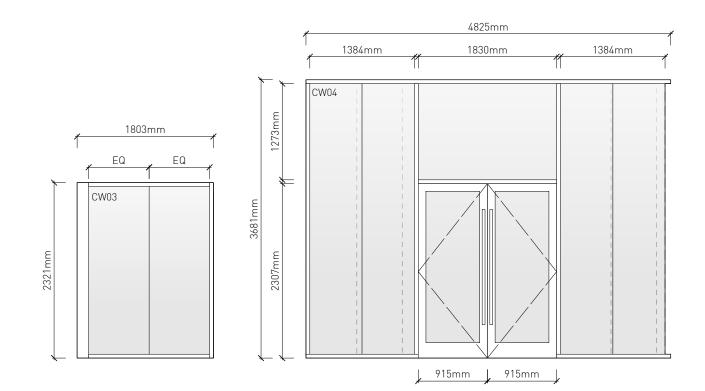


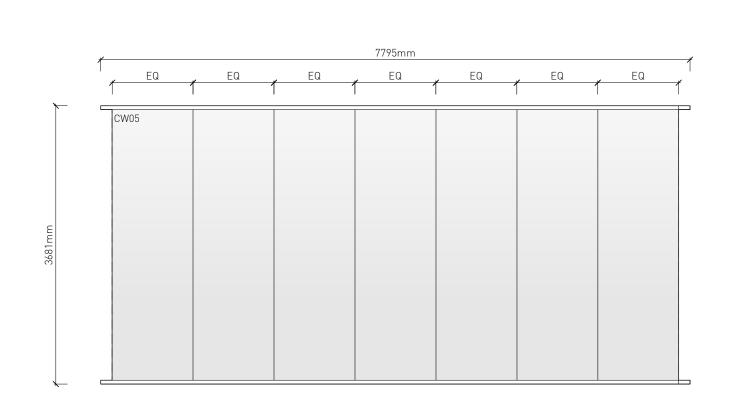



LIVE WORK STOREFRONT

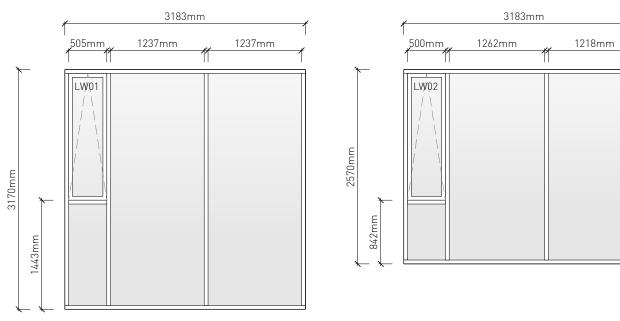

PENTHOUSE STOREFRONT

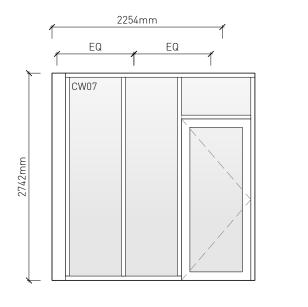

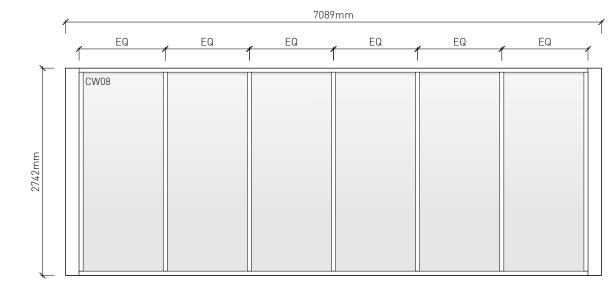

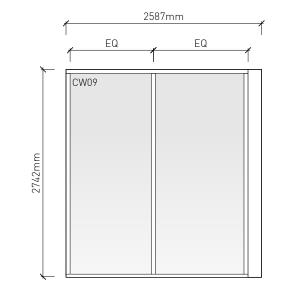



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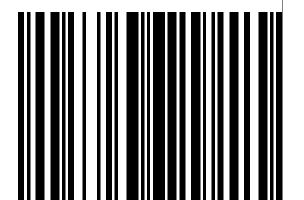
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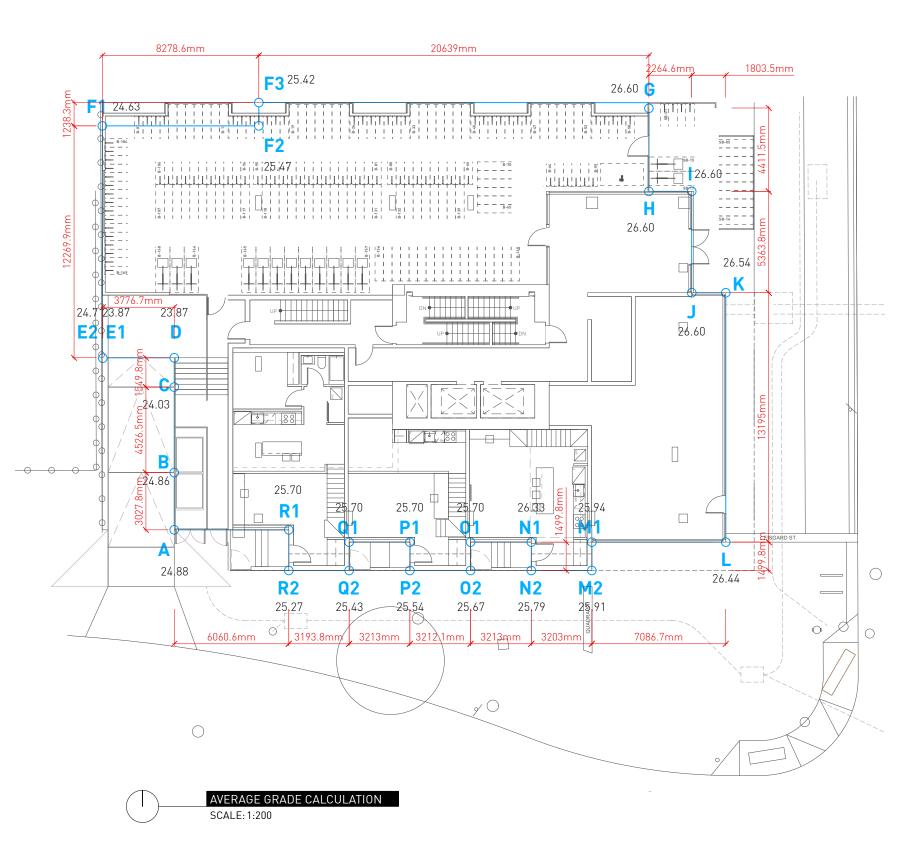



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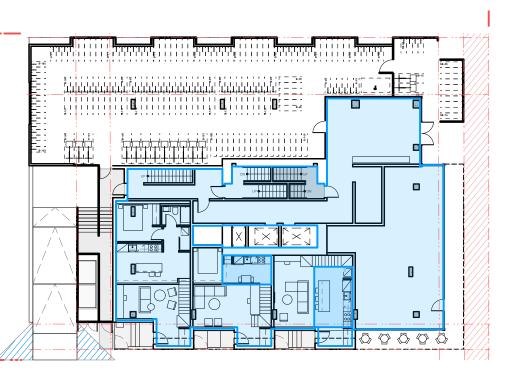
WINDOW & DOOR SCHEDULE

Sheet AG.7






M2 & N2

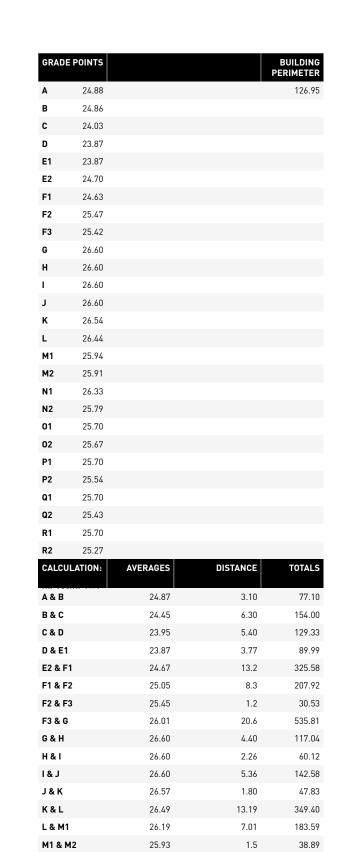


384.00 m²



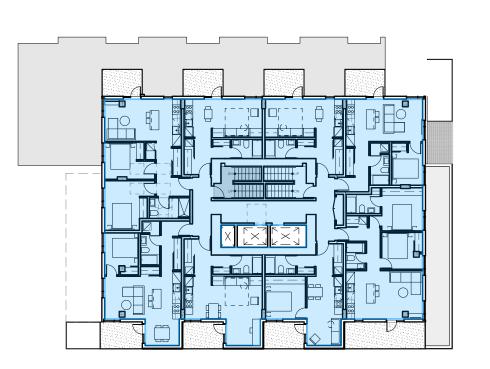


445.46 m²



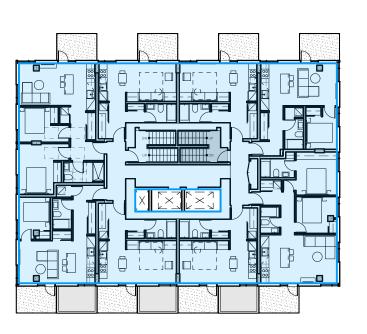

428.50 m²



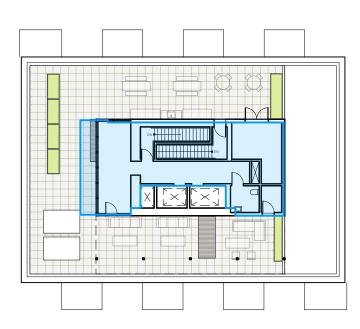

102.5 m²



PROJECT STATS:

| LEGAL DESCRIPTION | ZONING: R3-C | LOTS: A, 1, 2 | SUBURBAN LOT: 4 | PLAN: CITY 01516011 |
|-----------------------|--------------------------------|-------------------|-----------------|---|
| CIVIC ADDRESS | 1702 QUADRA STR | EET, VICTORIA, BC | | |
| 70,111,0 | oupp. | | | 4500 0114 004 000 1507 07470 |
| ZONING | CURR [R-3C, RESIDEN FAMI | NTIAL MULTI- | | 1702 QUADRA PROJECT STATS |
| SITE AREA [m²] | | | | 947.78 |
| GROSS FLOOR AREA [m²] | | | | 5217.01 |
| FLOOR SPACE RATIO | 3.0 |) | | 5.50 |
| SITE COVERAGE (%) | | | | 76.5% |
| OPEN SITE SPACE (%) | | | | 23.5% |
| AVERAGE GRADE | | | | 24.59 m |
| BUILDING HEIGHT | NO BUILDING SH METRES IN | | | 13 STOREYS [42.88m] |
| SETBACKS | | | | |
| NORTH [SIDE] | 6.01 | m | | 4.85m [[EXCLUDING BIKE PARKING ENCLOSURE] |
| EAST [FRONT] | 4.51 | m | | 2.0m [BASE] 4.0m [TOWER] |
| SOUTH [FLANKING] | 4.51 | m | | 0.85m [BASE] 2.85m [TOWER] |
| WEST [REAR] | 6.0r | m | | 3.8m [BASE - EXCLUDING BIKE PARKING ENCLOSURE] 6.5m [TOWER] |

| UNIT TYPES | AVERAGE AREA (M²) | UNIT COUNT | TOTAL AREA (M²) |
|---------------------|-------------------|------------|-----------------|
| RESIDENTIAL | | | |
| BACHELOR | 34.72 | 43 | 1,492.85 |
| 1 BEDROOM UNIT | 47.27 | 24 | 1,134.38 |
| 2 BEDROOM UNIT | 65.19 | 21 | 1,368.95 |
| OTHER | | | |
| COMMERCIAL UNIT [S] | 183.40 | 1 | 183.40 |
| WORK / LIVE | 57.85 | 3 | 173.55 |
| | | | |
| TOTAL | | 92 | |
| TOTAL RENTABLE AREA | | | 4,353.13 |

| RESIDENTIAL UNIT MIX | UNIT COUNT | % |
|----------------------|------------|-----|
| BACHELOR | 43 | 47% |
| 1 BEDROOM UNIT | 24 | 26% |
| 2 BEDROOM UNIT | 21 | 23% |

| SITE DATA | |
|-----------------------|------------------------|
| | AREA [m ²] |
| | |
| EVEL 01 | 384.00 |
| EVEL 02 | 445.46 |
| EVEL 03 | 428.50 |
| EVEL 04 | 428.50 |
| EVEL 05 | 428.50 |
| EVEL 06 | 428.50 |
| EVEL 07 | 428.50 |
| EVEL 08 | 428.50 |
| EVEL 09 | 428.50 |
| EVEL 10 | 428.50 |
| EVEL 11 | 428.50 |
| EVEL 12 | 428.50 |
| EVEL 13 | 102.55 |
| | |
| OTAL GROSS FLOOR AREA | 5217.01 |
| UILDING FOOTPRINT | 724.88 |
| | |

TOTAL PROPOSED

| | UNIT COUNT | RATE | REQUIRED STALLS |
|---------------------------|------------|-------------------------------|-----------------|
| RESIDENTIAL | | | |
| UNIT < 45 M ² | 44 | 0.5 STALLS / UNIT | 22 |
| UNIT 45-70 M ² | 47 | 0.6 STALLS / UNIT | 29 |
| UNIT > 70 M ² | 0 | 1.45 STALLS / UNIT | 0 |
| VISITOR | 91 | 0.1 STALLS / UNIT | 9 |
| COMMERCIAL | | | |
| RESTAURANT | 183.40 | 1.0 STALLS / 40m ² | 5 |
| TOTAL REQUIRED | | | 65 |

| | UNIT COUNT | RATE | REQUIRED STALLS |
|---------------------------|------------|--------------------------------|-----------------|
| LONG TERM | | | |
| UNIT < 45 M ² | 44 | 1.0 STALLS / UNIT | 44 |
| UNIT => 45 M ² | 47 | 1.25 STALLS / UNIT | 59 |
| RESTAURANT | 183.40 | 1.0 STALLS / 400m ² | 1 |
| TOTAL REQUIRED | | | 104 |

| | | | · |
|----------------|------------------|--------------------------------|-----|
| SHORT TERM | | | |
| RESIDENT | 91 | 0.1 STALLS / UNIT | 9.1 |
| RESTAURA | NT 183.40 | 1.0 STALLS / 100m ² | 2 |
| TOTAL REQUIRED | | | 12 |
| | | | |
| TOTAL PROPOSED | | | 14 |

18.07.2025 7 Issued for DDP 6 Issued for DDP 11.07.2025 5 Issued for DDP 08.07.2025

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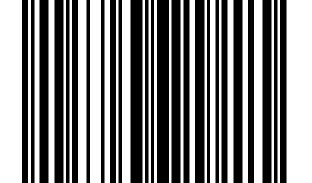
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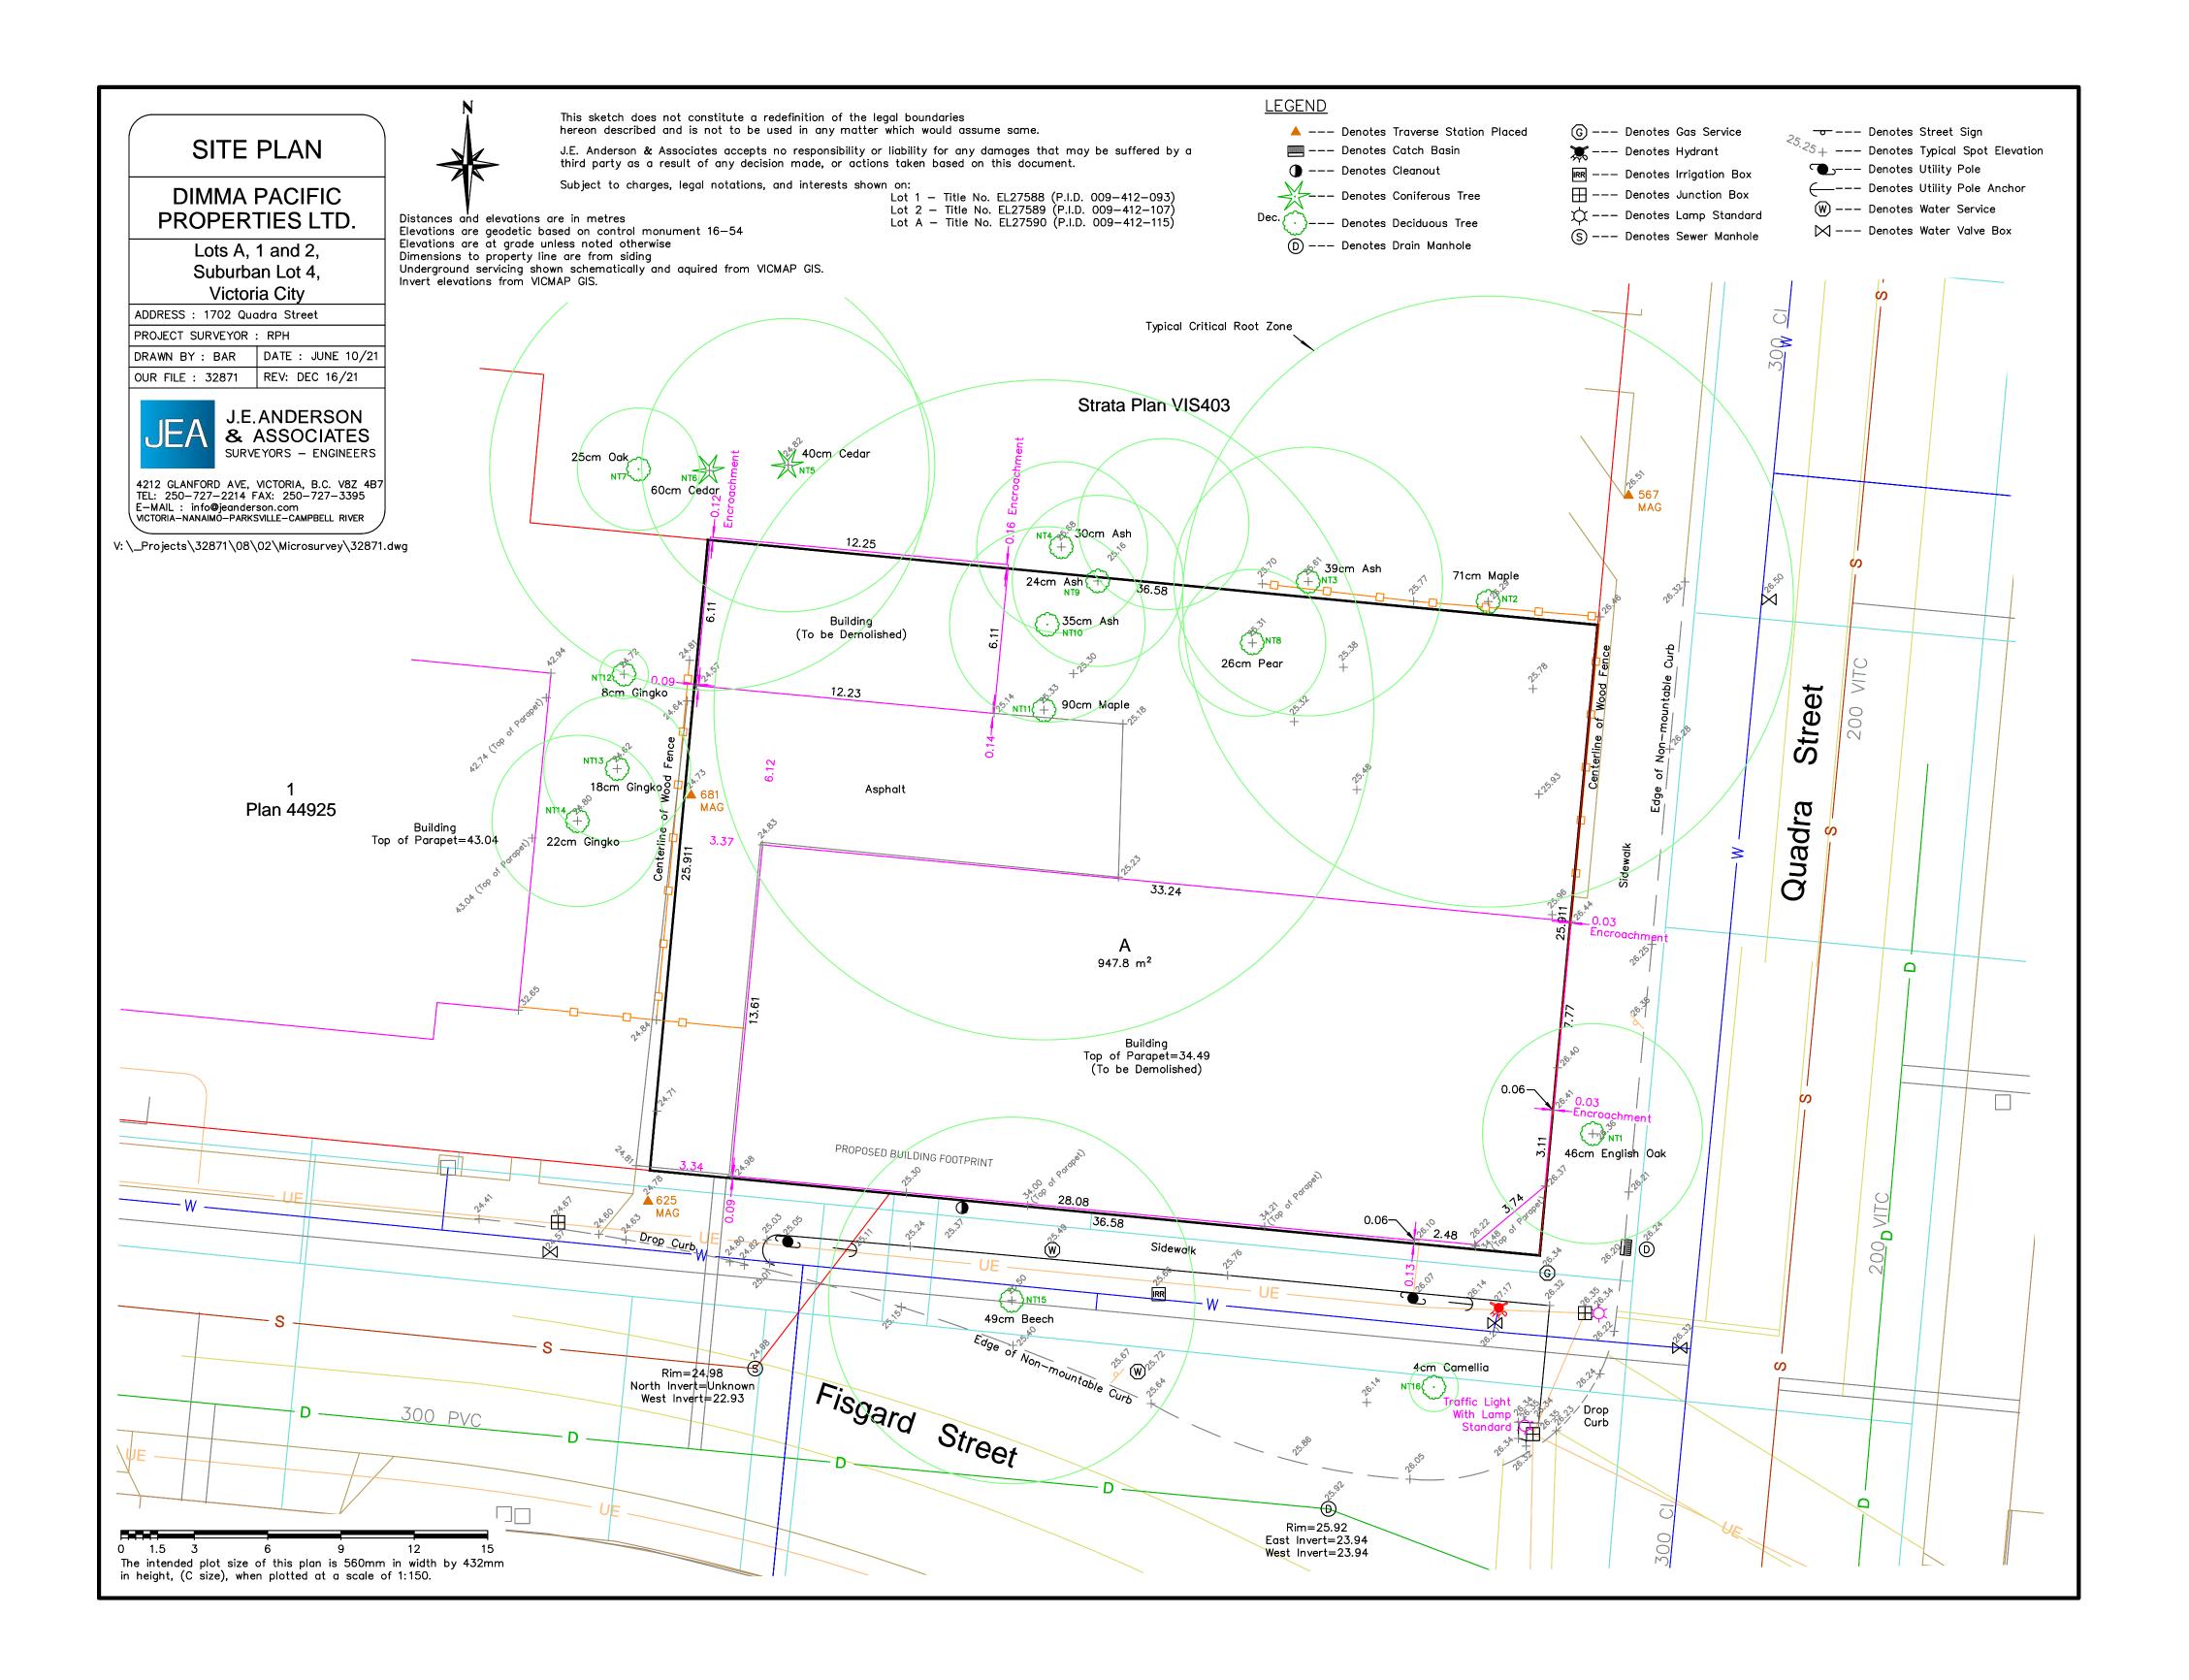


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1702 QUADRA STREET + 862 FISGARD STREET

ZONING CALCULATIONS Project 0650

AG.8



1 SITE SURVEY BY OTHERS
AG.5 SCALE: NTS

7 Issued for DDP 18.07.2025
6 Issued for DDP 11.07.2025
5 Issued for DDP 08.07.2025
4 Issued for DDP 26.05.2025

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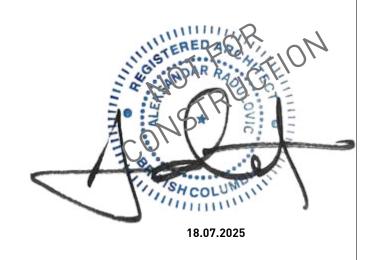
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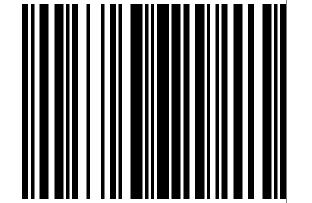
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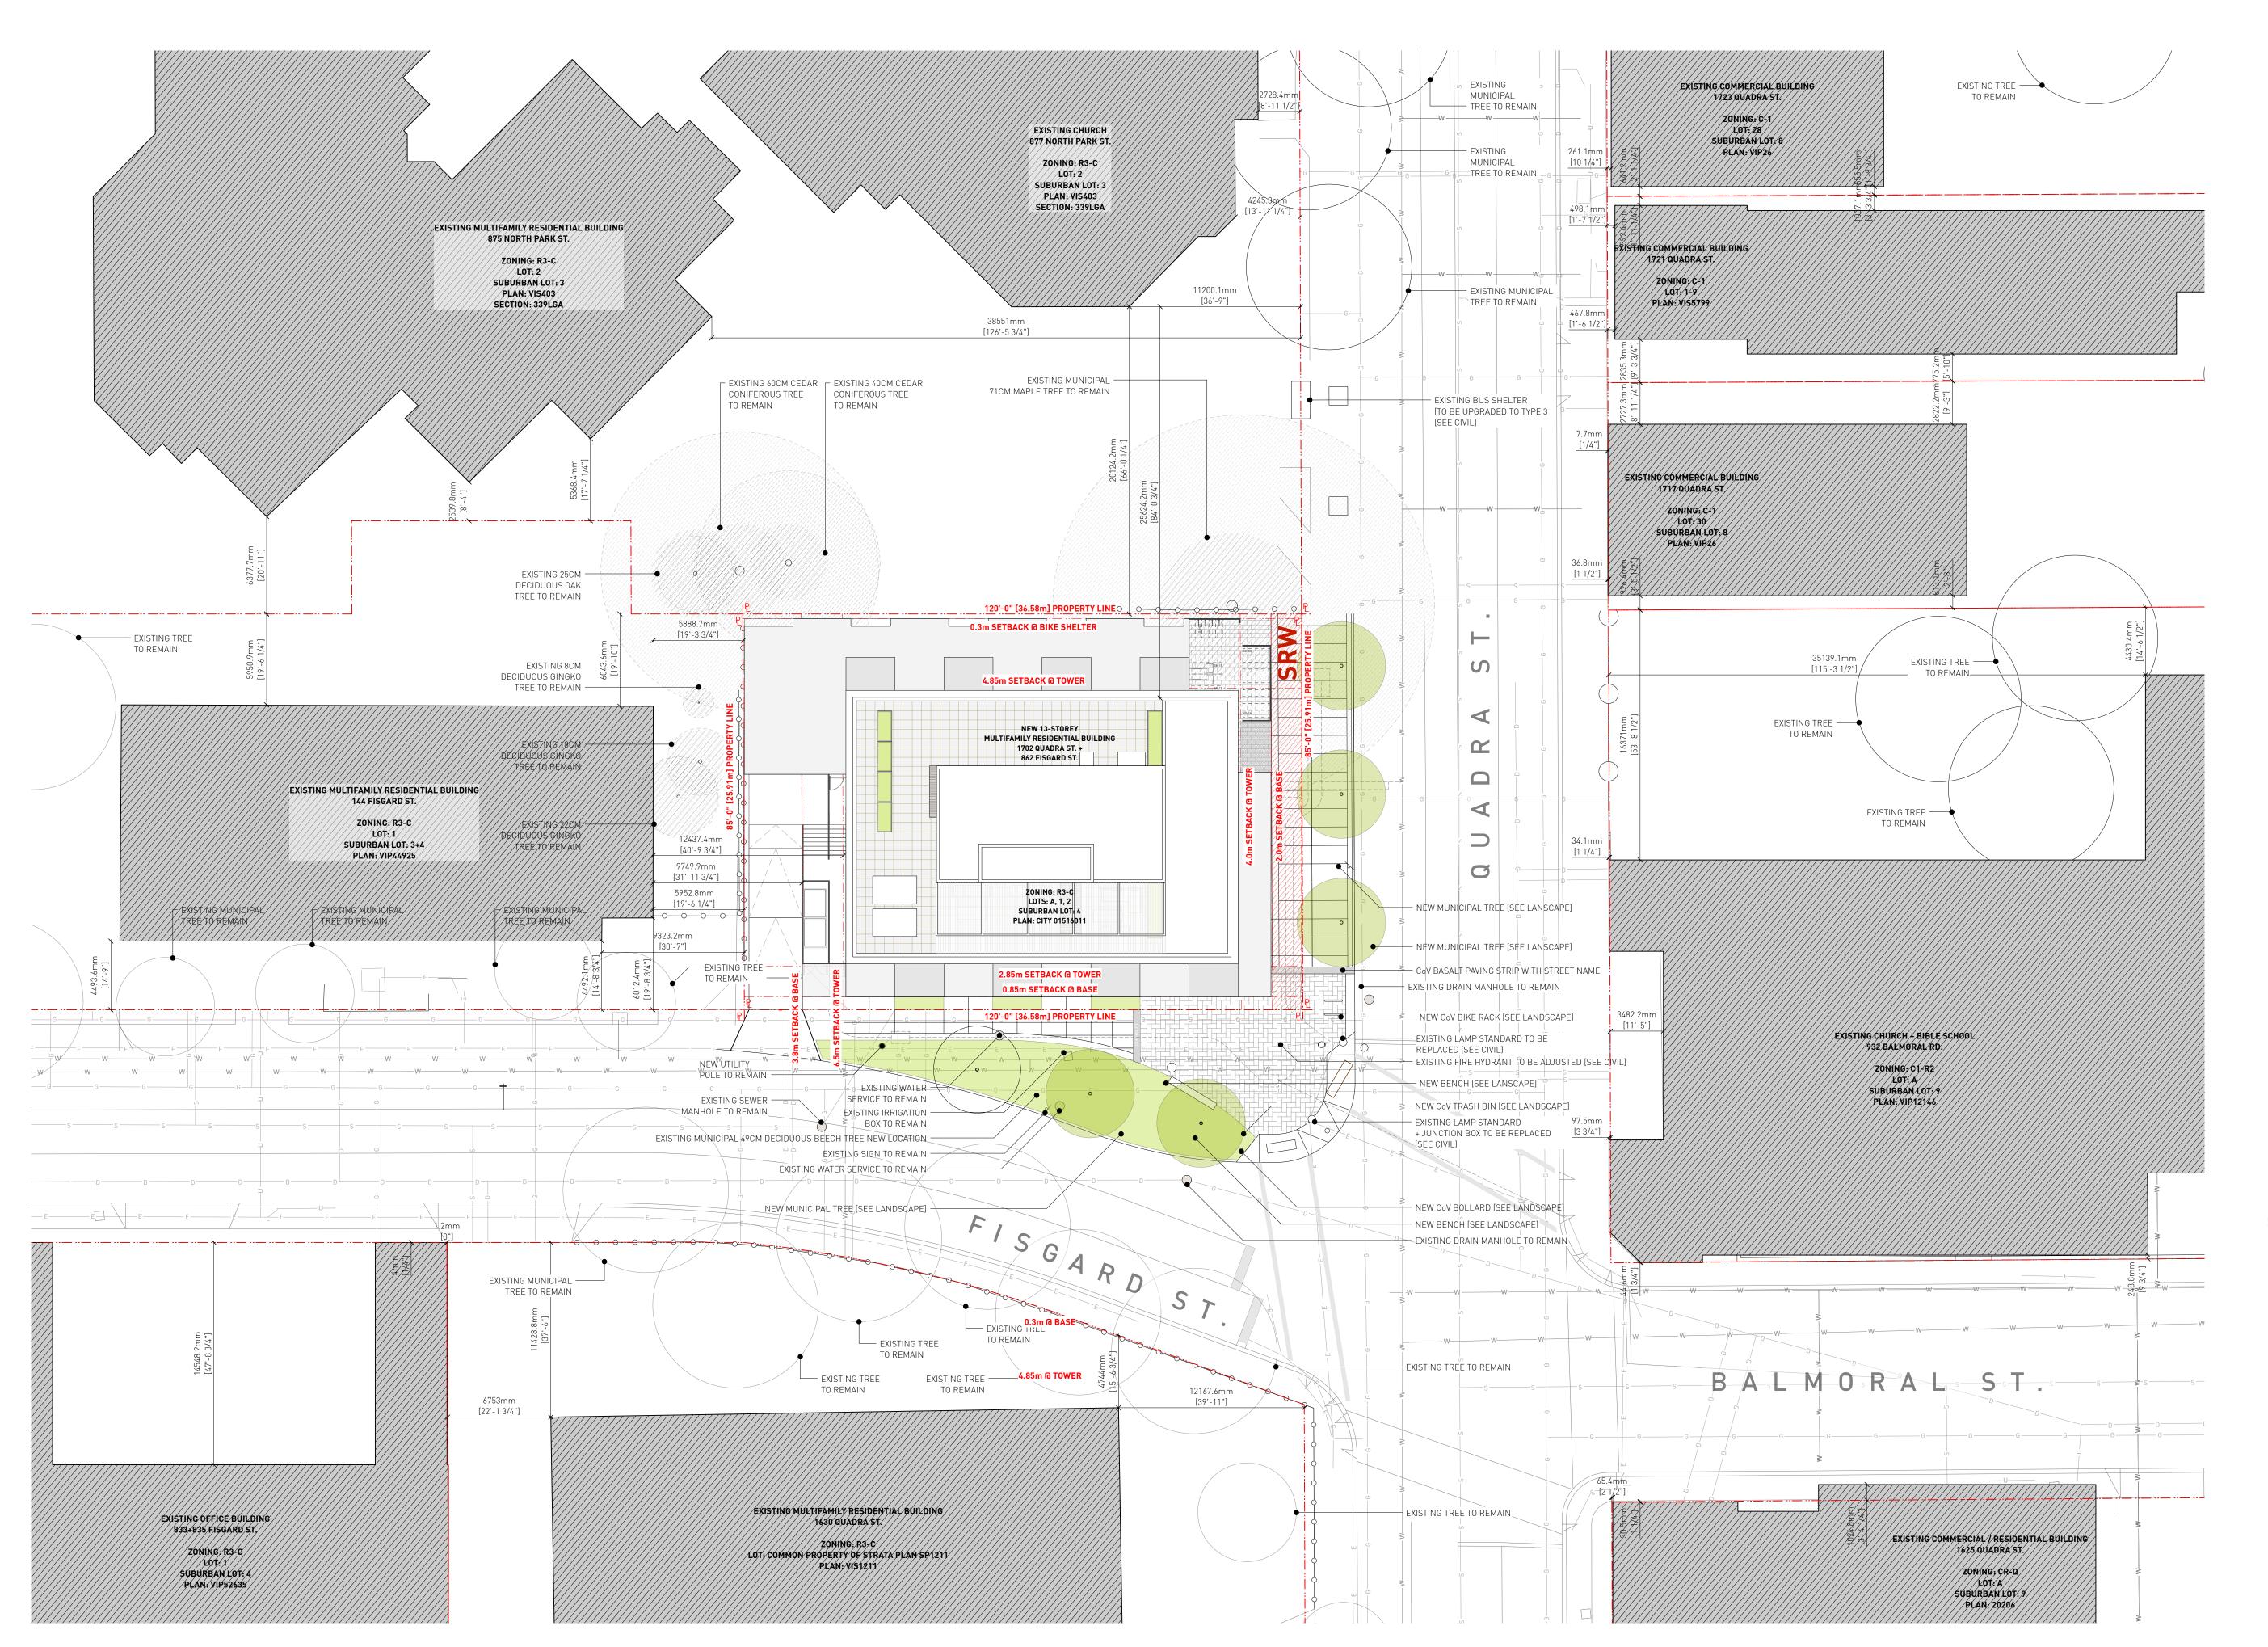


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1702 QUADRA STREET + 862 FISGARD STREET

SITE SURVEY

O650 Sheet



EXISTING BUILDING [TO BE DEMOLISHED]

EXISTING BUILDING

EXISTING GAS LINE

EXISTING DRAIN LINE

EXISTING TREE [TO BE REMOVED]

EXISTING TREE

EXISTING TREE ROOT AREA

EXISTING TREE ROOT AREA [TO BE REMOVED]

EXISTING HYDRO POLE

EXISTING FIRE HYDRANT

5 Issued for DDP

7 Issued for DDP 18.07.2025
6 Issued for DDP 11.07.2025

08.07.2025

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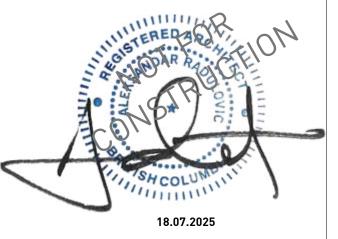
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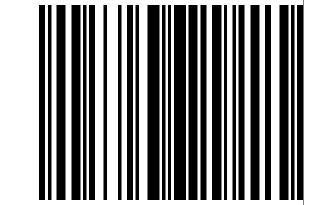
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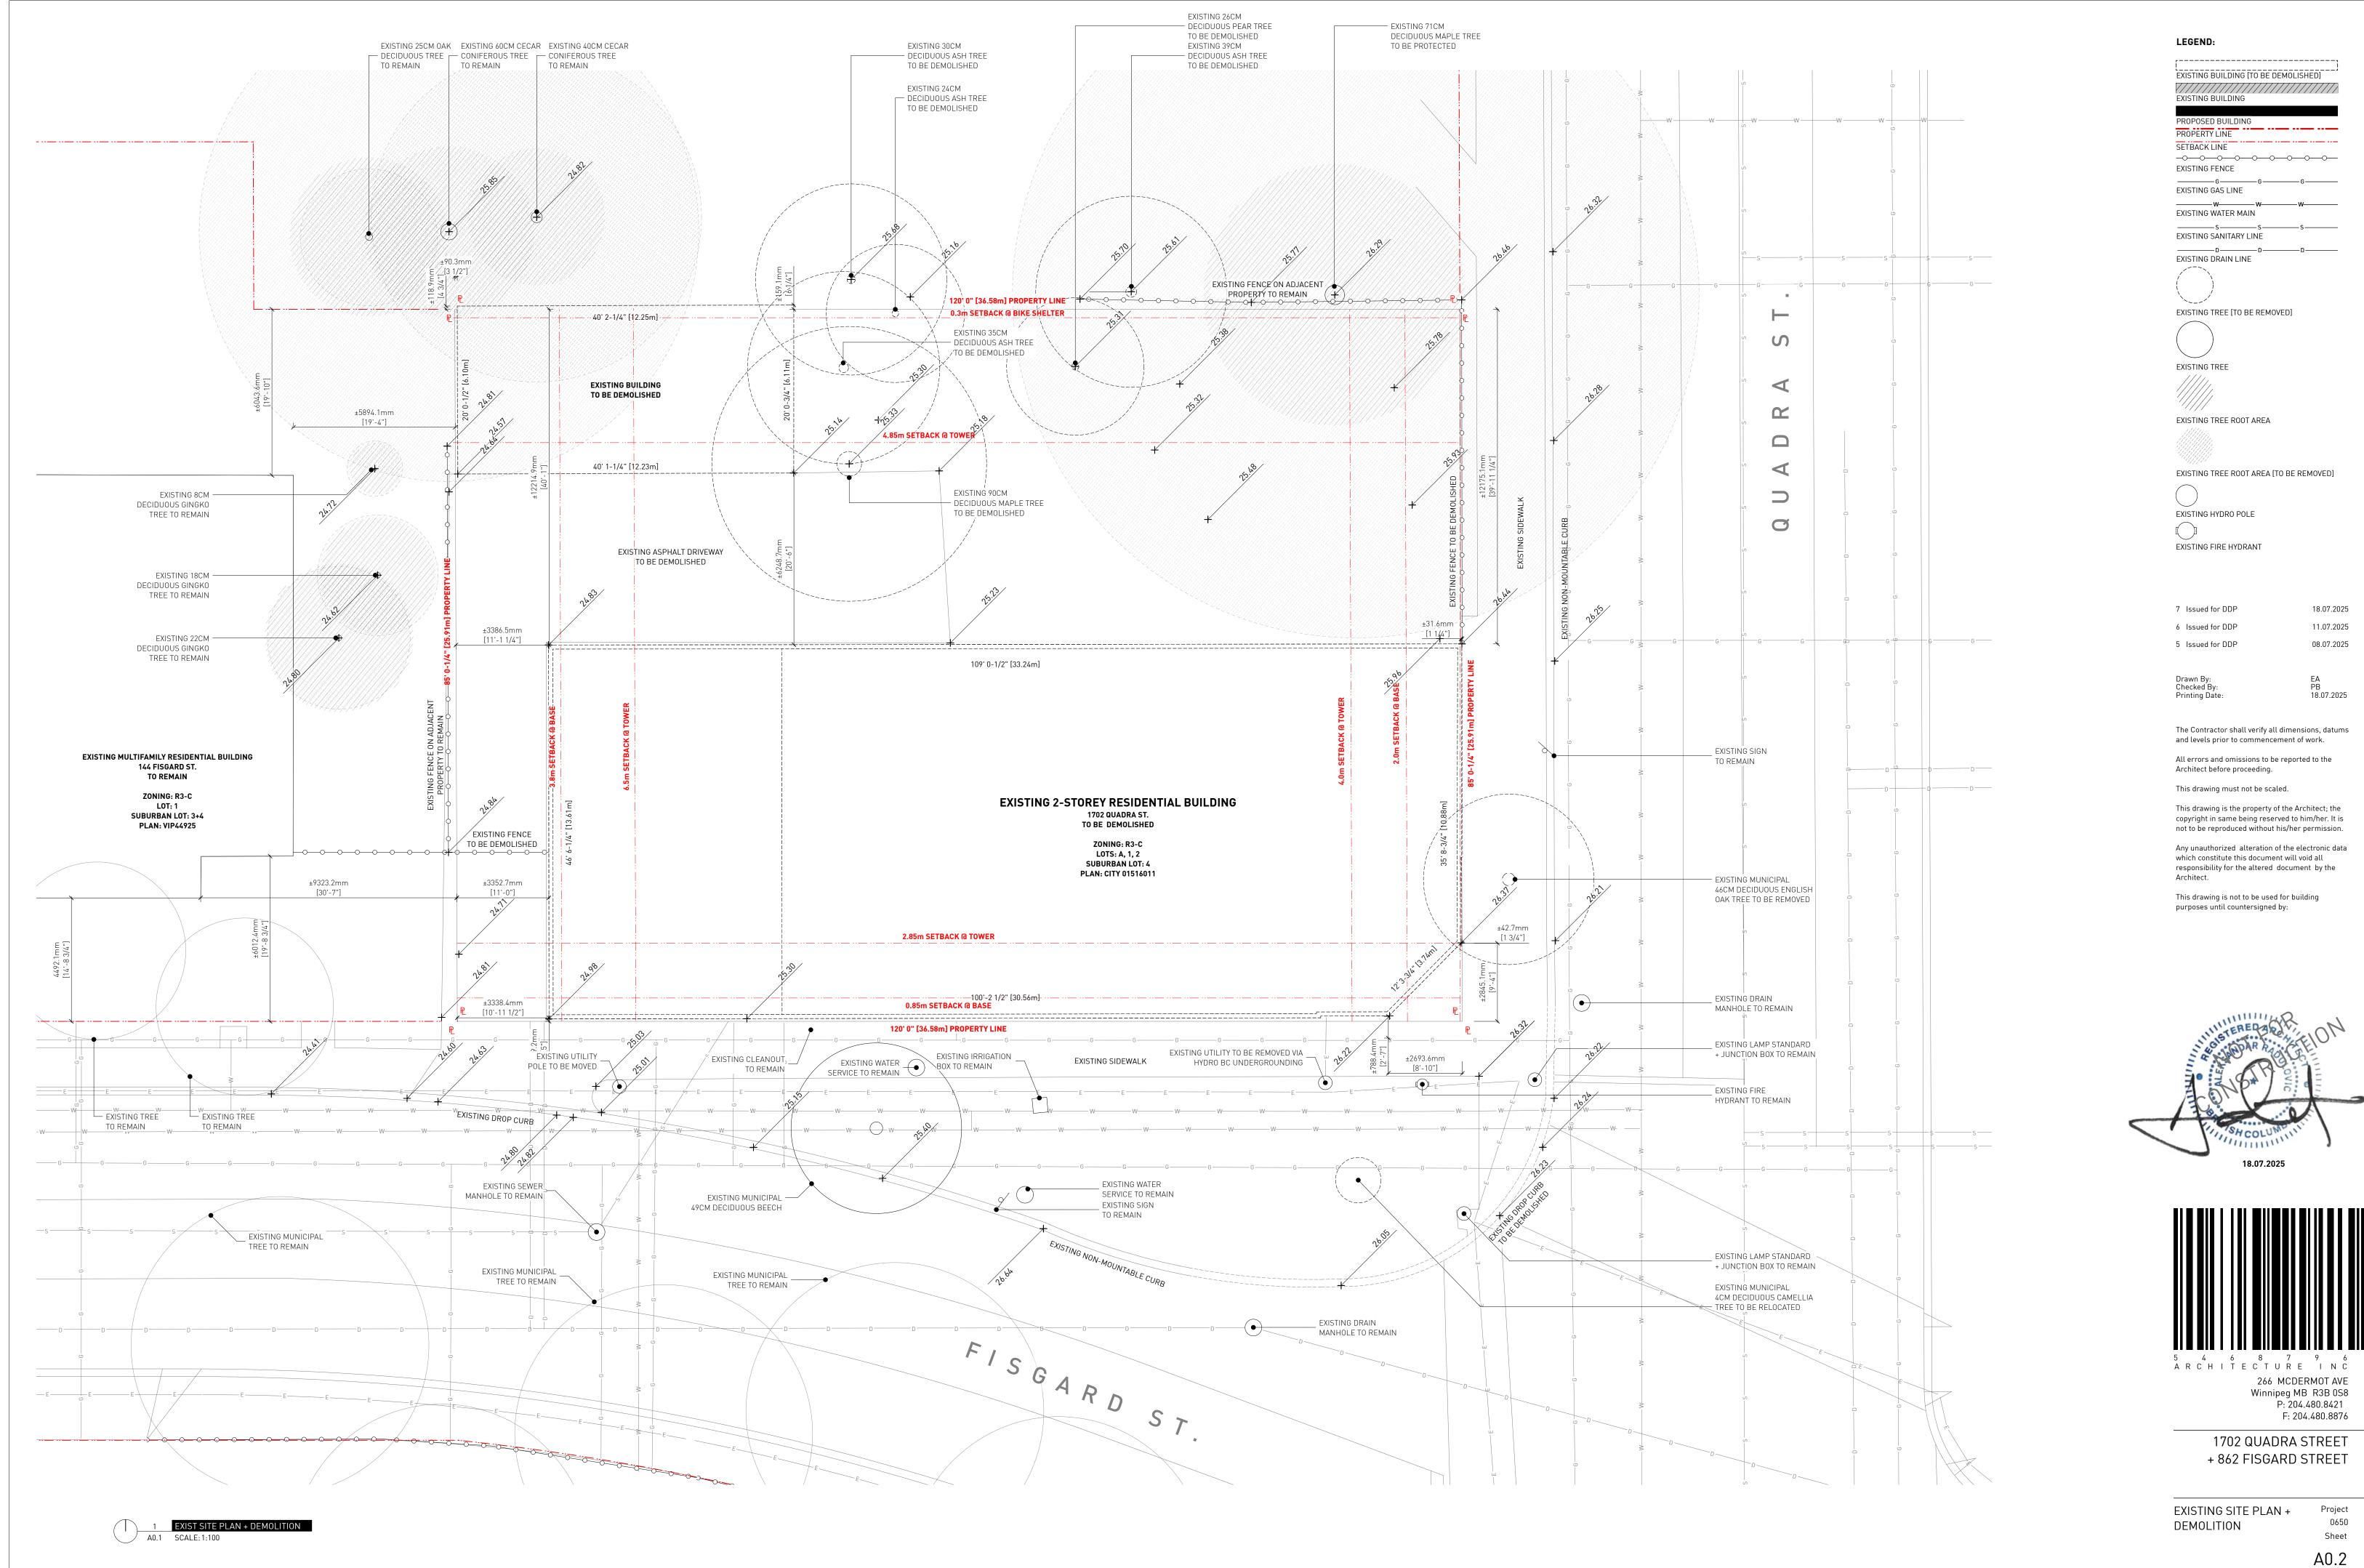


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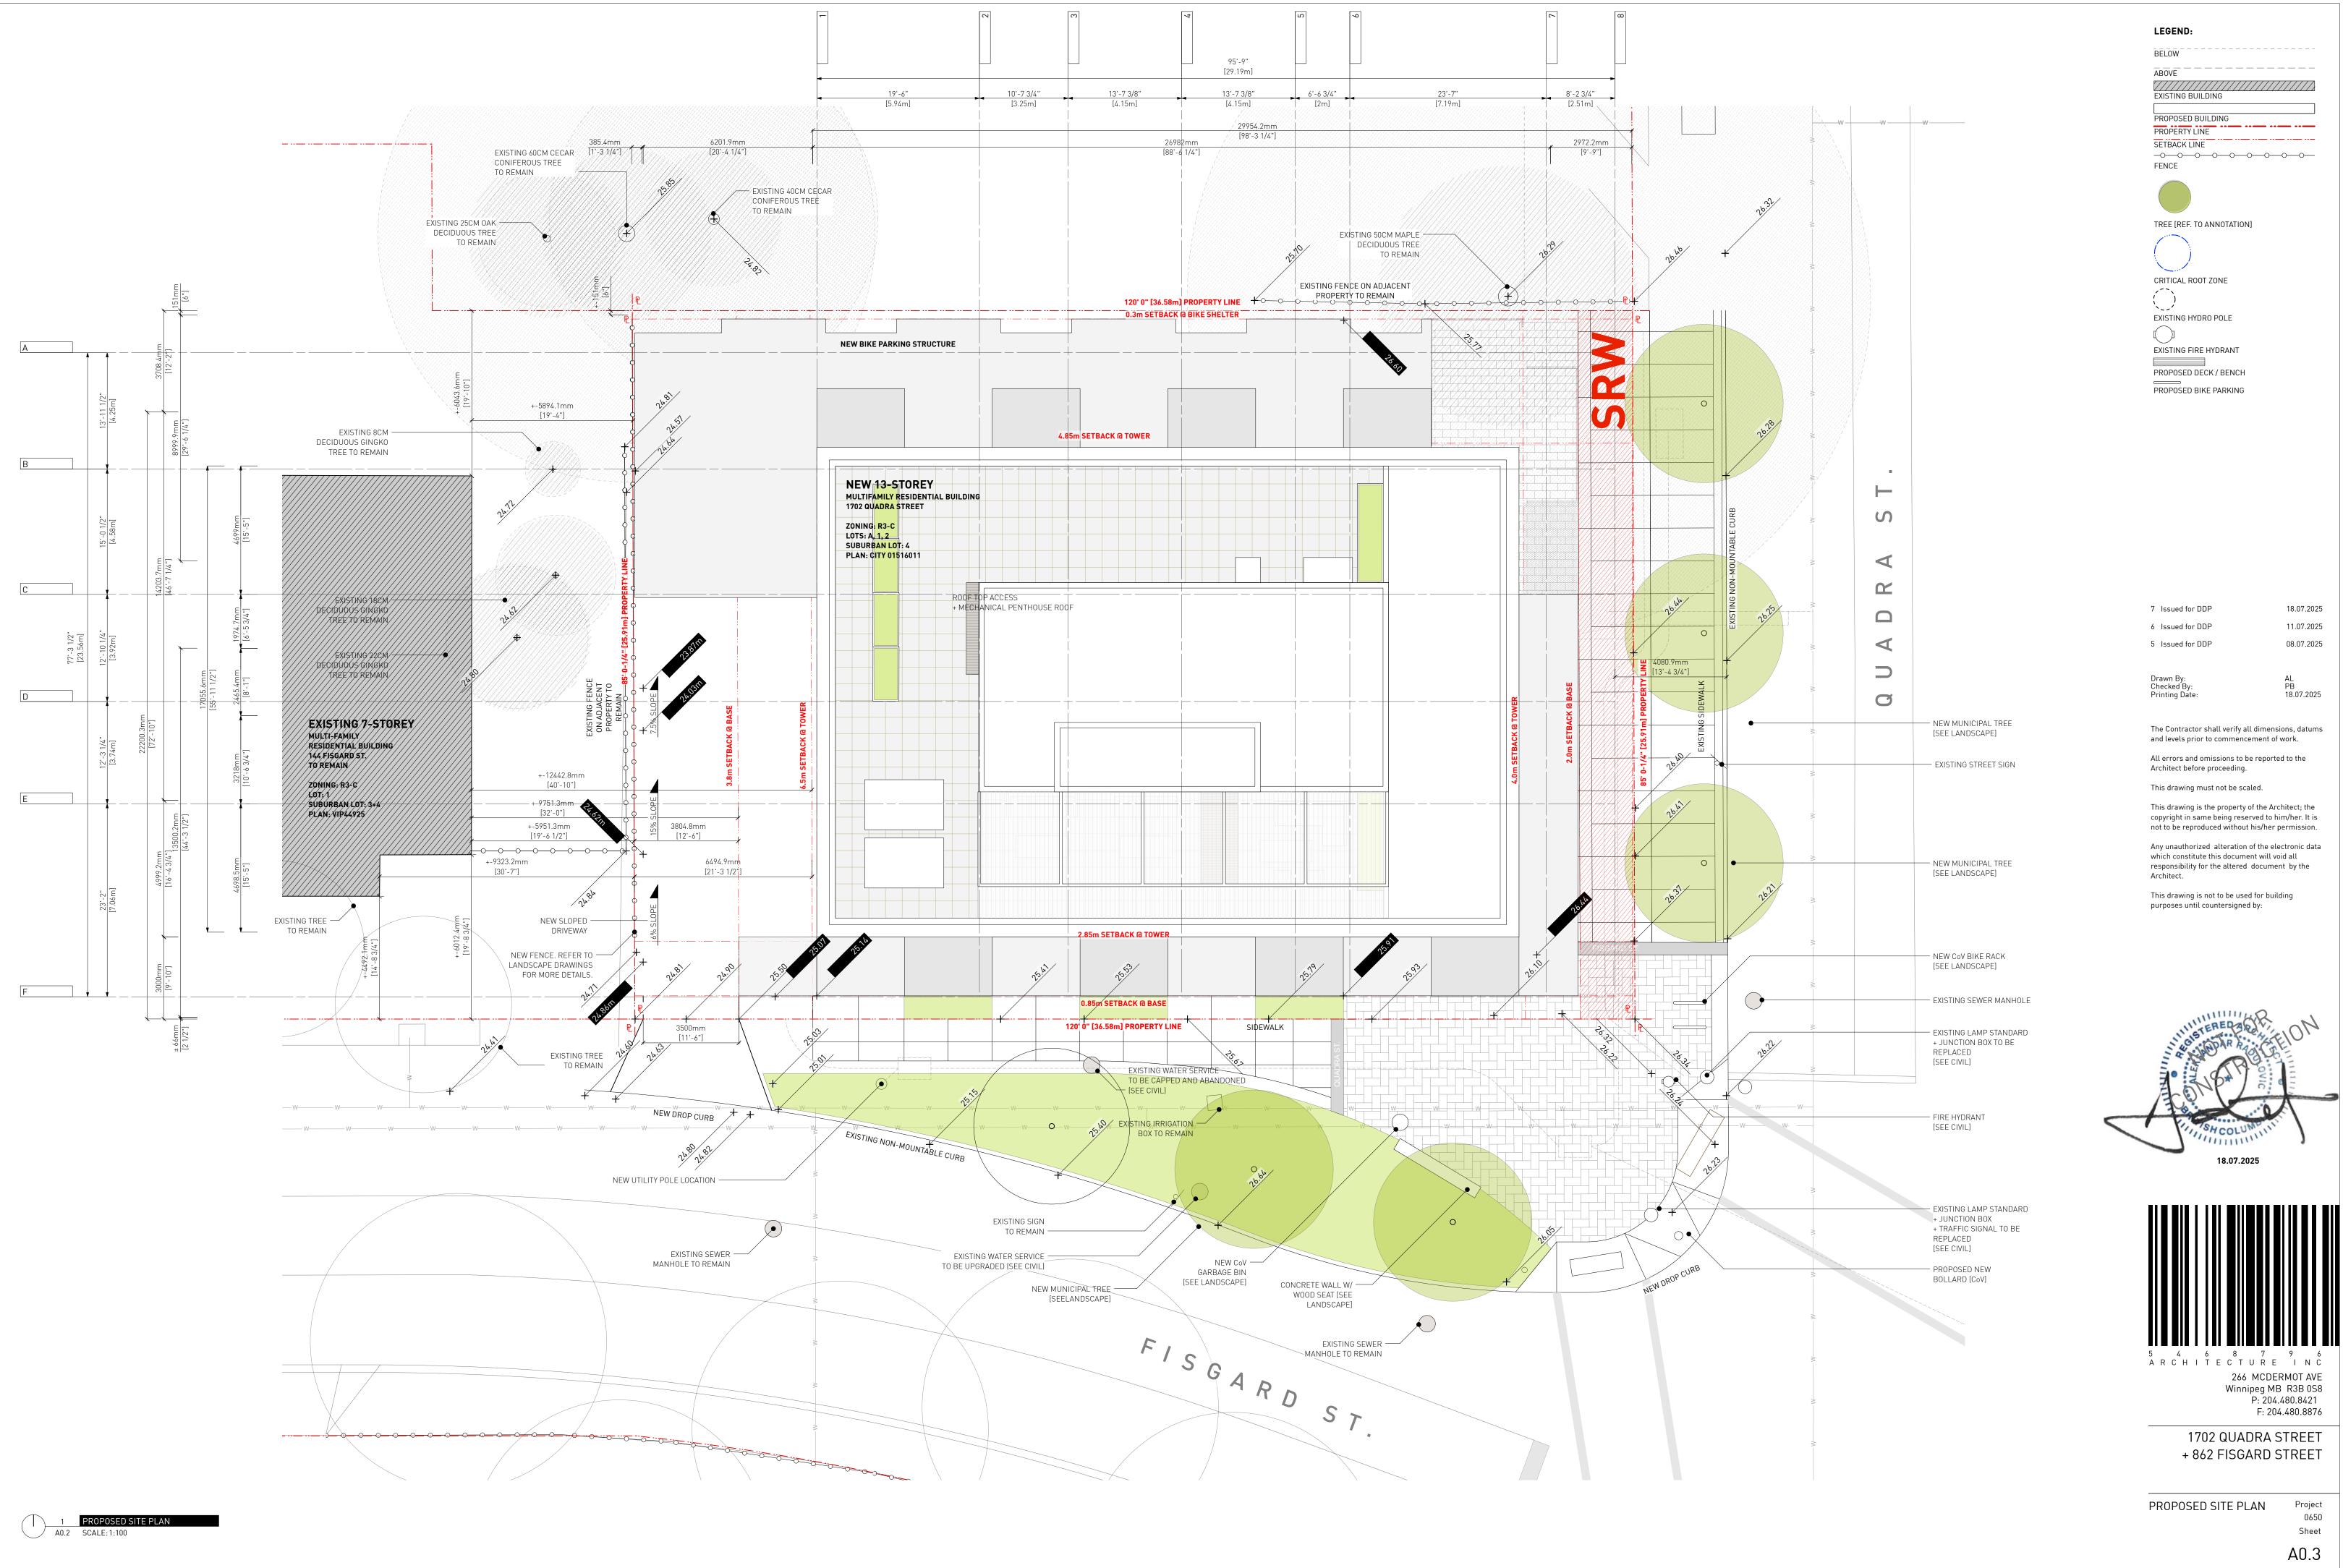
1702 QUADRA STREET + 862 FISGARD STREET


CONTEXT SITE PLAN

Project 0650 Sheet








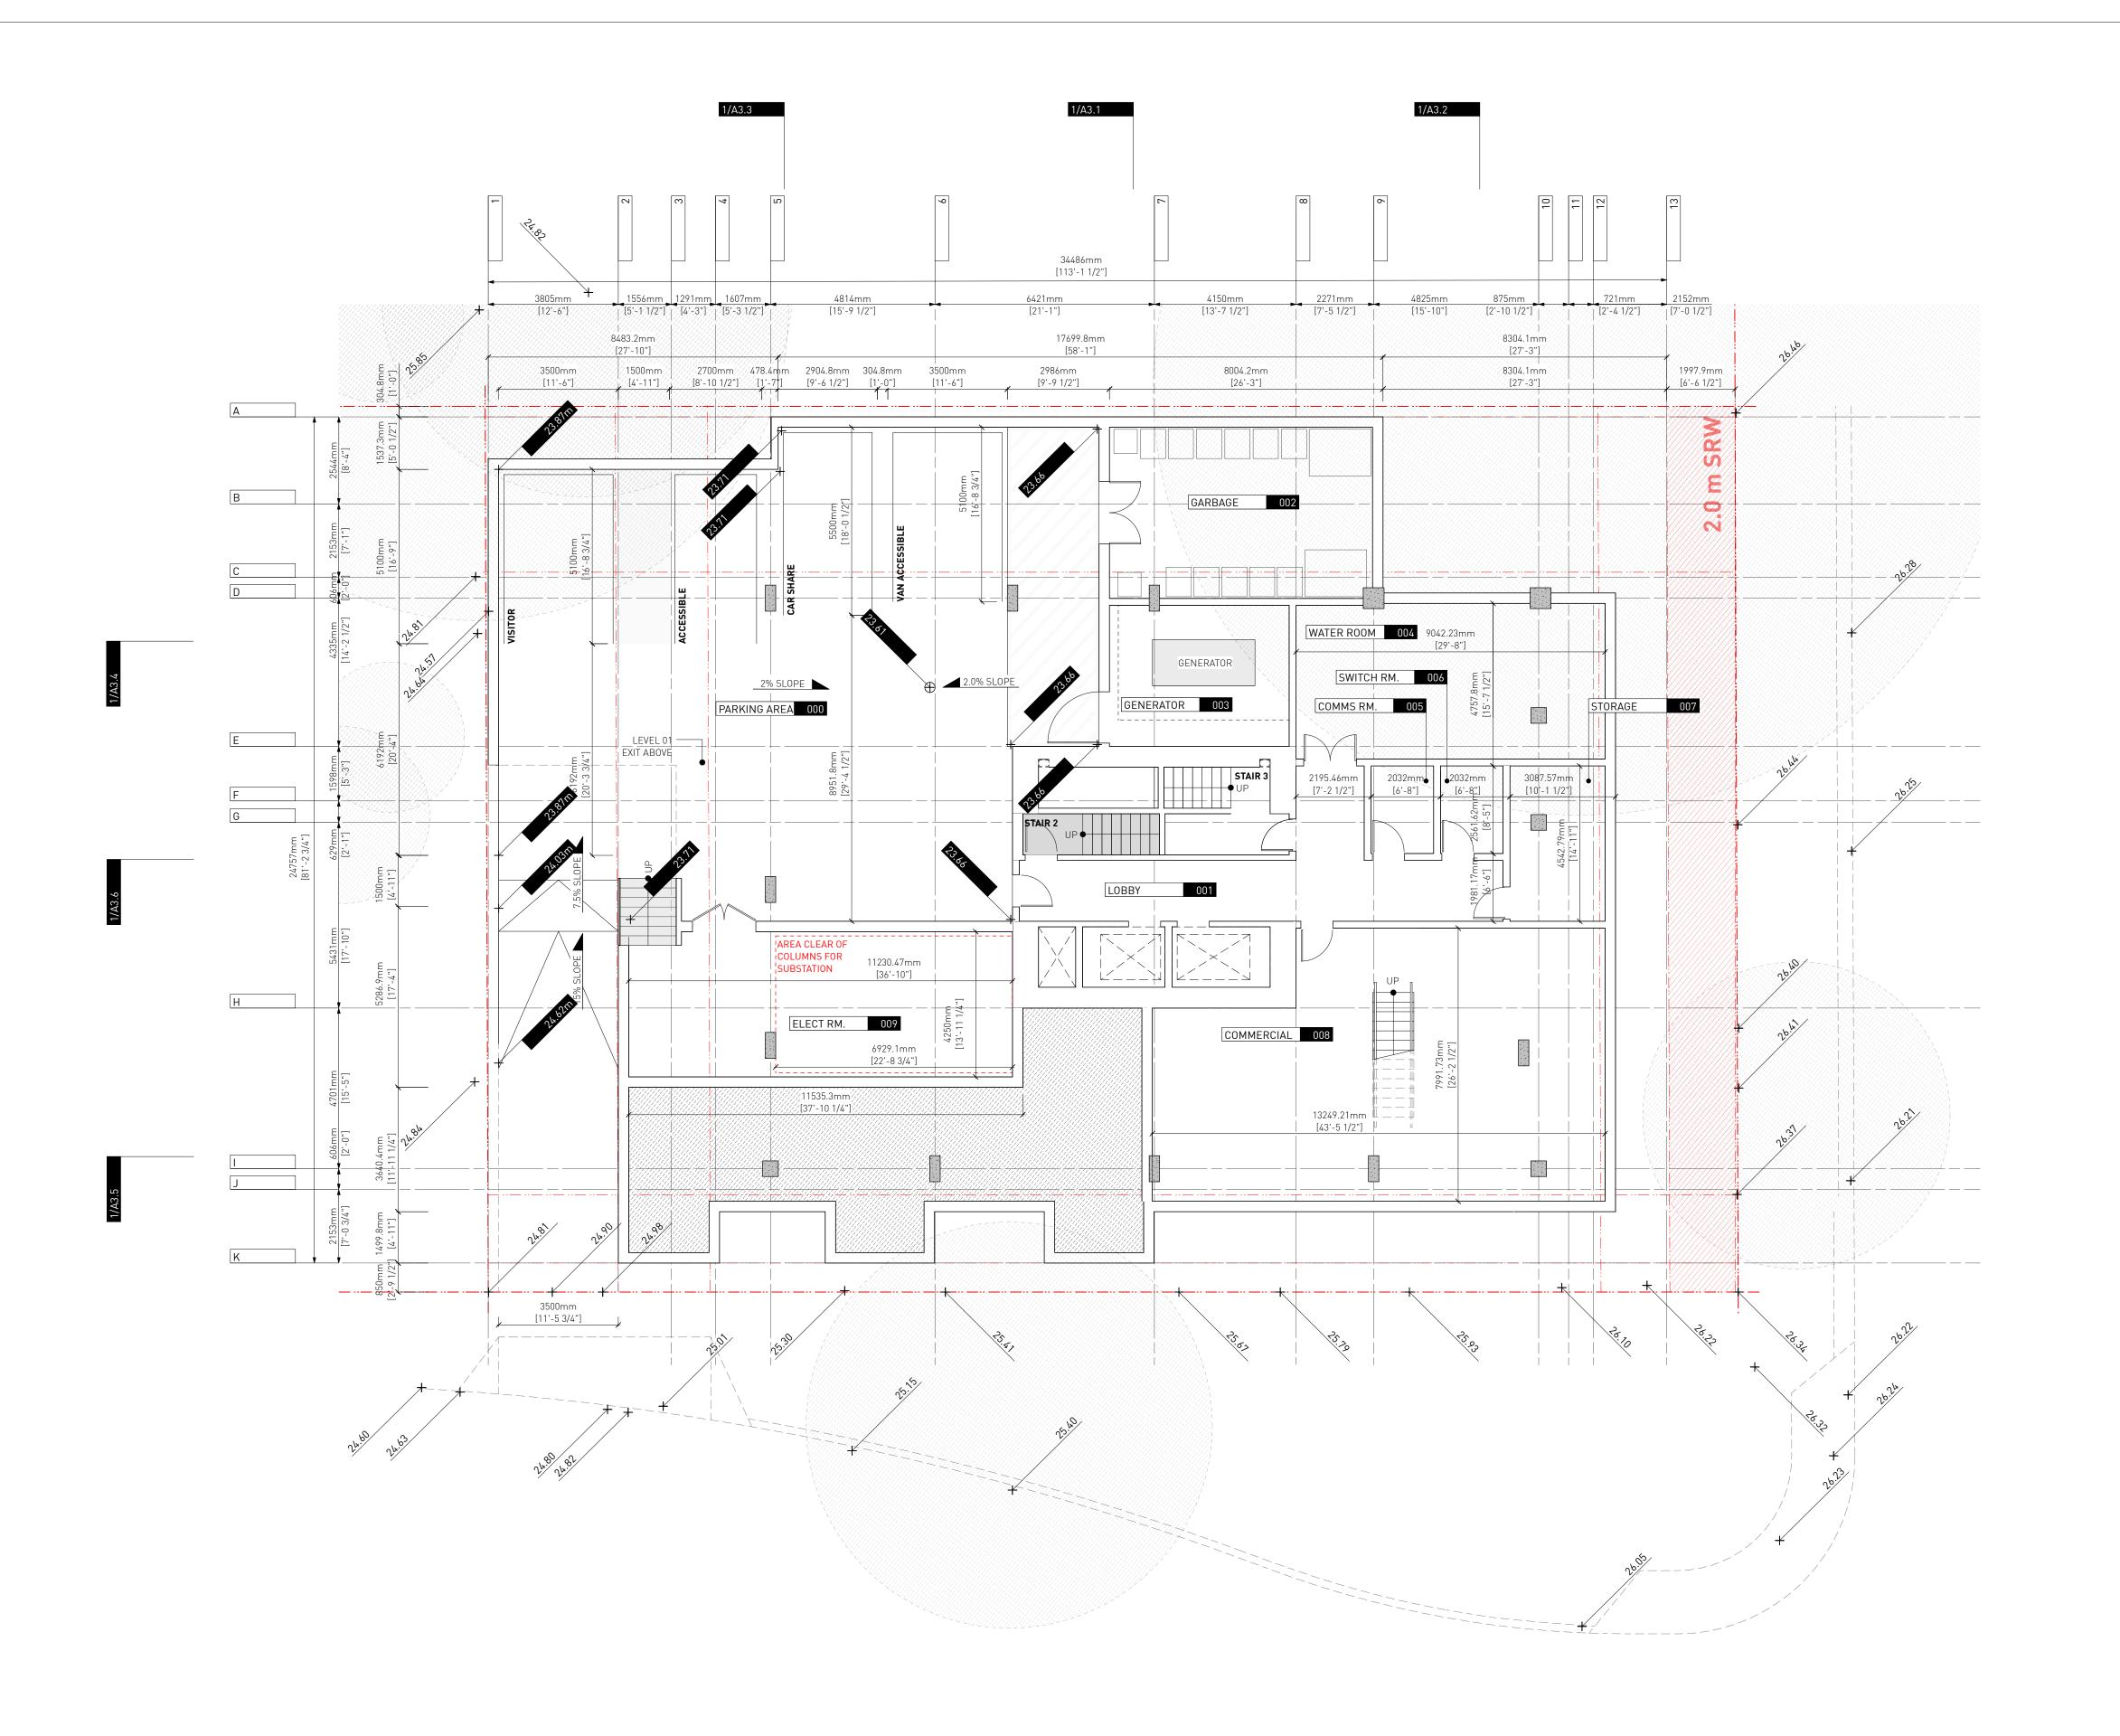

EXISTING BUILDING

PROPOSED BUILDING
PROPERTY LINE

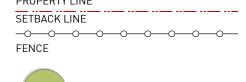



TREE [REF. TO ANNOTATION]



EXISTING HYDRO POLE

EXISTING FIRE HYDRANT

PROPOSED DECK / BENCH PROPOSED BIKE PARKING

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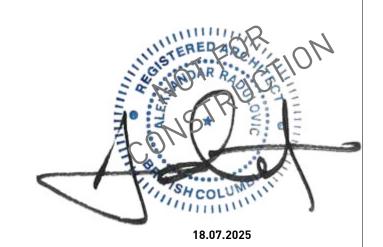
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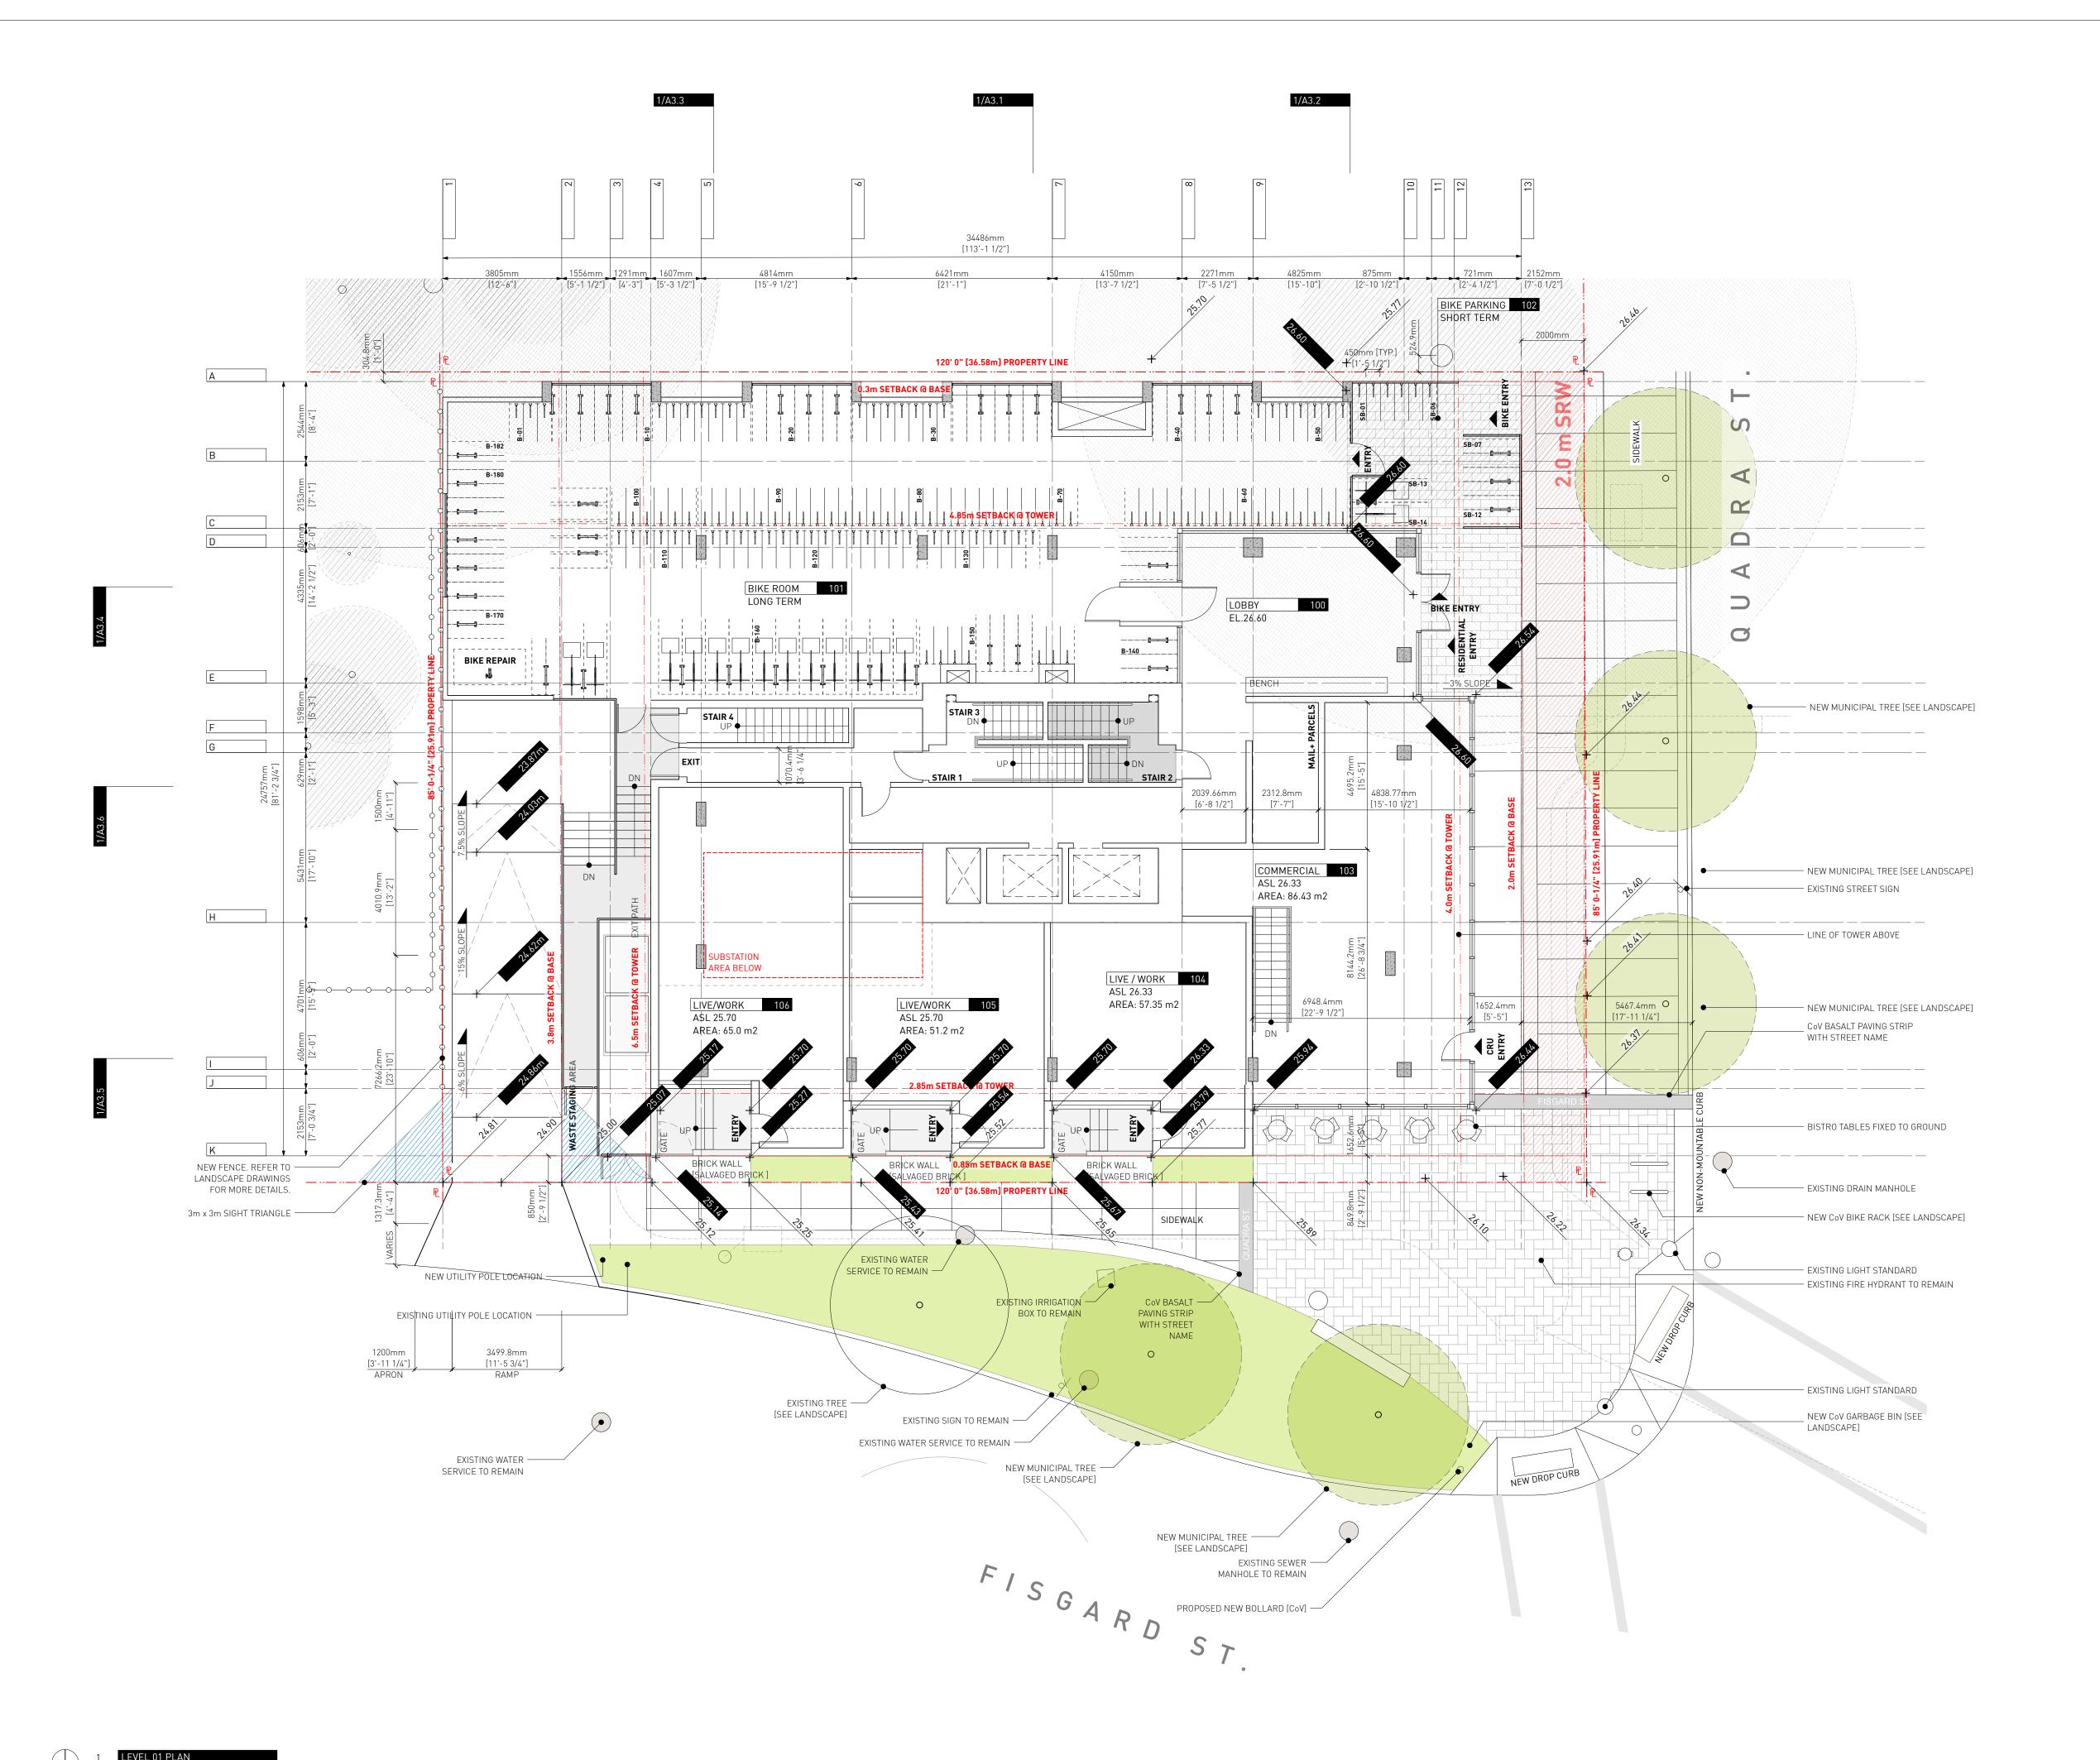
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1702 QUADRA STREET + 862 FISGARD STREET

LEVEL 00 PLAN

Project 0650 Sheet A1.1

1 LEVEL 00 PLAN
A1.1 SCALE: 1:100



EXISTING BUILDING

PROPOSED BUILDING PROPERTY LINE SETBACK LINE

TREE [REF. TO ANNOTATION]

CRITICAL ROOT ZONE

EXISTING HYDRO POLE

EXISTING FIRE HYDRANT

PROPOSED DECK / BENCH

PROPOSED BIKE PARKING

18.07.2025 7 Issued for DDP 6 Issued for DDP 11.07.2025

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08.07.2025

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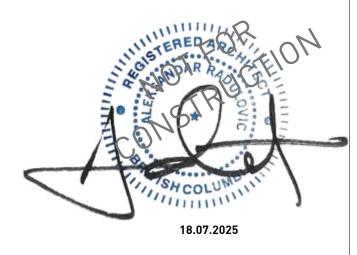
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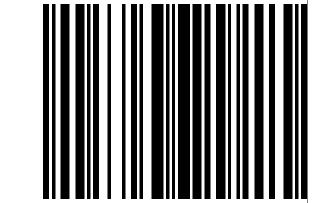
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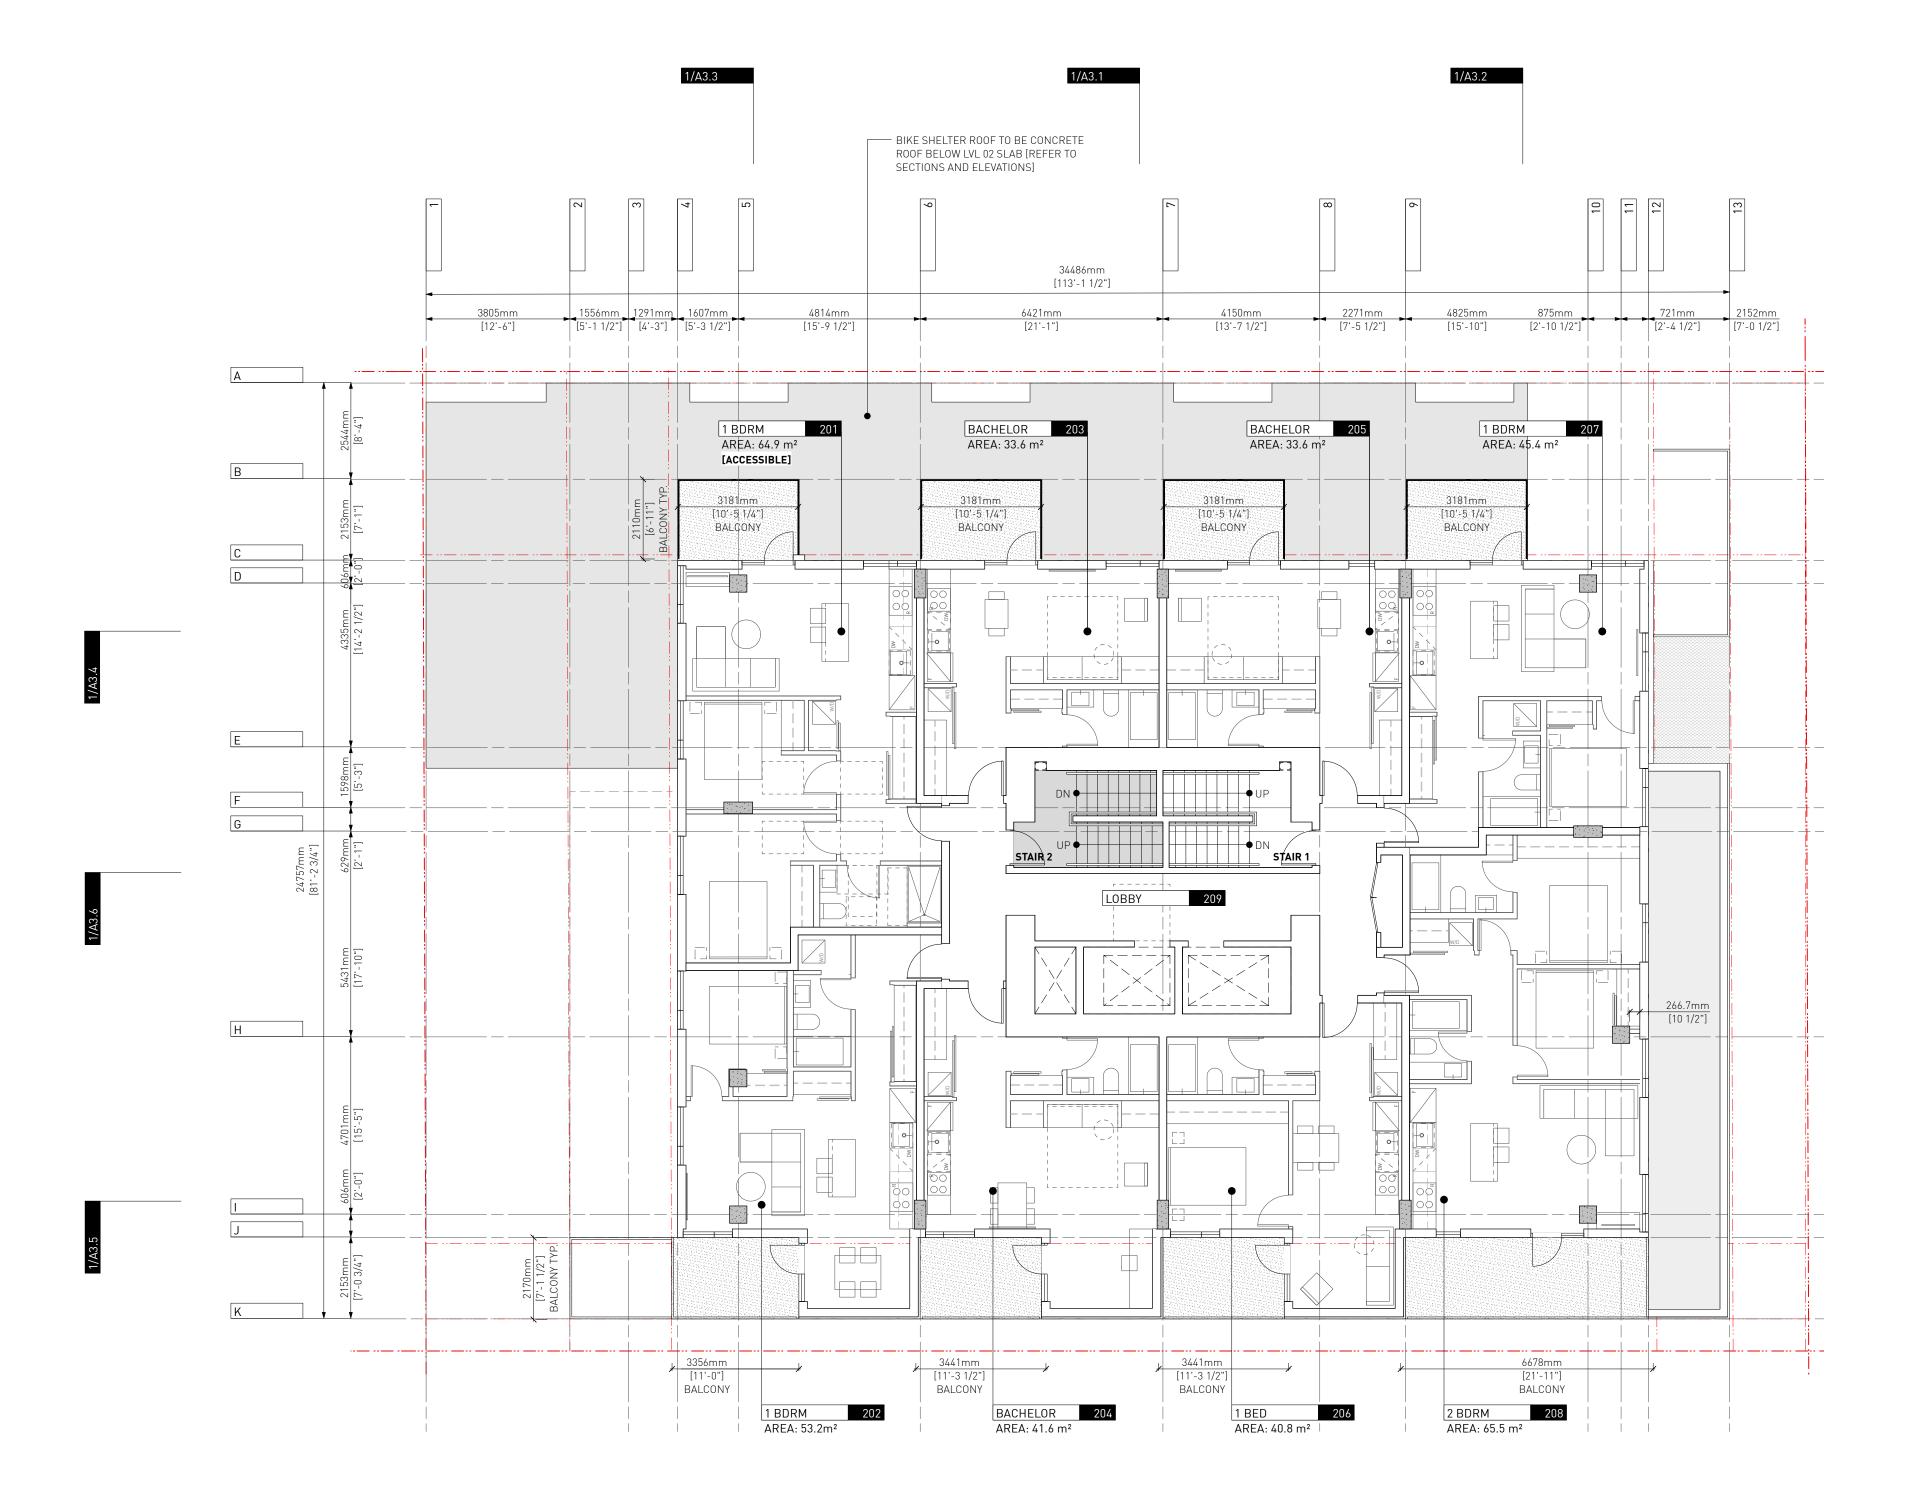


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1702 QUADRA STREET + 862 FISGARD STREET

LEVEL 01 PLAN

Project 0650 Sheet



EXISTING BUILDING

PROPOSED BUILDING

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5 Issued for DDP

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11.07.2025

08.07.2025

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PROPERTY LINE SETBACK LINE

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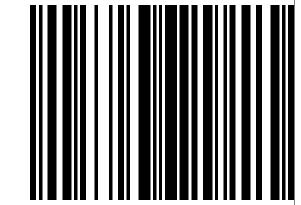
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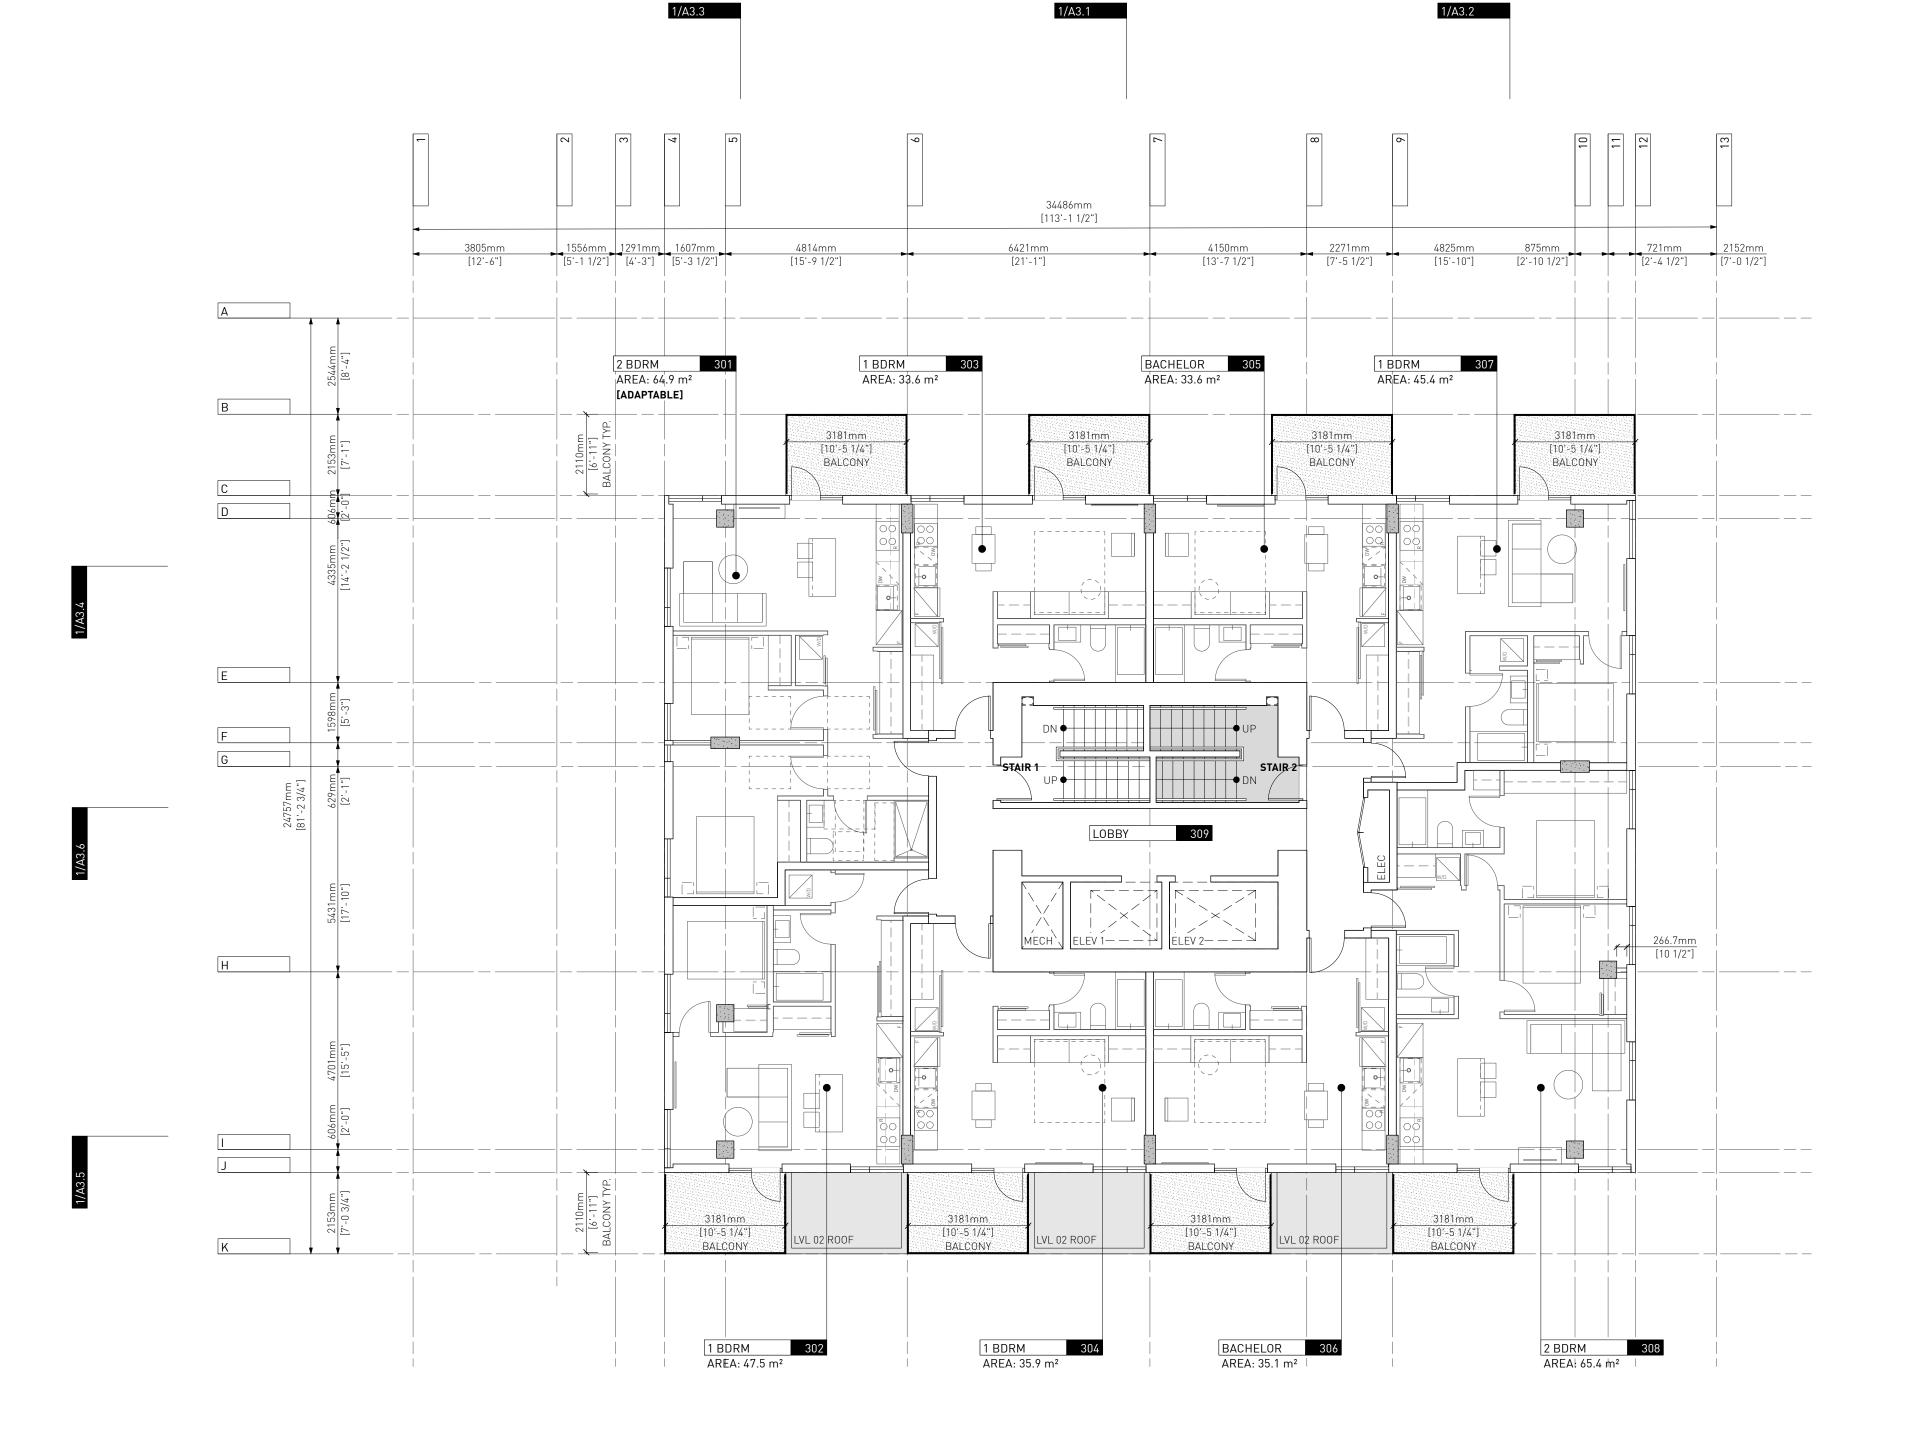


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1702 QUADRA STREET + 862 FISGARD STREET

LEVEL 02 PLAN

Project 0650 Sheet A1.3





BELOW

EXISTING BUILDING

PROPOSED BUILDING

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18.07.2025

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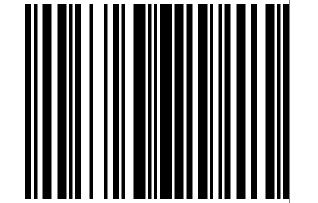
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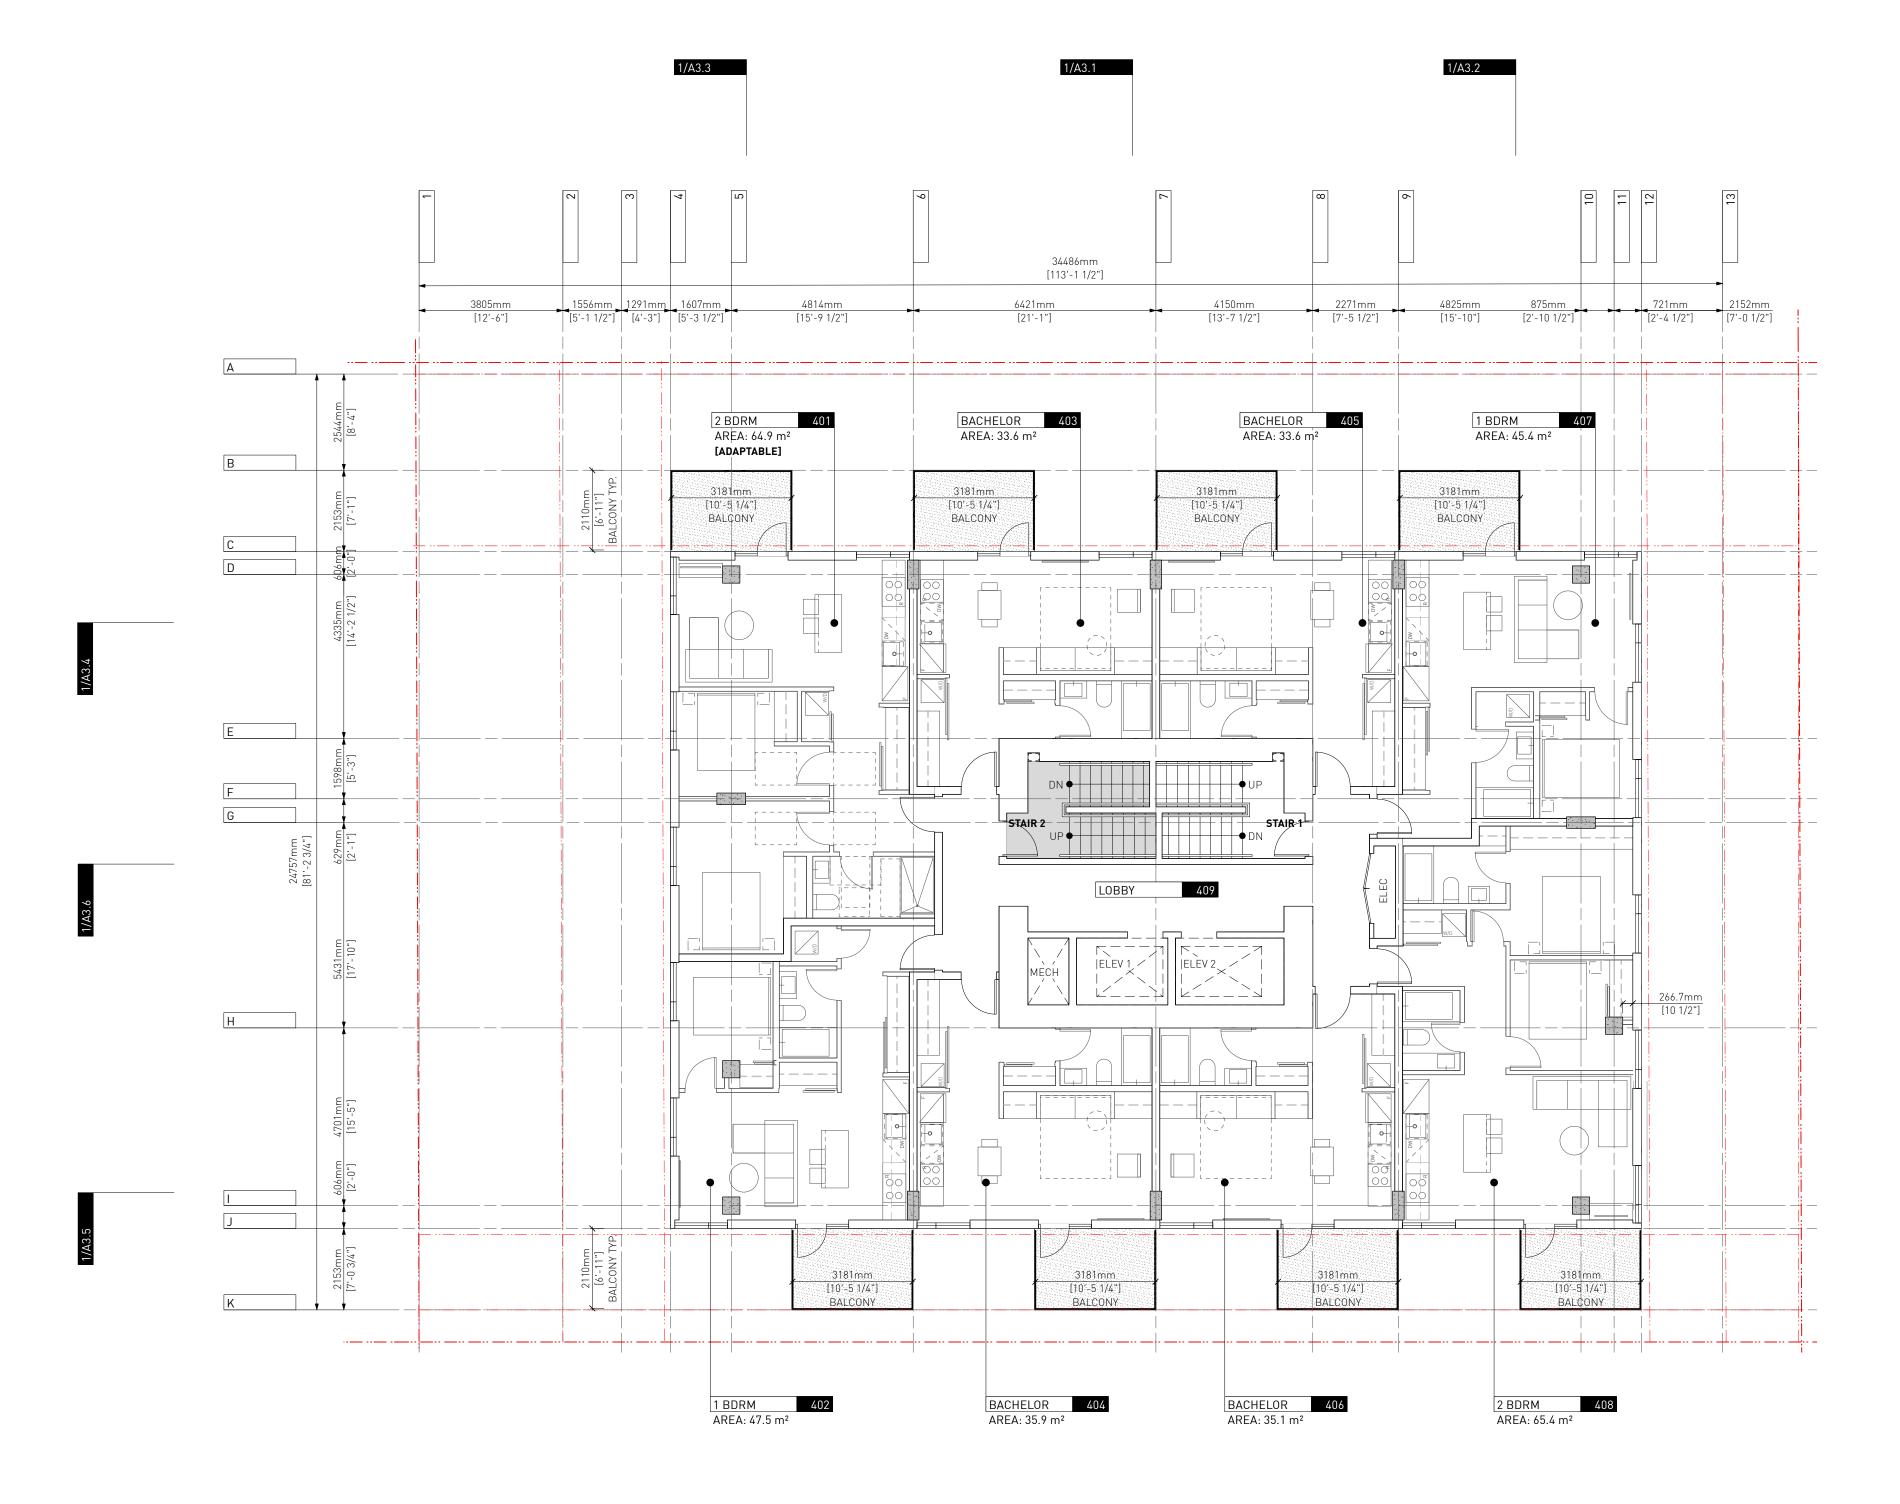


5 4 6 8 7 9 6 A R C H I T E C T U R E I N C 266 MCDERMOT AVE Winnipeg MB R3B 0S8 P: 204.480.8421 F: 204.480.8876

1702 QUADRA STREET + 862 FISGARD STREET

LEVEL 03 PLAN

Project 0650 Sheet



2 LEVEL 04 / 06 / 08 / 10 / 12 A1.5 SCALE: 1:100

LEGEND:

LOW

AB0VE

EXISTING BUILDING

PROPOSED BUILDING
PROPERTY LINE
SETBACK LINE

FENCE

5 Issued for DDP 08.07.2025

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11.07.2025

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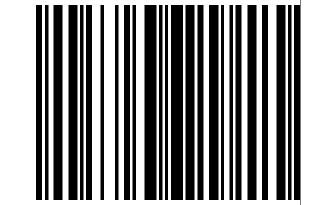
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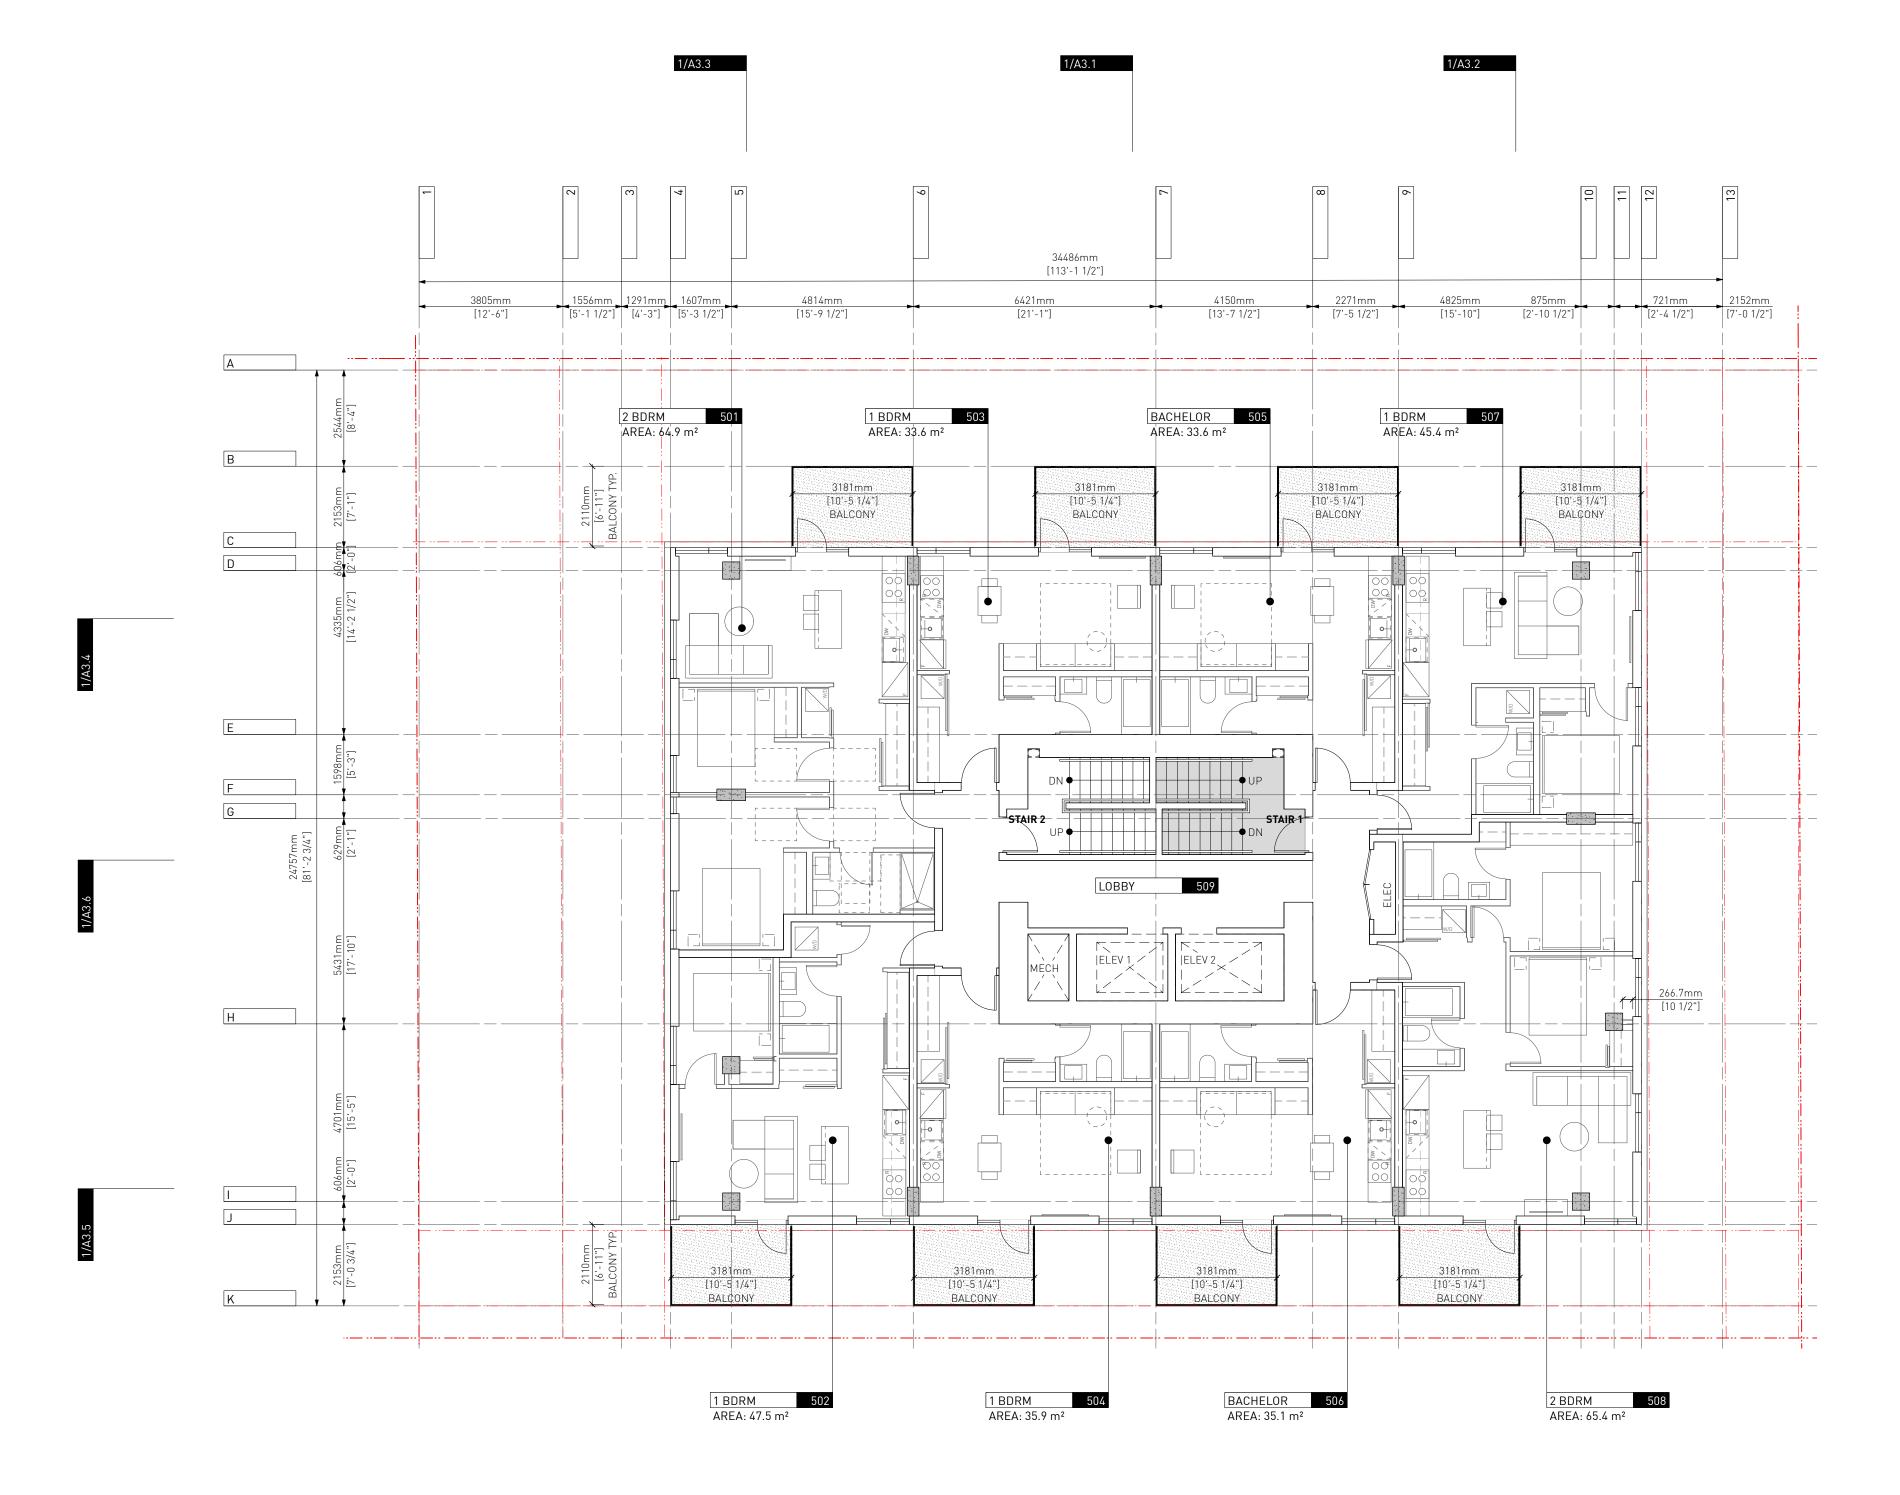


5 4 6 8 7 9 6 A R C H I T E C T U R E I N C 266 MCDERMOT AVE Winnipeg MB R3B 0S8 P: 204.480.8421 F: 204.480.8876

1702 QUADRA STREET + 862 FISGARD STREET

LEVEL 04/06/08/10/12

Sheet A1.5



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EXISTING BUILDING

PROPOSED BUILDING

PROPERTY LINE SETBACK LINE

18.07.2025


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1702 QUADRA STREET + 862 FISGARD STREET

LEVEL 05/07/09/11

Project 0650 Sheet



EXISTING BUILDING

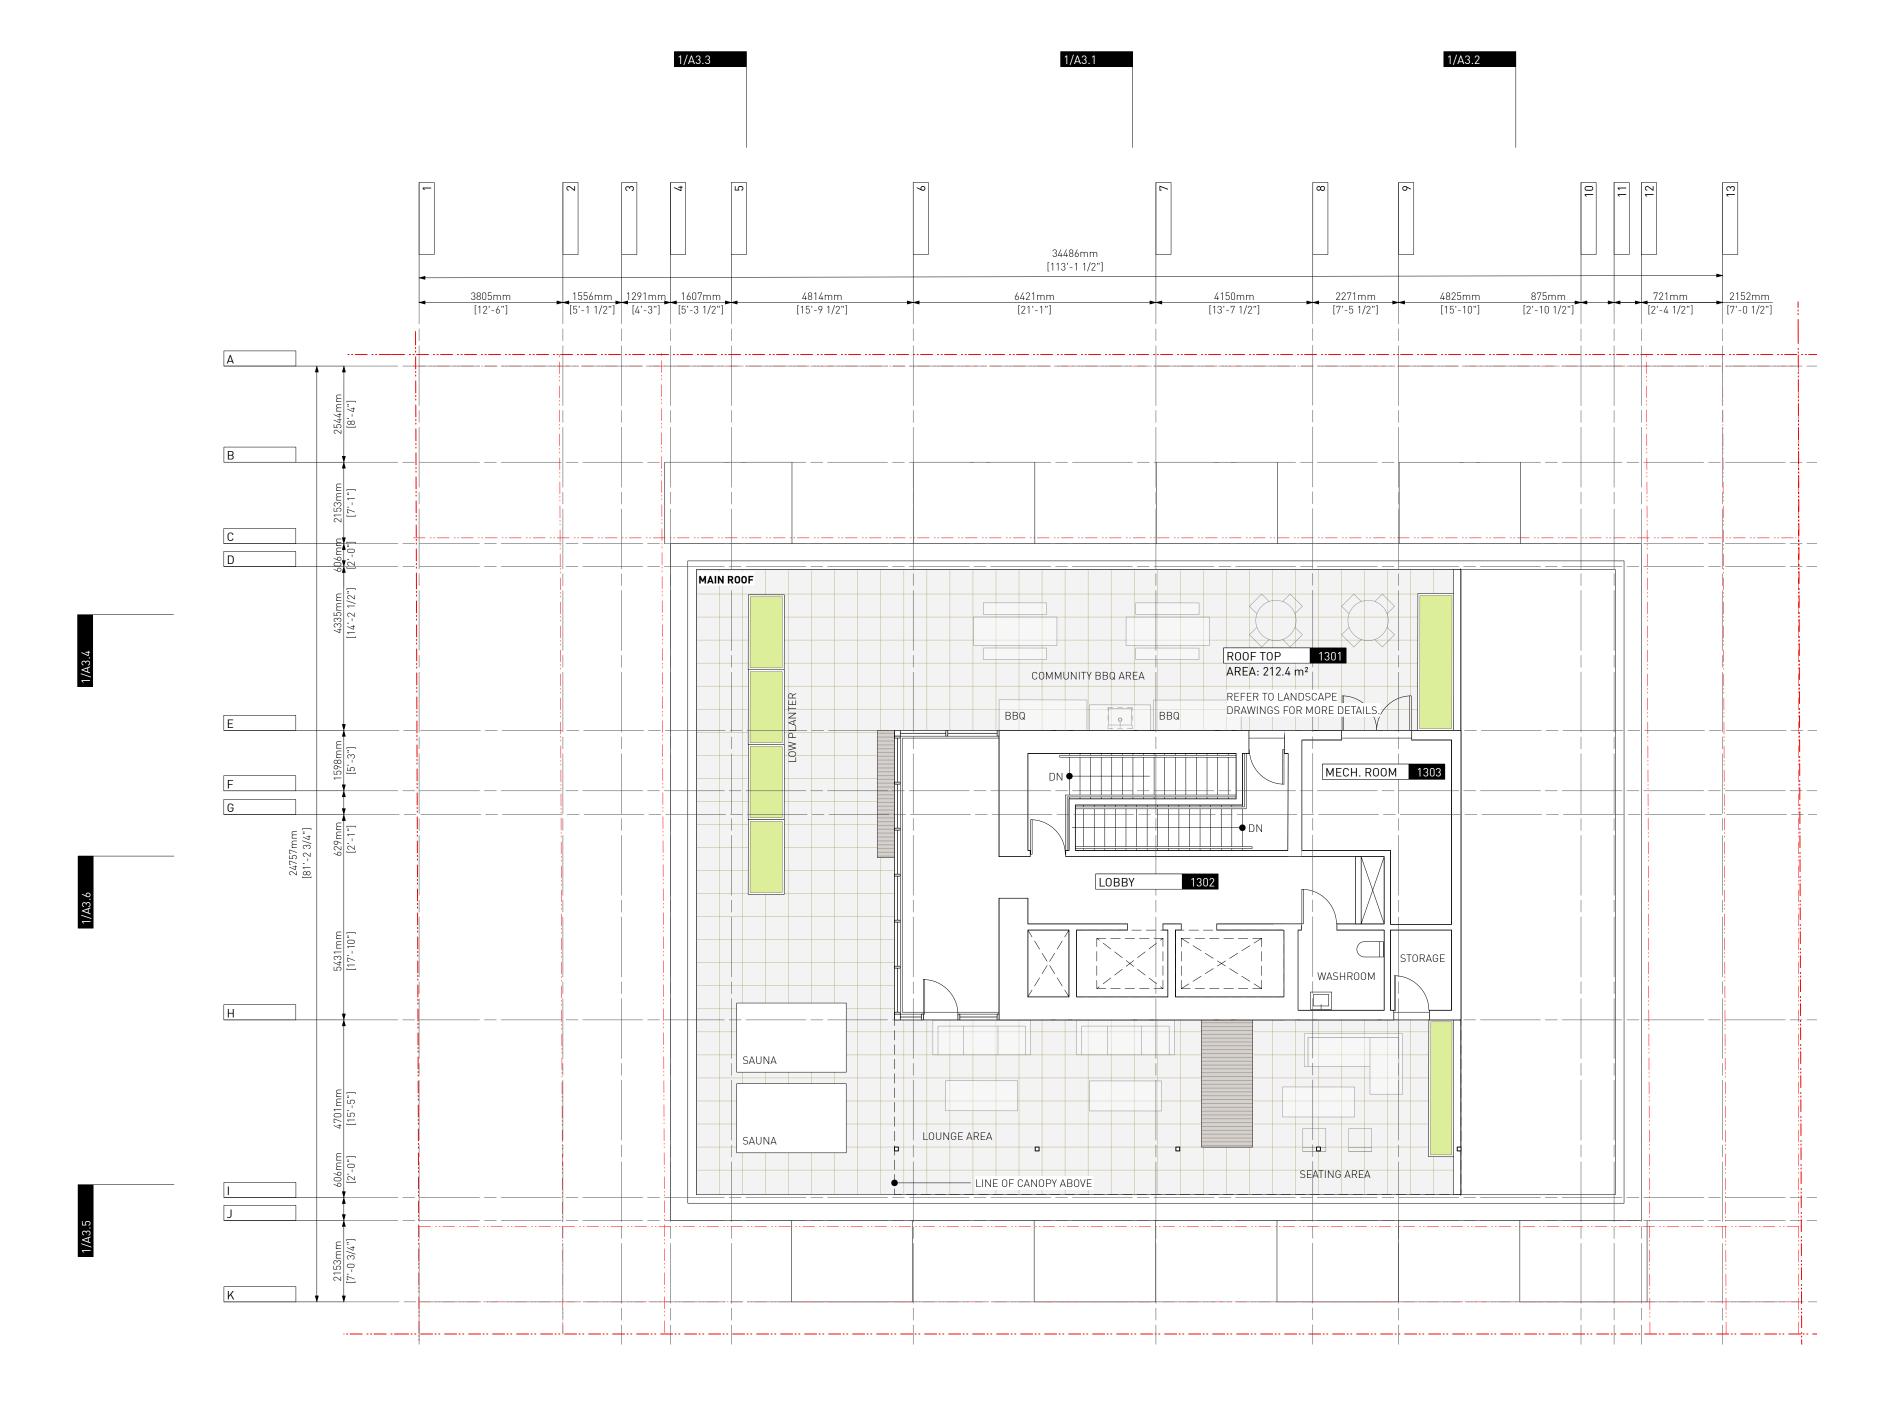PROPOSED BUILDING PROPERTY LINE

SETBACK LINE

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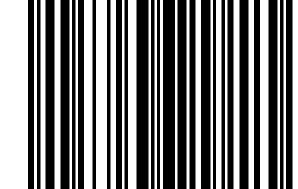
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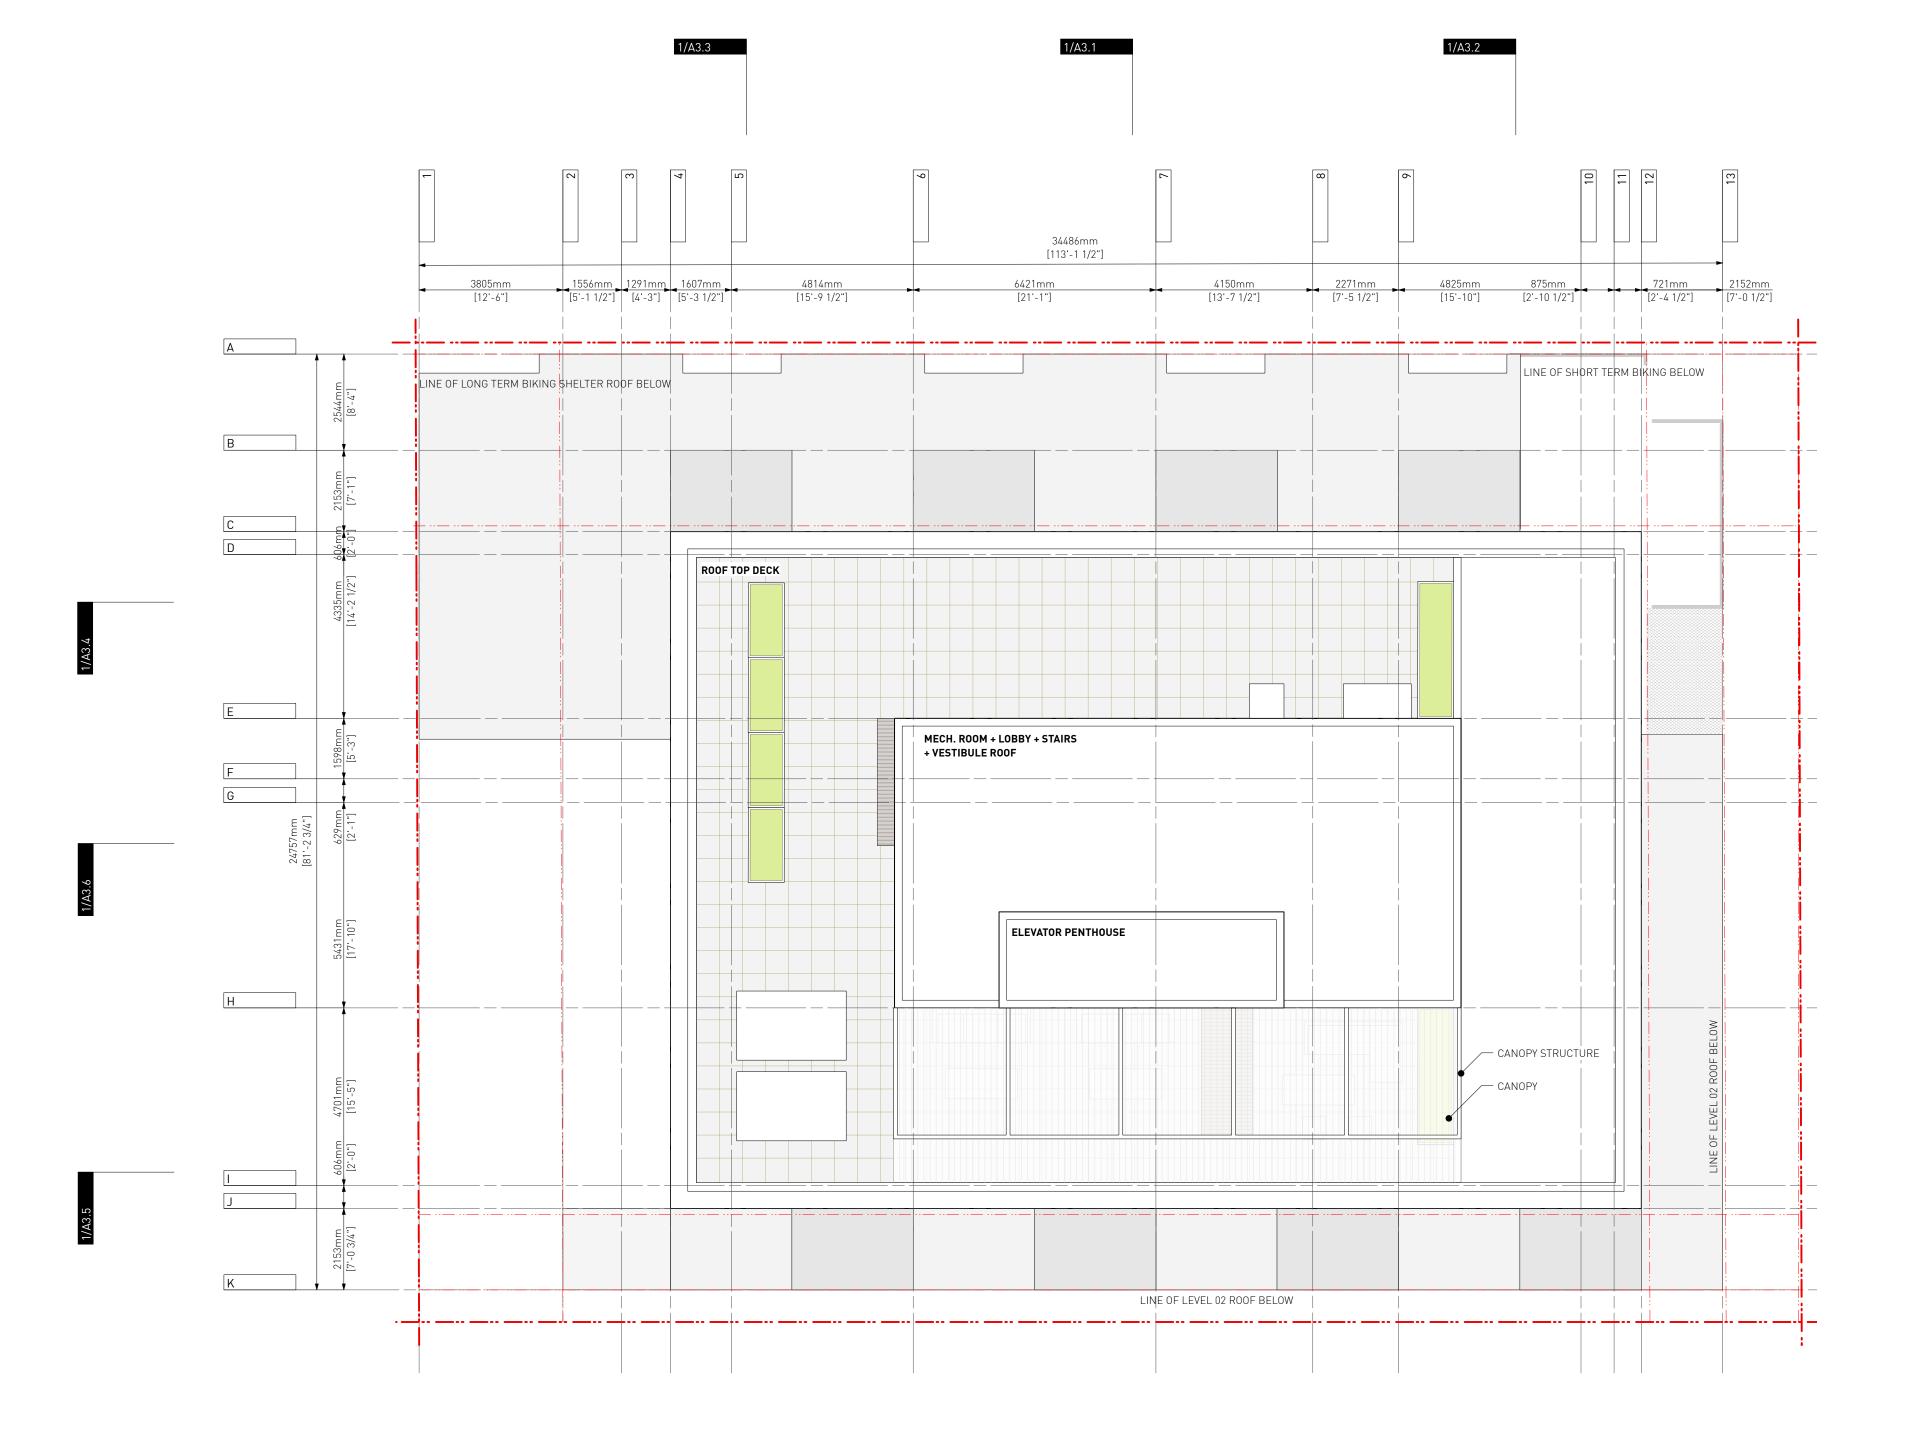


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1702 QUADRA STREET + 862 FISGARD STREET

LEVEL 13

Project 0650 Sheet



EXISTING BUILDING

PROPOSED BUILDING

PROPERTY LINE SETBACK LINE

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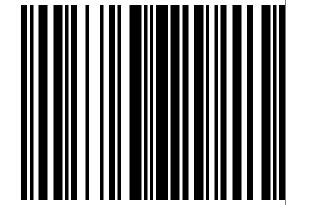
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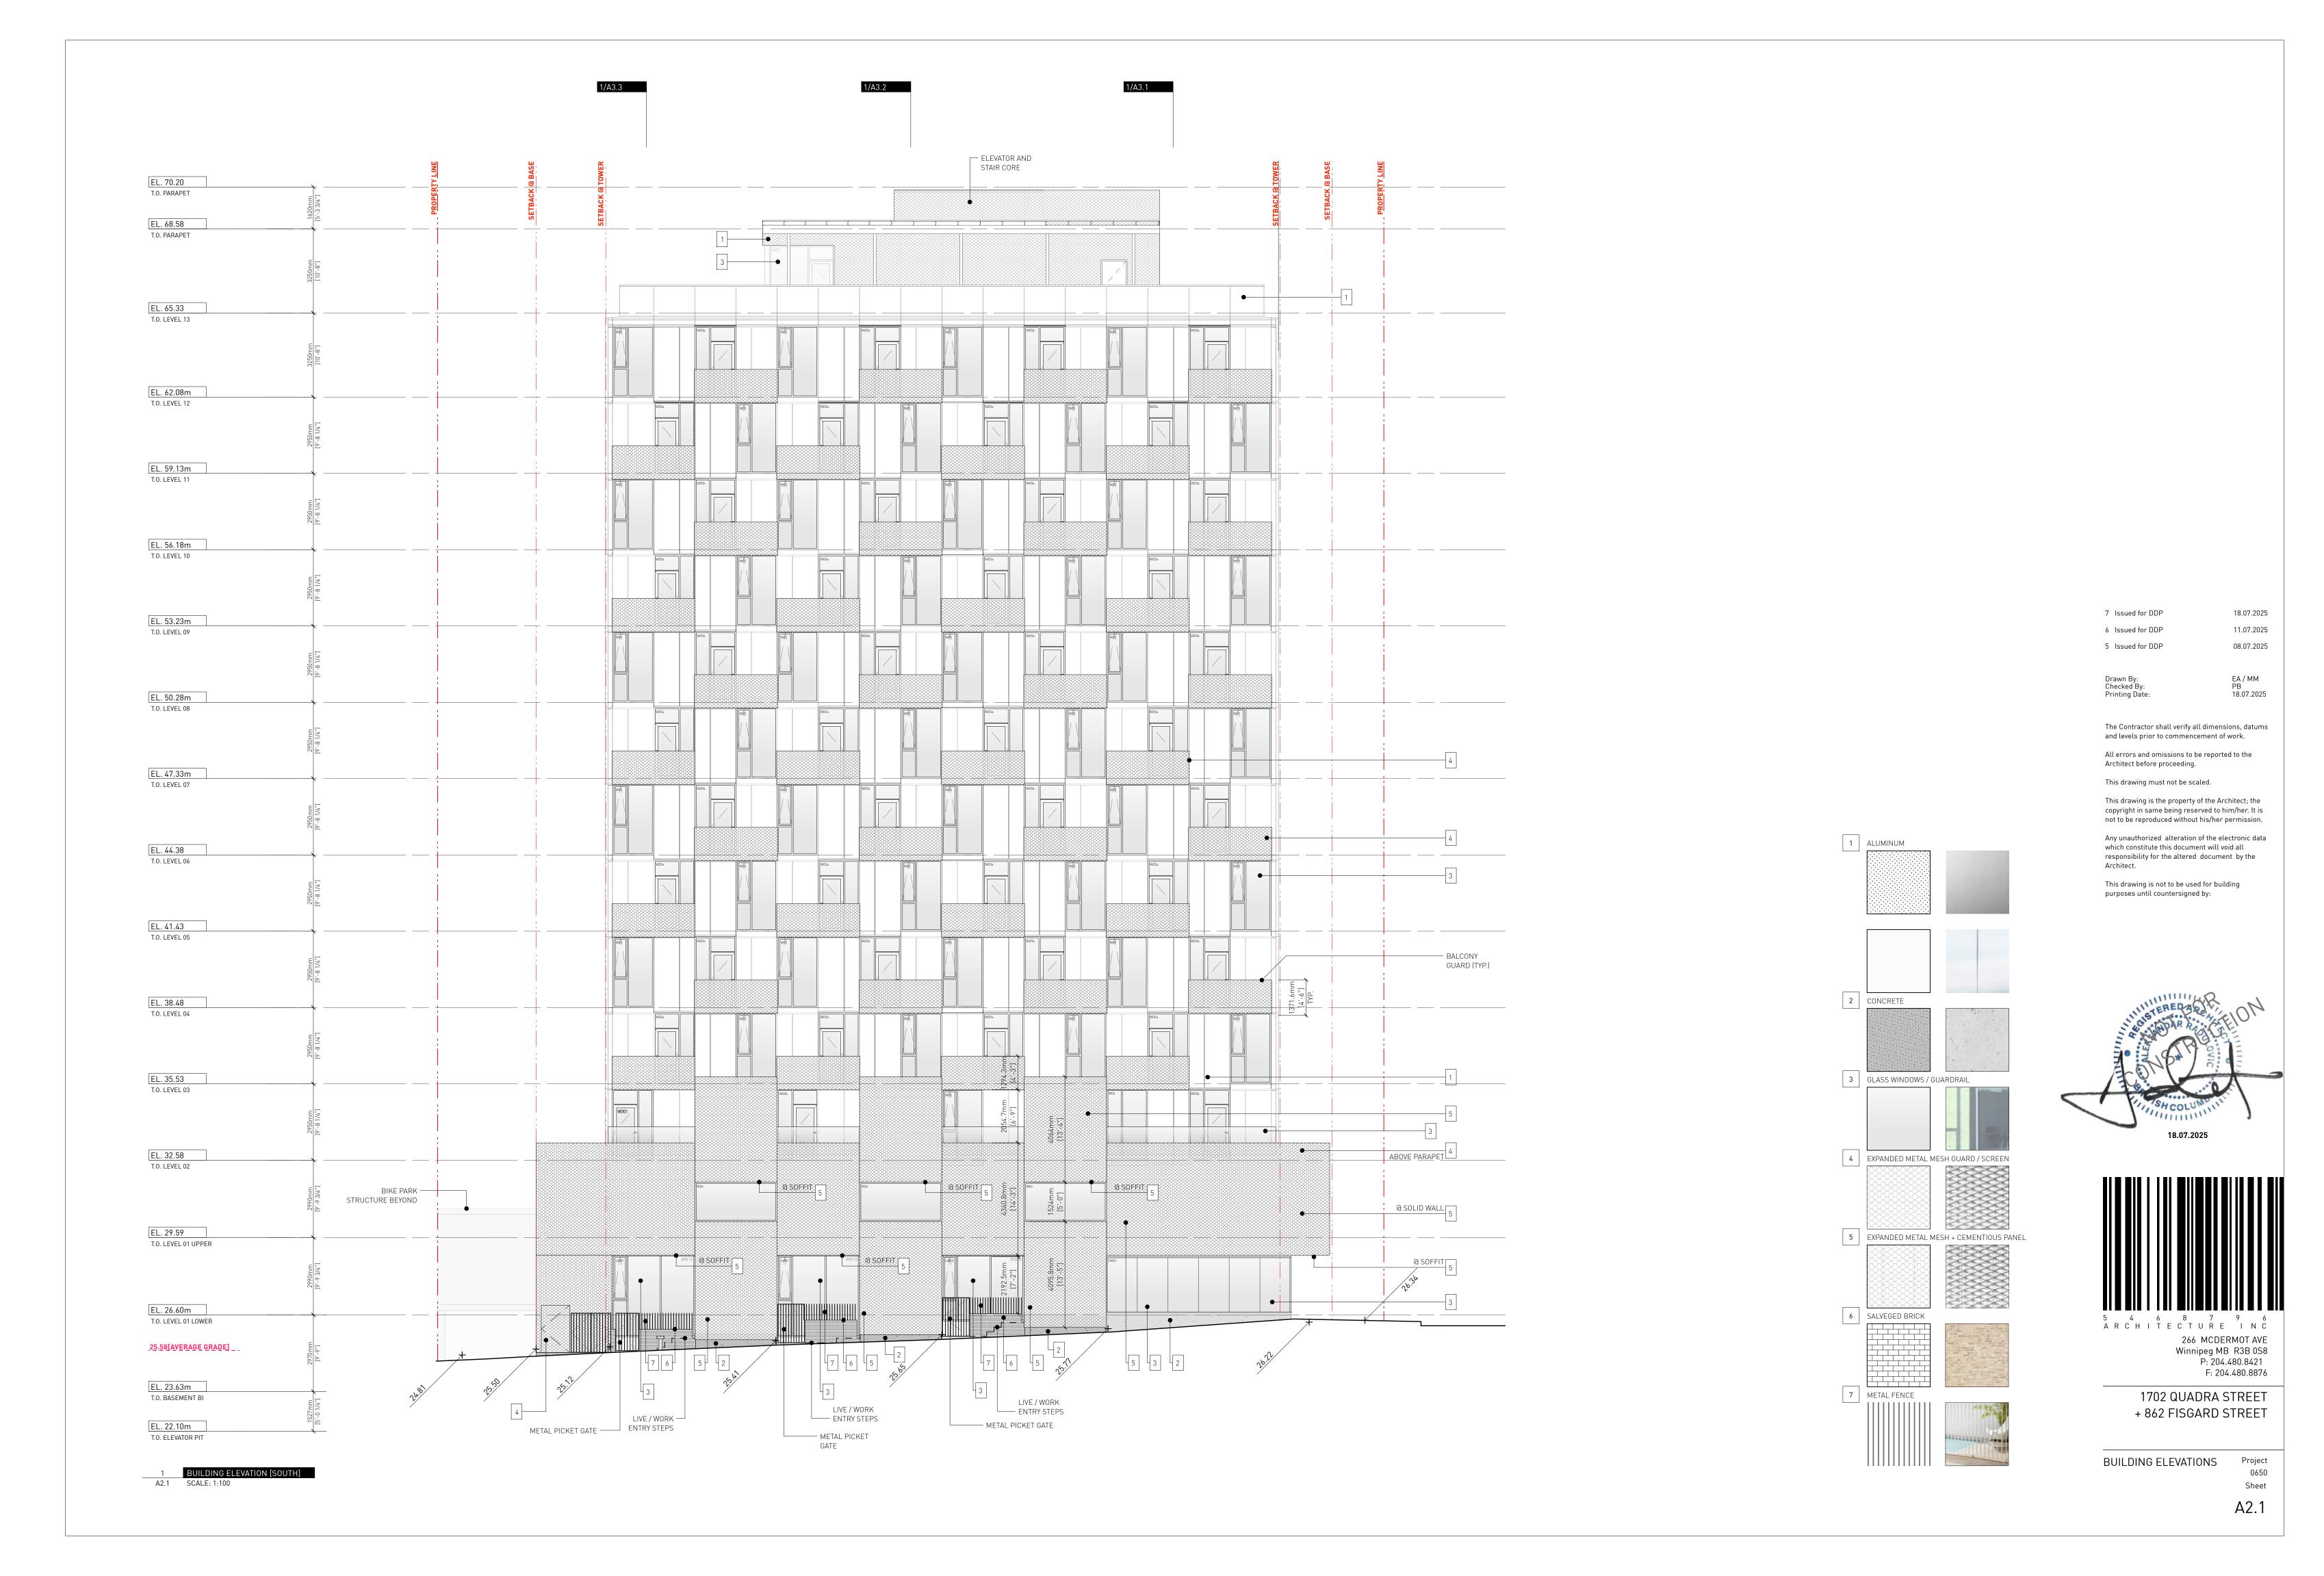



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1702 QUADRA STREET + 862 FISGARD STREET

ROOF PLAN

Project 0650 Sheet



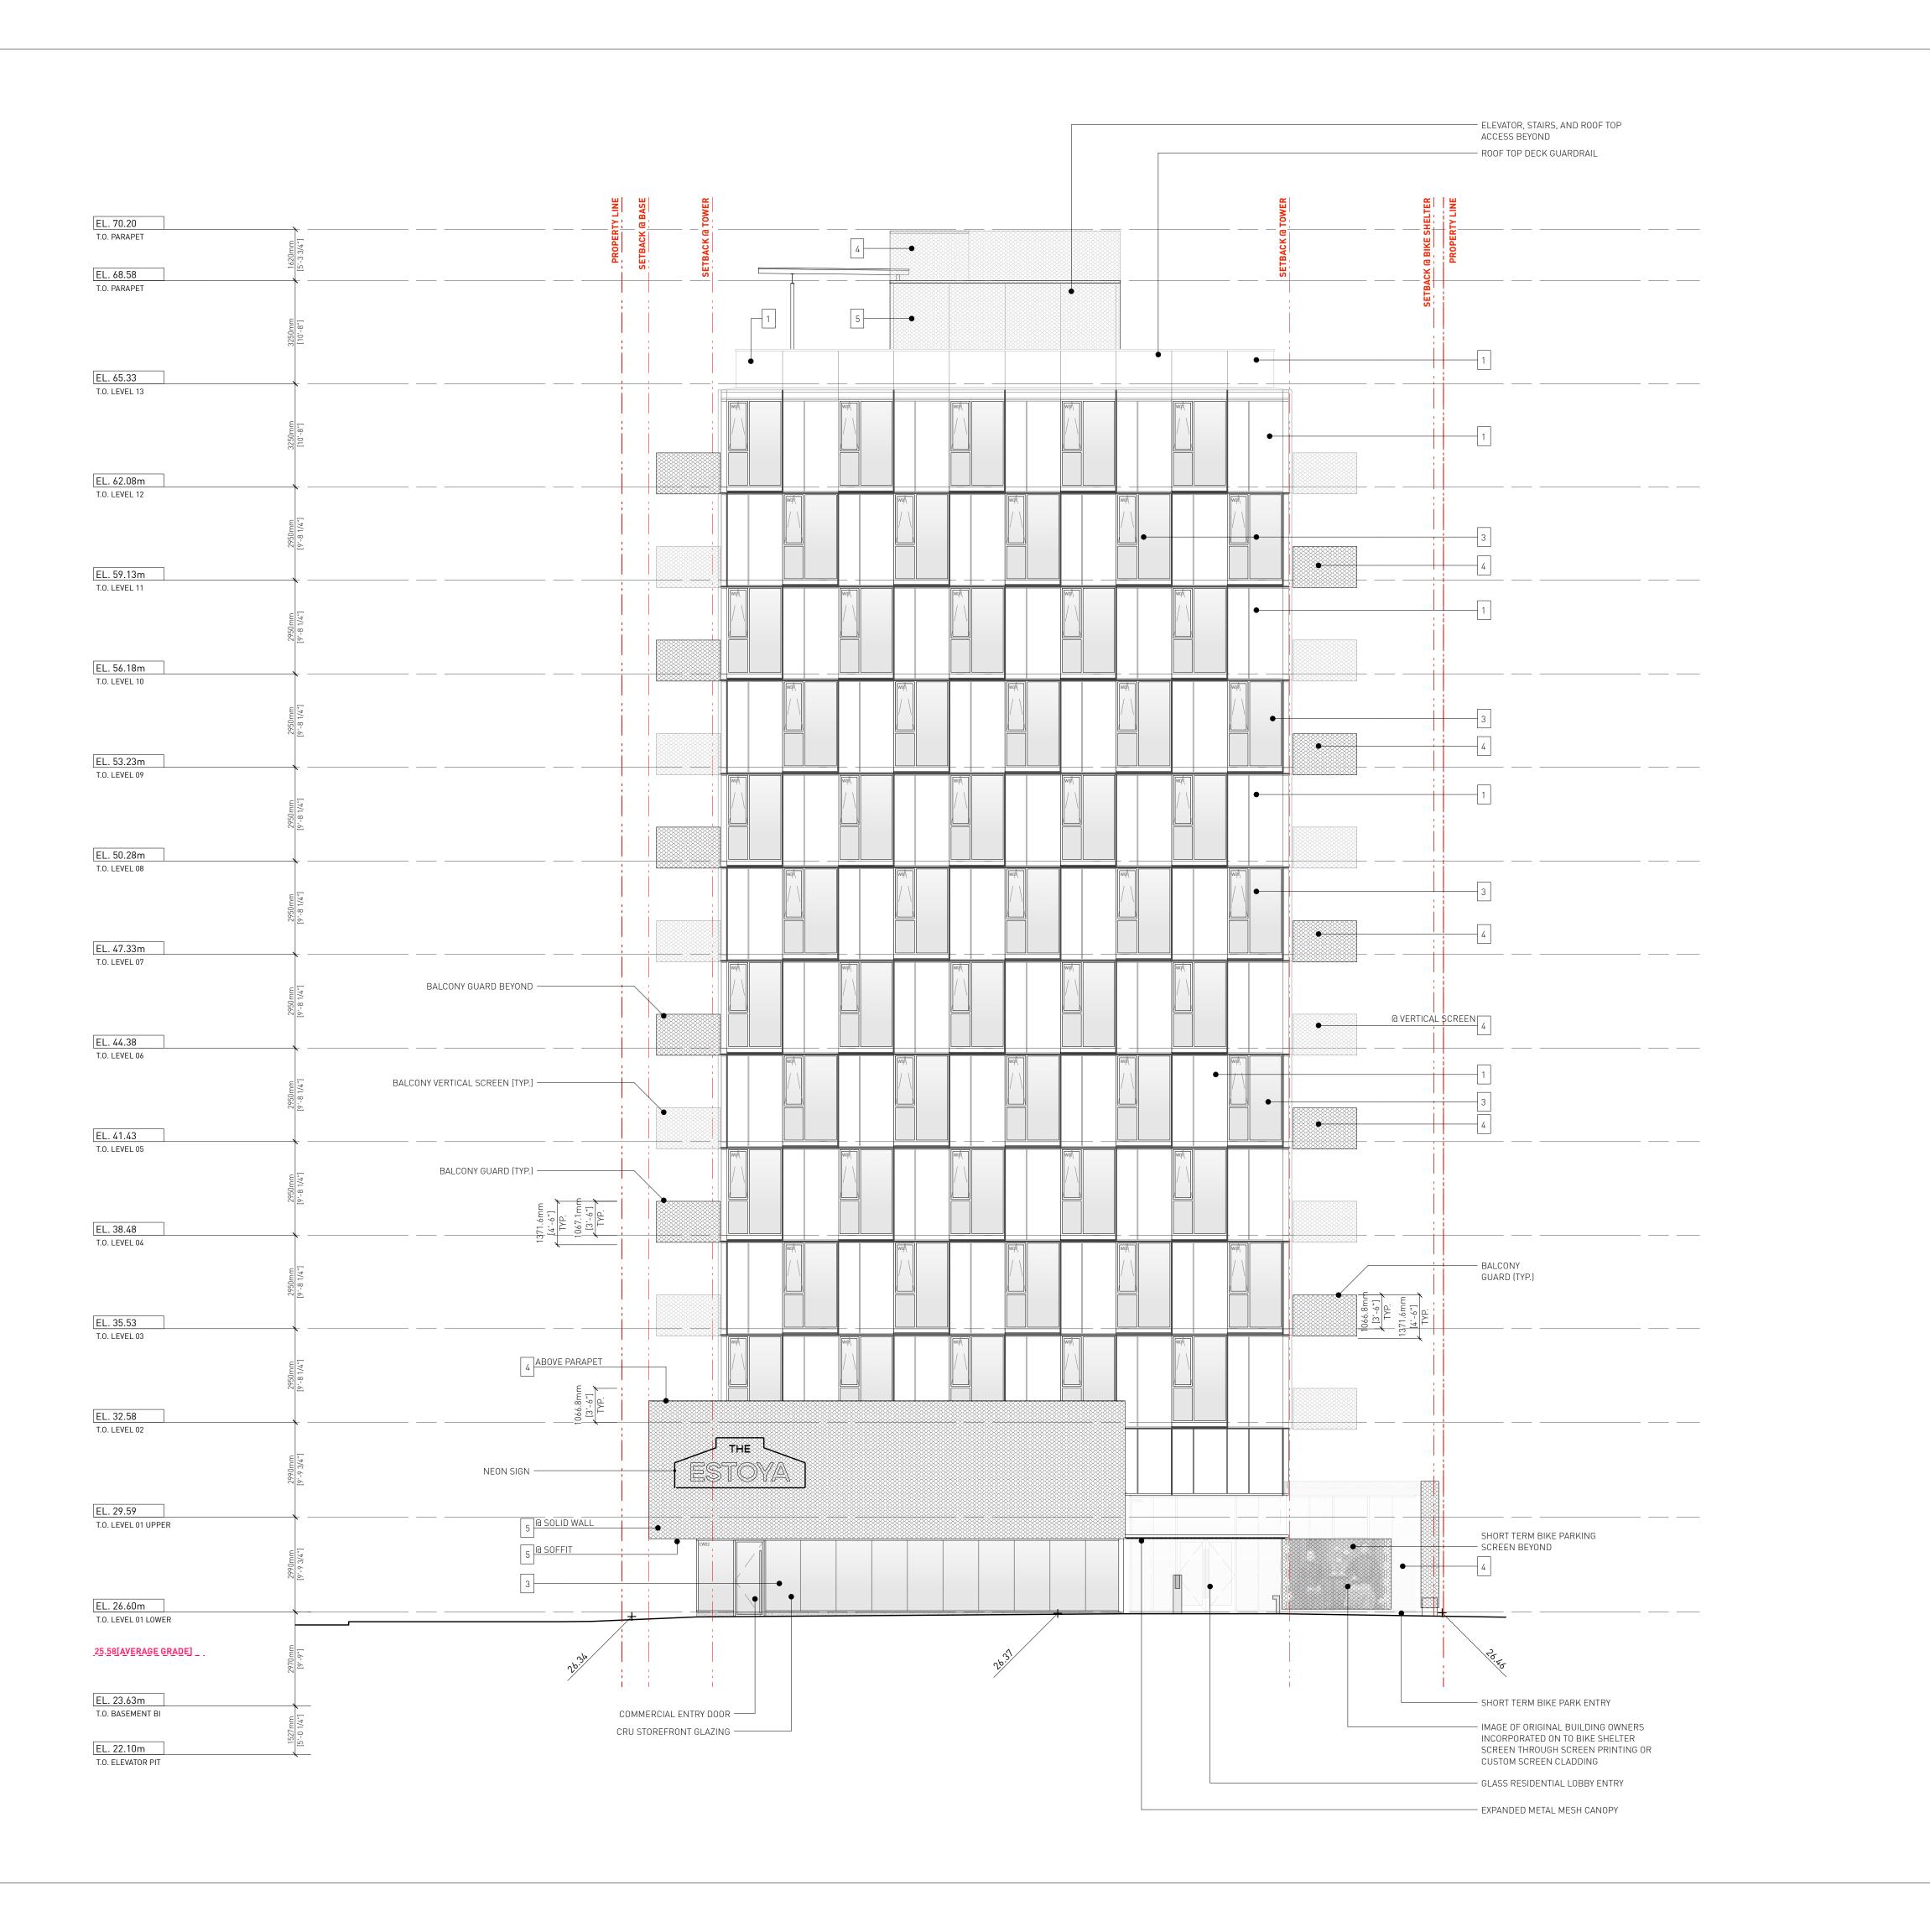

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1 ALUMINUM

2 CONCRETE

3 GLASS WINDOWS / GUARDRAIL

4 EXPANDED METAL MESH GUARD / SCREEN

5 EXPANDED METAL MESH + CEMENTIOUS PANEL


6 SALVEGED BRICK


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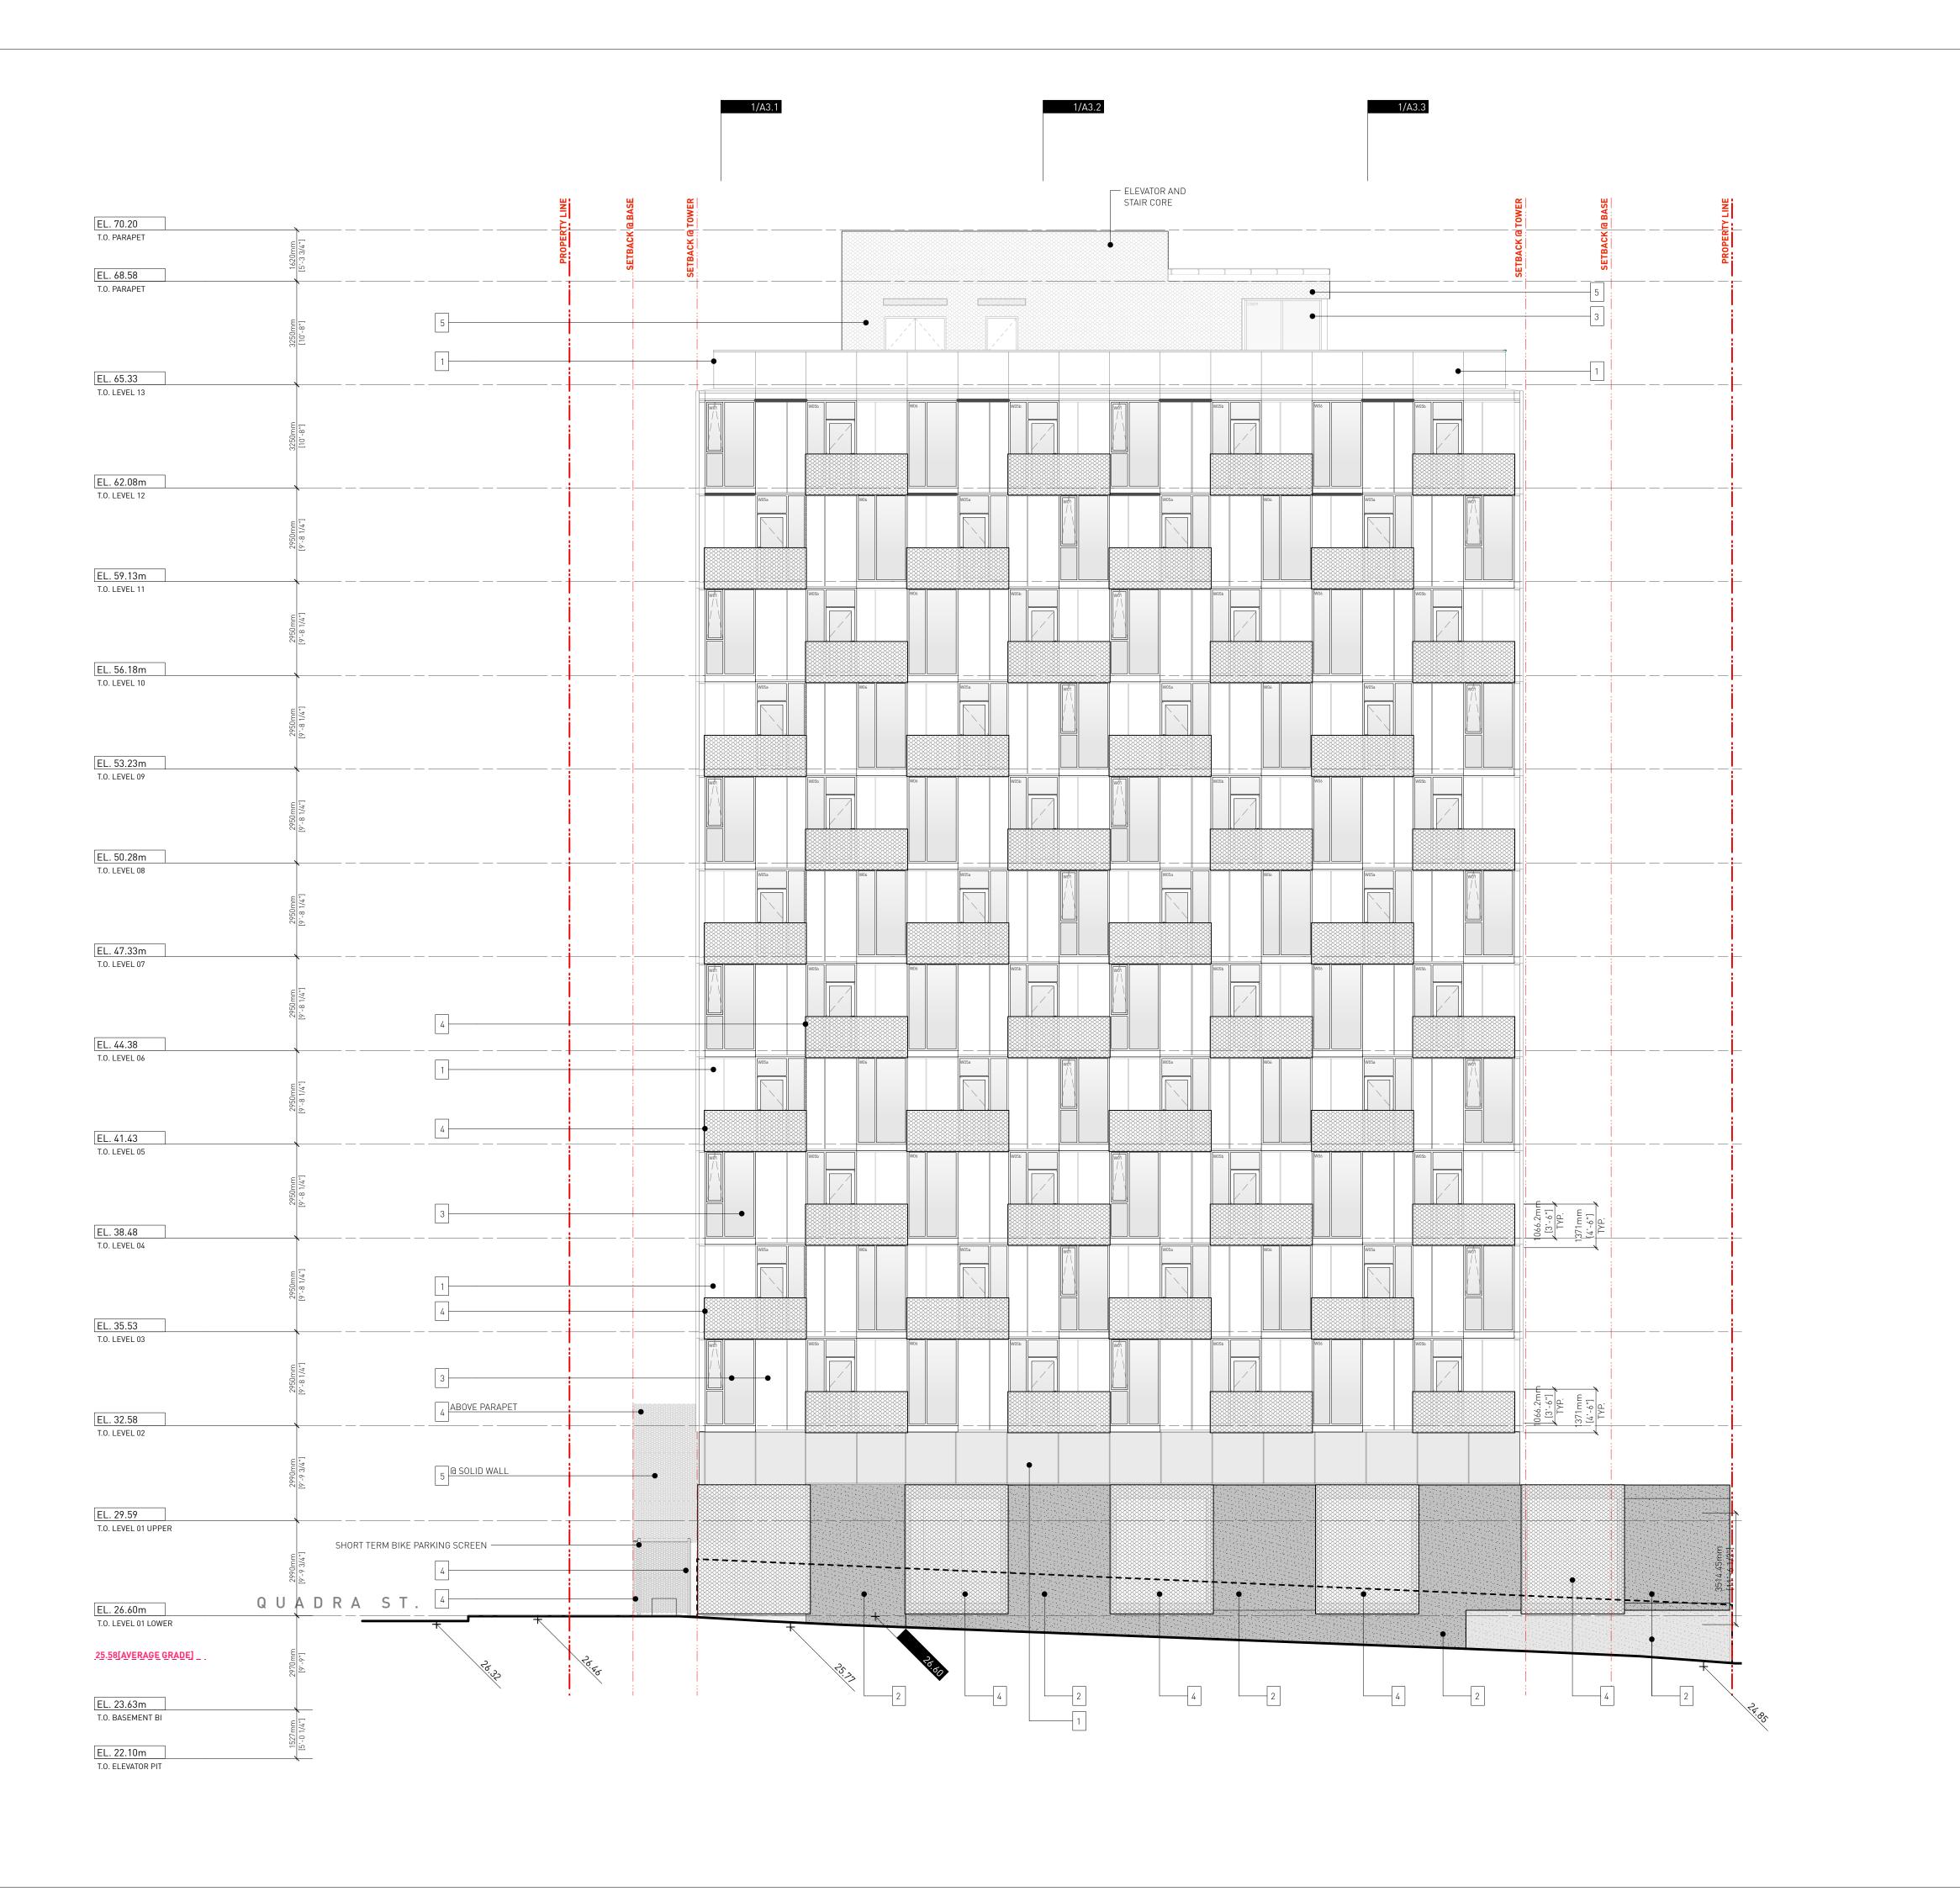
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1702 QUADRA STREET + 862 FISGARD STREET

BUILDING ELEVATIONS

Sheet

A2.2

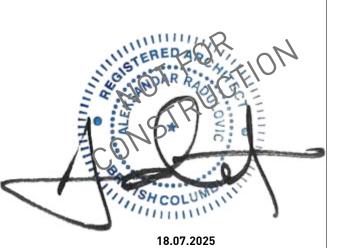

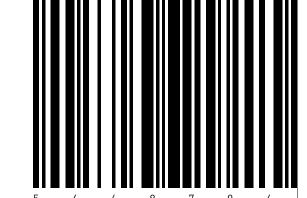EA / MM

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1 ALUMINUM

2 CONCRETE

3 GLASS WINDOWS / GUARDRAIL

4 EXPANDED METAL MESH GUARD / SCREEN

5 EXPANDED METAL MESH + CEMENTIOUS PANEL

6 SALVEGED BRICK

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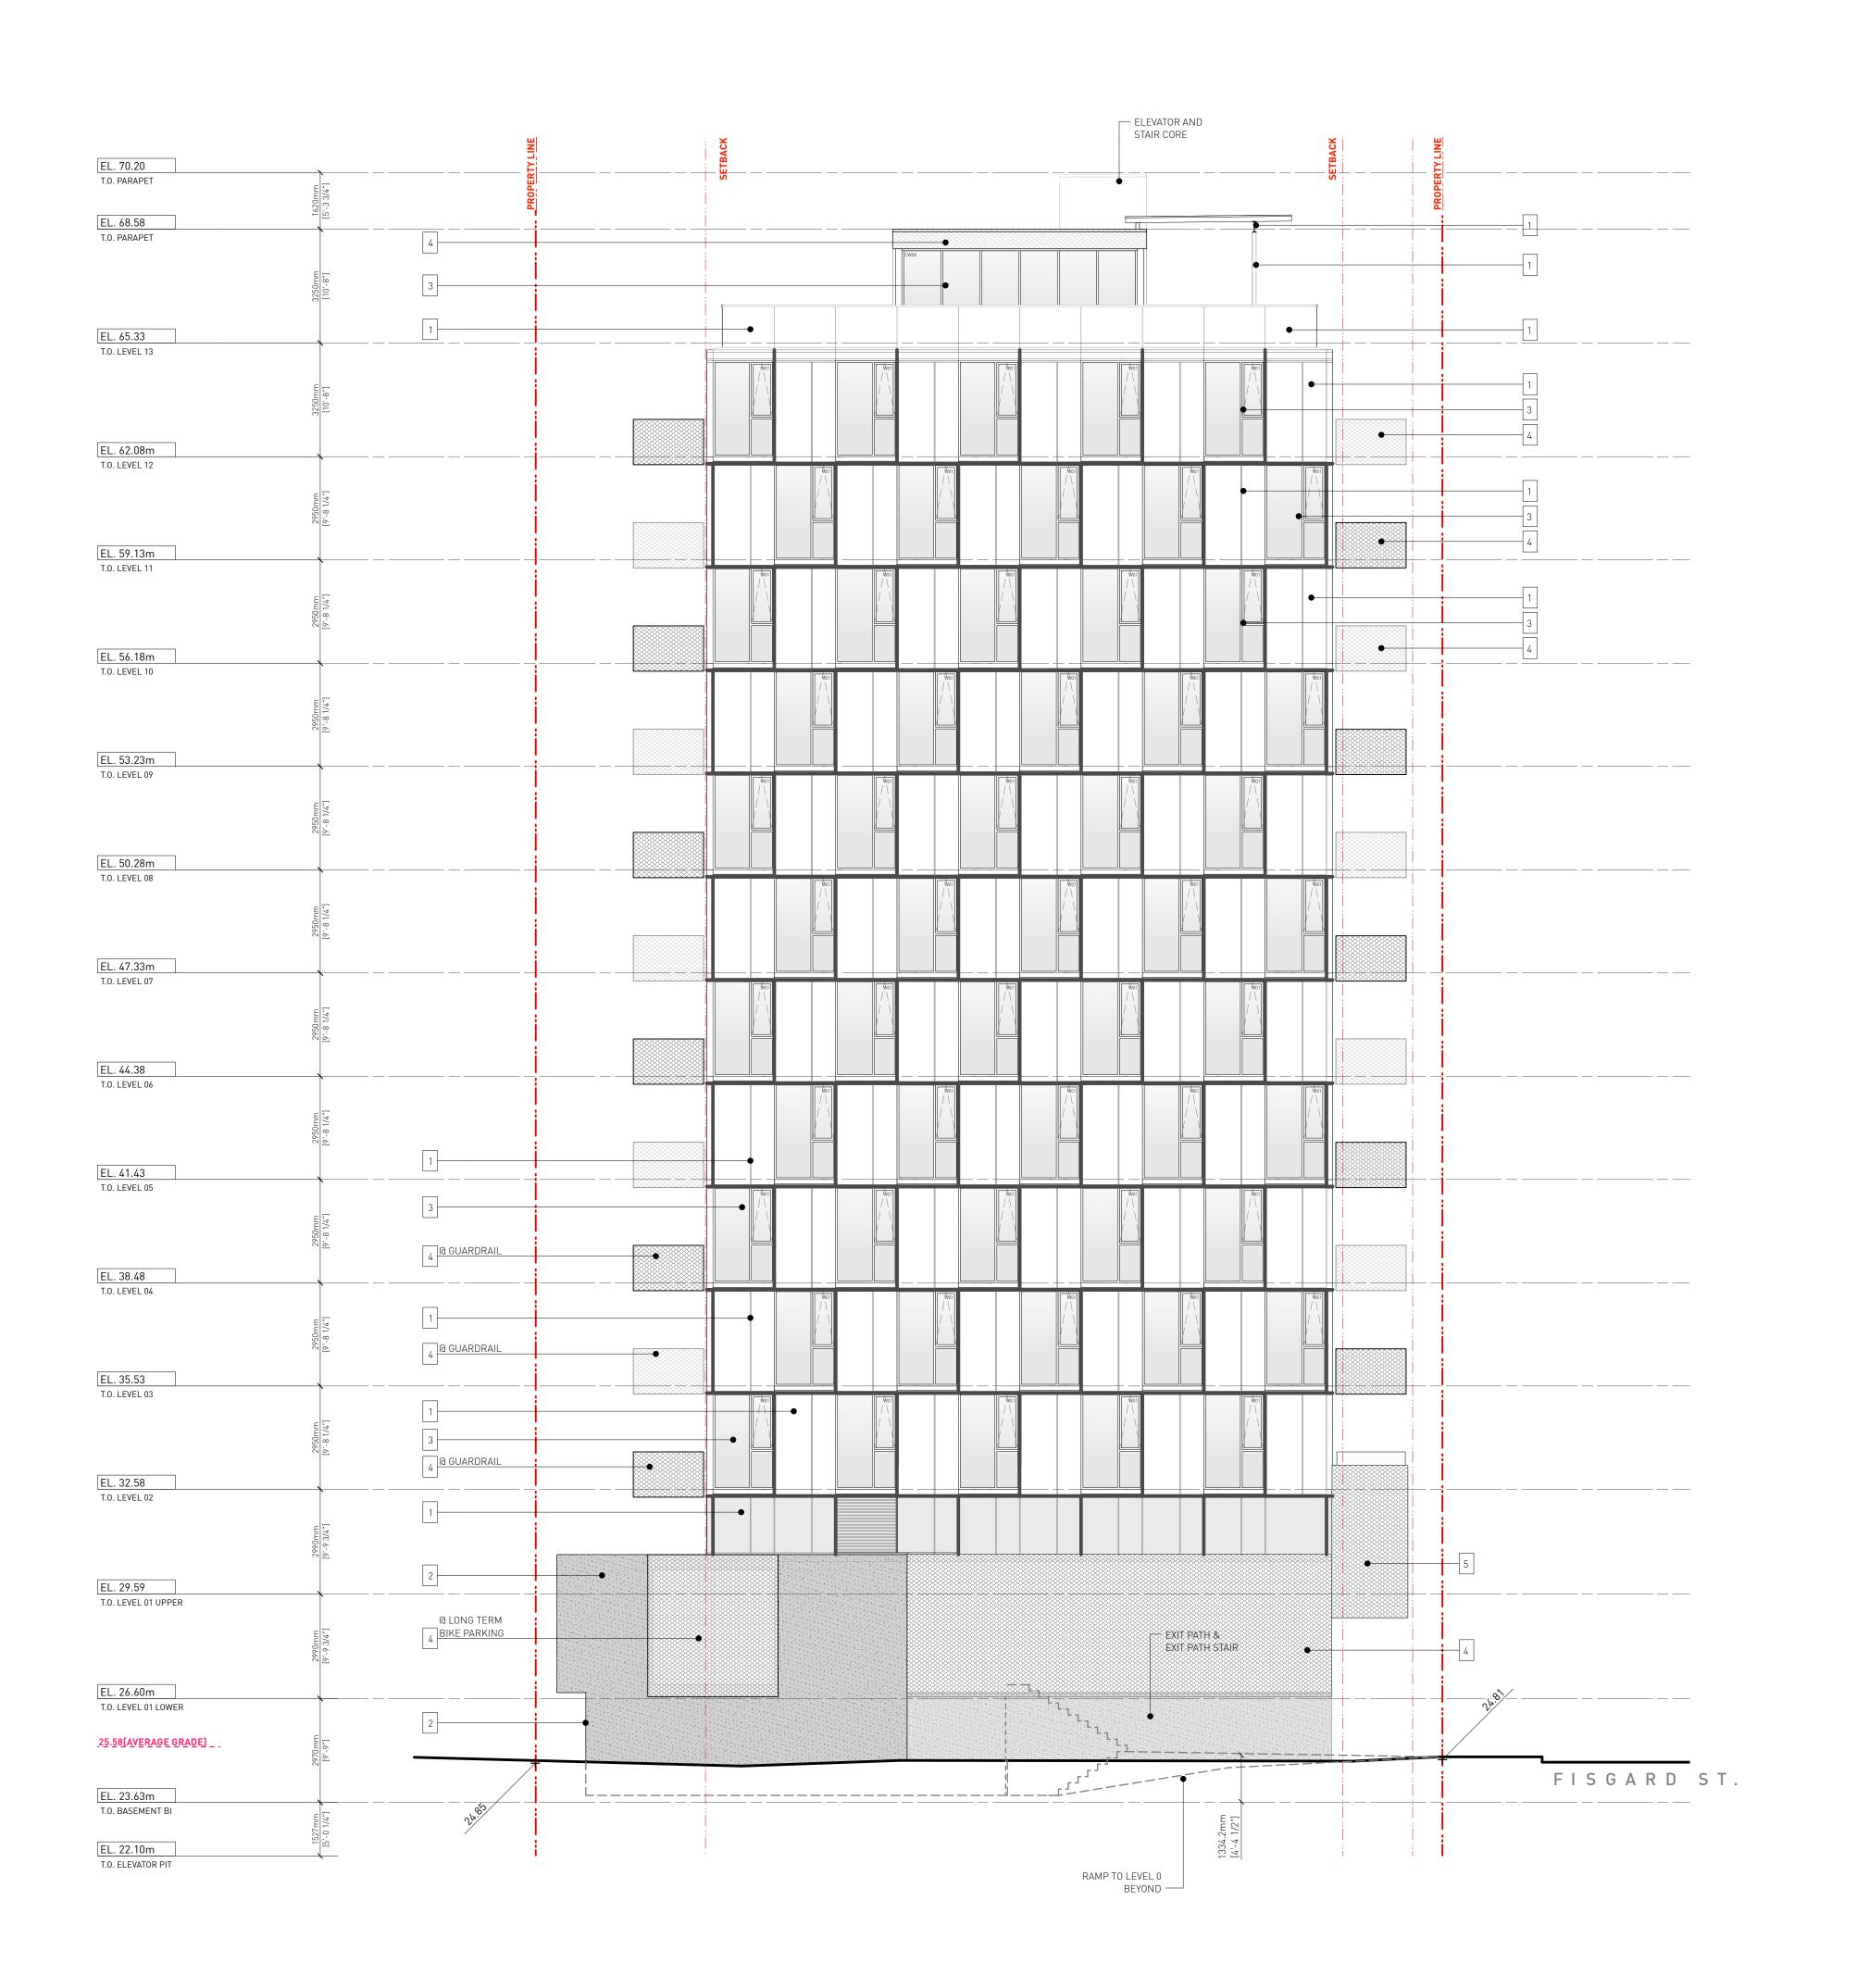


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1702 QUADRA STREET + 862 FISGARD STREET

BUILDING ELEVATIONS

Sheet A2.3



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1 ALUMINUM

2 CONCRETE

3 GLASS WINDOWS / GUARDRAIL

4 EXPANDED METAL MESH GUARD / SCREEN

5 EXPANDED METAL MESH + CEMENTIOUS PANEL


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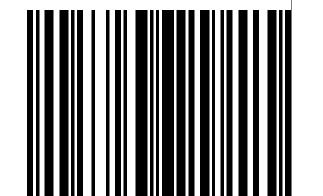
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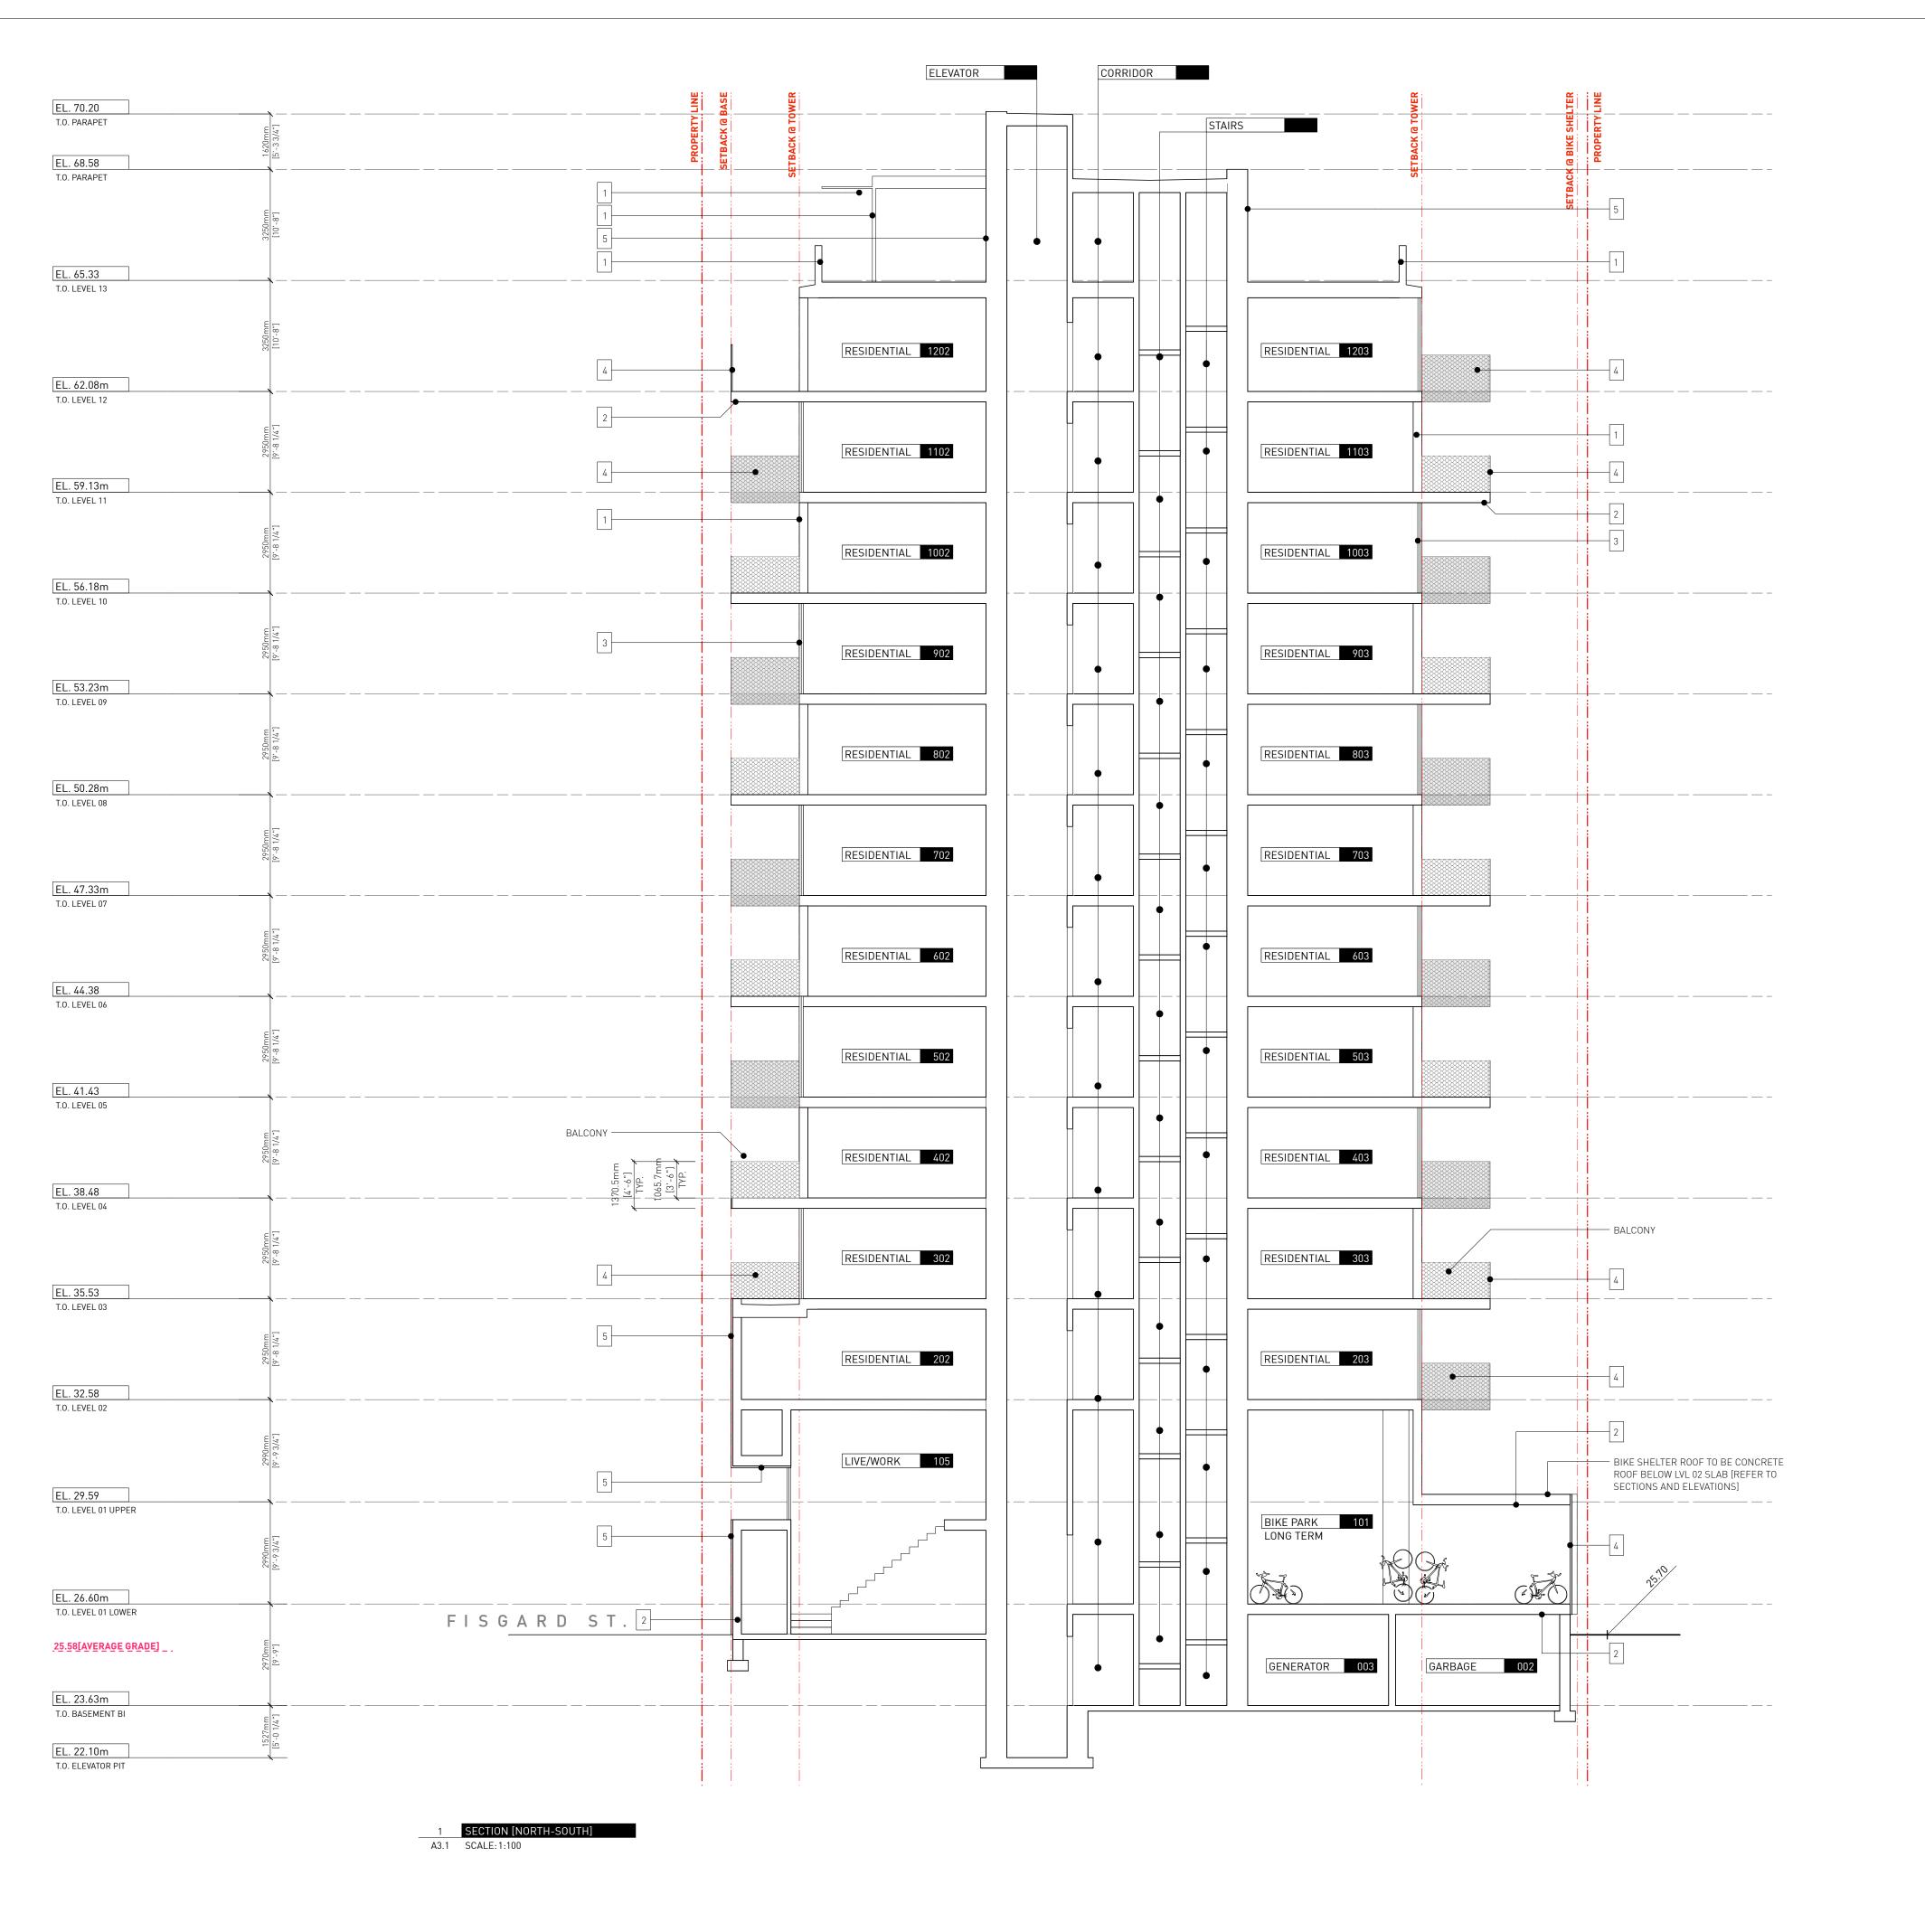



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1702 QUADRA STREET + 862 FISGARD STREET

BUILDING ELEVATIONS

Sheet A2.4



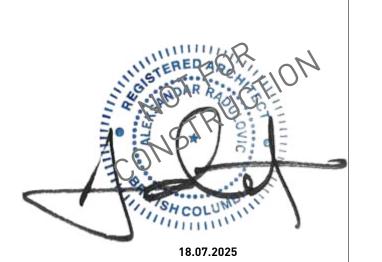
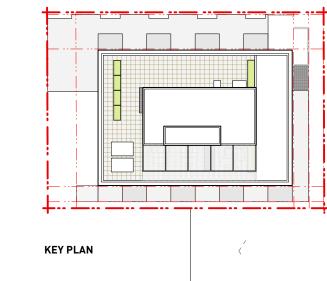
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Printing Date:
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1 ALUMINUM

2 CONCRETE

3 GLASS WINDOWS / GUARDRAIL

4 EXPANDED METAL MESH GUARD / SCREEN

5 EXPANDED METAL MESH + CEMENTIOUS PANEL


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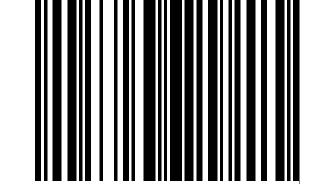
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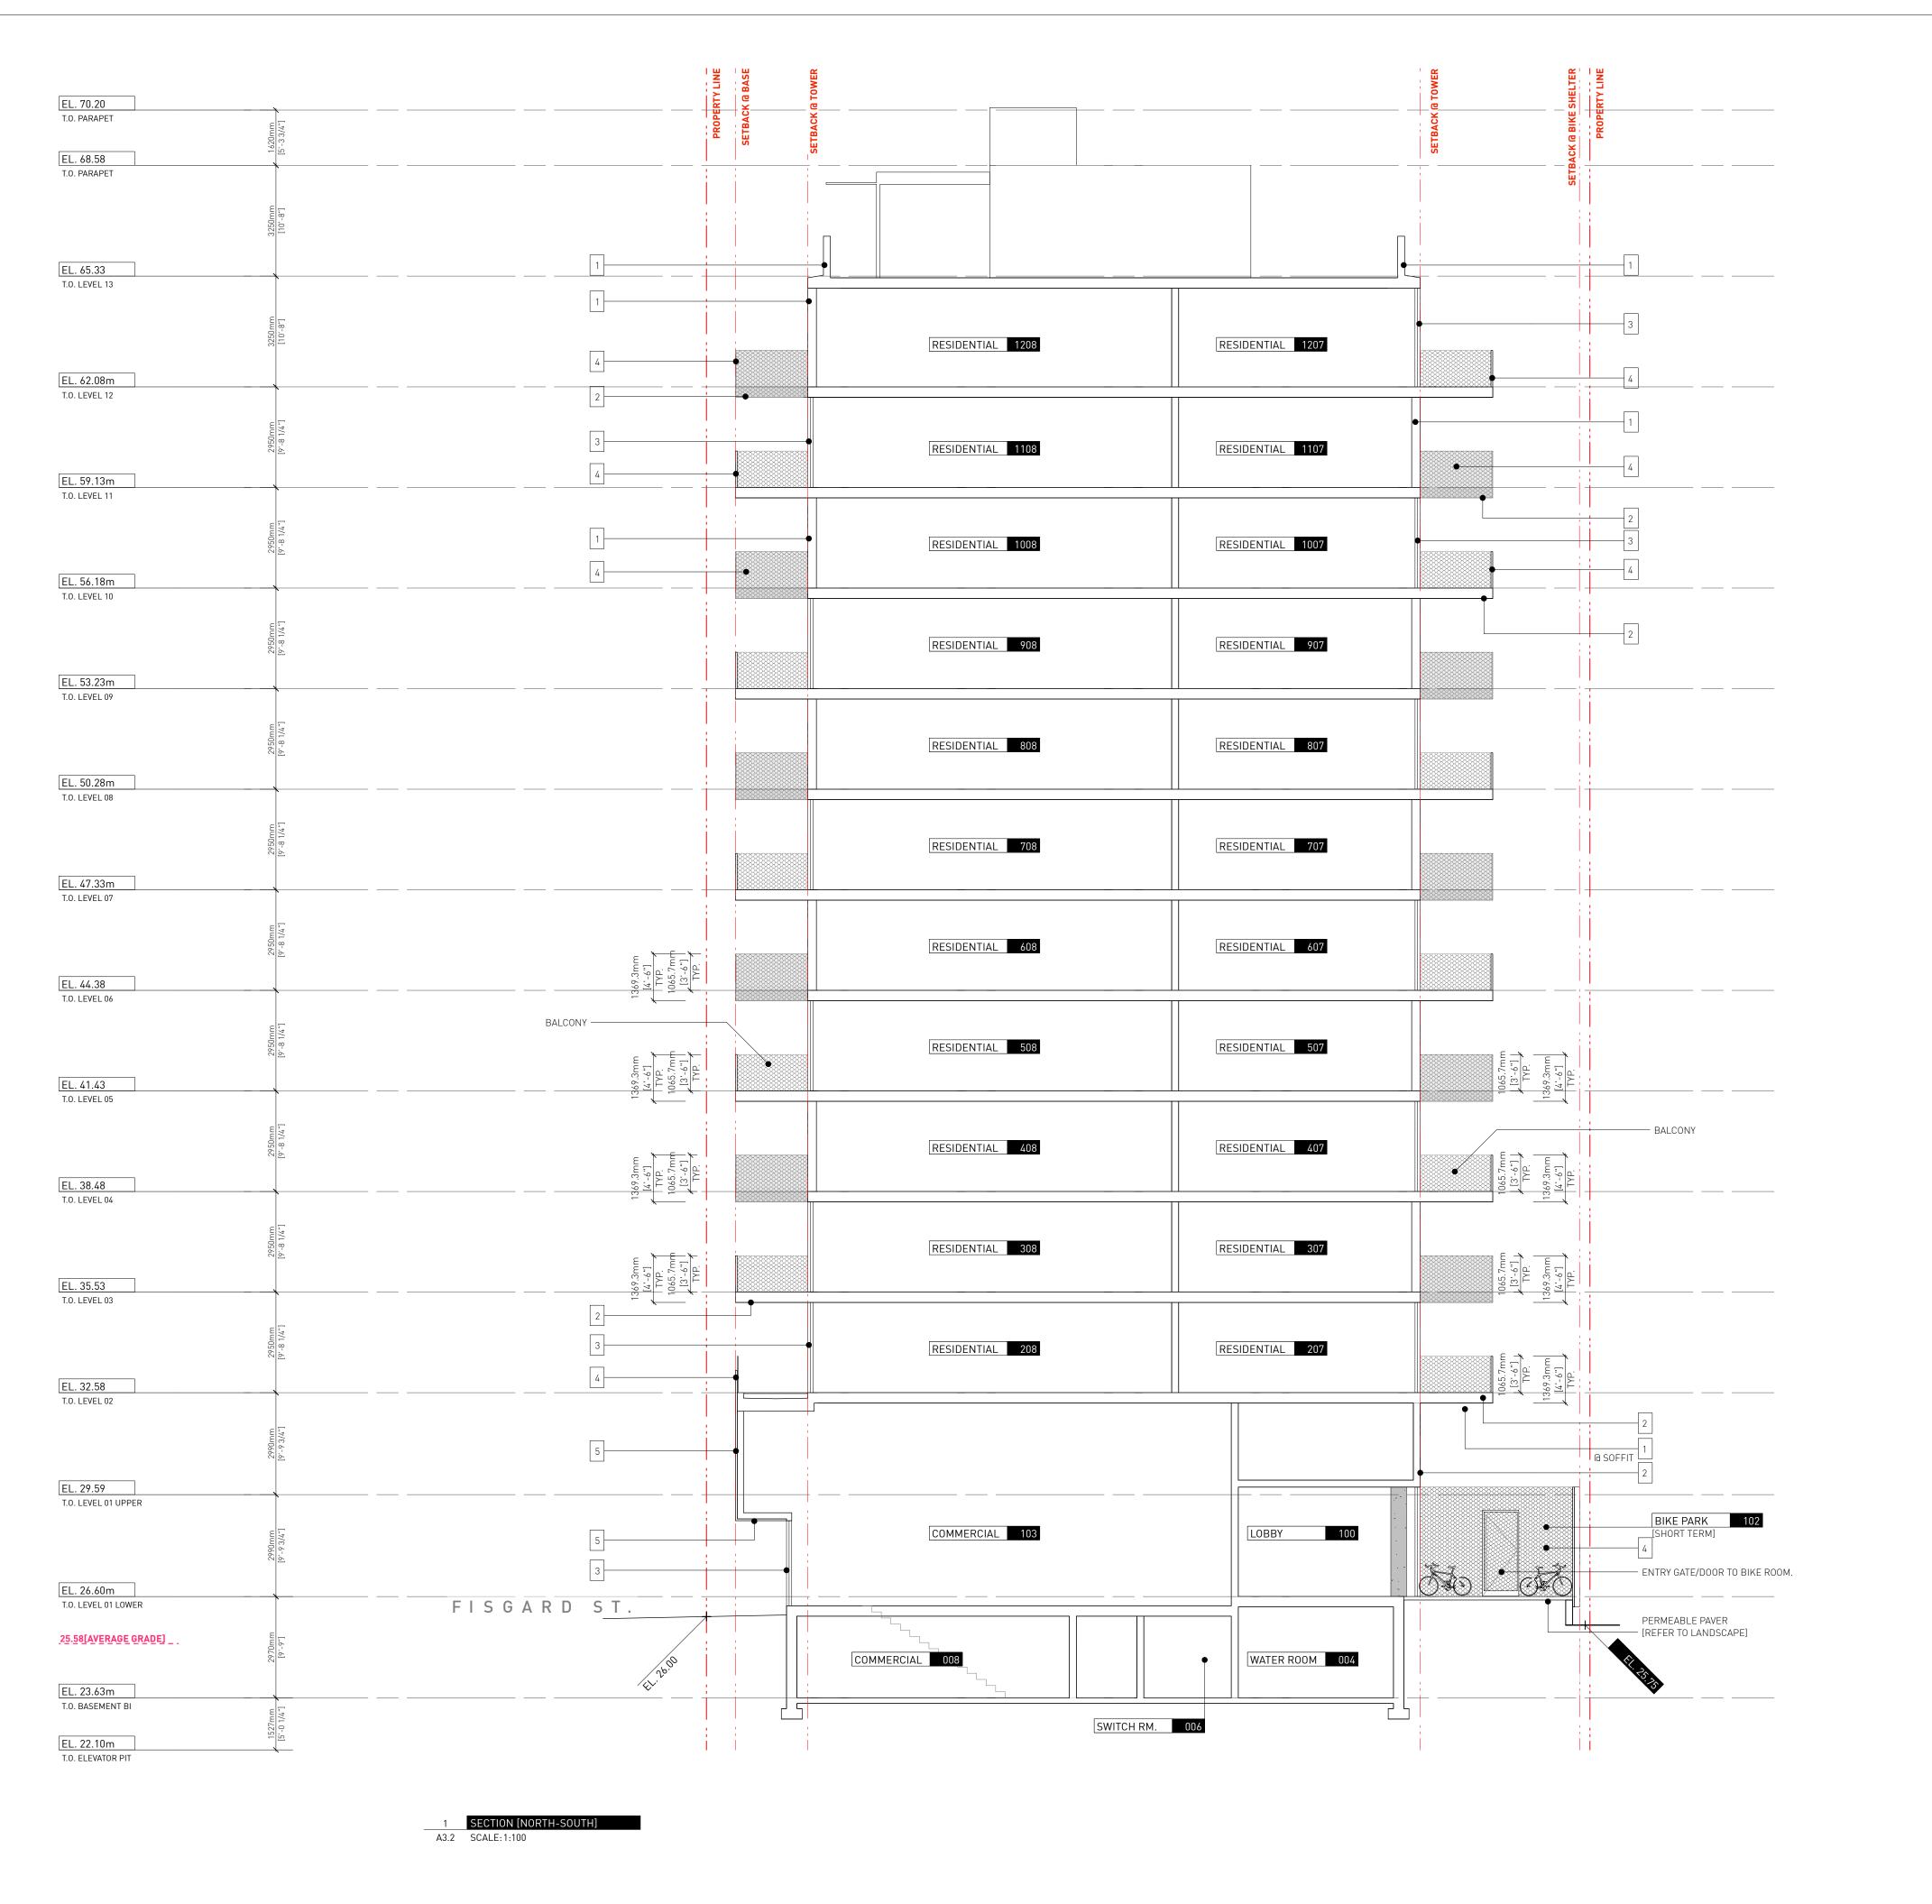



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1702 QUADRA STREET + 862 FISGARD STREET

BUILDING SECTION

Project 0650 Sheet



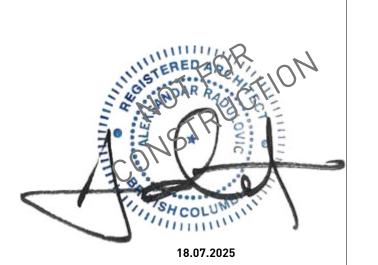
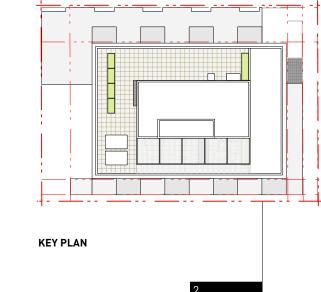
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1 ALUMINUM

2 CONCRETE

3 GLASS WINDOWS / GUARDRAIL

4 EXPANDED METAL MESH GUARD / SCREEN

5 EXPANDED METAL MESH + CEMENTIOUS PANEL


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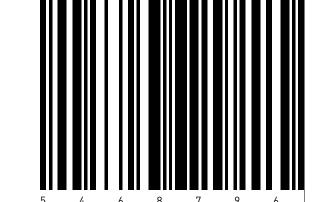
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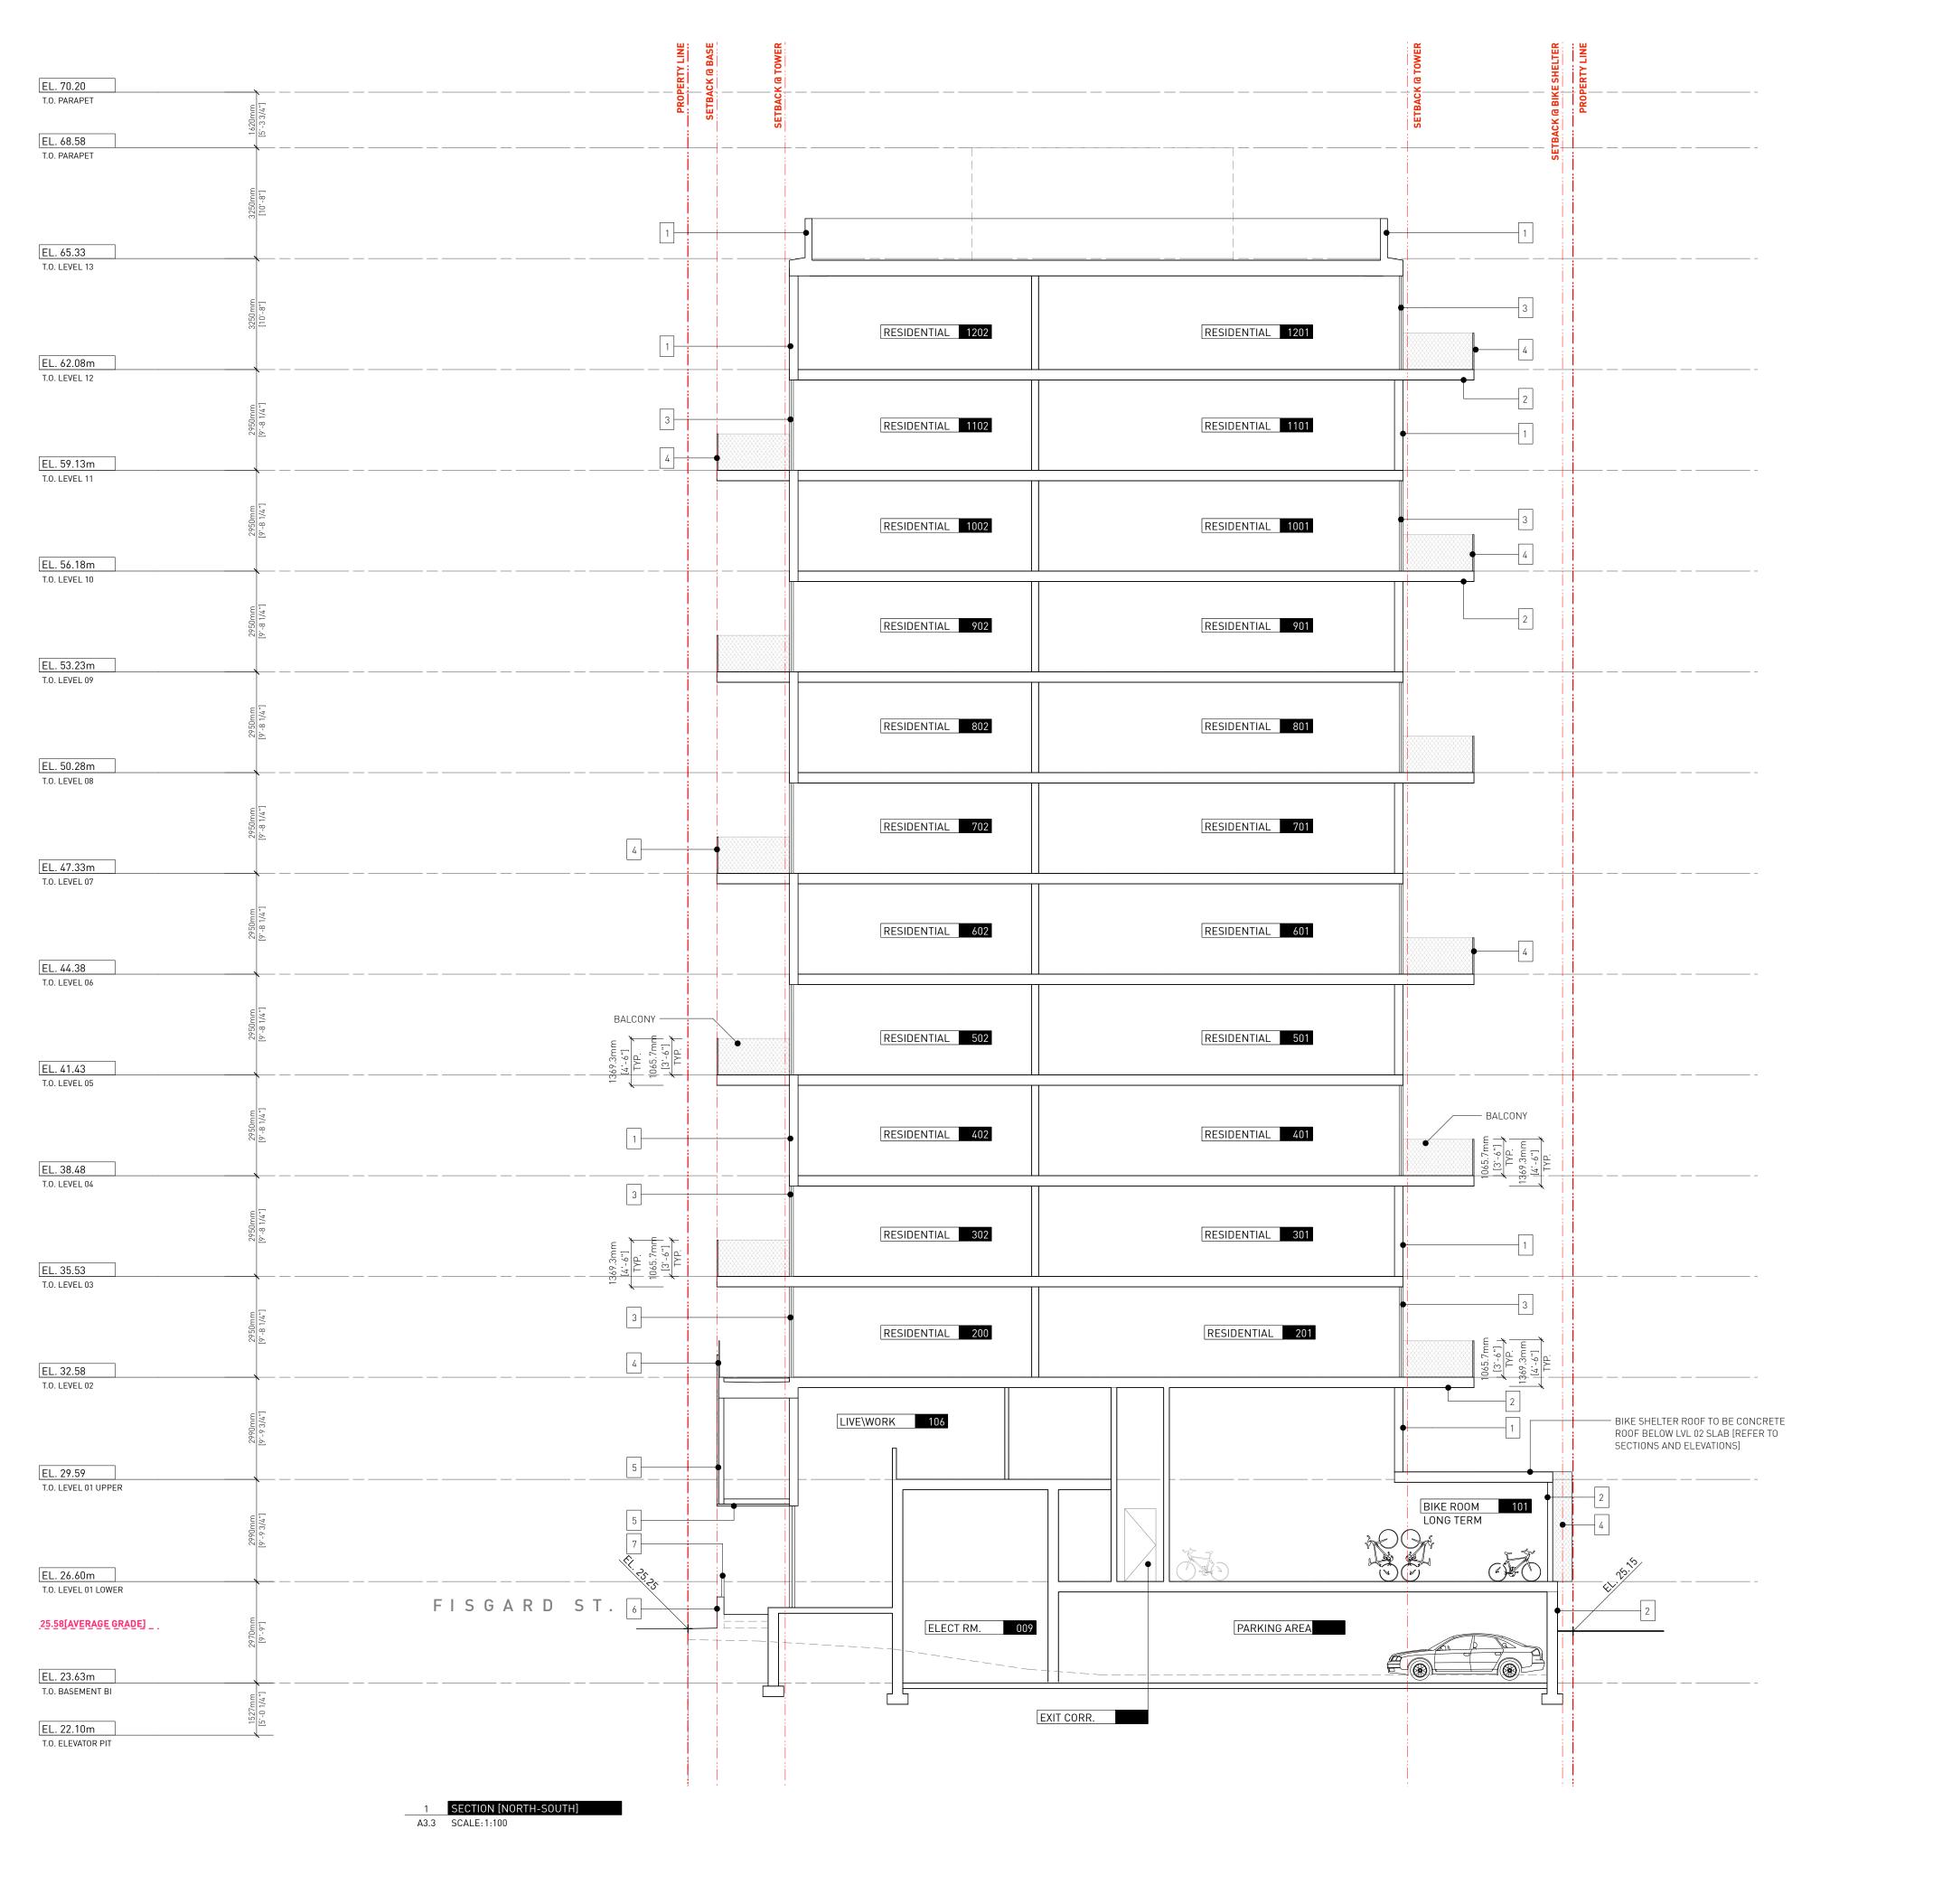
266 MCDERMOT AVE Winnipeg MB R3B 0S8 P: 204.480.8421 F: 204.480.8876


1702 QUADRA STREET + 862 FISGARD STREET

BUILDING SECTION

Project 0650 Sheet

A3.2

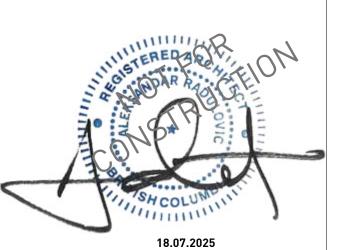

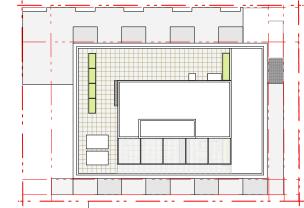

KEY PLAN

7 Issued for DDP 18.07.2025 6 Issued for DDP 11.07.2025

5 Issued for DDP

Drawn By:
Checked By:
Printing Date:
PB
18.07.2025

08.07.2025

The Contractor shall verify all dimensions, datums and levels prior to commencement of work.

All errors and omissions to be reported to the

Architect before proceeding.

This drawing must not be scaled.

This drawing is the property of the Architect; the

1 ALUMINUM

2 CONCRETE

3 GLASS WINDOWS / GUARDRAIL

4 EXPANDED METAL MESH GUARD / SCREEN

5 EXPANDED METAL MESH + CEMENTIOUS PANEL

6 SALVEGED BRICK

7 METAL FENCE


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18.07.2025



A R C H I T E C T U R E I N C

266 MCDERMOT AVE

Winnipeg MB R3B 0S8

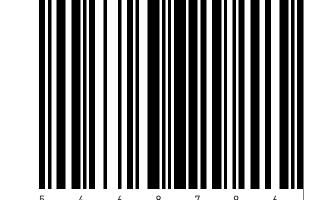
P: 204.480.8421


F: 204.480.8876

1702 QUADRA STREET + 862 FISGARD STREET

BUILDING SECTION

0650 Sheet

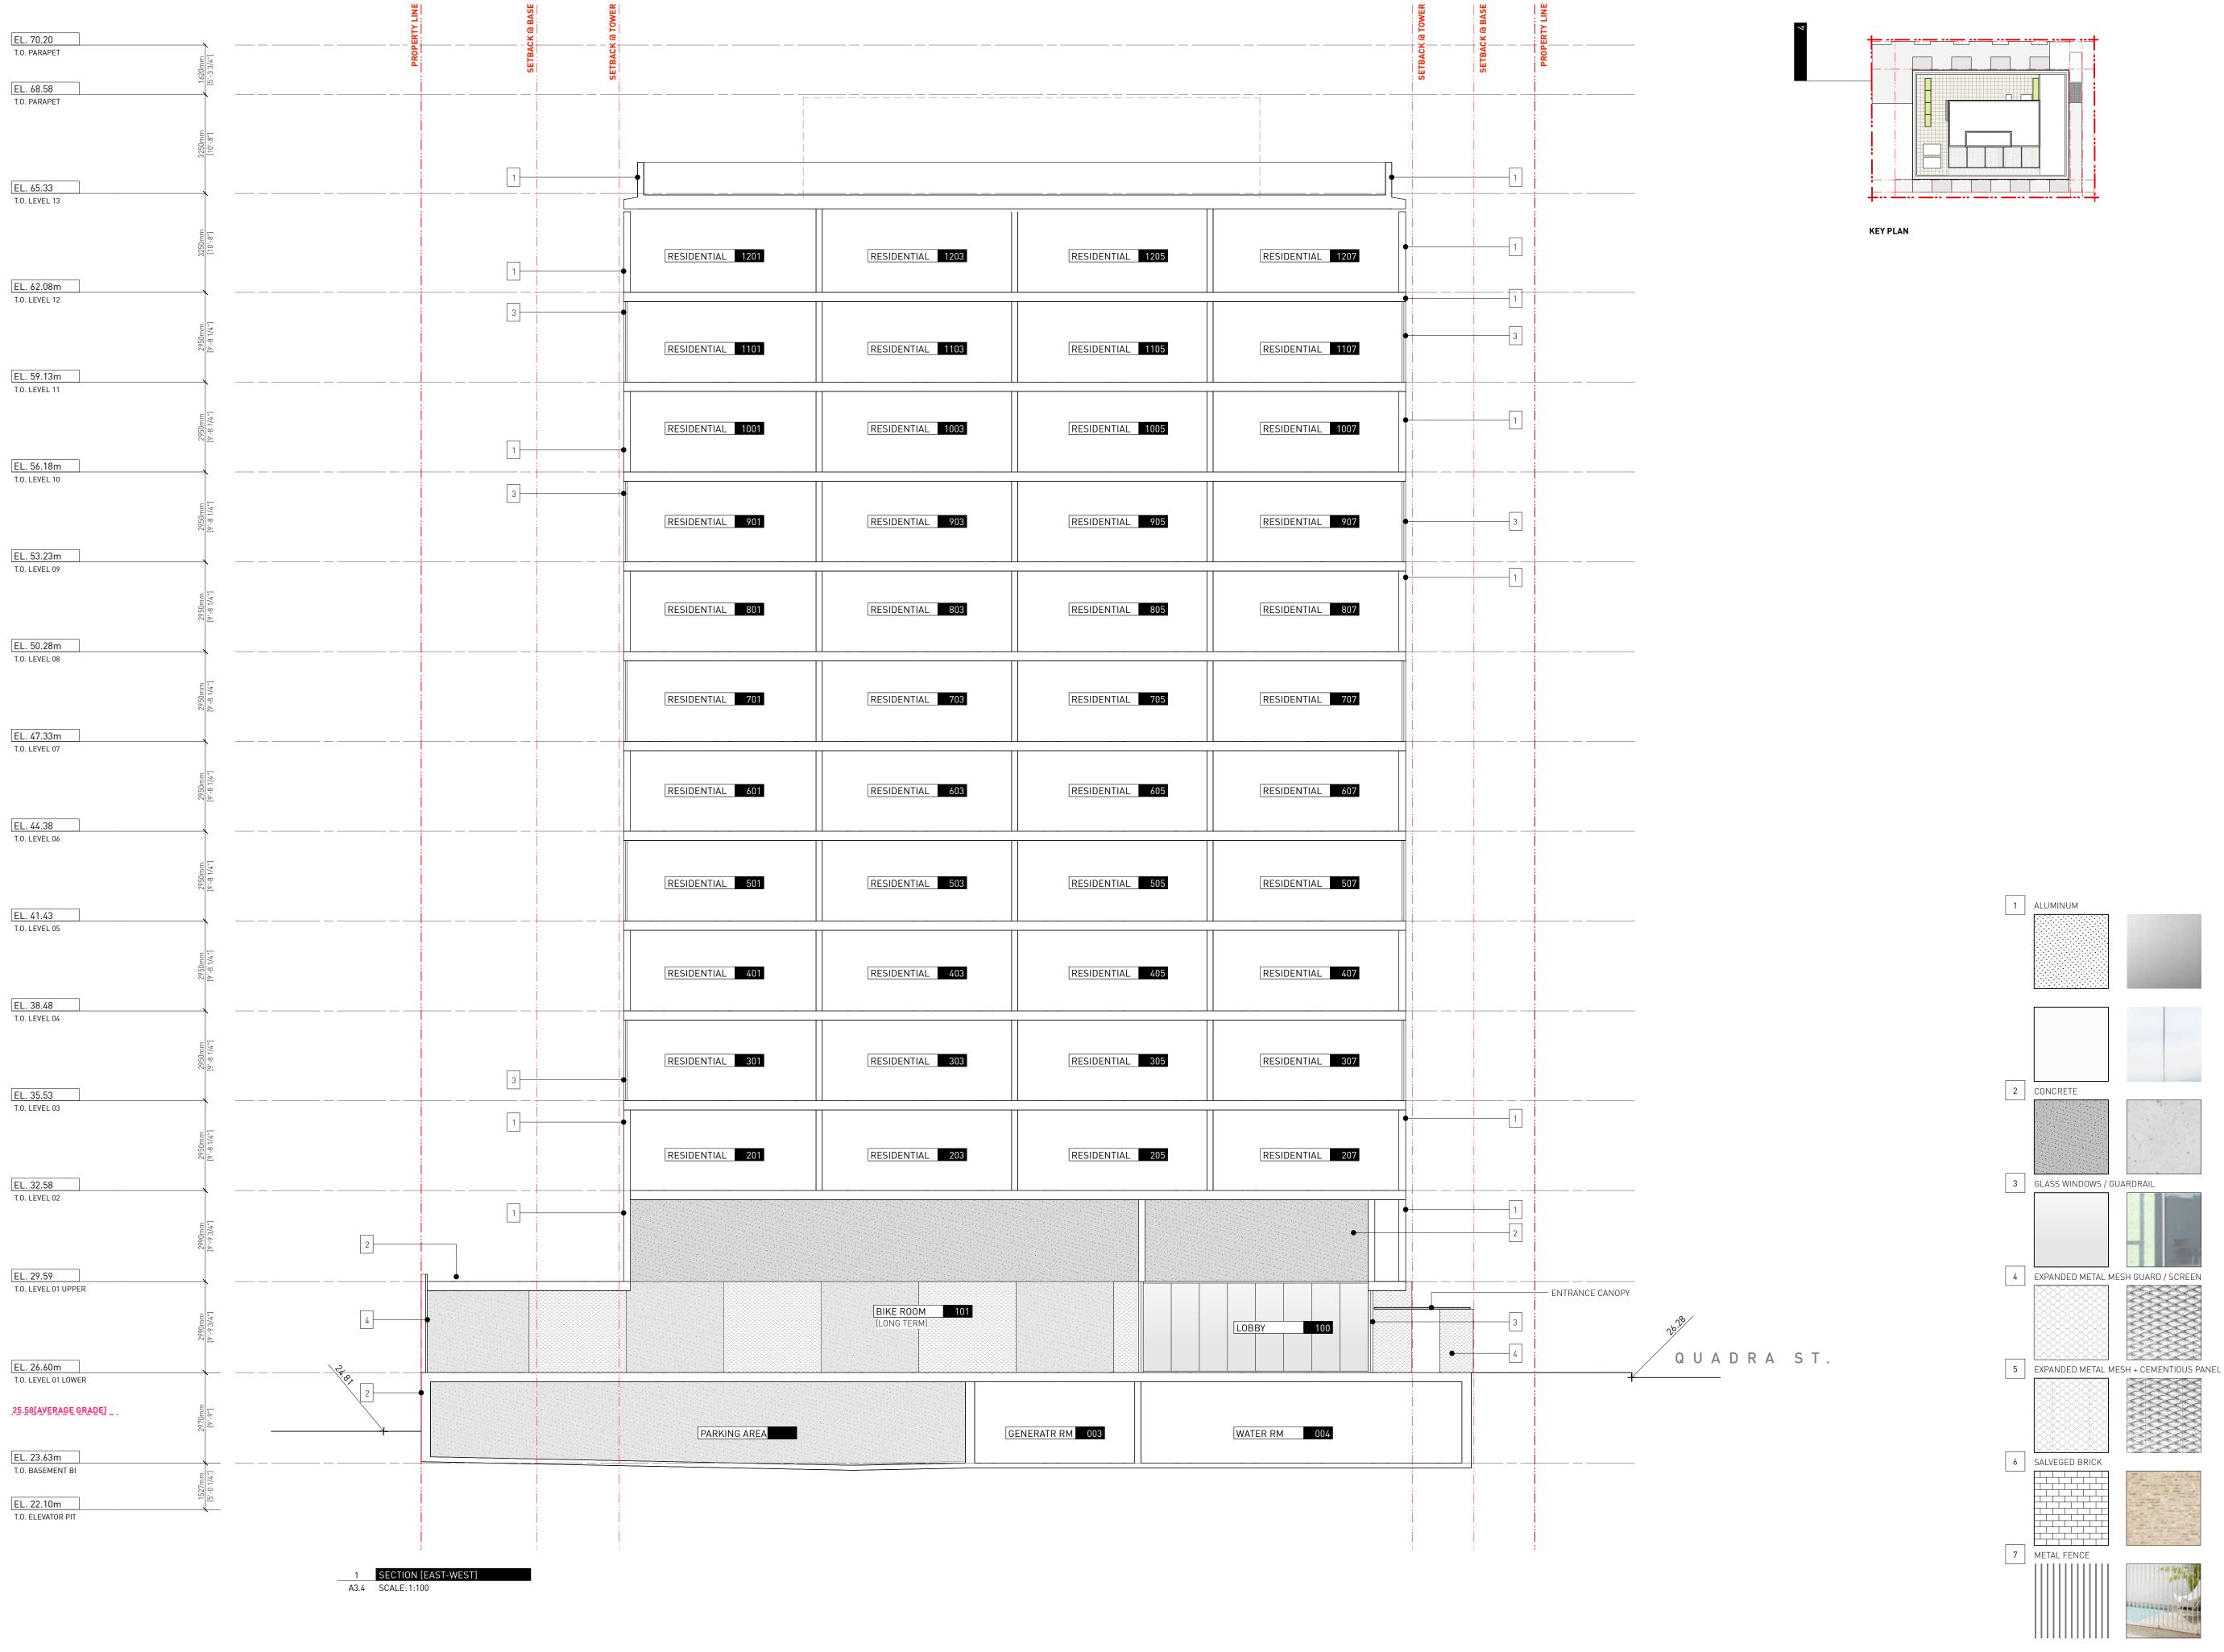

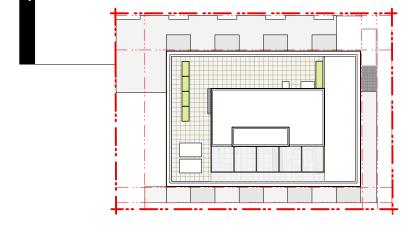

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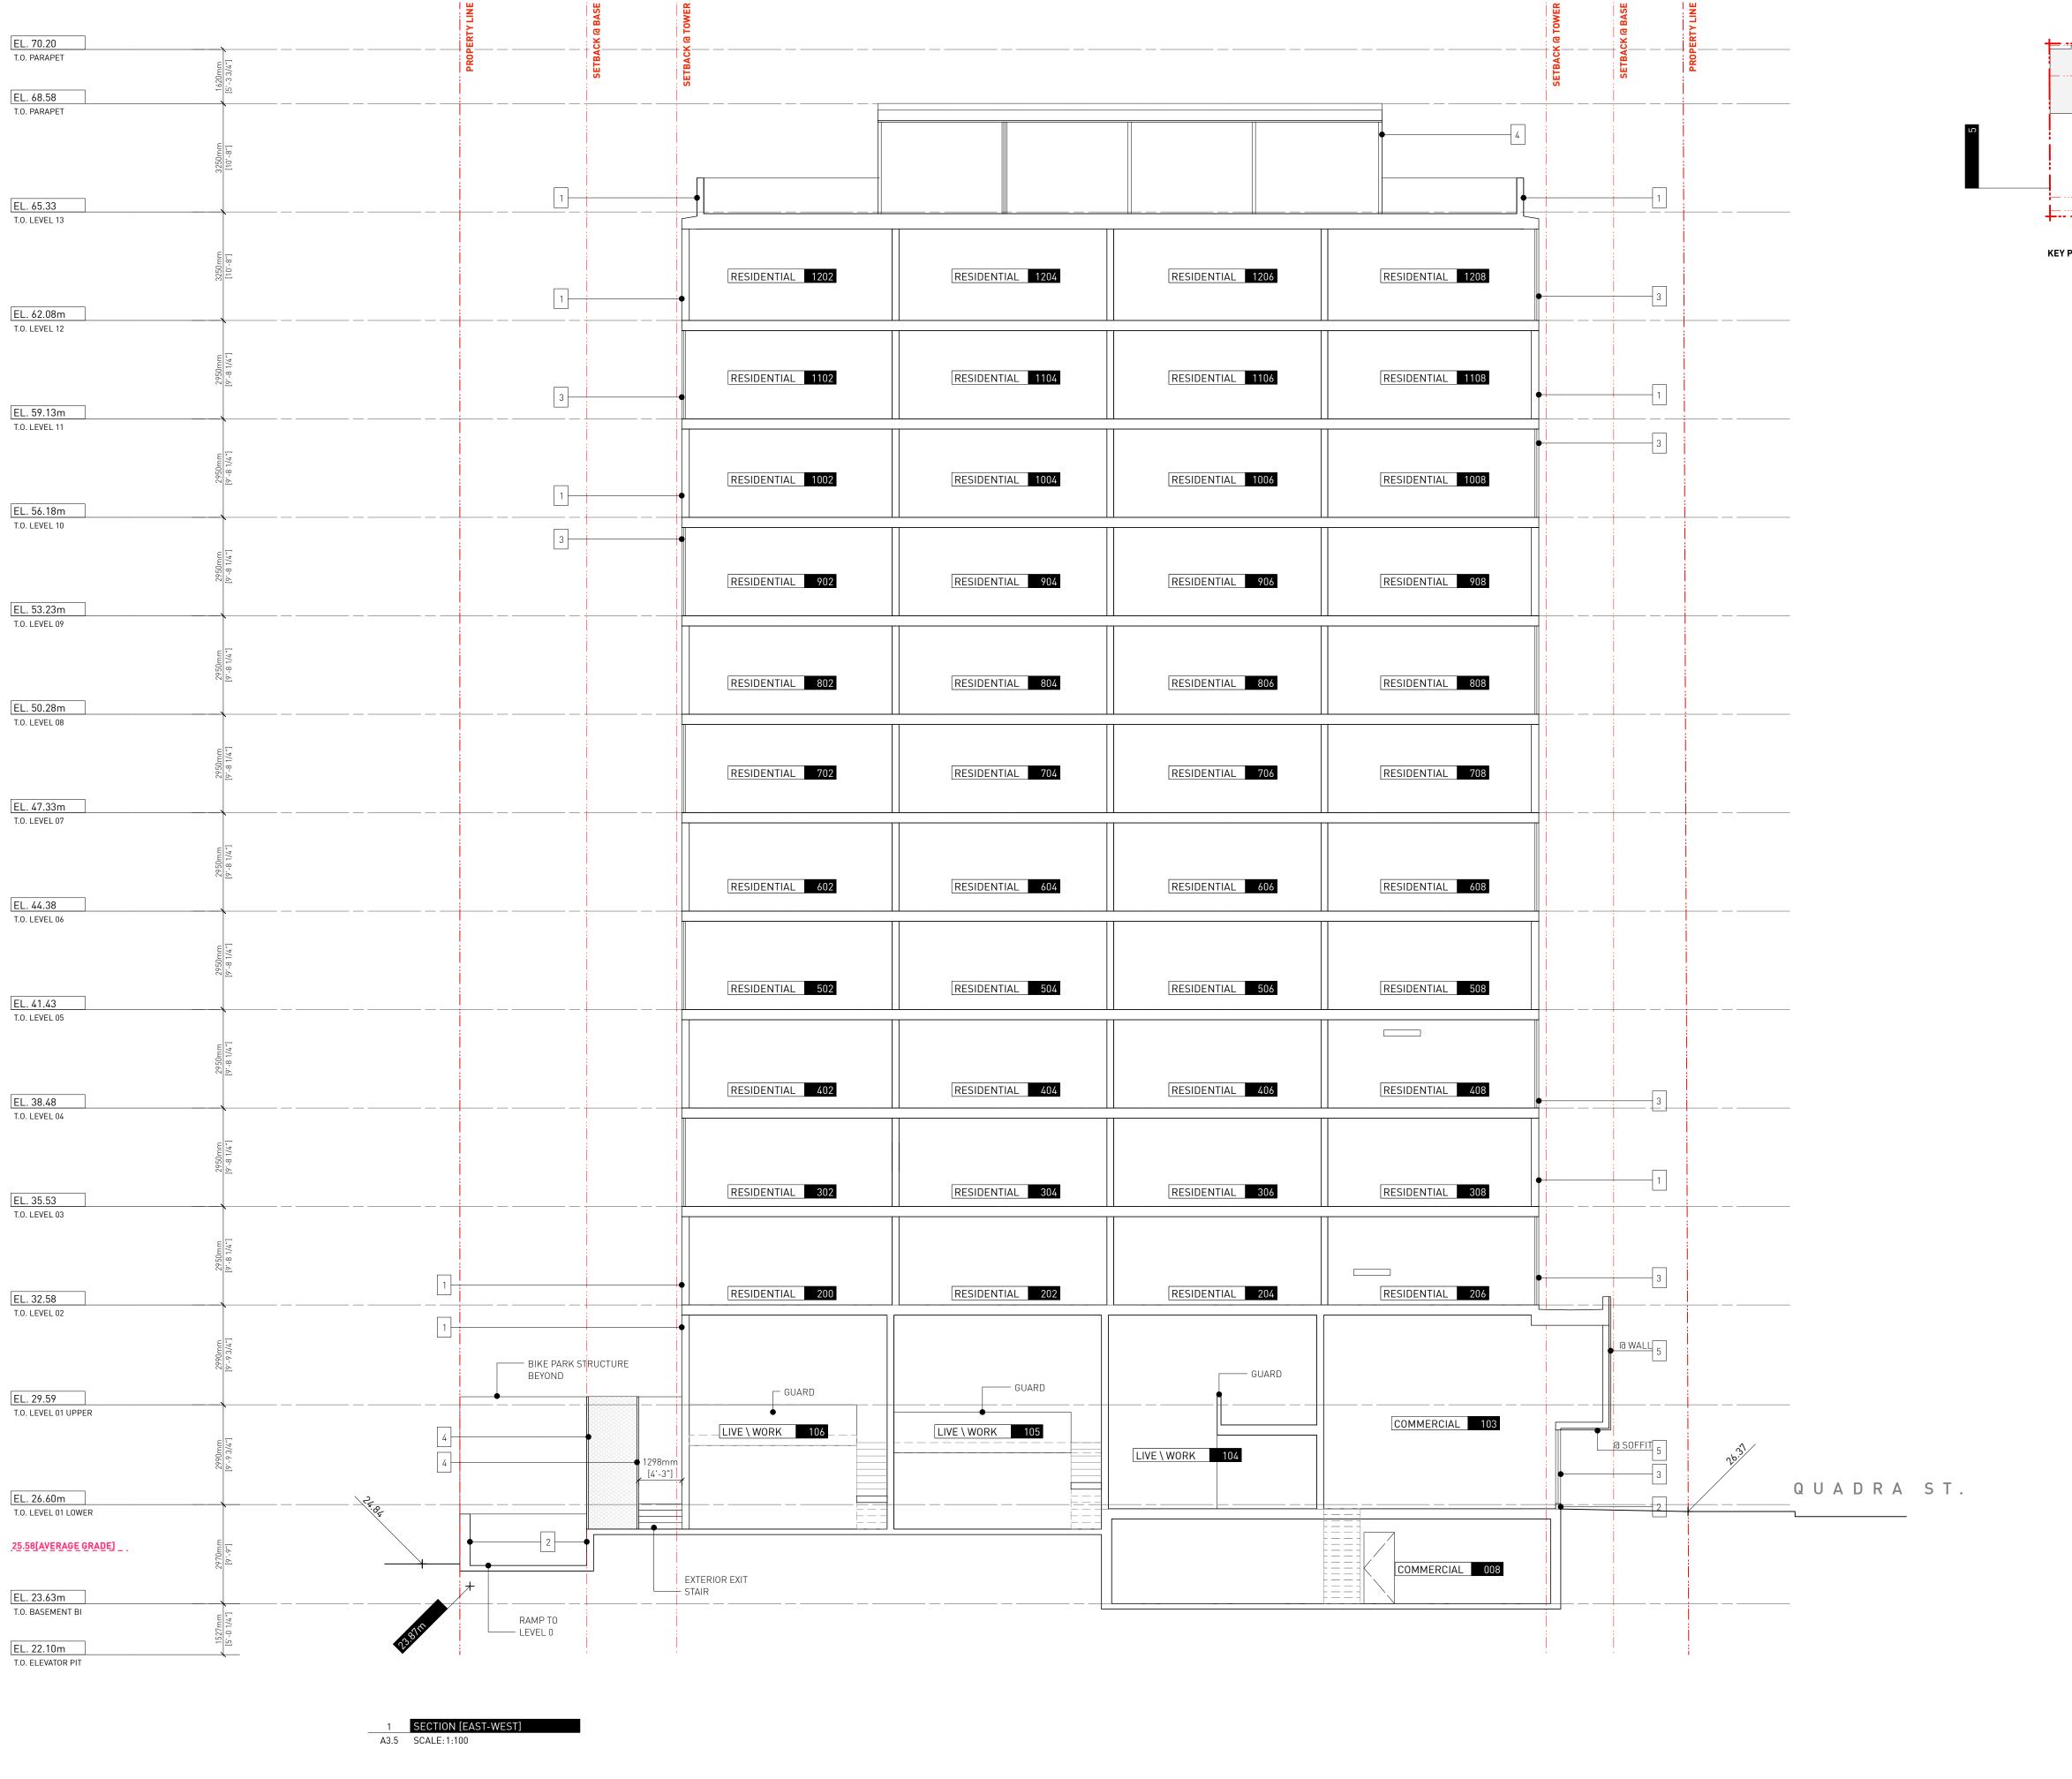


266 MCDERMOT AVE Winnipeg MB R3B 0S8 P: 204.480.8421 F: 204.480.8876

1702 QUADRA STREET + 862 FISGARD STREET

BUILDING SECTION

Project 0650 Sheet A3.4





1 ALUMINUM

2 CONCRETE

3 GLASS WINDOWS / GUARDRAIL

4 EXPANDED METAL MESH GUARD / SCREEN

5 EXPANDED METAL MESH + CEMENTIOUS PANEL

6 SALVEGED BRICK

7 METAL FENCE

KEY PLAN

7 Issued for DDP 18.07.2025 6 Issued for DDP 11.07.2025

Drawn By: Checked By: Printing Date: PB 18.07.2025

The Contractor shall verify all dimensions, datums

08.07.2025

and levels prior to commencement of work. All errors and omissions to be reported to the

Architect before proceeding.


This drawing must not be scaled.


5 Issued for DDP

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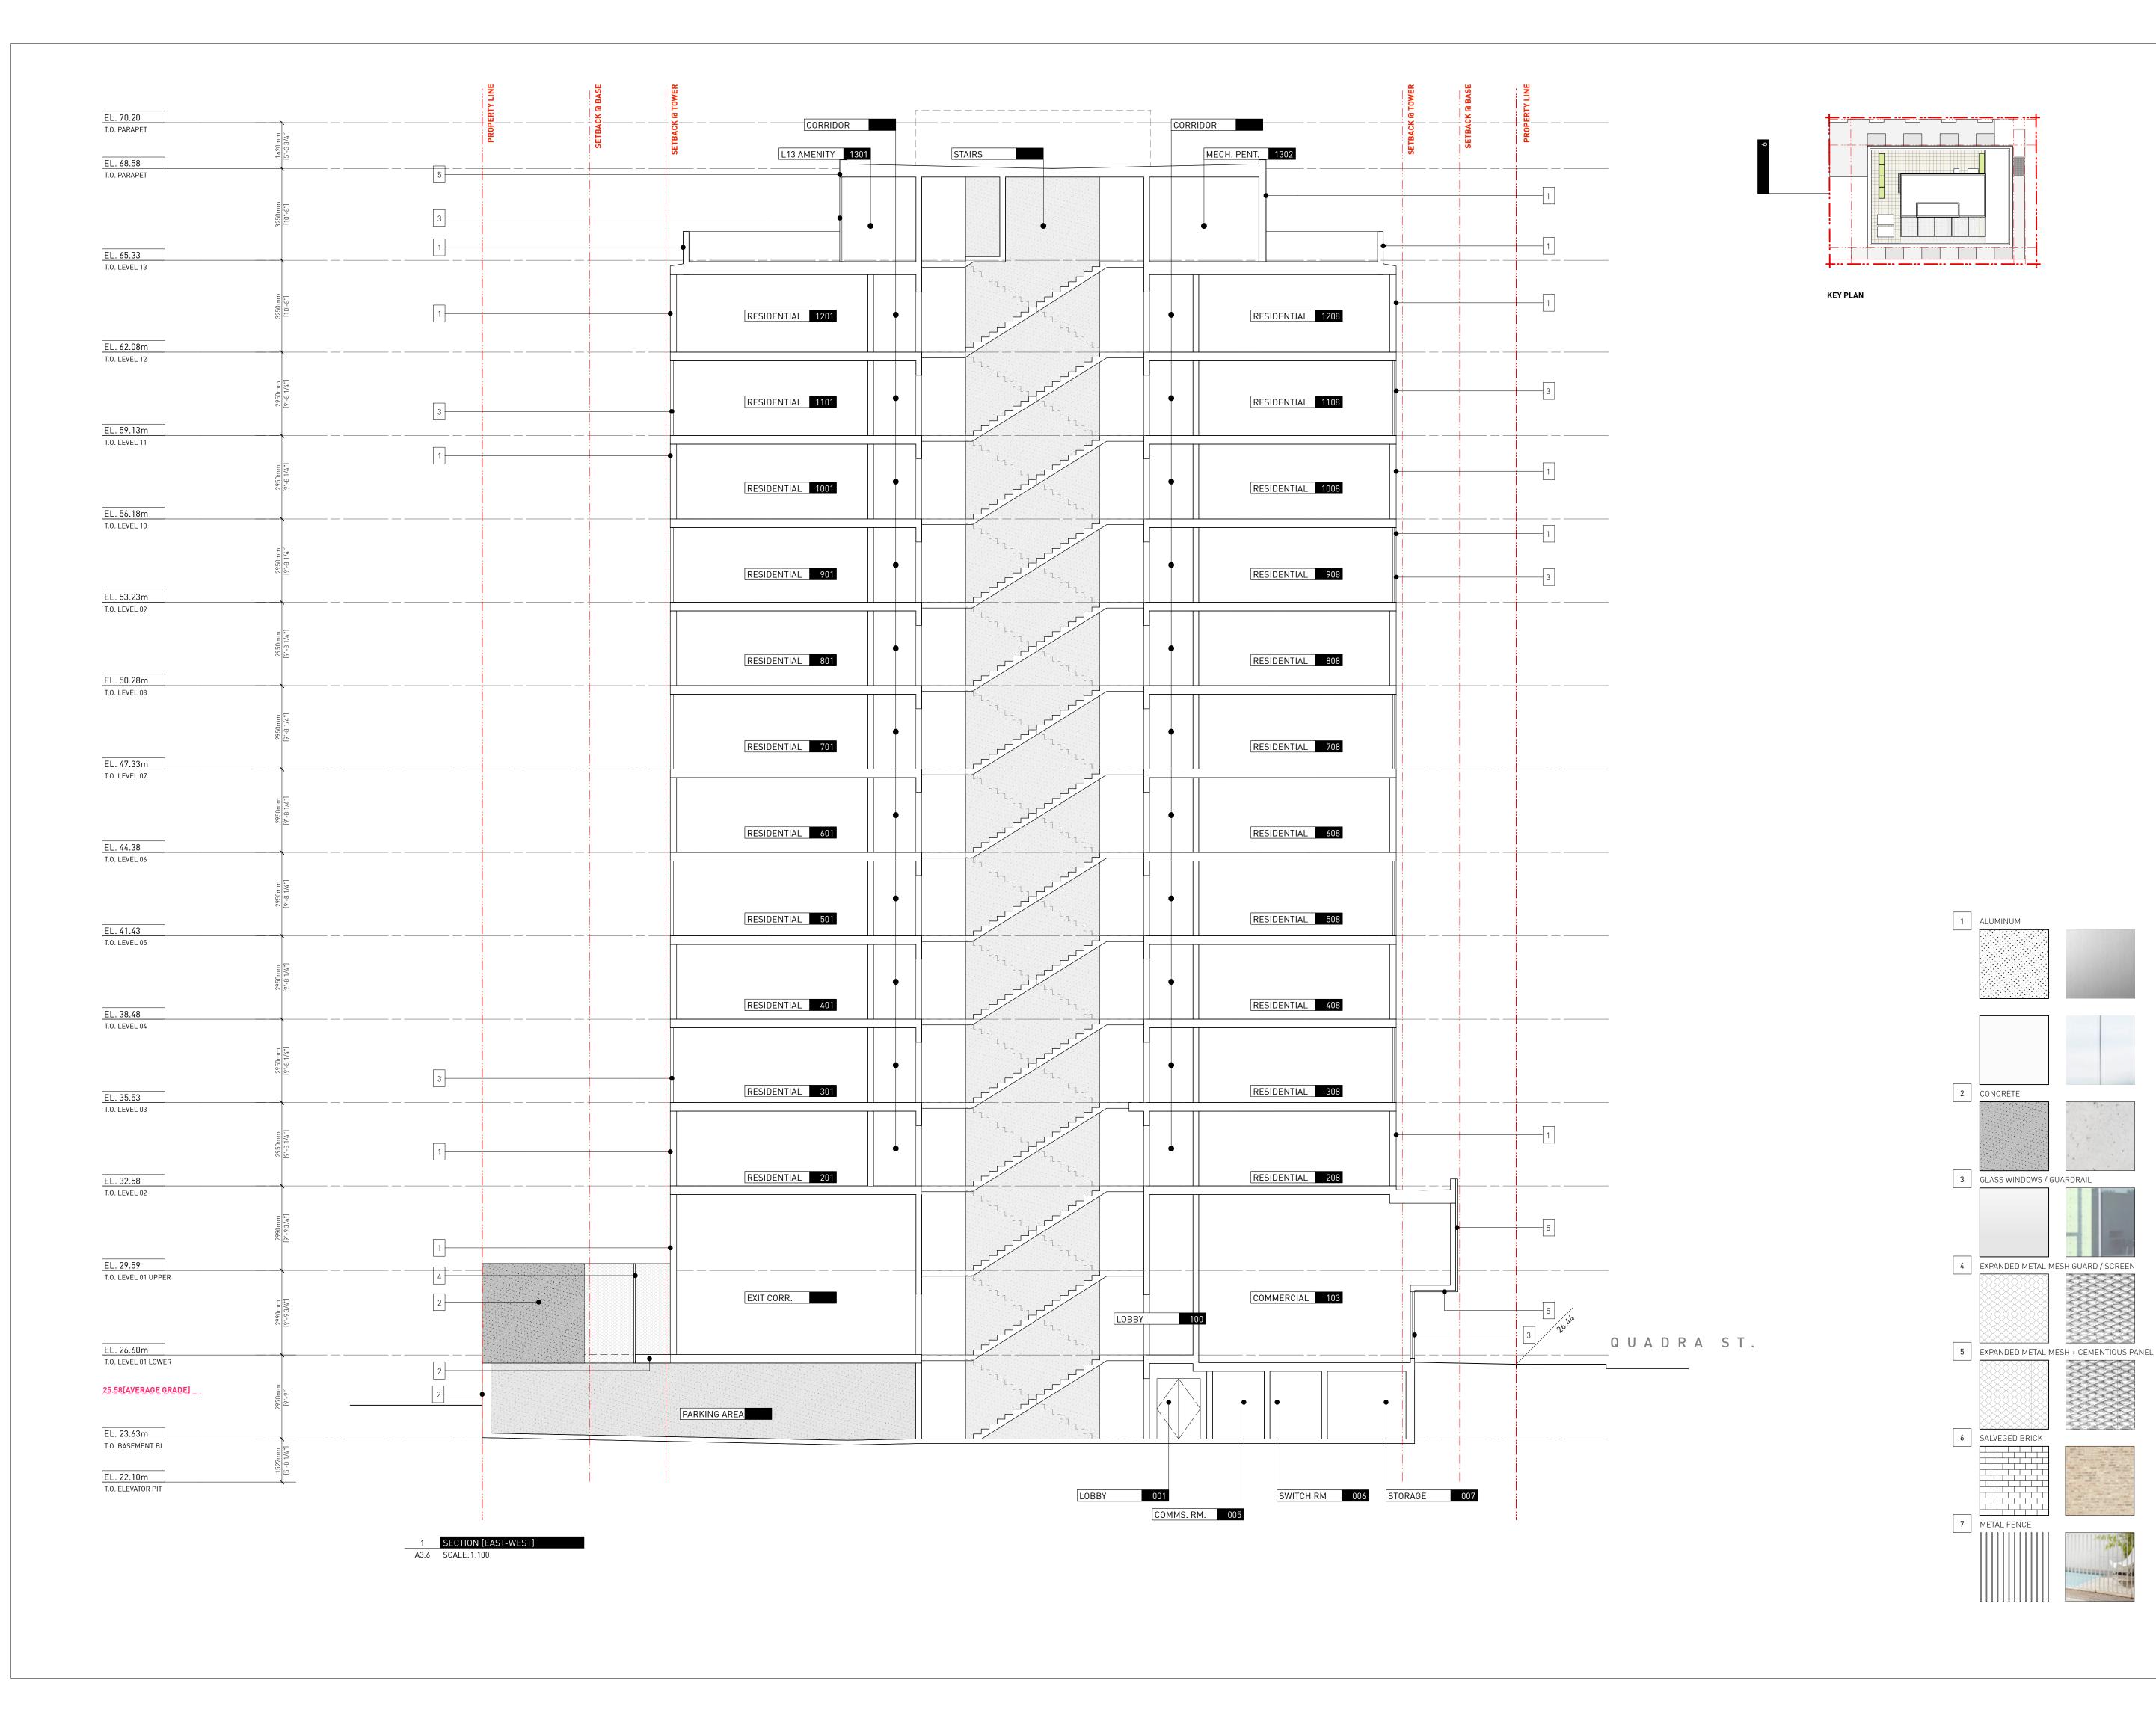
266 MCDERMOT AVE Winnipeg MB R3B 0S8 P: 204.480.8421 F: 204.480.8876

1702 QUADRA STREET + 862 FISGARD STREET

BUILDING SECTION

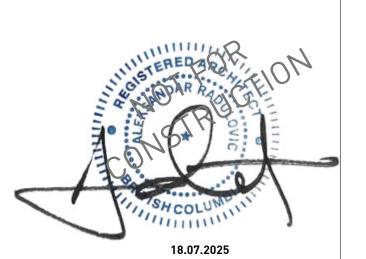Project 0650 Sheet

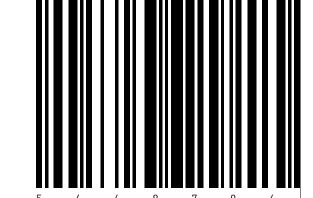A3.5



7 Issued for DDP6 Issued for DDP

5 Issued for DDP

18.07.2025

11.07.2025

08.07.2025

Drawn By:
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18.07.2025

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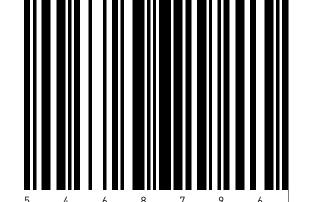
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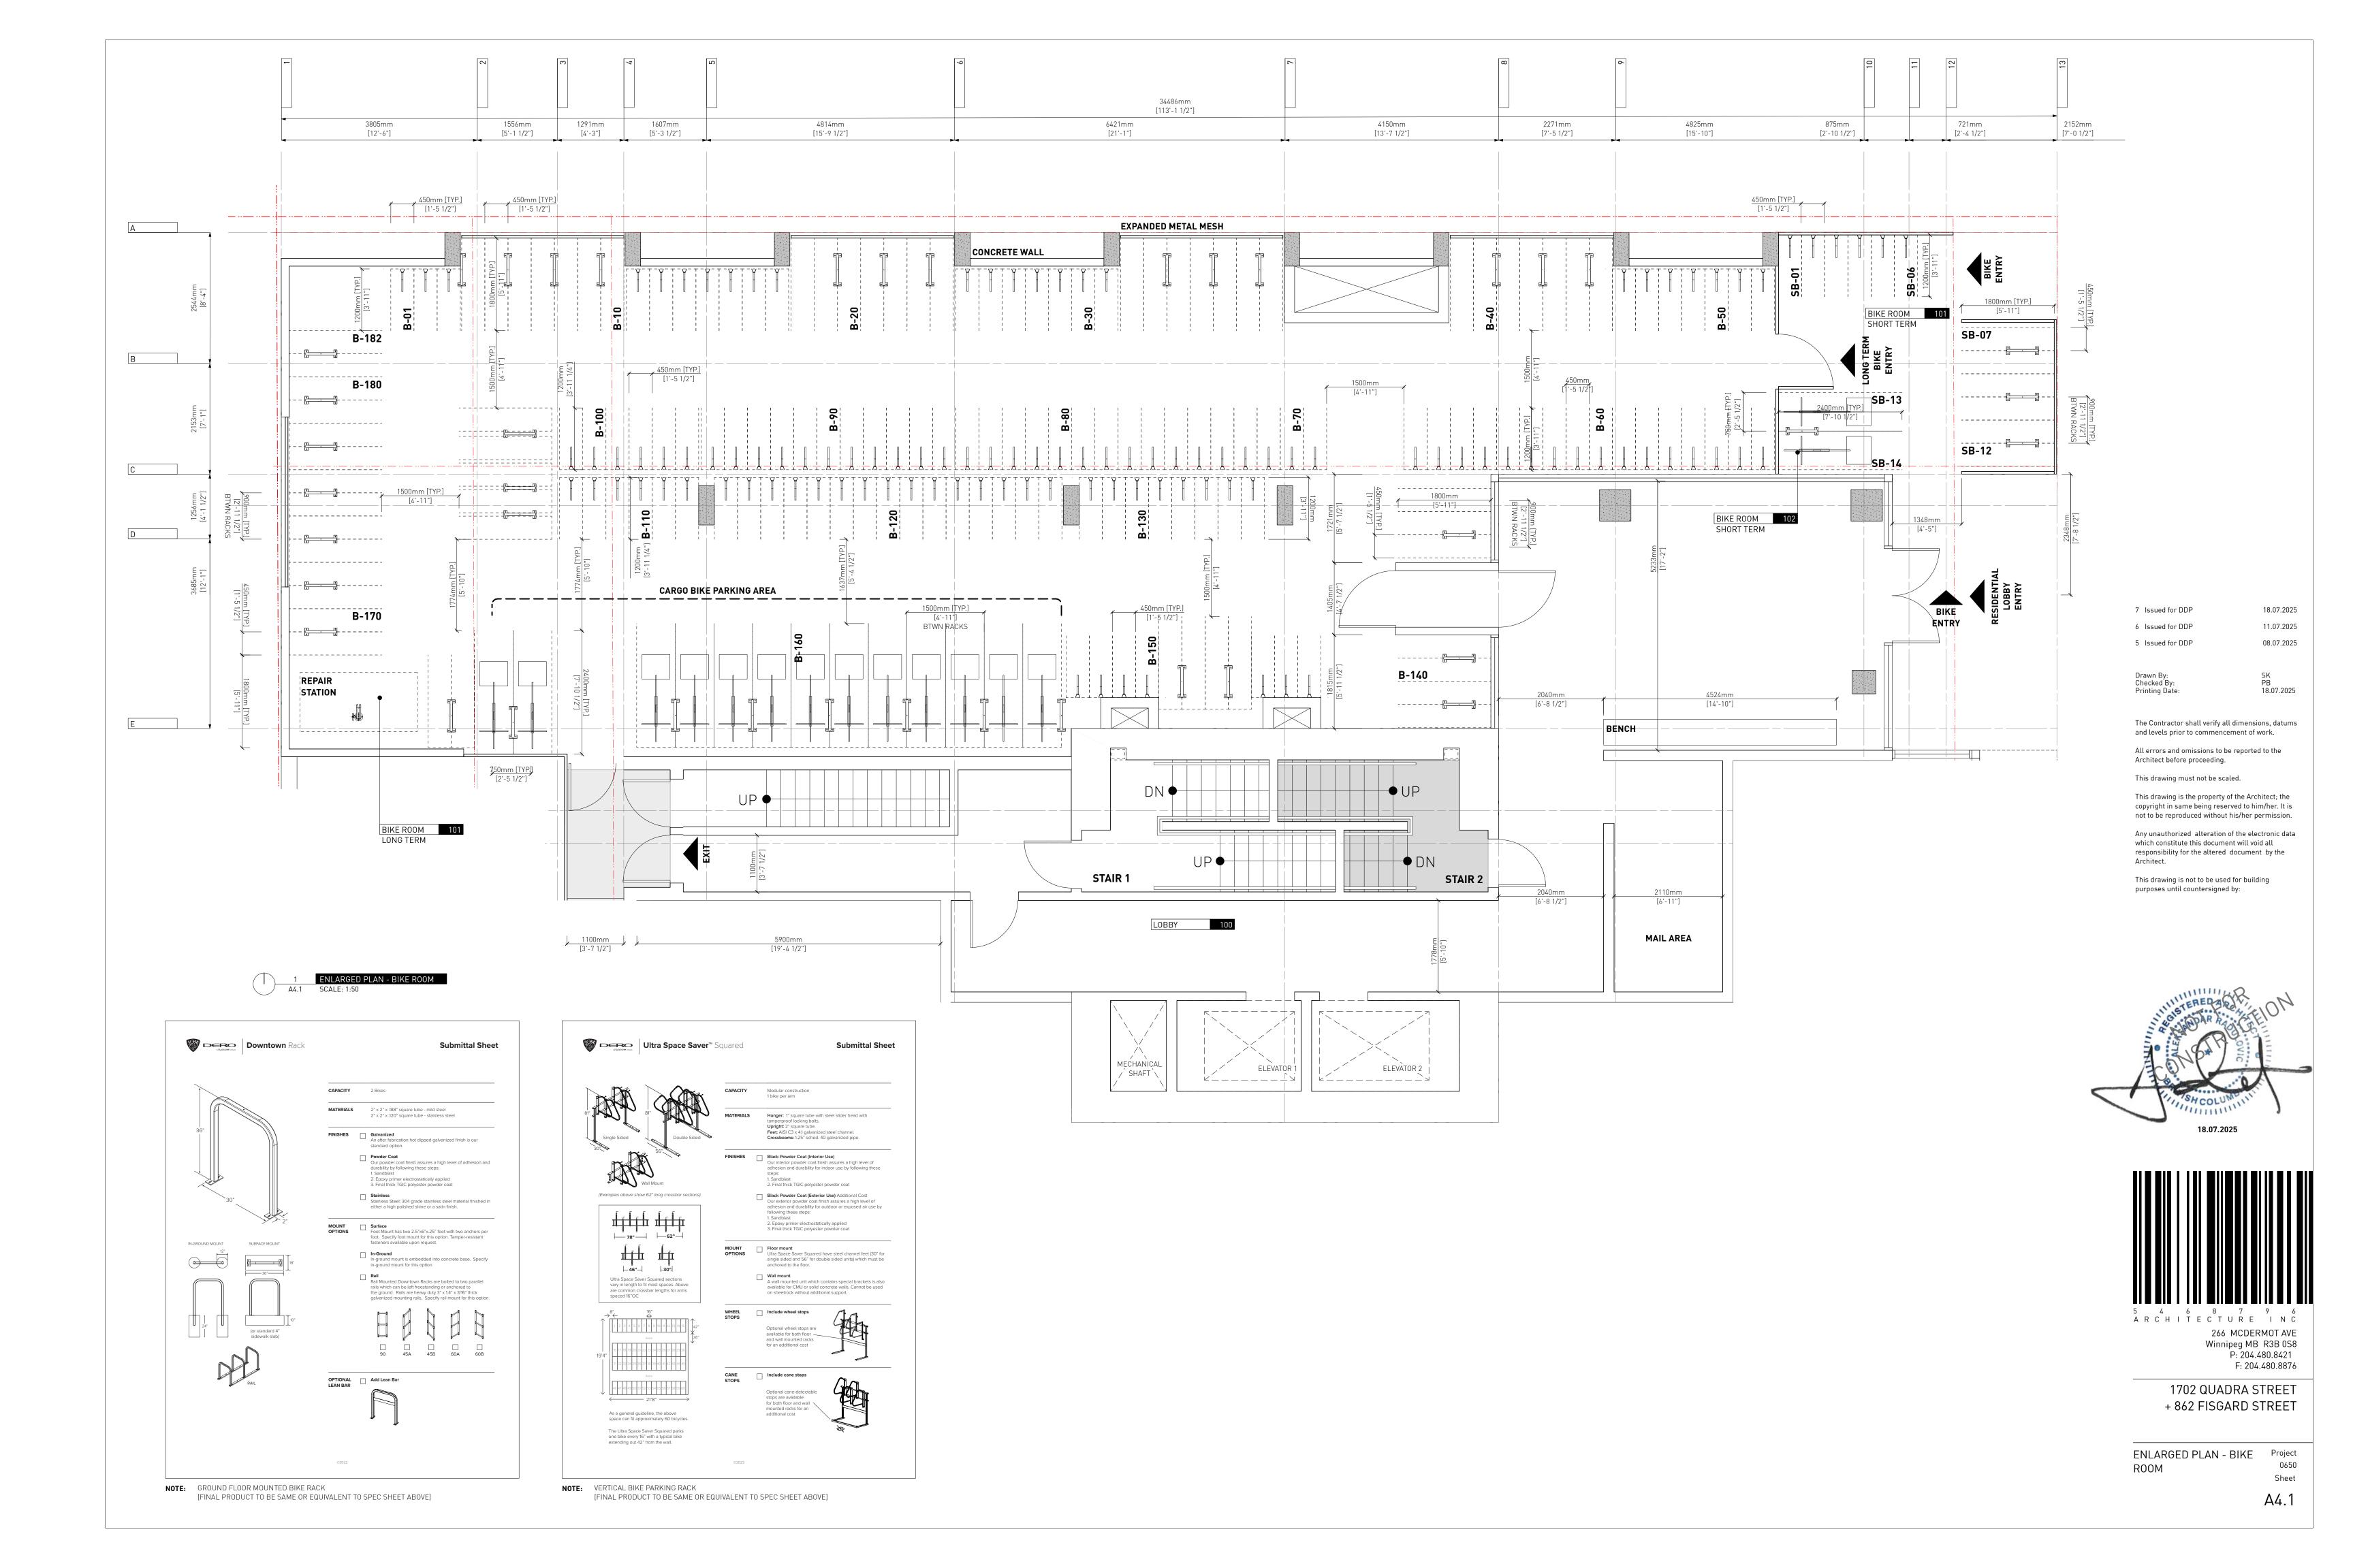


A R C H I T E C T U R E I N C 266 MCDERMOT AVE Winnipeg MB R3B 0S8 P: 204.480.8421 F: 204.480.8876

1702 QUADRA STREET + 862 FISGARD STREET

BUILDING SECTION

0650 Sheet



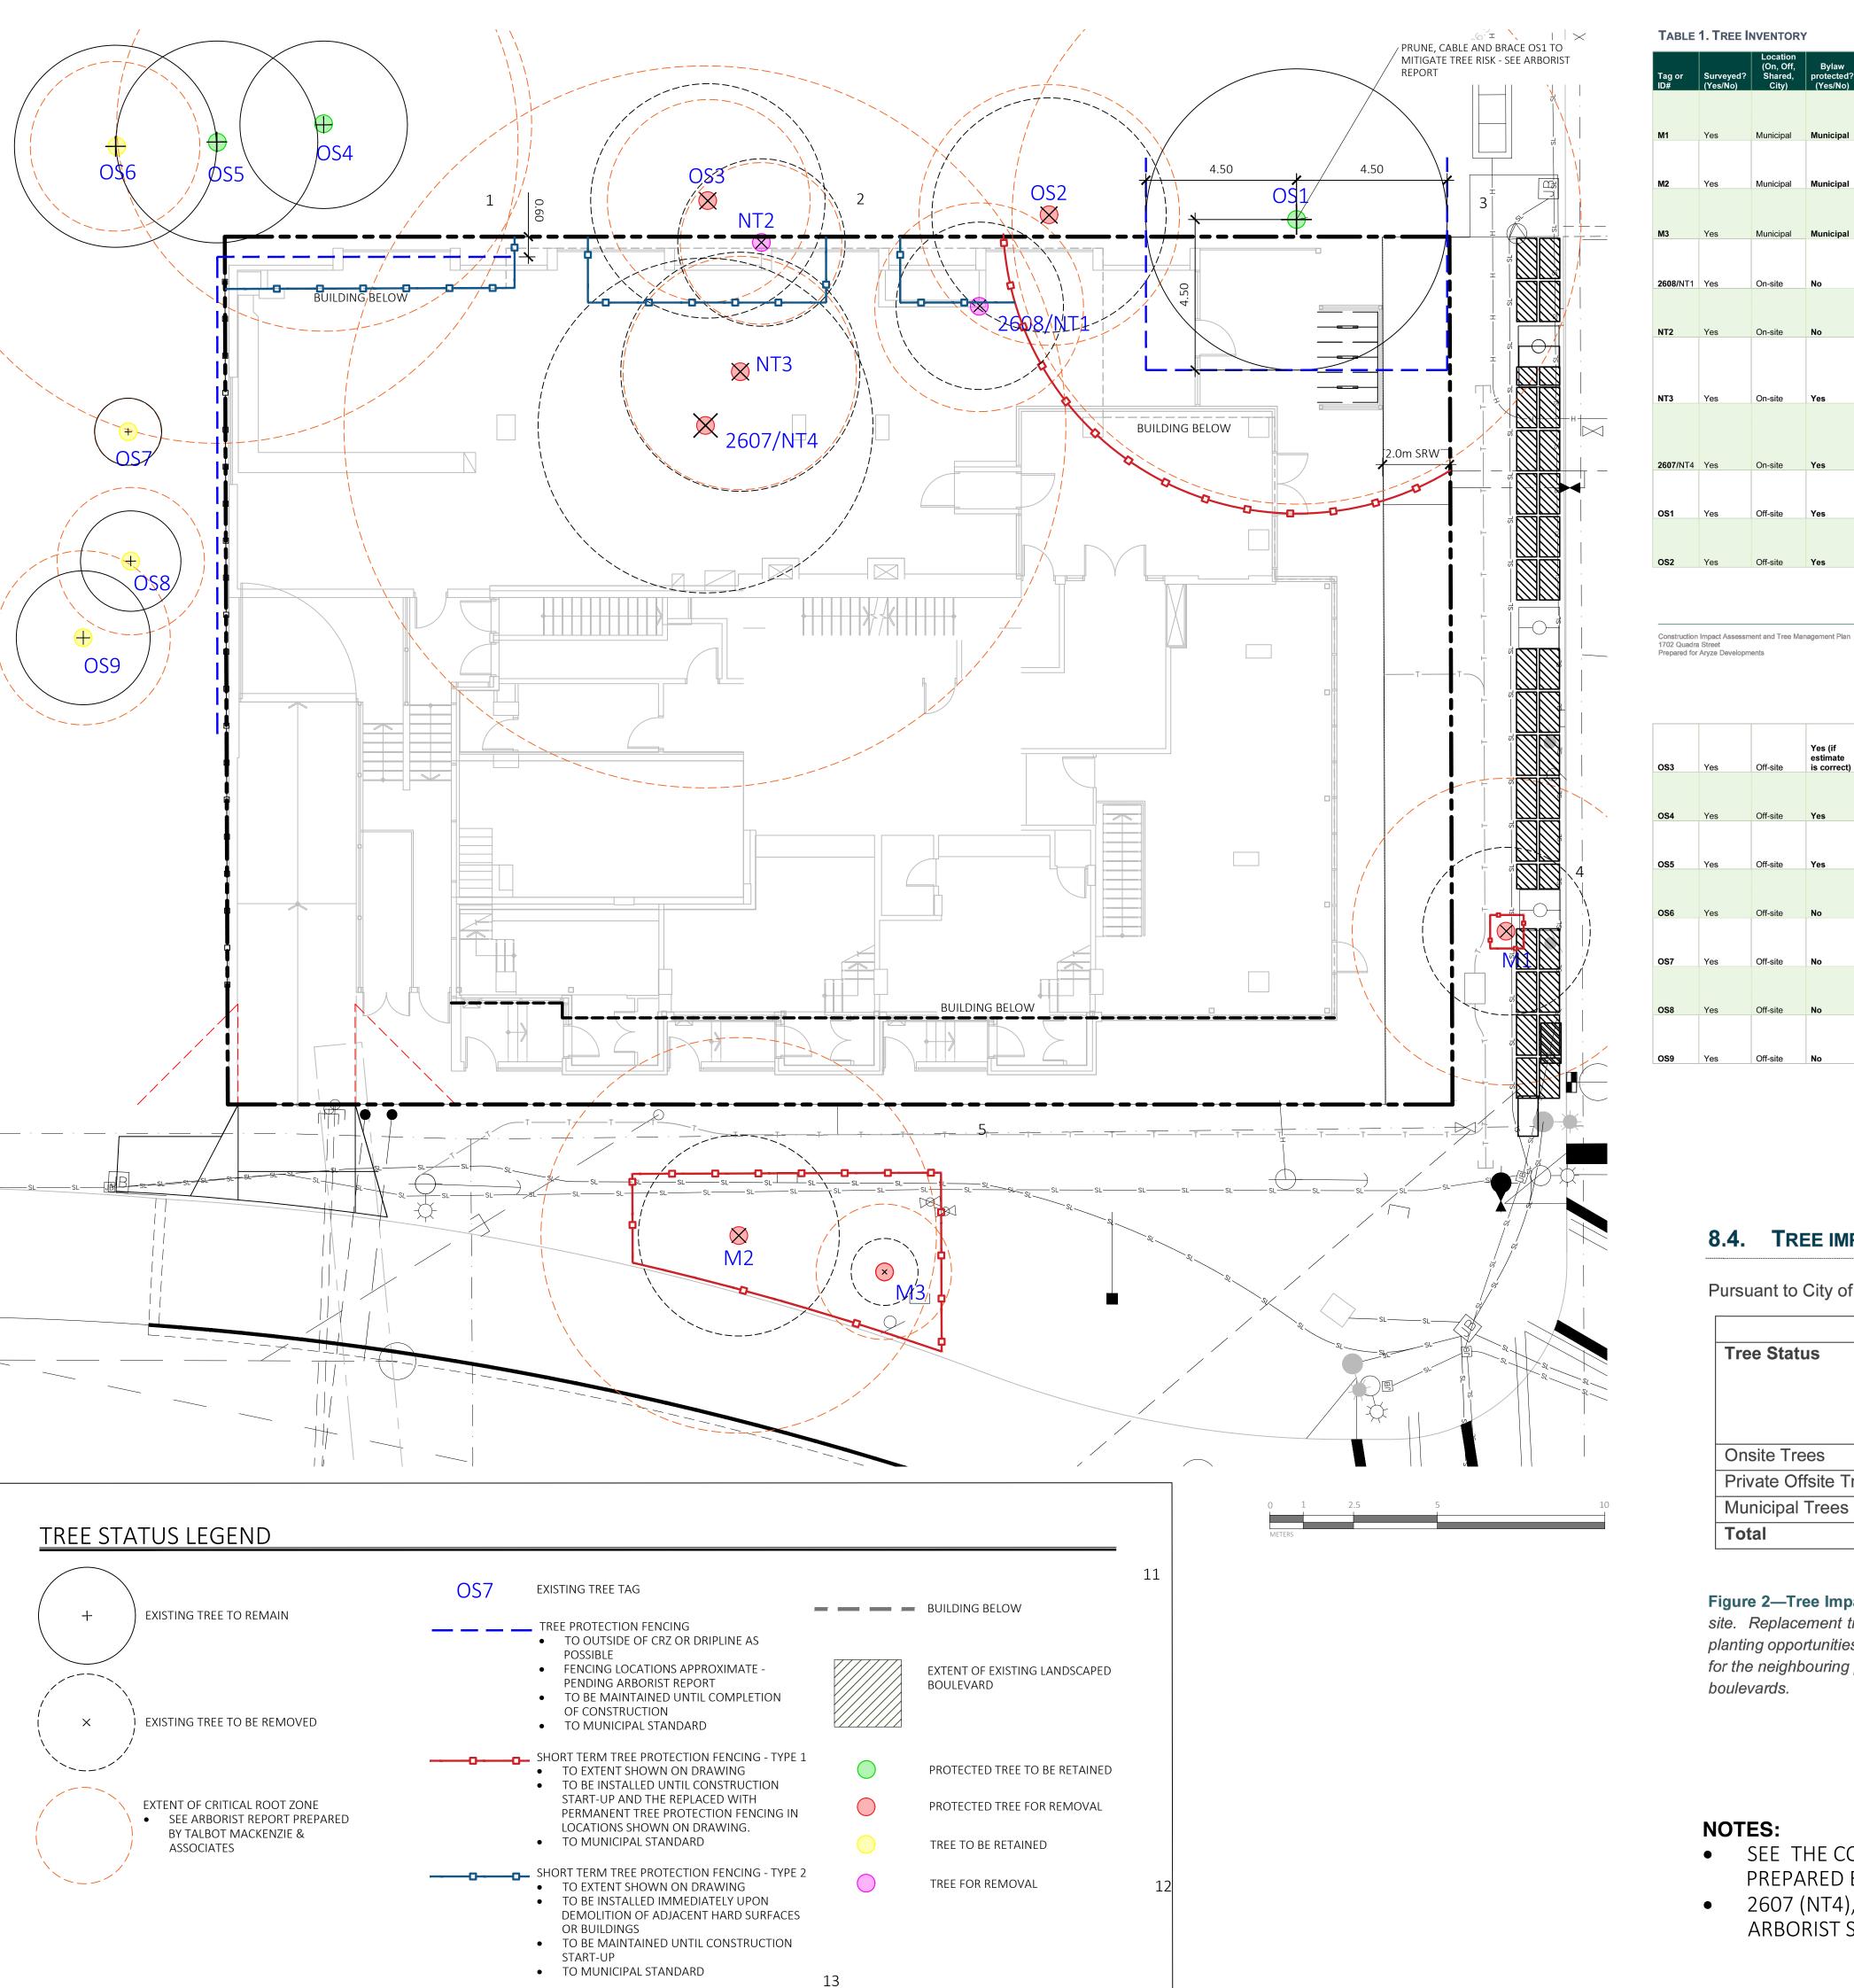


TABLE 1. TREE INVENTORY

| | | Location (On, Off, | Location (On Off | Location (On, Off, Bylaw | Name | | | Critical | Dripline | Condition | ļ | Retention Suitability | | | | |
|------------------|-----------------------|-----------------------|------------------------|-----------------------------|---|-------------------------|-------------------------|-----------------|-----------|------------|----------------|-----------------------|---|---|------------------|--|
| ag or # | Surveyed? (Yes/No) | Shared, City) | protected? (Yes/No) | Common | Botanical | dbh (cm) | root zone radius (m) | diameter (m) | Health | Structural | (onsite trees) | Relative tolerance | General field observations/remarks | Tree retention / location comments | Retent status | |
| | | | | English | | | | | | | | | Columnar form. Clearance pruned away from | Conflict with proposed underground | | |
| 1 | Yes | Municipal | Municipal | Oak | Quercus robur | 46 | 4.6 | 5 | Fair | Fair | N/A | Good | building. | hydro. | X | |
| 12 | Yes | Municipal | Municipal | Cut-leaf Beech | Fagus sylvatica 'Asplenifolia' | 49 (below union) | 5.9 | 6 | Good | Fair | N/A | Poor | Measured at 1m. Hydro clearance pruned. | Conflict with proposed underground hydro. | x | |
| | | | | Deciduous | Stewartia | | | | | | | | | | | |
| 13 | Yes | Municipal | Municipal | Camellia | pseudocamellia | 4 | 1 | 1 | Fair | Fair | N/A | Moderate | Juvenile tree. Weedwacker damage. | Frontage improvements. | Х | |
| 6 08 /NT1 | Yes | On-site | No | Pear | Pyrus spp. | 26 | 3.1 | 5 | Fair | Fair | Unsuitable | Moderate | Topped. Gravel parking adjacent. | Within building footprint. | x | |
| | | | | | ,,,,,,,,,,,,,,,,,,,,,,,,,,,,,,,,,,,,,,, | | | | | | | | 3 | , | | |
| IT2 | Yes | On-site | No | Ash | Fraxinus spp. | ~18,10 | 2.4 | 5 | Fair | Fair-poor | Unsuitable | Good | Located between fence and storage shed. Topped, epicormic growth. | Within building footprint. | x | |
| Т3 | Yes | On-site | Yes | Ash | Fraxinus spp. | ~35 | 3.5 | 7 | Fair-poor | Poor | Unsuitable | Good | Located between storage shed and brick garage. Large seam up trunk, likely from past failure, decaying. Lowest limb actively failing, has been shortened, will rest on garage roof. | Within building footprint. | x | |
| 607 /NT4 | | On-site | Yes | Big-Leaf Maple | Acer macrophyllum | 90 (below unions) | 10.8 | 10 | | | Unsuitable | | Large deadwood/decay north canopy. Pruning stubs and deadwood in primary stem, response growth lower stem. Large surface roots lifting surrounding asphalt. | Within building footprint. | x | |
|)S1 | Yes | Off-site | Yes | Big-Leaf Maple | Acer macrophyllum | ~50,35 | 8.5 | 9 | Fair | Fair | N/A | Moderate | North neighbouring property. Codominant stems, narrow attachments. Previous thinning. Located against fence. | Conflict with building footprint. | Retain | |
|)S2 | Yes | Off-site | Yes | Ash | Fraxinus spp. | ~30,15 | 3.9 | 7 | Fair | Fair | N/A | Good | North neighbouing property. Located against fence. Previous thinning and raising. Epicormic growth. | Conflict with building footprint. | x | |

North neighbouring property. Located against Potential impacts from building North neighbouring property, active inclusion Potential impacts from building Possibly removed. West neighbouring property. Codominant top. Off-site No Tree Gingko biloba ~18 2.2 3 Good Fair N/A Moderate subject property.

> West neighbouring property. Codominant top Canopy beginning to encroach on driveway on

8.4. TREE IMPACT SUMMARY TABLE

Pursuant to City of Victoria Tree Preservation Bylaw No. 21-035, the tree replacement calculations are as follows:

| | Α | В | С | D | |
|-----------------------|------------|------------|-------------|------------------|-----------|
| Tree Status | Total # of | # Of Trees | # Of NEW or | # Of EXISTING | NET |
| | Protected | to be | REPLACEMENT | non-protected | CHANGE |
| | Trees | REMOVED | Trees to be | Trees Counted as | (A-B+C+D) |
| | | | Planted* | Replacements | |
| Onsite Trees | 2 | 2 | 0 | 0 | -2 |
| Private Offsite Trees | 5 | 2 | 2 7 | 0 | 0 |
| Municipal Trees | 3 | 3 | 6 | N/A | 3 |
| Total | 10 | 7 | 4 | 0 | 1 |

Figure 2—Tree Impact Summary Table: Based on bylaw criteria, a lot of this size (947.8m²) requires a 5-tree minimum onsite. Replacement tree/tree minimum requirements will be compensated cash-in-lieu, as there do not appear to be sufficient planting opportunities post-construction. The landscape plan shows the two (2) required Schedule E—Part 1 replacement trees for the neighbouring property at 877 North Park Street and six (6) replacement trees on the Quadra & Fisgard Street municipal boulevards.

NOTES:

- SEE THE CONSTRUCTION IMPACT ASSESSMENT AND TREE MANAGEMENT PLAN, APPENDIX B, PREPARED BY TALMAC, FOR TREE PRESERVATION SUMMARY.
- 2607 (NT4), 2608 (NT1), NT2, AND NT3 ARE PROPOSED FOR REMOVAL AT THE DEMOLITION PHASE. ARBORIST SUPERVISION IS REQUIRED AS IDENTIFIED IN THE CONSTRUCTION IMPACT ASSESSMENT



1608 Camosun Street, Victoria BC V8T 3E6 Info@biophiliacollective.ca 250 590 1156

PROJECT NAME:

THE ABBEY

PROJECT ADDRESS:

1702 QUADRA STREET VICTORIA, BC

DESIGNED BY: BIANCA BODLEY DRAWN BY: KIM TANG

| NO. | ISSUED FOR | YY\MM\DD |
|-----|------------------------------|------------|
| 1 | CIS PRESENTATION | 12/07/2021 |
| 2 | DEVELOPMENT PERMIT | 12/22/2021 |
| 3 | ADP MEETING | 04/13/2022 |
| 4 | REVISED AND RE-ISSUED FOR DP | 2023/06/01 |
| 5 | REVISED AND RE-ISSUED FOR DP | 2023/09/21 |
| 6 | REVISED AND RE-ISSUED FOR DP | 2023/12/15 |
| 7 | ISSUED FOR BP RESUBMISSION | 2024/04/30 |
| 8 | ISSUED FOR TENDER | 2024/06/28 |
| 9 | ISSUED FOR BP RESUBMISSION | 2024/07/31 |
| 10 | ISSUED FOR BP RESUBMISSION | 2024/09/27 |
| | | • |






DRAWING TITLE:

TREE REMOVAL & PROTECTION PLAN

DWG NO:

SCALE: 1:100



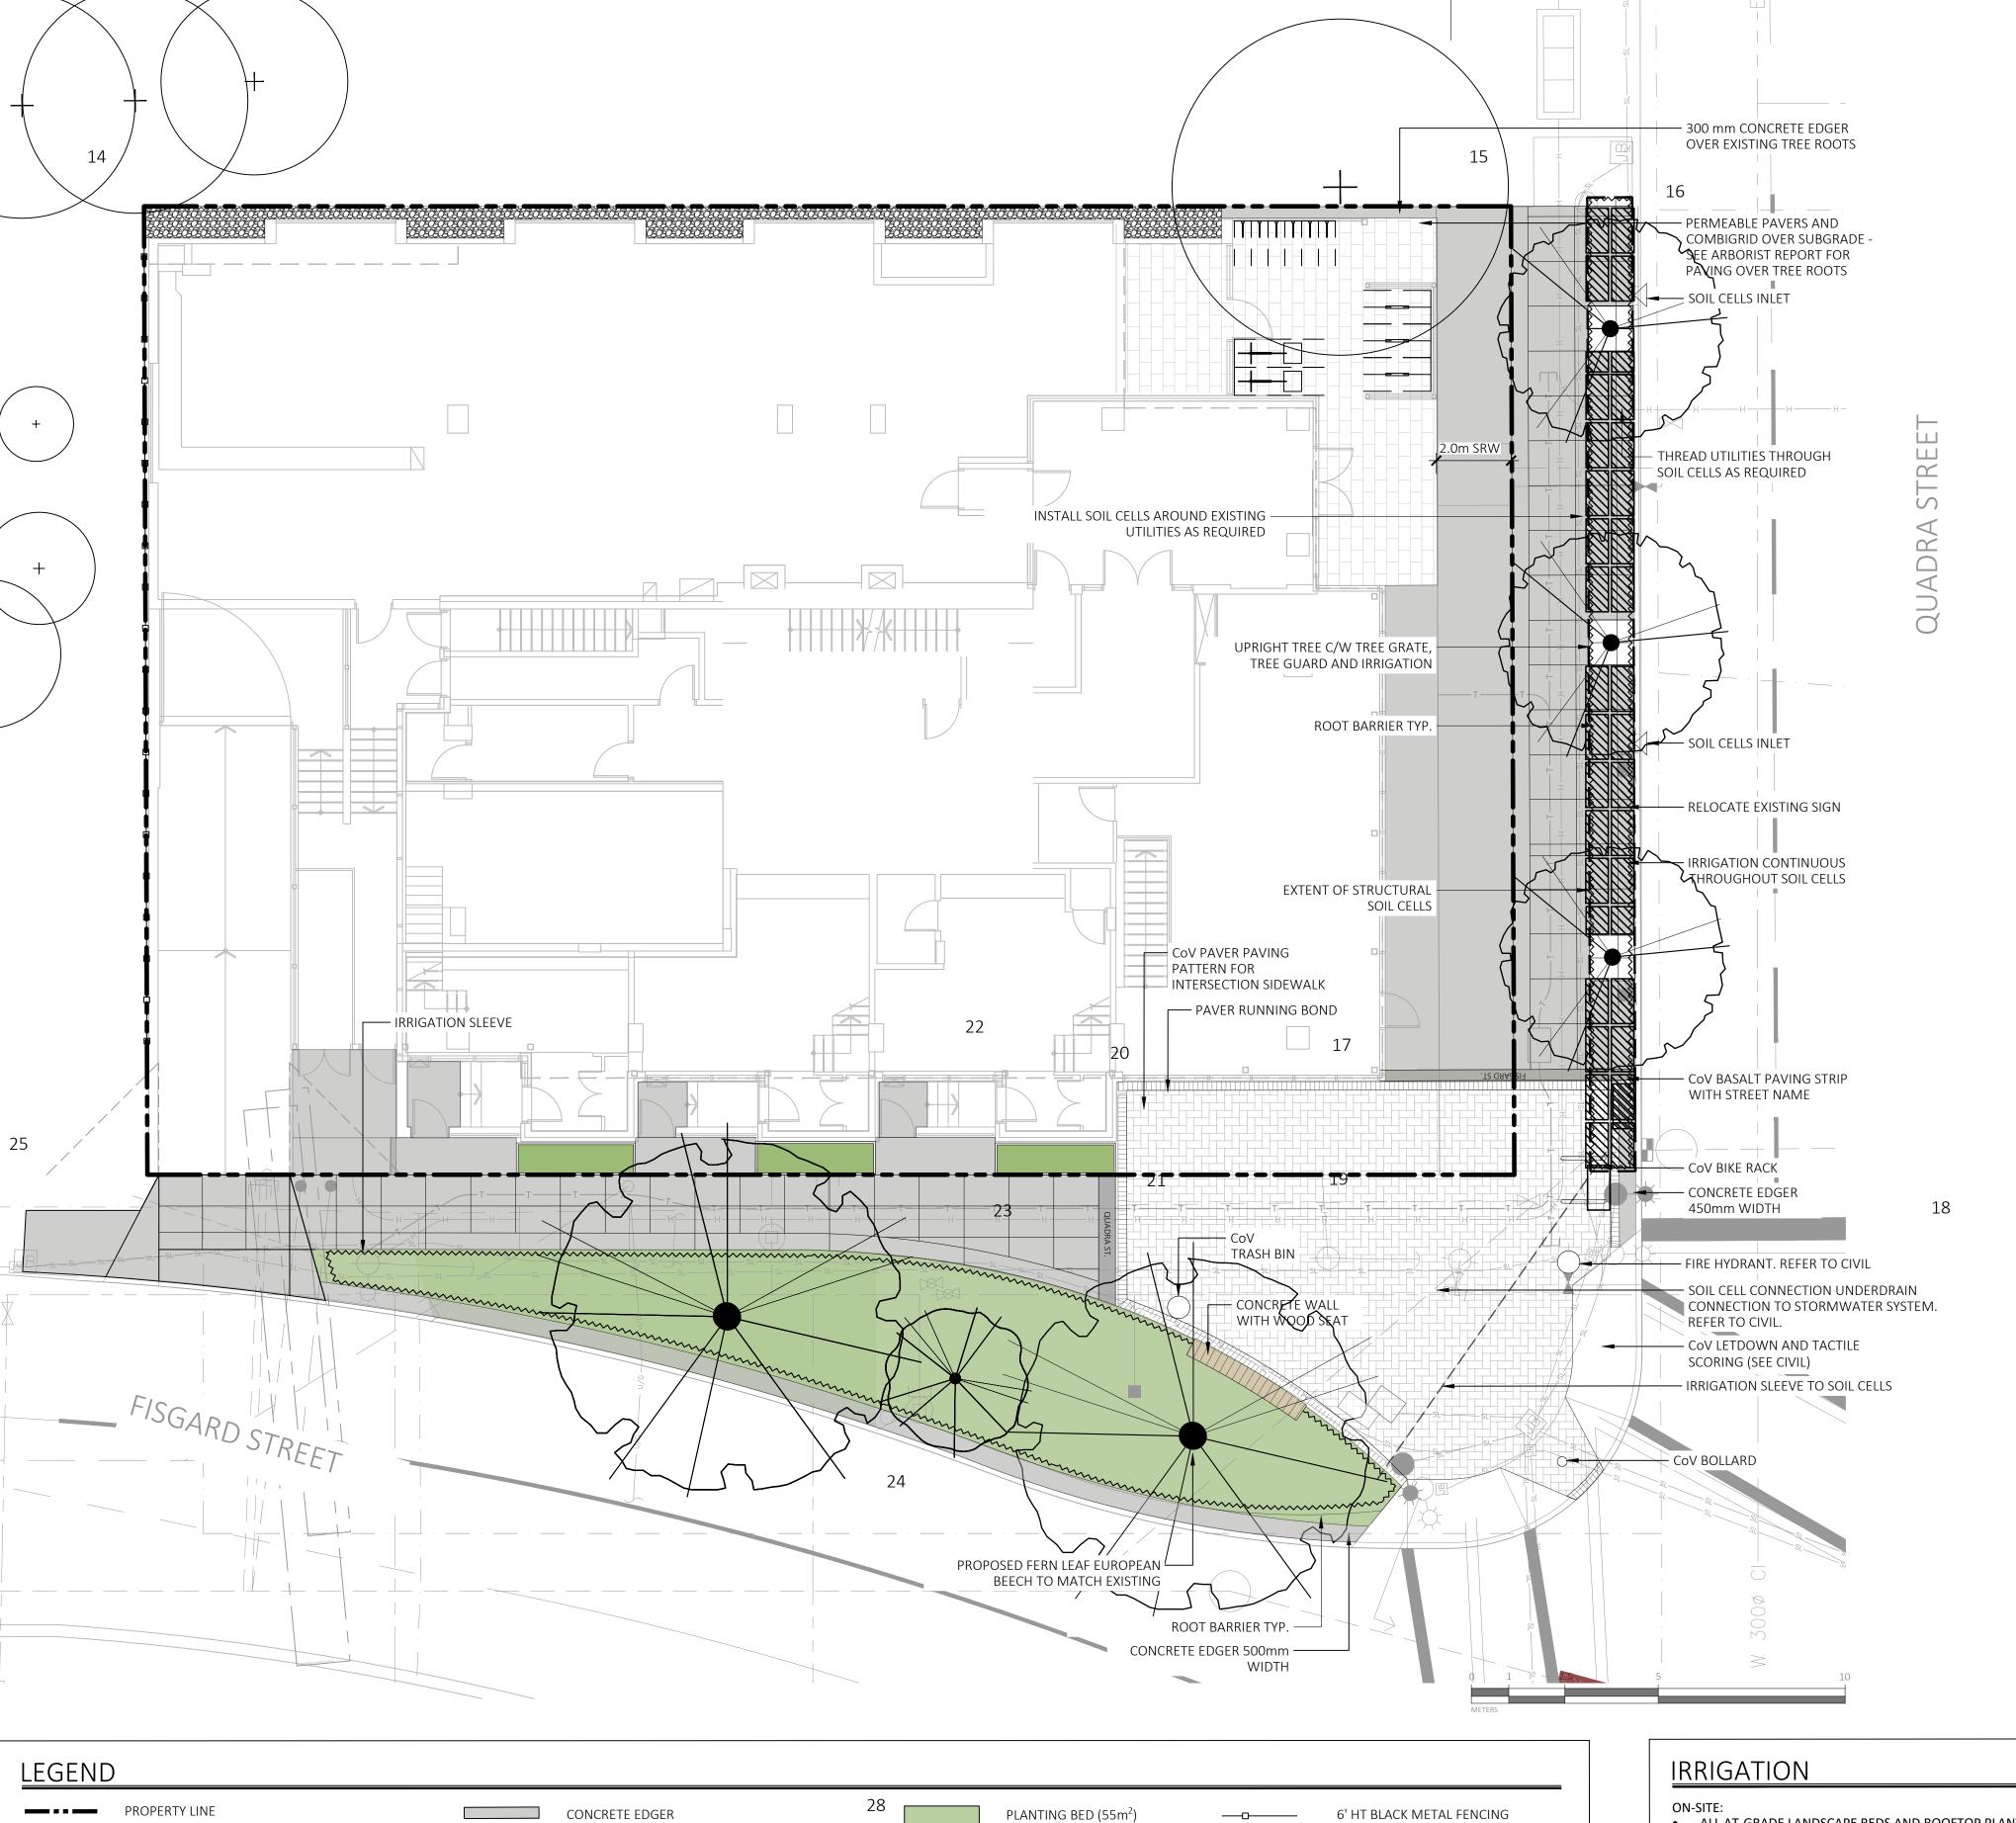

• 700mm DEPTH 1L GROWING

450mm DEPTH 1L GROWING

50 mm DEPTH MULCH

MEDIUM (CLS)

ON-SITE PLANTING BED

MEDIUM (BCLS)

PROPOSED MUNICIPAL

STREET TREE

ROOT BARRIER

• 50 mm DEPTH MULCH

WIDTH AND DEPTH VARIES

BASALT PAVER BANDING

MORTAR SET

SUBGRADE

COLOUR: NATURAL

ALUMINIUM EDGER

MEDIUM

IRRIGATION

GRAVEL MAINTENANCE STRIP

300mm DEPTH RIVER ROCK

STRUCTURAL SOIL CELLS (34.67m²)

• 1400mm DEPTH SOIL CELL GROWING

ACCENT PAVING

SEE DRAWINGS AND DETAILS

450 - 500mm WIDTH - AS NOTED

PERMEABLE PAVER ON COMBIGRID OVER

BELGARD AQUALINE PERMEABLE PAVER

— — — SRW

2.0m WIDTH ON QUADRA STREET

GUIDELINE STANDARDS

SAW CUT JOINTING PATTERN

SIDEWALK INTERSECTION PAVING

GUIDELINE STANDARDS

SIDEWALK STREET NAME PAVING

GUIDELINE STANDARDS

TO CITY OF VICTORIA 'NEW TOWN' DESIGN

TO CITY OF VICTORIA 'NEW TOWN' DESIGN

ABBOTSFORD CONCRETE; NATURAL GREY

TO CITY OF VICTORIA 'NEW TOWN' DESIGN

BASALT PAVING STRIP WITH STREET NAME

LINE OF FOUNDATIONS

CONCRETE SIDEWALK

LIGHT BROOM FINISH

PLACED ON SAND BED

MORTAR SET

POLYMERIC SAND JOINTS

ALONG WEST PROPERTY LINE

MUNICIPAL SITE FURNITURE

BOLLARD (2)

TRASH BIN (1)

BIKE RACK (2)

SEAT WALL

TREE GRATE (3)

TREE GUARD (3)

CONCRETE BASE, ARCHITECTURAL

CUSTOM WOOD SEAT TOP

- ALL AT-GRADE LANDSCAPE BEDS AND ROOFTOP PLANTERS TO BE IRRIGATED WITH AN AUTOMATIC IRRIGATION SYSTEM.
- DETAILED IRRIGATION PLAN TO BE SUBMITTED TO PARKS FOR REVIEW A MINIMUM OF 30
- DAYS PRIOR TO INSTALLATION.
- ALL IRRIGATION DESIGNS AND INSTALLATIONS SHALL MEET THE MINIMUM STANDARDS OF THE IRRIGATION INDUSTRY ASSOCIATION OF B.C. (IIABC).

OFF-SITE (MUNICIPAL)

- MUNICIPAL PLANTING BED AND STREET TREES TO BE IRRIGATED BY A SEPARATE SYSTEM FROM A SEPARATE CITY SOURCE CONFORMING TO THE CITY OF VICTORIA SUPPLEMENTARY SPECIFICATIONS FOR STREET TREES AND IRRIGATION SCHEDULE C TO BYLAW 12-042,
- SUBDIVISION BYLAW. IRRIGATION DESIGN DRAWINGS MUST BE SENT TO PARKS FOR REVIEW 30 DAYS PRIOR TO
- INSTALLATION. DRAWINGS SHOULD INDICATE ALL COMPONENTS, MODELS AND MATERIALS FROM WATER
- SUPPLY TO IRRIGATION HEADS.
- THE CITY WILL REQUIRE 4 INSPECTIONS FOR IRRIGATION INSTALLATION: 1)SLEEVING, 2) OPEN TRENCH MAINLINE AND PRESSURE TEST,

3) OPEN TRENCH AND LATERAL LINE, 4) OPERATION AND COVERAGE, AND 5) BACKFLOW PREVENTER ASSEMBLY TEST REPORT

CITY OF VICTORIA DOWNTOWN REALM PLAN AND STREETSCAPE STANDARDS - NEW TOWN

NEW TOWN PAVING MATERIALS

Installation Method: Cast-in-place

Colour: Natural

Finish: Fine broom finish

Application: Sidewalk fill and frame






• Dimensions: 225mm x 75mm x 60

· Application: Paving field

Colours: Natural grey

• Finish: Unsealed

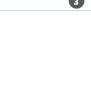





Colour: Charcoal grey

Finish: Flamed



• Dimensions: 300mm x 450mm x 60mm 1608 Camosun Street, Victoria BC V8T 3E6 Installation Method: Mortar set Info@biophiliacollective.ca 250 590 1156 Application: Entry banding


PROJECT NAME:

THE ABBEY

PROJECT ADDRESS:

1702 QUADRA STREET VICTORIA, BC

DESIGNED BY: BIANCA BODLEY DRAWN BY: KIM TANG

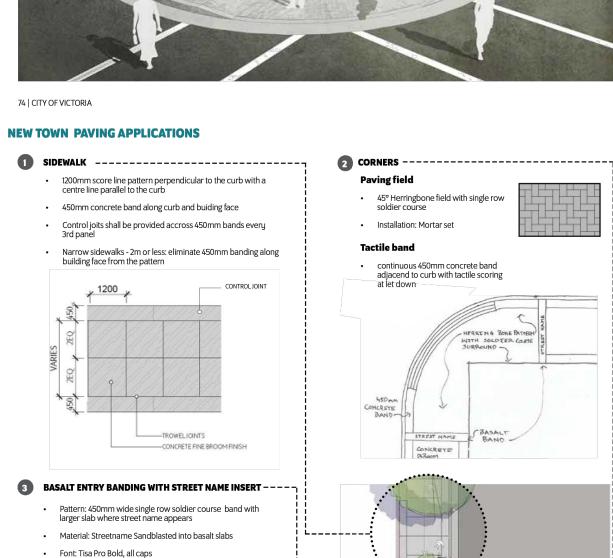

Note: Care should be taken to the letter spacing and kerning

DOWNTOWN PUBLIC REALM PLAN STRATEGY + STREETSCAPE PLAN | 75


NEW TOWN PLANTING DETAILS


APPLICATION For all sidewalks in New Town area there are be two types of trees-in-sidewalk condition:


1. Adaptation of existing tree locations to sidewalk improvements: accommodate for existing tree locations. Detailed design and recommendations to be provided on a case-by-case basis for each improvement area. Use of proposed poured-in-place resin bound material instead of tree grates is highly recommended to best accommodate heaving and overgrown tree routes and large tree trunks.

2. New development condition:

 A street tree spacing of between 8 - 10 metres is desired Tree grates should be set in a concrete band that runs across the sidewalk from curb to building face as illustrated on the diagram below with trowel joint defining the band always aligned with tree grates Street trees should be sited to correspond with architectural features of building

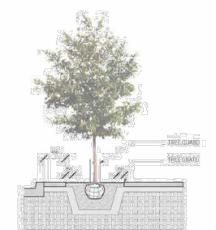

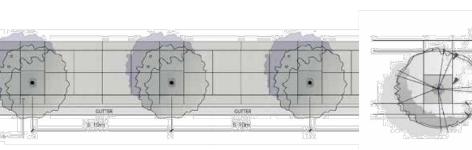


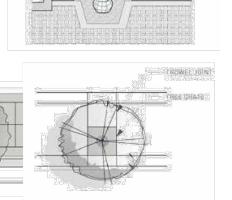

Tree grates define bands in the

the diagram above

sidewalk pattern as illustrated on

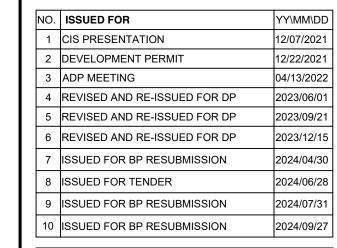








DRAWING TITLE:

LANDSCAPE SITE PLAN

DWG NO:



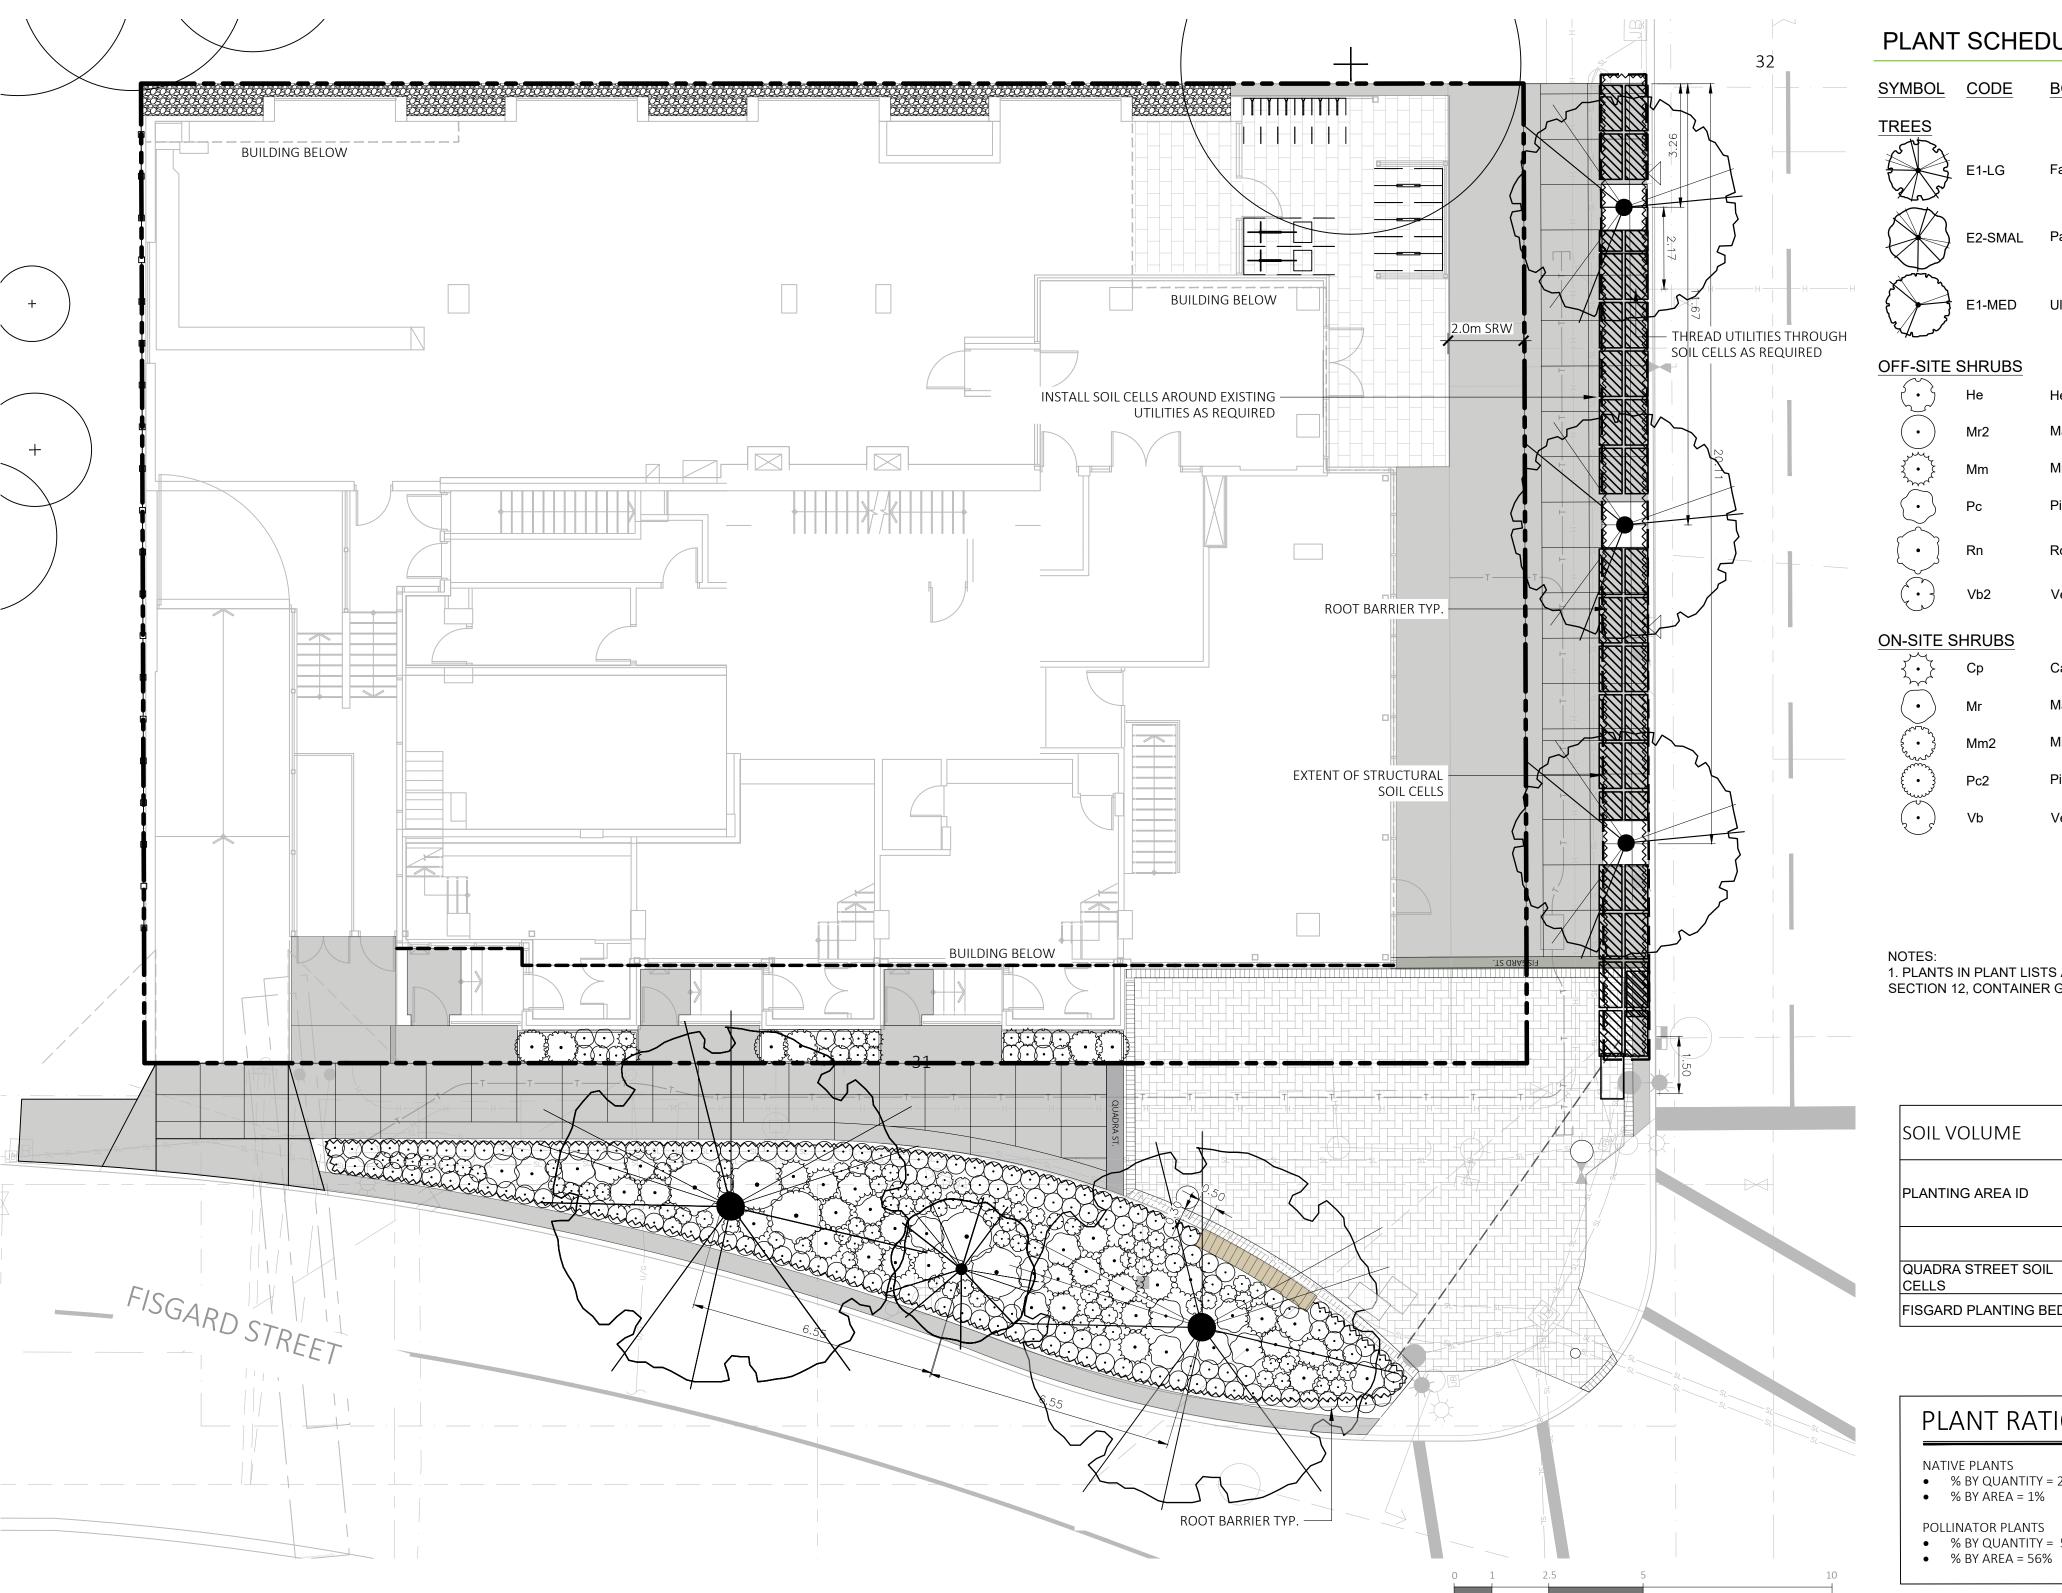

PLANT SCHEDULE MAIN LEVEL

| | SYMBOL | CODE | BOTANICAL / COMMON NAME | SIZE | SPACING | COMMENTS | QTY | 3 |
|-----|--|---------|--|-----------|----------|-------------------------------------|-----|----|
| | TREES | | | | | | | |
| | 3 | E1-LG | Fagus sylvatica heterophylla 'Aspleniifolia' / Fernleaf European Beech | 70mm Cal. | As Shown | SPECIES T.B.D. BY PARKS AT BP STAGE | 2 | |
| | | E2-SMAL | Parrotia persica / Persian Parrotia | 70mm Cal. | As Shown | SPECIES T.B.D. BY PARKS AT BP STAGE | 1 | |
| - H | | E1-MED | Ulmus x 'Lobel' / Lobel Elm | 70mm Cal. | As Shown | SPECIES T.B.D. BY PARKS AT BP STAGE | 3 | 3 |
| | OFF-SITE | SHRUBS | | | | | | |
| | | He | Hebe x 'Emerald Green' / Emerald Green Hebe | #2 POT | 450mm | Full, Well Established | 62 | |
| | • | Mr2 | Mahonia repens / Creeping Mahonia | #2 POT | 500mm | Full, Well Established | 117 | |
| |) • | Mm | Miscanthus sinensis 'Morning Light' / Morning Light Eulalia Grass | #3 POT | 900mm | Full, Well Established | 27 | |
| | | Pc | Pinus mugo 'Compacta' / Dwarf Mugo Pine | #3 POT | 900mm | Full, Well Established | 16 | |
| | | Rn | Rosa nutkana / Nootka Rose | #2 POT | 1500mm | Full, Well Established | 5 | |
| | | Vb2 | Verbena bonariensis / Tall Verbena | #1 POT | 450mm | Full, Well Established | 29 | |
| | ON-SITE S | HRUBS | | | | | | |
| | | Ср | Carex testacea 'Prairie Fire' / Prairie Fire Orange Sedge | #1 POT | 500mm | Full, Well Established | 8 | |
| | • | Mr | Mahonia repens / Creeping Mahonia | #2 POT | 500mm | Full, Well Established | 8 | |
| | ~~~~~~~~~~~~~~~~~~~~~~~~~~~~~~~~~~~~~~ | Mm2 | Miscanthus sinensis 'Morning Light' / Morning Light Eulalia Grass | #3 POT | 900mm | Full, Well Established | 3 | |
| | £ • 33 | Pc2 | Pinus mugo 'Compacta' / Dwarf Mugo Pine | #2 POT | 900mm | Full, Well Established | 3 | |
| | (·) | Vb | Verbena bonariensis / Tall Verbena | #1 POT | 450mm | Full, Well Established | 7 | 3. |

1. PLANTS IN PLANT LISTS ARE SPECIFIED ACCORDING TO THE CANADIAN NURSERY LANDSCAPE ASSOCIATION CANADIAN STANDARDS FOR NURSERY STOCK AND SECTION 12, CONTAINER GROWN PLANTS FROM THE BC LANDSCAPE STANDARD, CURRENT EDITION.

| SOIL VOLUME | | | | REPLACEMENT TREES PROPOSED | | | SOIL VOLUME REQUIRED (m3) | | | |
|-----------------------------|-----------|--------|----------------------------|-------------------------------|---|---------------|---------------------------|--------------|-------------|-------|
| PLANTING AREA ID | AREA (m2) | sc | A.ESTIMATED SOIL VOLUME | B. # SMALL | | D. # LARGE | | F. MEDIUM | G. LARGE | TOTAL |
| | | | ON-SITE | AREA ₆ | • | | | | 1 | |
| QUADRA STREET SOIL CELLS | 34 | 1.4000 | 45 | | 3 | | | 15 | | 45 |
| FISGARD PLANTING BED | 55 | 1 | 67 | 1 | | 1 | 6 | | 30 | 36 |

PLANT RATIOS - OFF SITE

- NATIVE PLANTS
- % BY QUANTITY = 2%% BY AREA = 1%
- POLLINATOR PLANTS
- % BY QUANTITY = 56%

PLANT RATIOS - ON SITE

MUNICIPAL BOULEVARD TREES

WITH BRANCHING STARTING AT 1.8m-2.5m ABOVE GROUND

• PARKS WILL REQUIRE (3) INSPECTIONS FOR TREE PLANTING:

1) INSPECTION OF SOIL AND PLANTING AREA,

2) INSPECTION OF STOCK UPON DELIVERY, AND

• TREES MUST HAVE ONE DOMINANT CENTRAL LEADER OR SINGLE STRAIGHT TRUNK, 5-8 cm DIAMETER, CALIPER MEASURED 15 cm ABOVE GROUND, WELL BALANCED CROWN

• TREES TO BE PLANTED AS PER PLANTIG OF TREES, SHRUBS AND GROUND COVERS (32 93 01 MMCD 2009 AND CITY OF VICTORIA SUPPLEMENTAL DRAWINGS SD P3 AND SD P4)

3) INSPECTION OF INSTALLED TREE WITH MULCH AND STAKING. TRUNK FLARE MUST BE

VISIBLE AND PLANTED AT OR SLIGHTLY ABOVE GRADE UPON INSPECTION • THE APPLICANT IS RESPONSIBLE FOR PROCURING AND PLANTING THE PROPOSED

CONDITION FOR 1 YEAR FROM THE SUBSTANTIAL COMPLETION TO BE ELIGIBLE FOR

THE APPLICANT MUST MAINTAIN THE TREE IN GOOD HEALTH AND STRUCTURAL


- NATIVE PLANTS
- % BY QUANTITY = 0%% BY AREA = 0%
- POLLINATOR PLANTS

BOULEVARD TREES.

DEPOSIT RETURN.

• % BY QUANTITY = 80% % BY AREA = 50%

SHRUBS + PERENNIALS

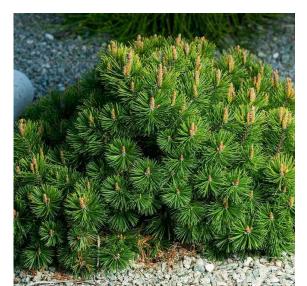

DWARF MUGO PINE



EMERALD GREEN HEBE





CREEPING MAHONIA



MISCANTHUS





PRAIRIE FIRE SEDGE



NOOTKA ROSE

PRE-CONSTRUCTION MEETING

 PARKS REQUIRES A PRE-CONSTRUCTION MEETING TO BE HELD PRIOR TO COMMENCEMENT OF CONSTRUCTING THE FRONTAGE WORKS



1608 Camosun Street, Victoria BC V8T 3E6 Info@biophiliacollective.ca 250 590 1156

PROJECT NAME:

THE ABBEY

PROJECT ADDRESS:

1702 QUADRA STREET VICTORIA, BC

DESIGNED BY: BIANCA BODLEY DRAWN BY: KIM TANG

NO. **ISSUED FOR** YY\MM\DD 1 CIS PRESENTATION 2 DEVELOPMENT PERMIT 3 ADP MEETING 4 REVISED AND RE-ISSUED FOR DP 5 REVISED AND RE-ISSUED FOR DP 6 REVISED AND RE-ISSUED FOR DP ISSUED FOR BP RESUBMISSION ISSUED FOR TENDER 9 ISSUED FOR BP RESUBMISSION 10 ISSUED FOR BP RESUBMISSION





NORTH ARROW

DRAWING TITLE:

PLANTING PLAN -**GROUND FLOOR**

DWG NO:

1608 Camosun Street, Victoria BC V8T 3E6

PROJECT NAME:

THE ABBEY

PROJECT ADDRESS:


VICTORIA, BC

DESIGNED BY: BIANCA BODLEY

DRAWN BY: KIM TANG


1702 QUADRA STREET

Info@biophiliacollective.ca 250 590 1156

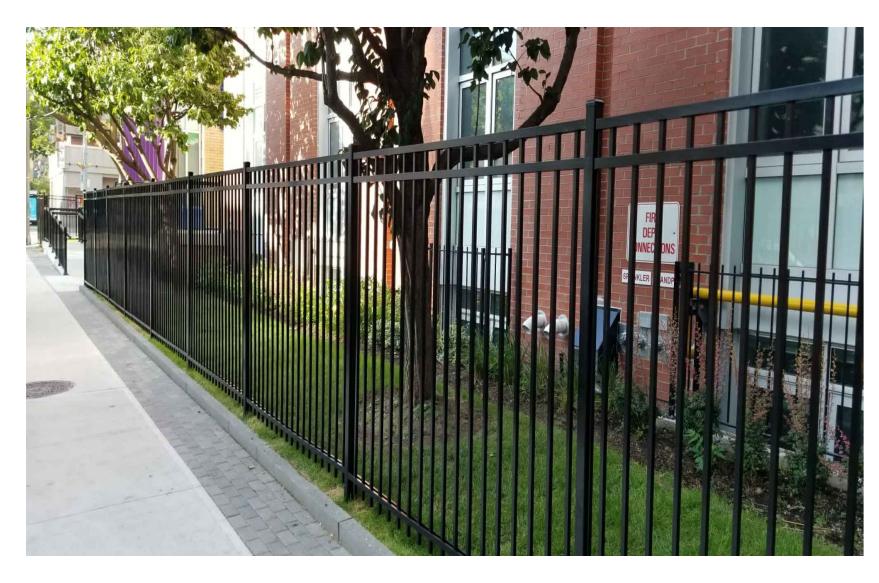

1 6' HT METAL PICKET FENCE

L3 NTS

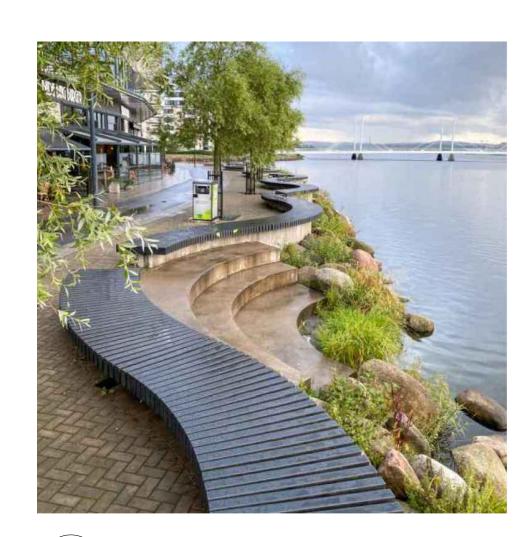

CUSTOM SEAT WALL BENCH

L3 NTS



BELGARD AQUALINE PERMEABLE PAVER

Smooth surface with a microchamfer to minimize vibration and enhance wheelchair comfort Can be utilized to construct an ADA-compliant pavement

True installed dimensions for design optimization Optimal joint openings for

infiltration and maintenance

Can eliminate stormwater runoff

 Interlocking spacer bars for increased structural performance

and improve water quality Meets the requirements of ASTM Chamfer Width: 3 mm Spacer Bar Width: 10 mm Surface Infiltration Rate: > 500

inches per hour (varies based on joint infill gradation) Surface Open Area: 10% Can be installed mechanically

♦ AVAILABLE COLOURS







SHAPES & SIZES

45/16 x 83/4 x 31/8" 110 x 221.5 x 80mm

DURAFUSION™ Unmatched Durability

PRODUCT TYPE:

MODERN METAL BIN


PRODUCT NAME: DESIGN STYLE: MATERIALS: COLOUR/FINISH:

Type A Litter Bin with Recycling Component

Modern Metal Bin Modern Metal Frame Glossy Black (RAL 9017) Baked-on

Powder Coat 42" Height Inner Harbour, Old Town, Rock Bay, New Town, Government Street,

Douglas Street City of Victoria See Character area section of Streetscape Standards for specific location guidelines.

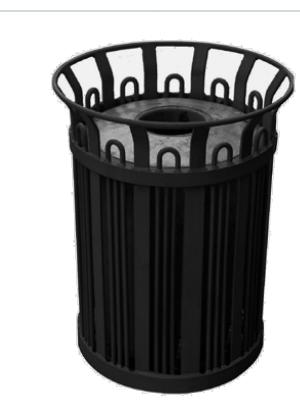

4 NEW TOWN BOLLARD
L3 NTS

L3 NTS

RELIANCE FOUNDRY BOLLARD

Type B Bollard

Ductile Iron

35" Height

Douglas Street

Reliance Foundry

Reliance Foundry Bollard

Glossy Black (RAL 9017) Baked-on

Inner Harbour, Old Town, Rock Bay,

Surface Mount, Bolted to Concrete

New Town, Government Street,

See Character area section of

Streetscape Standards for specific

5 NEW TOWN LITTER RECEPTACLE


STANDARD BIKE RACK

1.5" Galvanized Steel Pipe Glossy Black (RAL 9017) Baked-on Powder Coat

12" Length, 3' Height

Inner Harbour, Old Town, Rock Bay, New Town, Government Street,


Douglas Street Sleeve Mount See Character area section of Streetscape Standards for specific location guidelines.

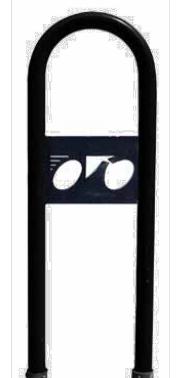

6 NEW TOWN BIKE RACK
L3 NTS




7 NEW TOWN TREE GUARD L3 NTS

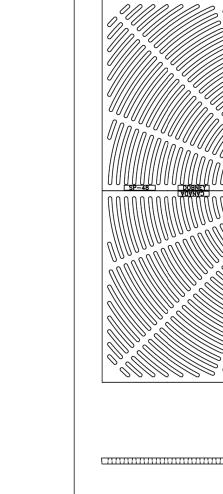


TREE GUARD FABRICATED BY

TO ORDER CONTACT PARKS DIVISION: 250-361-0600

COV PUBLIC WORKS

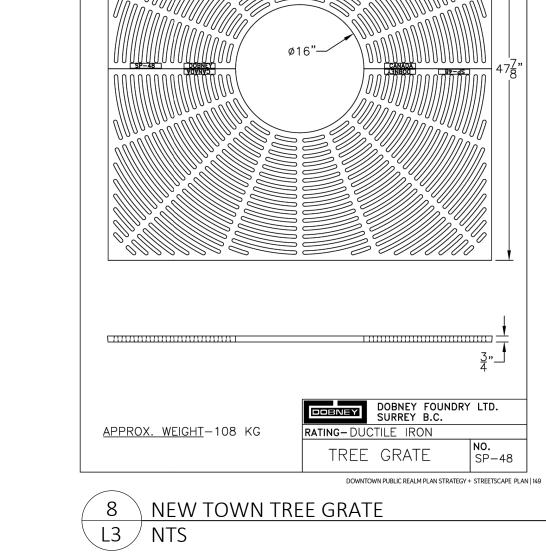

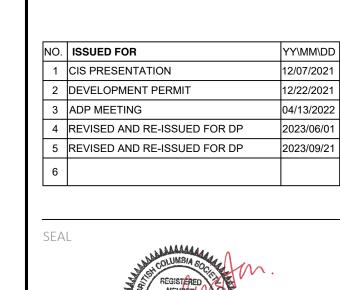







DRAWING TITLE:

LANDSCAPE SITE PLAN

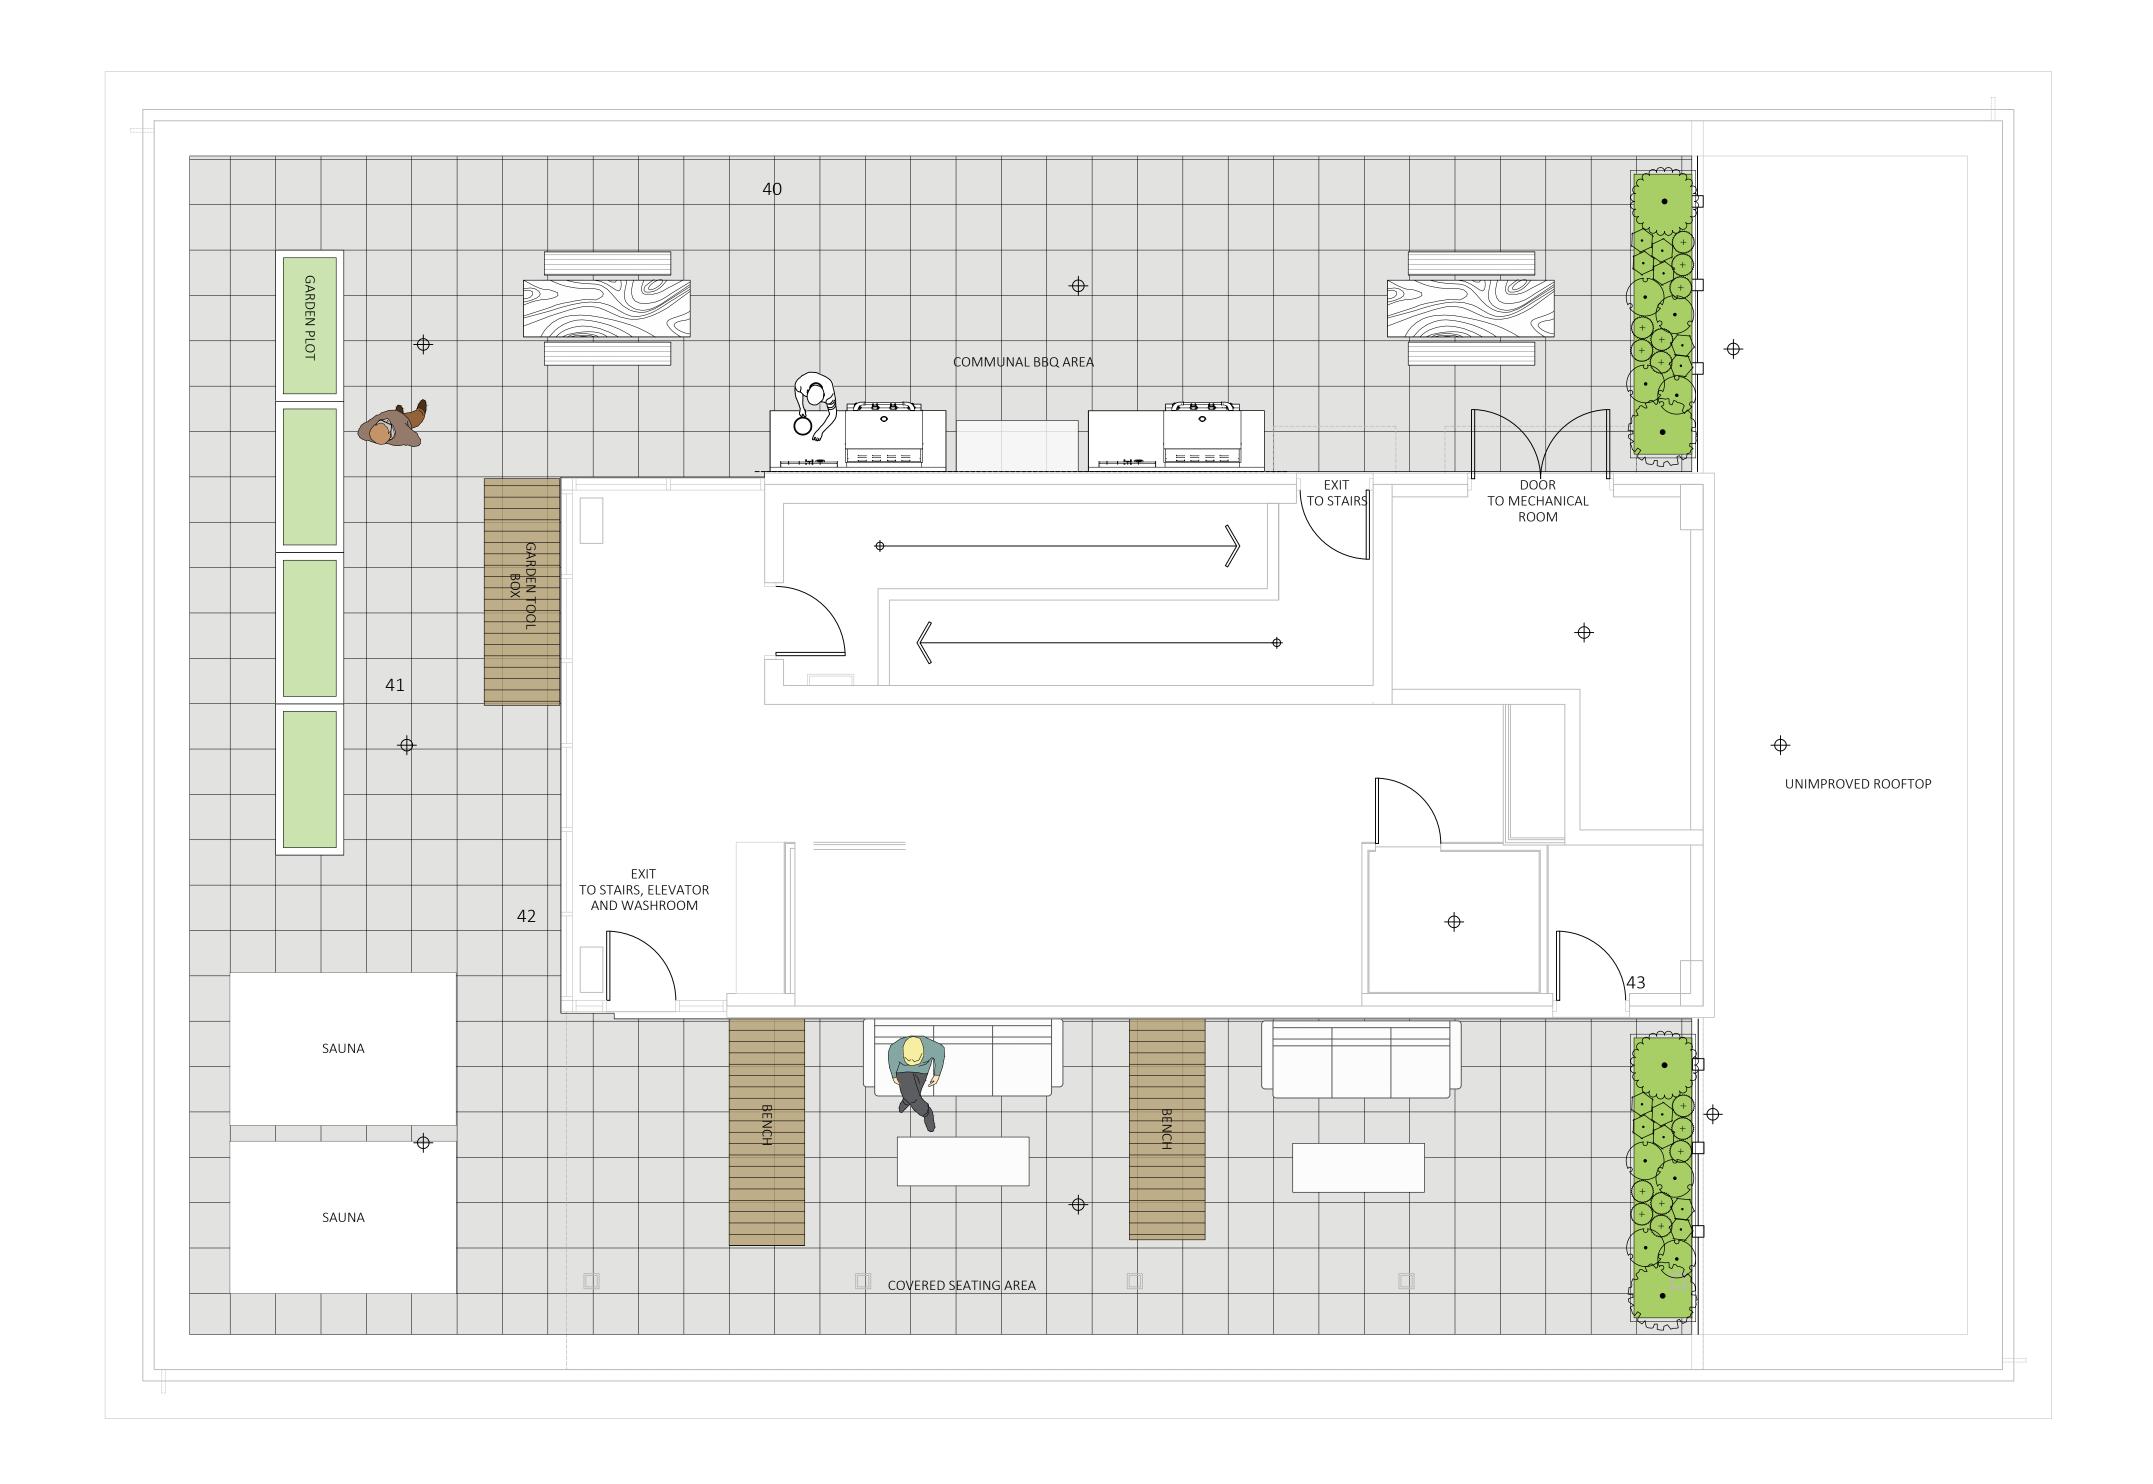

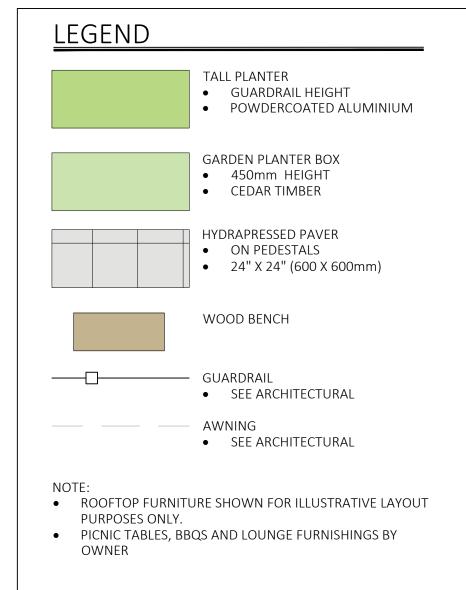



DESIGNED BY: BIANCA BODLEY DRAWN BY: KIM TANG

| NO. | ISSUED FOR | YY\MM\DD |
|-----|------------------------------|------------|
| 1 | CIS PRESENTATION | 12/07/2021 |
| 2 | DEVELOPMENT PERMIT | 12/22/2021 |
| 3 | ADP MEETING | 04/13/2022 |
| 4 | REVISED AND RE-ISSUED FOR DP | 2023/06/01 |
| 5 | REVISED AND RE-ISSUED FOR DP | 2023/09/21 |
| 6 | REVISED AND RE-ISSUED FOR DP | 2023/12/15 |
| 7 | ISSUED FOR BP RESUBMISSION | 2024/04/30 |
| 8 | ISSUED FOR TENDER | 2024/06/28 |
| 9 | ISSUED FOR BP RESUBMISSION | 2024/07/31 |
| 10 | ISSUED FOR BP RESUBMISSION | 2024/09/27 |







DRAWING TITLE:

SITE PLAN - ROOFTOP **AMENITY**





DWG NO:


Full, Well Established 14 Full, Well Established 1 Full, Well Established 2 Full, Well Established 6 SCALE: **1:50**

QTY

COMMENTS

Full, Well Established 15

Full, Well Established 3

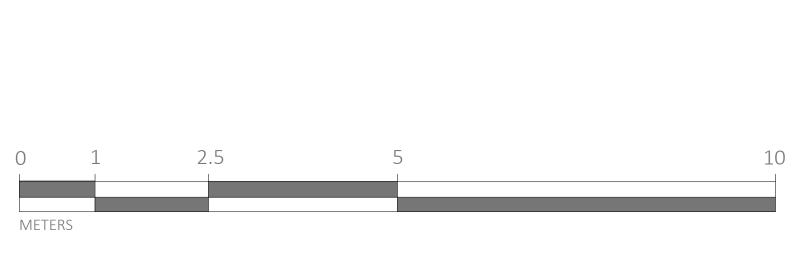



FIREFLY HEATHER

DWARF MUGO PINE




PRAIRIE FIRE SEDGE



CREEPING MAHONIA





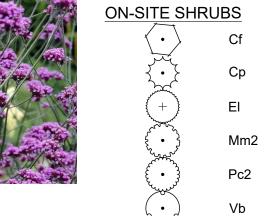

BOTANICAL / COMMON NAME

Calluna vulgaris 'Firefly' / Firefly Heather

Carex testacea 'Prairie Fire' / Prairie Fire Orange Sedge

#1 POT

#1 POT

#2 POT

#1 POT

PLANT SCHEDULE ROOFTOP

VERBENA