

CITY OF
VICTORIA

Revisions

Received Date:
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A811	VIEW NORTHWEST FROM CORNER OF PANDORA & COOK	NTS
A812	VIEW WEST THROUGH RESIDENTIAL MEWS	NTS
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MICHAEL GREEN ARCHITECTURE
1535 W 3RD AVENUE, VANCOUVER BC
CANADA V6J 1J8

2020-03-20	3	REVISED FOR REZONING
2019-10-30	2	REVISED FOR REZONING
2019-09-13	1	REVISED FOR REZONING
2019-05-15	0	ISSUED FOR REZONING

DATE	REVISION	DESCRIPTION
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PARKWAY

1050 PANDORA AVE + 1518 COOK STREET
VICTORIA, BC
2018-001

PROJECT NARRATIVE

The Parkway Revitalization and Development is located at Pandora Avenue & Cook Street, at the site of what is known to the community as the Wellburns Building. Originally named Parkway apartments, the two-storey masonry building was constructed in 1911 by William Ridgway-Wilson. At the corner of the North Park neighbourhood, the building is a gateway feature to both the neighbourhood and the centre of Victoria.

The new development proposes a 4 & 6 storey volume stepping back from the existing heritage building to the north & west, and from Franklin Green Park to the south & east. 103 purpose-built rental apartments are proposed with a retail / commercial space being maintained on the existing ground floor of the Wellburn’s Building and the addition of a cafe space in the ground floor of the new addition facing Cook Street. A mews separating the historic and modern buildings at street level serves as the residential entrance to the building and provides access to a west facing courtyard. Public access to and from Franklin Green Park is provided through a wide pedestrian walkway along the north edge of the site. One level of underground parking will be provided below the project site.

A priority of the project is to conserve the heritage value of the Wellburn’s building through retaining 50% of the existing volume, including the historic facades facing Pandora Ave & Cook St and the north-east wall facing the residential mews. All character-defining

elements in these locations will be preserved along with any in-kind repairs, as required. The original use of the building will remain with opportunities for multiple retail spaces on the ground floor & residential suites above. The building will be Designated Heritage with the Heritage Registry.

The new development will be clad in a large format, pearl coloured, ultra high performance concrete panel. It will borrow elements from its historic counterpart, including the running bond pattern of the glazed white brick, the rhythm, proportion & angles of the projecting oriel windows and the recessed entryways of the existing storefronts.

To create a strong visual connection with the surrounding context, juliet balconies will be provided in the living spaces of the suites directly facing Franklin Green Park & Harris Green Park. An accessible roof deck will also be provided for all residential tenants of the building, facing onto Franklin Green Park.

PROJECT NAME

Parkway

PROJECT ADDRESS

1050 Pandora Ave + 1518 Cook Street

LEGAL DESCRIPTION

Lots 1 and 2, Suburban Lot 15, Victoria, VIP73211

PROJECT TEAM

OWNER

Pandora Cook Development Corp.

District Developments Corp.

200- 8809 Heather Street, Vancouver, BC, V6P 3T1

Primary Contact

Andrew Rennison

604-736-1866

AGENT

DISTRICT DEVELOPMENTS CORP.

200- 8809 Heather Street, Vancouver, BC, V6P 3T1

Primary Contact

Jessica Gibson

604-322-5762

ARCHITECT

MGA | Michael Green Architecture

1535 West 3rd Avenue, Vancouver, BC, V6J 1J8

Architect

Michael Green

Contact

Jordan Van Dijk

604-336-4770

PROPOSED ZONING

New Site-Specific Zone

Changed from R-2 (Two Family Dwelling District) at 1518 Cook Street, and CA-1 (Pandora Avenue Special Commercial District) at 1050 Pandora Avenue.

SITE AREA

2879 m²

AVERAGE GRADE

27.54m (See A004 for average grade calculations)

Note that the project ground floor is set at a geodetic elevation of 27.56m and building levels are dimensioned from that elevation.

PROPOSED HEIGHT

20.22 m taken from average grade. Note that 321mm parapet is excluded from proposed height.

ALLOWABLE HEIGHT

30m/ 8-10 storeys per OCP

APPLICABLE BUILDING CODE

BCBC 2018

STREETS FACING

Pandora Avenue to the South

Cook Street to the East

OCCUPANCY CLASSIFICATIONS

3.2.2.50. Group C, up to 6 Storeys,

Sprinklered- Residential Occupancies

3.2.2.50. Group E, up to 6 Storeys,

Sprinklered- Mercantile Occupancies,

Located below the third storey.

3.2.2.82 Group F, Division 3, Up to 6 Storeys,

Sprinklered- Below Grade Parkade.

AREA CALCULATIONS

LEVEL 0	2,713.6	m2
LEVEL 1	1832.82	m2
LEVEL 2	1990.02	m2
LEVEL 3	1408.55	m2
LEVEL 4	1399.30	m2
LEVEL 5	921.02	m2
LEVEL 6	860.58	m2

PROPOSED FSR	8,412.3	m2
ALLOWABLE FSR	9,330	m2
PROPOSED FSR RATIO	2.9	
ALLOWABLE FSR RATIO	3.3	

UNIT TYPES	No#	%
STUDIO	4	4%
STUDIO & DEN	7	7%
1 BED	53	51%
1 B & DEN	24	23%
2 BED	11	11%
2 BED & DEN	4	4%

TOTAL

103

PROPOSED HEIGHT

20.221m

TOTAL RESIDENTIAL AREA

5884

m2

TOTAL RESIDENTIAL UNITS

103

TOTAL PARKING SPACES

44

PROVIDED

93

REQUIRED

TOTAL COMMERCIAL AREA

1054

m2

888.1

m2

RETAIL

165.7

m2

CAFÉ

55.6

m2

OUTDOOR SEATING

ORIGINAL HERITAGE BUILDING AREA

1891.9m2

TOTAL AREA TO BE RETAINED

947.6m2 | 50%

TOTAL BIKE PARKING

172

154

SHORT-TERM

18

LONG-TERM

UNIT CALCULATIONS

CITY	m2	L1	L2	L3	L4	L5	L6	TOTAL
STUDIO A	56.0			1	1			2
STUDIO B	52.6				1		1	2
ST & DEN A	66.0		4					4
ST & DEN B	72.7		1					1
ST & DEN C	57.7			1				1
ST & DEN D	53.6			1				1

1 BED A	52.1	1	1	1	1			4
1 BED B	52.8	1	1	1	1			4
1 BED C	56.1		1					1
1 BED D	48.3		1					1
1 BED E	48.6		1	1	1			3
1 BED F	51.6			5		5		10
1 BED G	46.8			1		1		2
1 BED H	36.2					1		1
1 BED I	51.1				5		5	10
1 BED J	36.7			1	1	1	1	4
1 BED K	47.8			1	1	1	1	4
1 BED L	53.4					1		1
1 BED M	45.0					1		1
1 BED N	48.4					1		1
1 BED O	49.0						1	1
1 BED P	48.6						1	1
1 BED Q	49.0					1		1
1 BED R	51.9	1						1
1 BED S	51.1						1	1
1 BED T	45.0						1	1

1 B&D A	61.5	1						1
1 B&D B	51.6				1			1
1 B&D C	62.2	1	2	2	2			7
1 B&D D	59.1		1					1
1 B&D E	51.4				1		1	2
1 B&D F	54.2			1		1		2
1 B&D G	51.0				1			1
1 B&D H	58.0			1				1
1 B&D I	62.2		1	1	1			3
1 B&D J	93.9		1					1
1 B&D K	81.2		1					1
1 B&D L	73.0	2						2
1 B&D M	68.7		1					1

2 BED A	72.5						1	1
2 BED B	68.8		1					1
2 BED C	73.5		1					1
2 BED D	60.0			1	1	1		3
2 BED E	79.5			1				1
2 BED F	67.2	1		1	1	1		3
2 BED G	75.4					1		1

2 B&D A	90.8		1					1
2 B&D B	96.1			1	1			2
2 B&D C	76.1			1				1

TOTAL UNITS			8	24	21	21	15	14	103
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PARKING CALCULATIONS

RESIDENTIAL PARKING

	Parking Rate	# of Units	Required	Provided
<45m2	0.50	5	2.5	3
45-70m2	0.60	85	51.0	23
>70m2	1.00	13	13.0	7
TOTAL RESIDENTIAL PARKING			67	33

VISITOR PARKING

Visitor Parking	Parking Rate	# of Units		
	0.10	103	10	4

COMMERCIAL PARKING

		Total Area (m2)		
Retail/ Grocery	1/ 80m2	888	11	2
Restaurant	1/ 40m2	221.7	6	3
TOTAL COMMERCIAL PARKING			17	5

CARSHARE PARKING

Modo Carshare Parking Stalls				
			2	44


TOTAL PARKING

BIKE PARKING | LONG TERM

		# of Units		
Residential	1 / unit <45m2 1.25 / unit >45m2	5 98	5 123	20 122
		Total Area (m2)		
Restaurant	1/ 400m2	221.7	1	6
Retail/ Grocery	1/ 200m2	888	5	6
TOTAL LONG TERM BIKE PARKING			133	154
		FLOOR-MOUNTED RACKS		78
		FLOOR-MOUNTED CARGO RACKS		40
		WALL-MOUNTED RACKS		36


BIKE PARKING | SHORT TERM

		Total Area (m2)	Total Units		
Residential	.1 / unit	-	103	10	10
Restaurant	1/ 100m2	221.7		3	3
Retail/ Grocery	1/ 200m2	888		5	5
TOTAL SHORT TERM BIKE PARKING				18	18

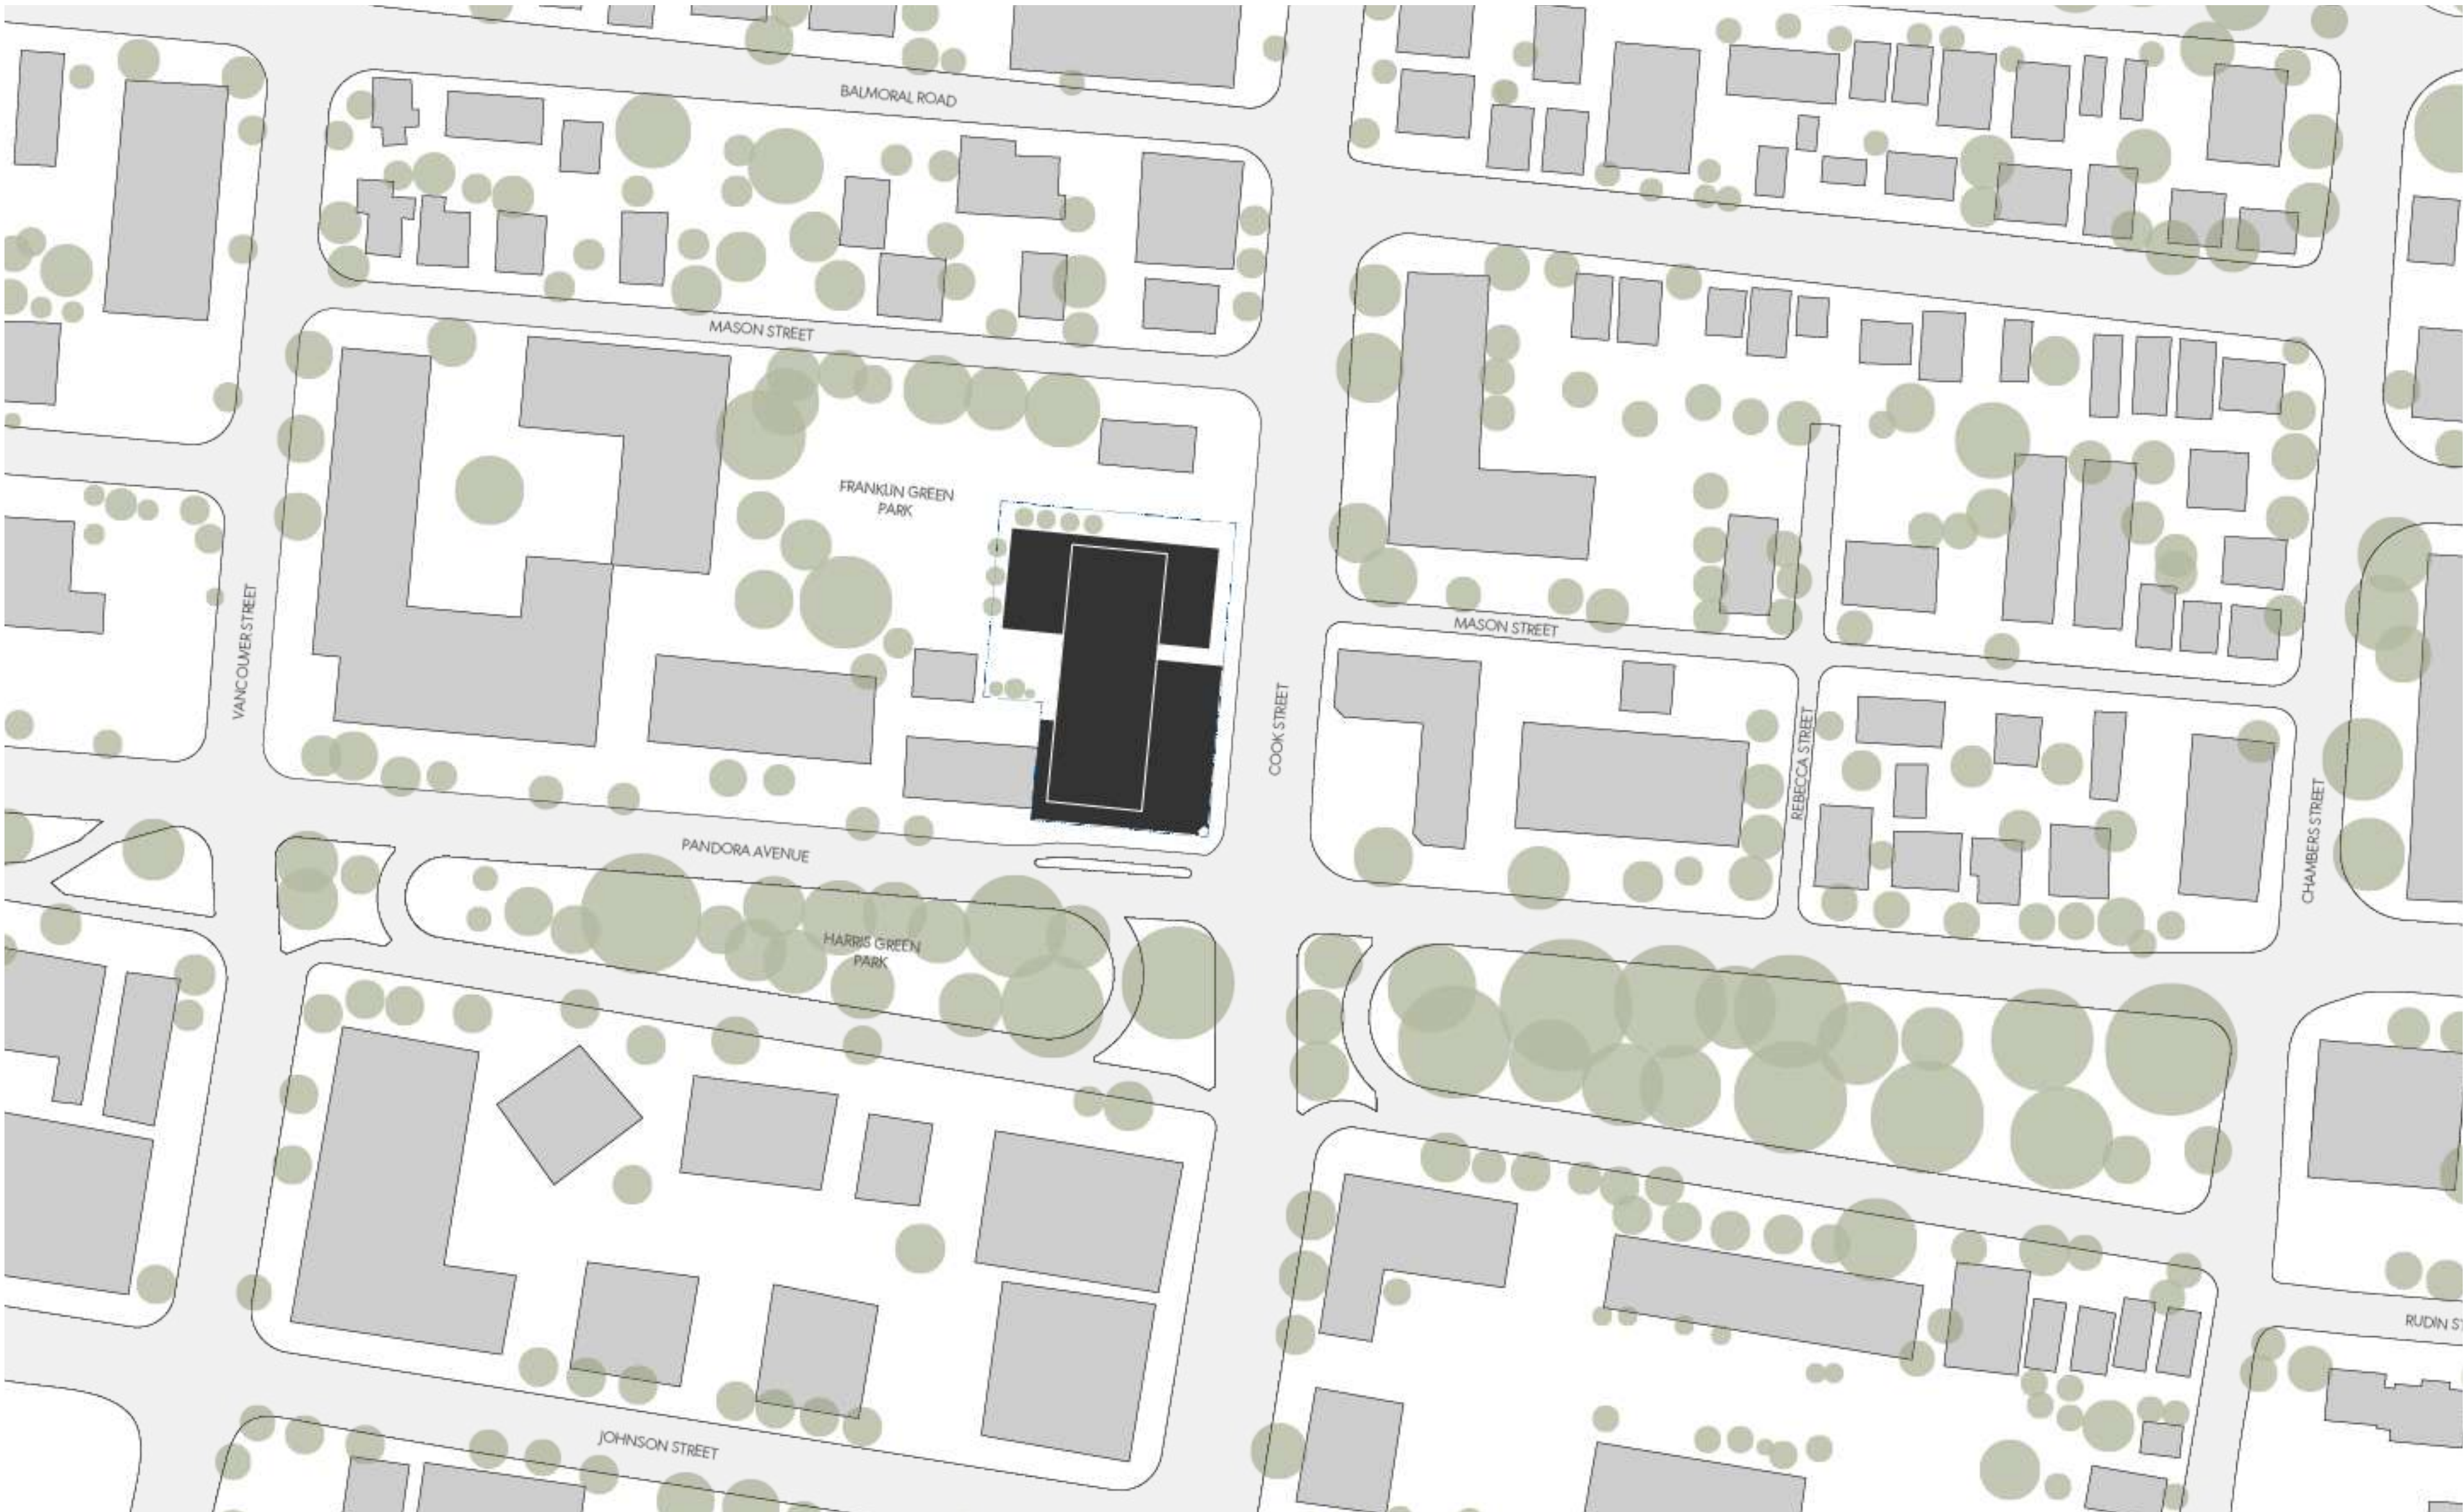

PARKWAY

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VICTORIA, BC
2018-001

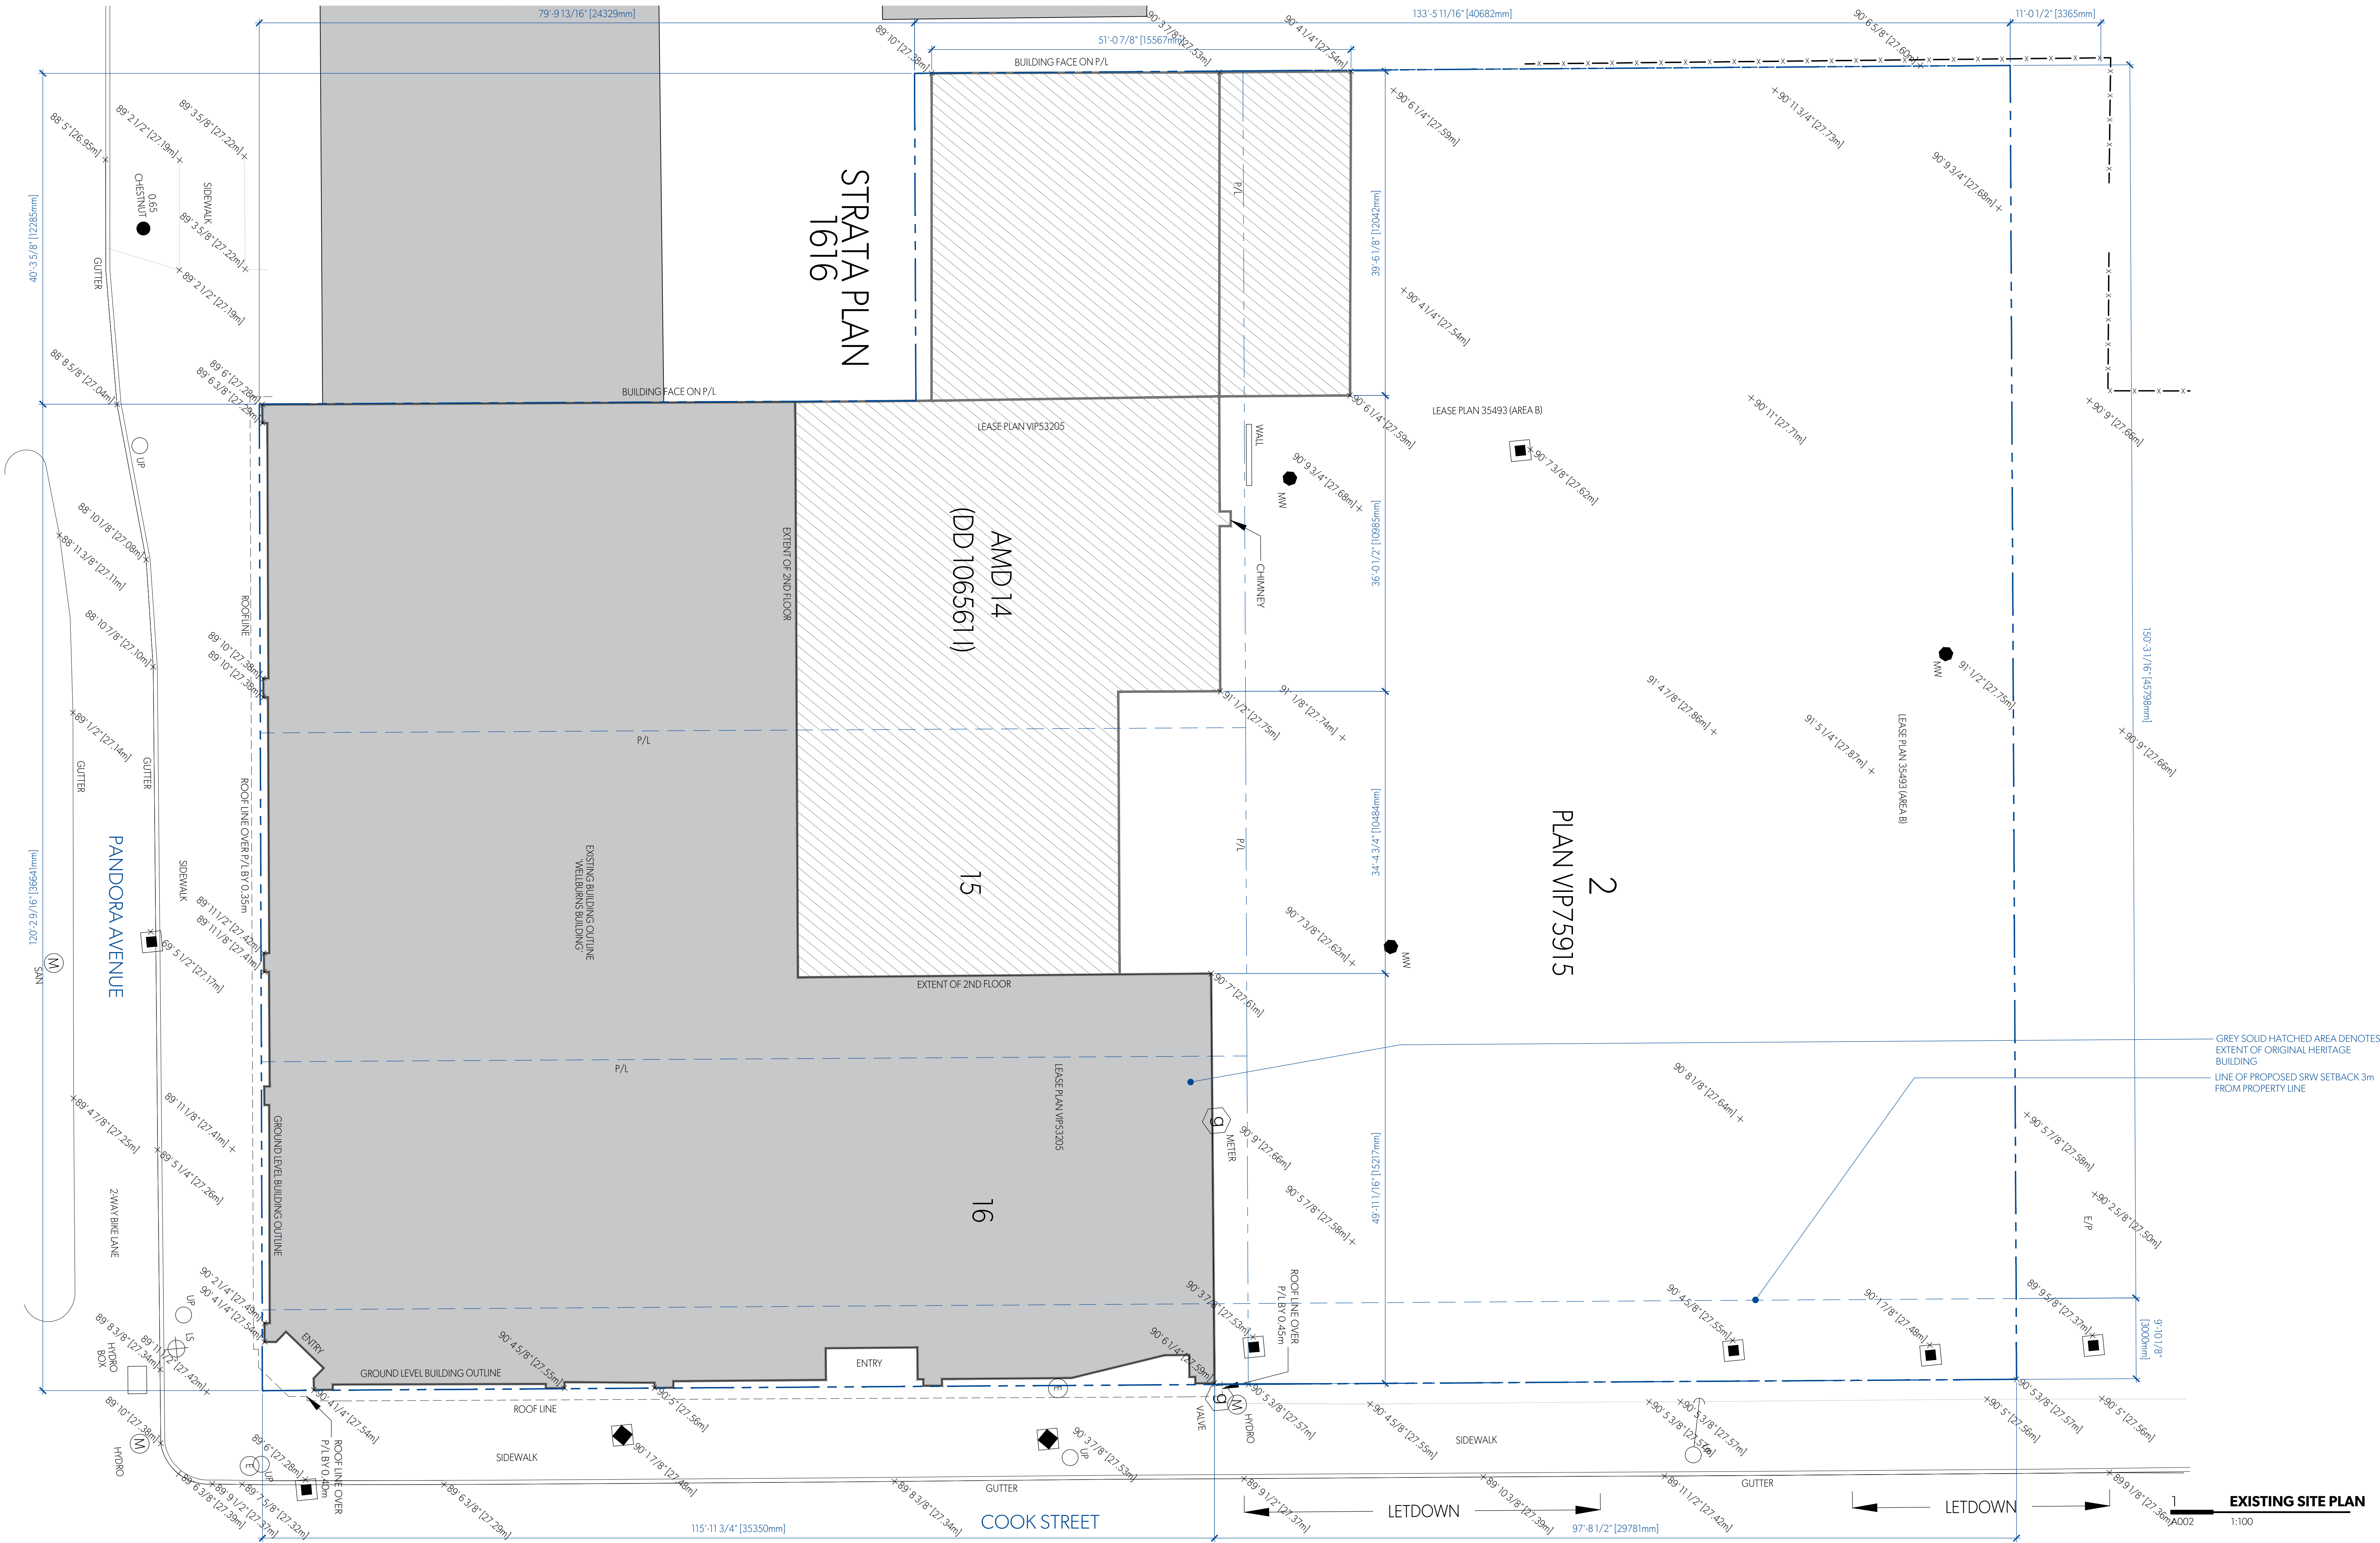


MGA

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SYMBOL LEGEND

- IS LIGHT STANDARD
- 1" 3/4" [0.40m] TREE TYPE & DIAMETER
- BRCH
- FIRE HYDRANT
- WATER VALVE
- WATER MAIN
- 2' 3/8" [15.94m] CATCH BASIN & ELEVATION @ RM
- MANHOLE
- GAS METER
- BOLLARD
- UTILITY POLE
- MONITORING WELL
- UTILITY POLE ANCHOR
- 52' 3/8" [15.94m] SURVEYED GEODETIC SPOT ELEVATION
- EL: 1' 0" [305mm] PROPOSED GRADE

MICHAEL GREEN ARCHITECTURE
1535 W 3RD AVENUE, VANCOUVER BC
CANADA V6J 1J8

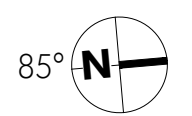


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PARKWAY

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A002
EXISTING SITE PLAN



MGA

PROJECT INFORMATION TABLE		
ZONE		
NEW SITE SPECIFIC ZONE RESIDENTIAL		
SITE AREA	2879.0	m ²
TOTAL FLOOR AREA	8412	m ²
COMMERCIAL FLOOR AREA	1054	m ²
FLOOR SPACE AREA	3.3	
SITE COVERAGE	70%	
OPEN SITE SPACE	22%	
HEIGHT OF BUILDING	20.22	m
NUMBER OF STOREYS	6	
PARKING STALLS ON SITE	44	
TOTAL BICYCLE PARKING	172	
LONG-TERM FLOOR MOUNTED	76	
LONG-TERM WALL MOUNTED	36	
LONG-TERM CARGO	40	
SHORT-TERM BIKE PARKING	18	
EXISTING BUILDING SETBACKS		
EAST	0m	
SOUTH	0m	
NORTH	29.78m	
WEST (ADJOINING SOUTH PL)	0m	
WEST (ADJOINING NORTH PL)	12.04m	
PROPOSED BUILDING SETBACKS		
EAST (FROM 6 STOREY VOL.)	13.13m	
EAST (FROM 4 STOREY VOL.)	3.08m	
SOUTH (FROM 6 STOREY VOL.)	4.01m	
SOUTH (FROM 4 STOREY VOL.)	38.04m	
NORTH (FROM 6 STOREY VOL.)	7.6m	
NORTH (FROM 4 STOREY VOL.)	6.18m	
WEST (FROM 6 STOREY VOL.)	3.33m	
WEST (FROM 4 STOREY VOL.)	2.96m	
RESIDENTIAL USE DETAILS		
TOTAL NUMBER OF UNITS	103	
UNIT TYPE		
STUDIO	4	
STUDIO & DEN	7	
1 BED	53	
1.8 BED	24	
2 BED	11	
2 BED & DEN	4	
GROUND-ORIENTATED UNITS		
MINIMUM UNIT FLOOR AREA	36.2 m ²	(1 BED H)
TOTAL RESIDENTIAL FLOOR AREA	5884	m ²
SYMBOL LEGEND		
LS	LIGHT STANDARD	
1" 3 3/4" [0.40m]	TREE (TYPE & DIAMETER)	
BRCH	BENCH	
FIRE HYDRANT	FIRE HYDRANT	
WATER VALVE	WATER VALVE	
WATER MAIN	WATER MAIN	
52" 3/8" [15.94m]	CATCH BASIN & ELEVATION @ RM	
MANHOLE	MANHOLE	
GAS METER	GAS METER	
BOILIARD	BOILIARD	
UTILITY POLE	UTILITY POLE	
MONITORING WELL	MONITORING WELL	
UTILITY POLE ANCHOR	UTILITY POLE ANCHOR	
52" 3/8" [15.94m]	SURVEYED GEODETIC SPOT ELEVATION	
EL. 3' 0" [0.91m]	PROPOSED GRADE	

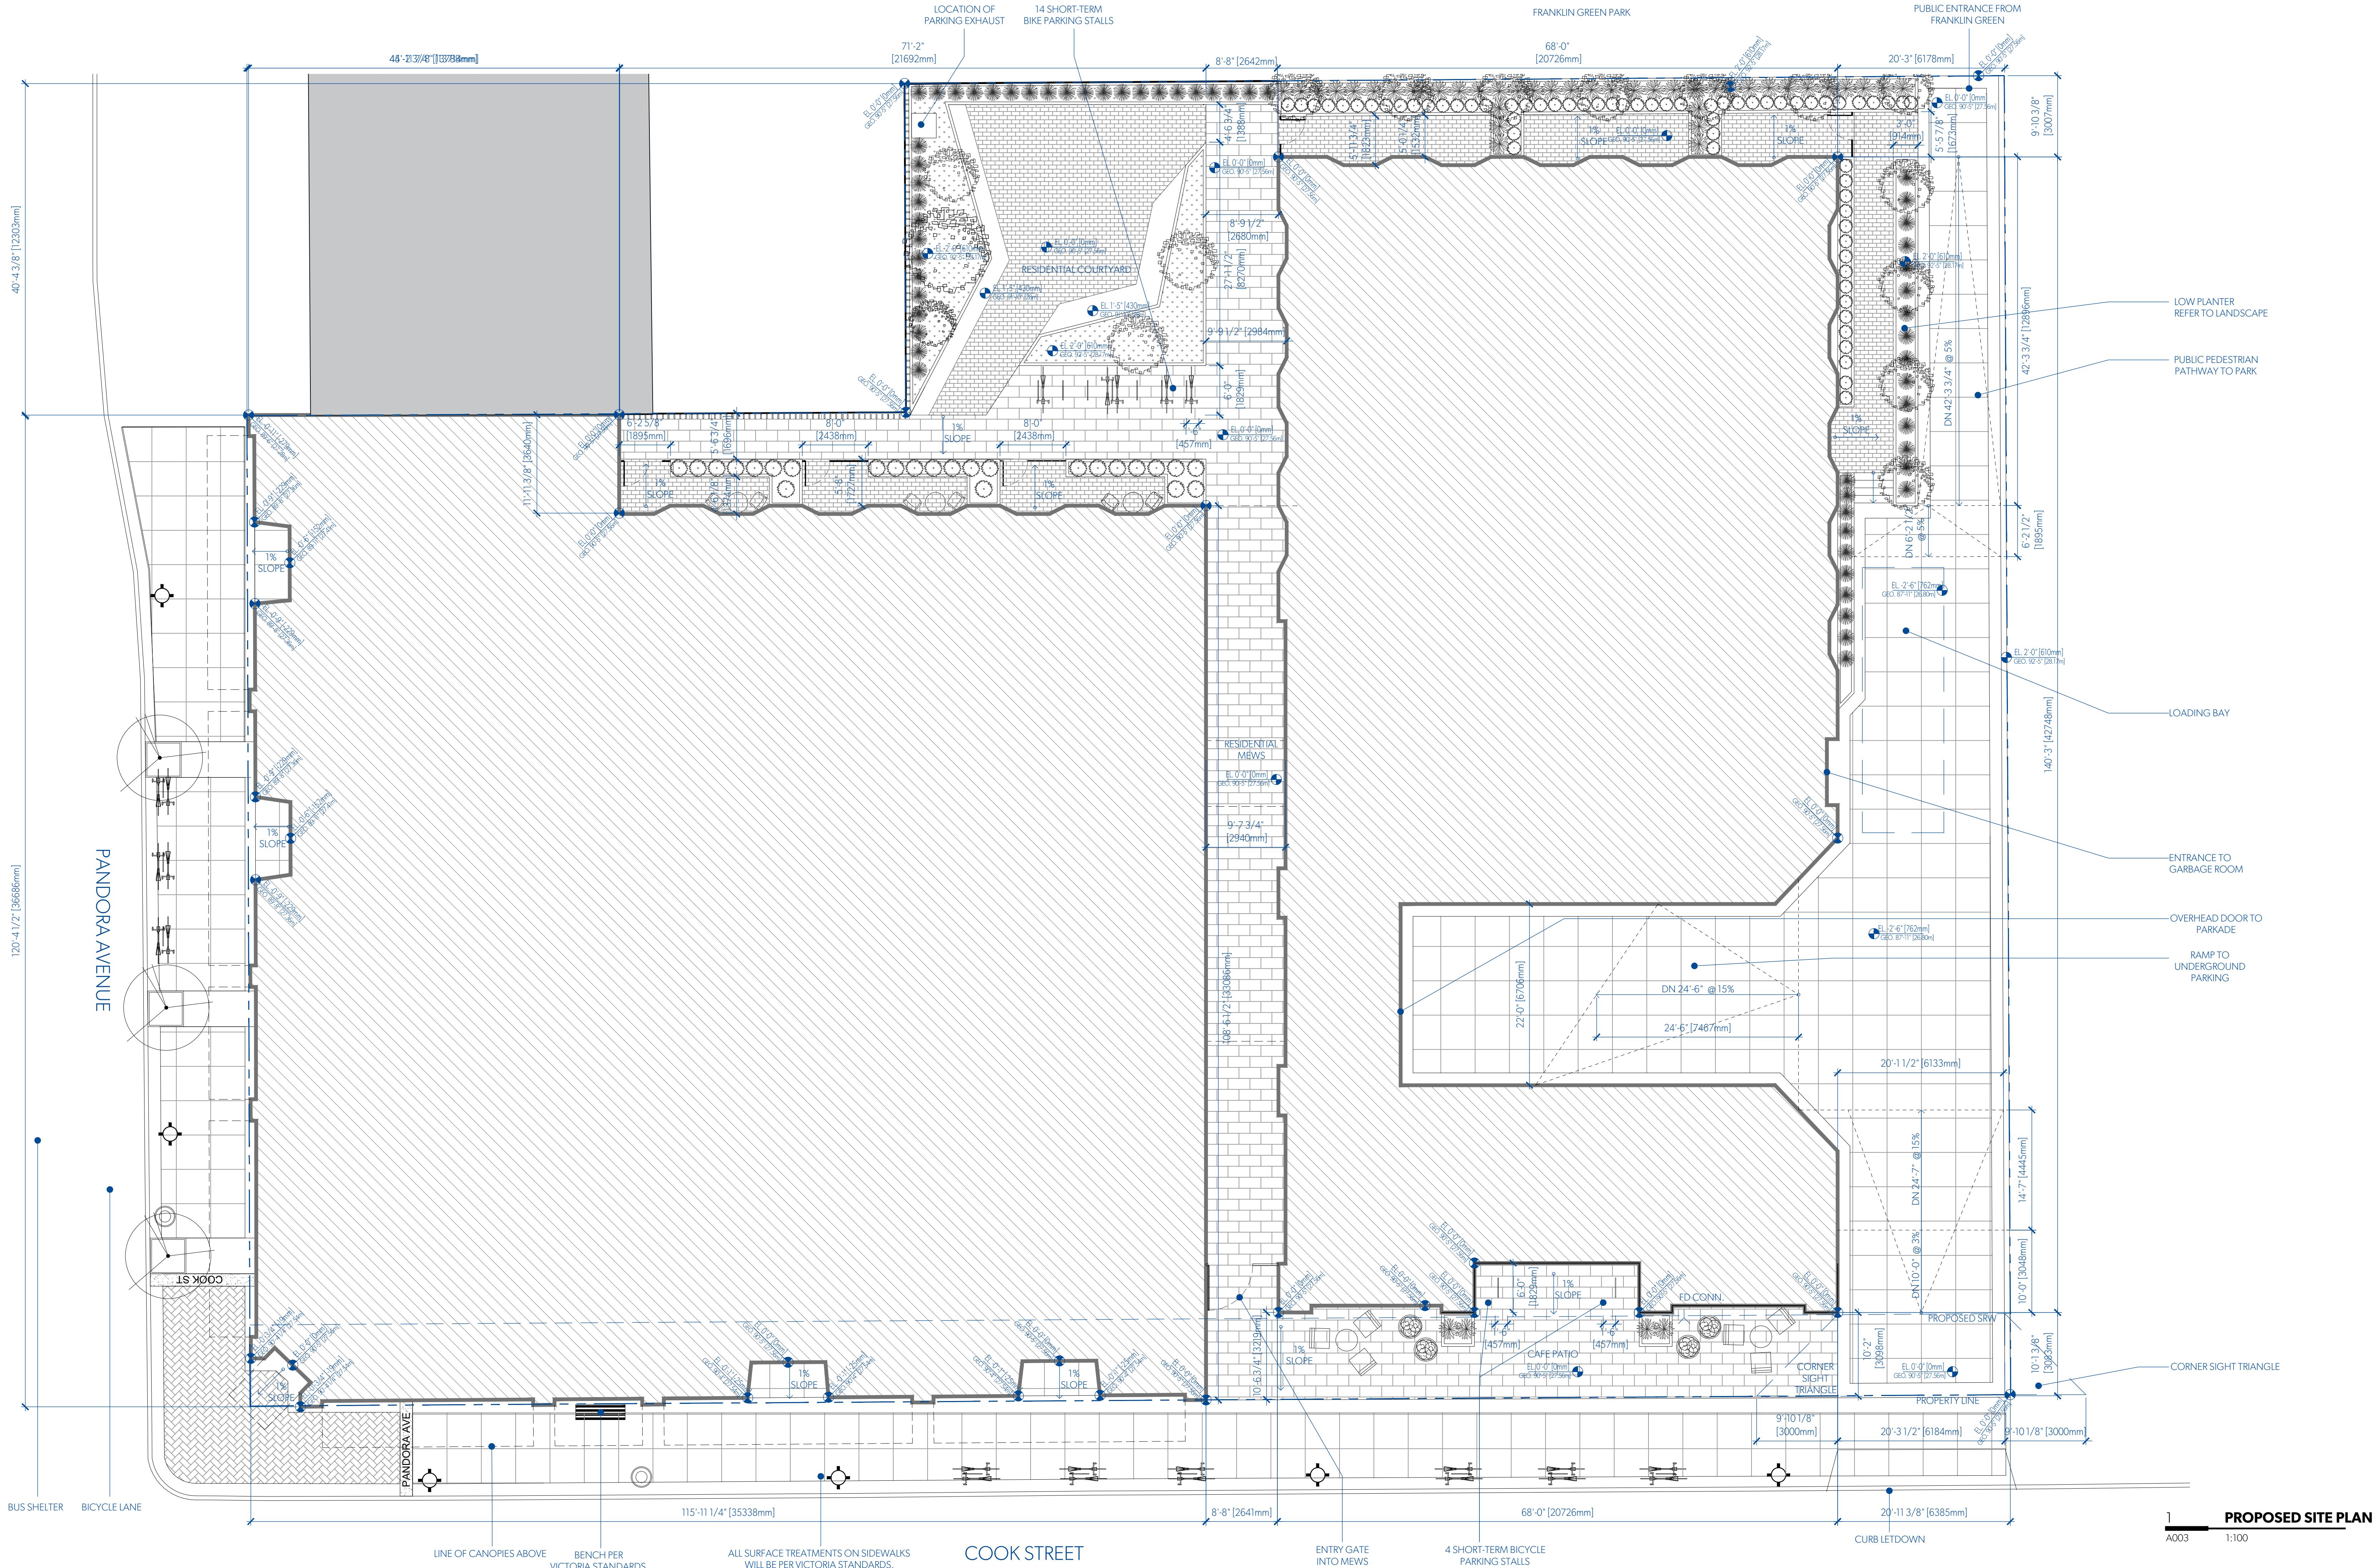MICHAEL GREEN ARCHITECTURE
1535 W 3RD AVENUE, VANCOUVER BC
CANADA V6J 1J8


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A003
PROPOSED SITE PLAN



AVERAGE GRADE CALCULATIONS				
GRADE POINTS	x DIST. BETWEEN PTS		TOTAL	
POINTS A & B	(27.28m + 27.56m)	x 0.5	x 13.65m	= 374.38
POINTS B & C	(27.56m + 27.56m)	x 0.5	x 3.40m	= 93.81
POINTS C & D	(27.56m + 27.56m)	x 0.5	x 21.71m	= 598.33
POINTS D & E	(27.56m + 27.56m)	x 0.5	x 2.64m	= 72.76
POINTS E & F	(27.56m + 27.56m)	x 0.5	x 12.90m	= 355.63
POINTS F & G	(27.56m + 27.56m)	x 0.5	x 20.73m	= 571.21
POINTS G & H	(27.56m + 27.56m)	x 0.5	x 42.75m	= 1178.13
POINTS H & I	(27.56m + 27.56m)	x 0.5	x 20.73m	= 571.21
POINTS I & J	(27.56m + 27.56m)	x 0.5	x 2.64m	= 72.76
POINTS J & K	(27.56m + 27.56m)	x 0.5	x 3.24m	= 89.29
POINTS K & L	(27.56m + 27.56m)	x 0.5	x 33.30m	= 922.93
POINTS L & M	(27.54m + 27.54m)	x 0.5	x 2.56m	= 70.50
POINTS M & A	(27.54m + 27.28m)	x 0.5	x 34.90m	= 966.61
TOTAL				5927.45
BLDG PERIMETER				215.34m
TOTAL =				5927.45 / 215.34m = 27.54m
AVG GRADE =				


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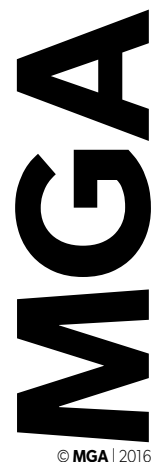
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- TYP. FLOOR MOUNTED BIKE RACK
- TYP. FLOOR MOUNTED CARGO BIKE RACK
- BI-DIRECTIONAL DRIVEWAY
- TYP. FLOOR MOUNTED BIKE RACK
- OVERHEAD PARKADE ENTRY DOOR
- TYP. FLOOR MOUNTED CARGO BIKE RACK
- LINE 3m SRW
- HATCHED AREA DENOTES RETAINED STRUCTURE OF EXISTING BUILDING ABOVE

1 LEVEL 0 PLAN
A100 1:100

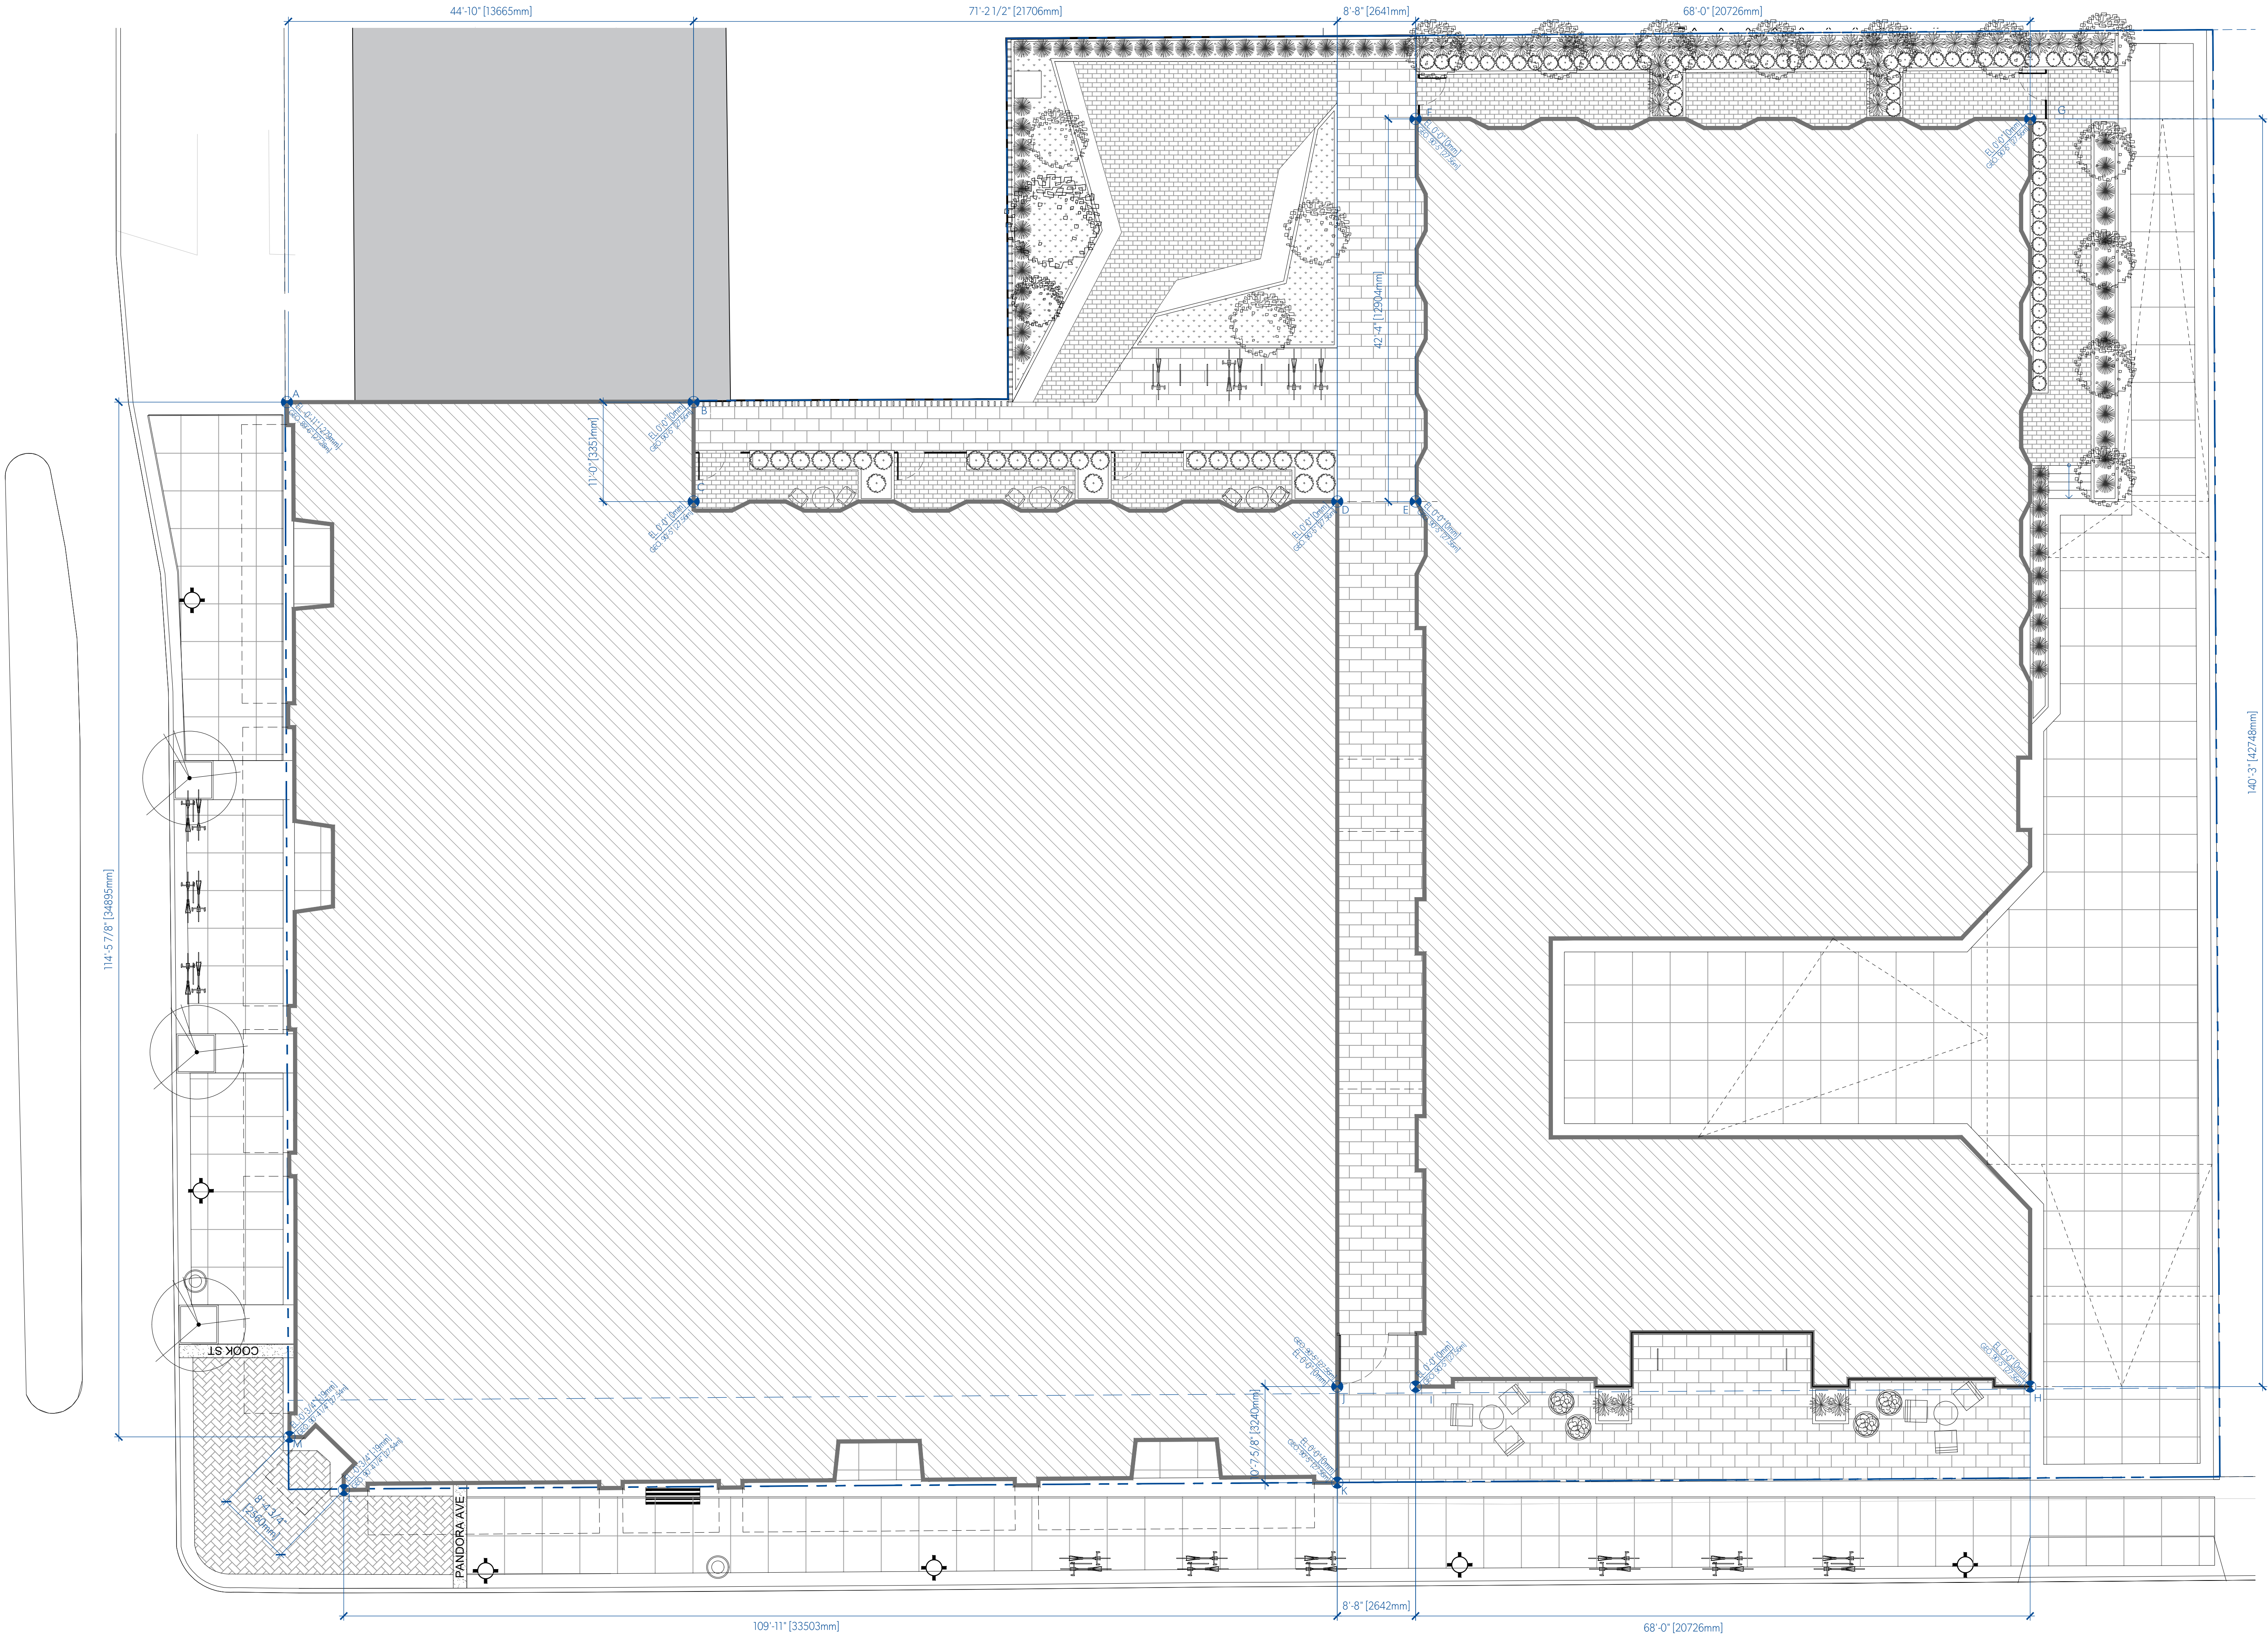


PARKING CALCULATIONS					
RESIDENTIAL	Parking Rate	# of Units	Stalls req'd	Stalls prov'd	
<45m ²	0.50	5	3	3	
45-70m ²	0.60	85	51	23	
>70m ²	1.00	13	13	7	
TOTAL RESIDENTIAL PARKINGS			67	33	
VISITOR	Parking Rate	# of Units	Stalls req'd	Stalls prov'd	
Visitor Parking	0.10	103	10	4	
COMMERCIAL	Parking Rate	Area (m ²)	Stalls req'd	Stalls prov'd	
Retail/Grocery	1/80m ²	888	11	2	
Restaurant	1/40m ²	222	6	3	
TOTAL COMMERCIAL PARKING			17	5	
CAR SHARE			Stalls prov'd		
Modo Car Share			2		
TOTAL PARKING			93	44	

BICYCLE PARKING LONG TERM					
RESIDENTIAL	Parking Rate	# of Units	Stalls req'd	Stalls prov'd	
1/Unit <45m ²		5	5	20	
1.25/Unit >45m ²		96	123	122	
RESTAURANT	area (m ²)		1	6	
1/400m ²	221.7		5	6	
1/100m ²	888		5	6	
TOTAL LONG TERM BIKE PARKING			133	154	
FLOOR MOUNTED RACKS				78	
FLOOR MOUNTED CARGO RACKS				40	
WALL MOUNTED RACKS				36	

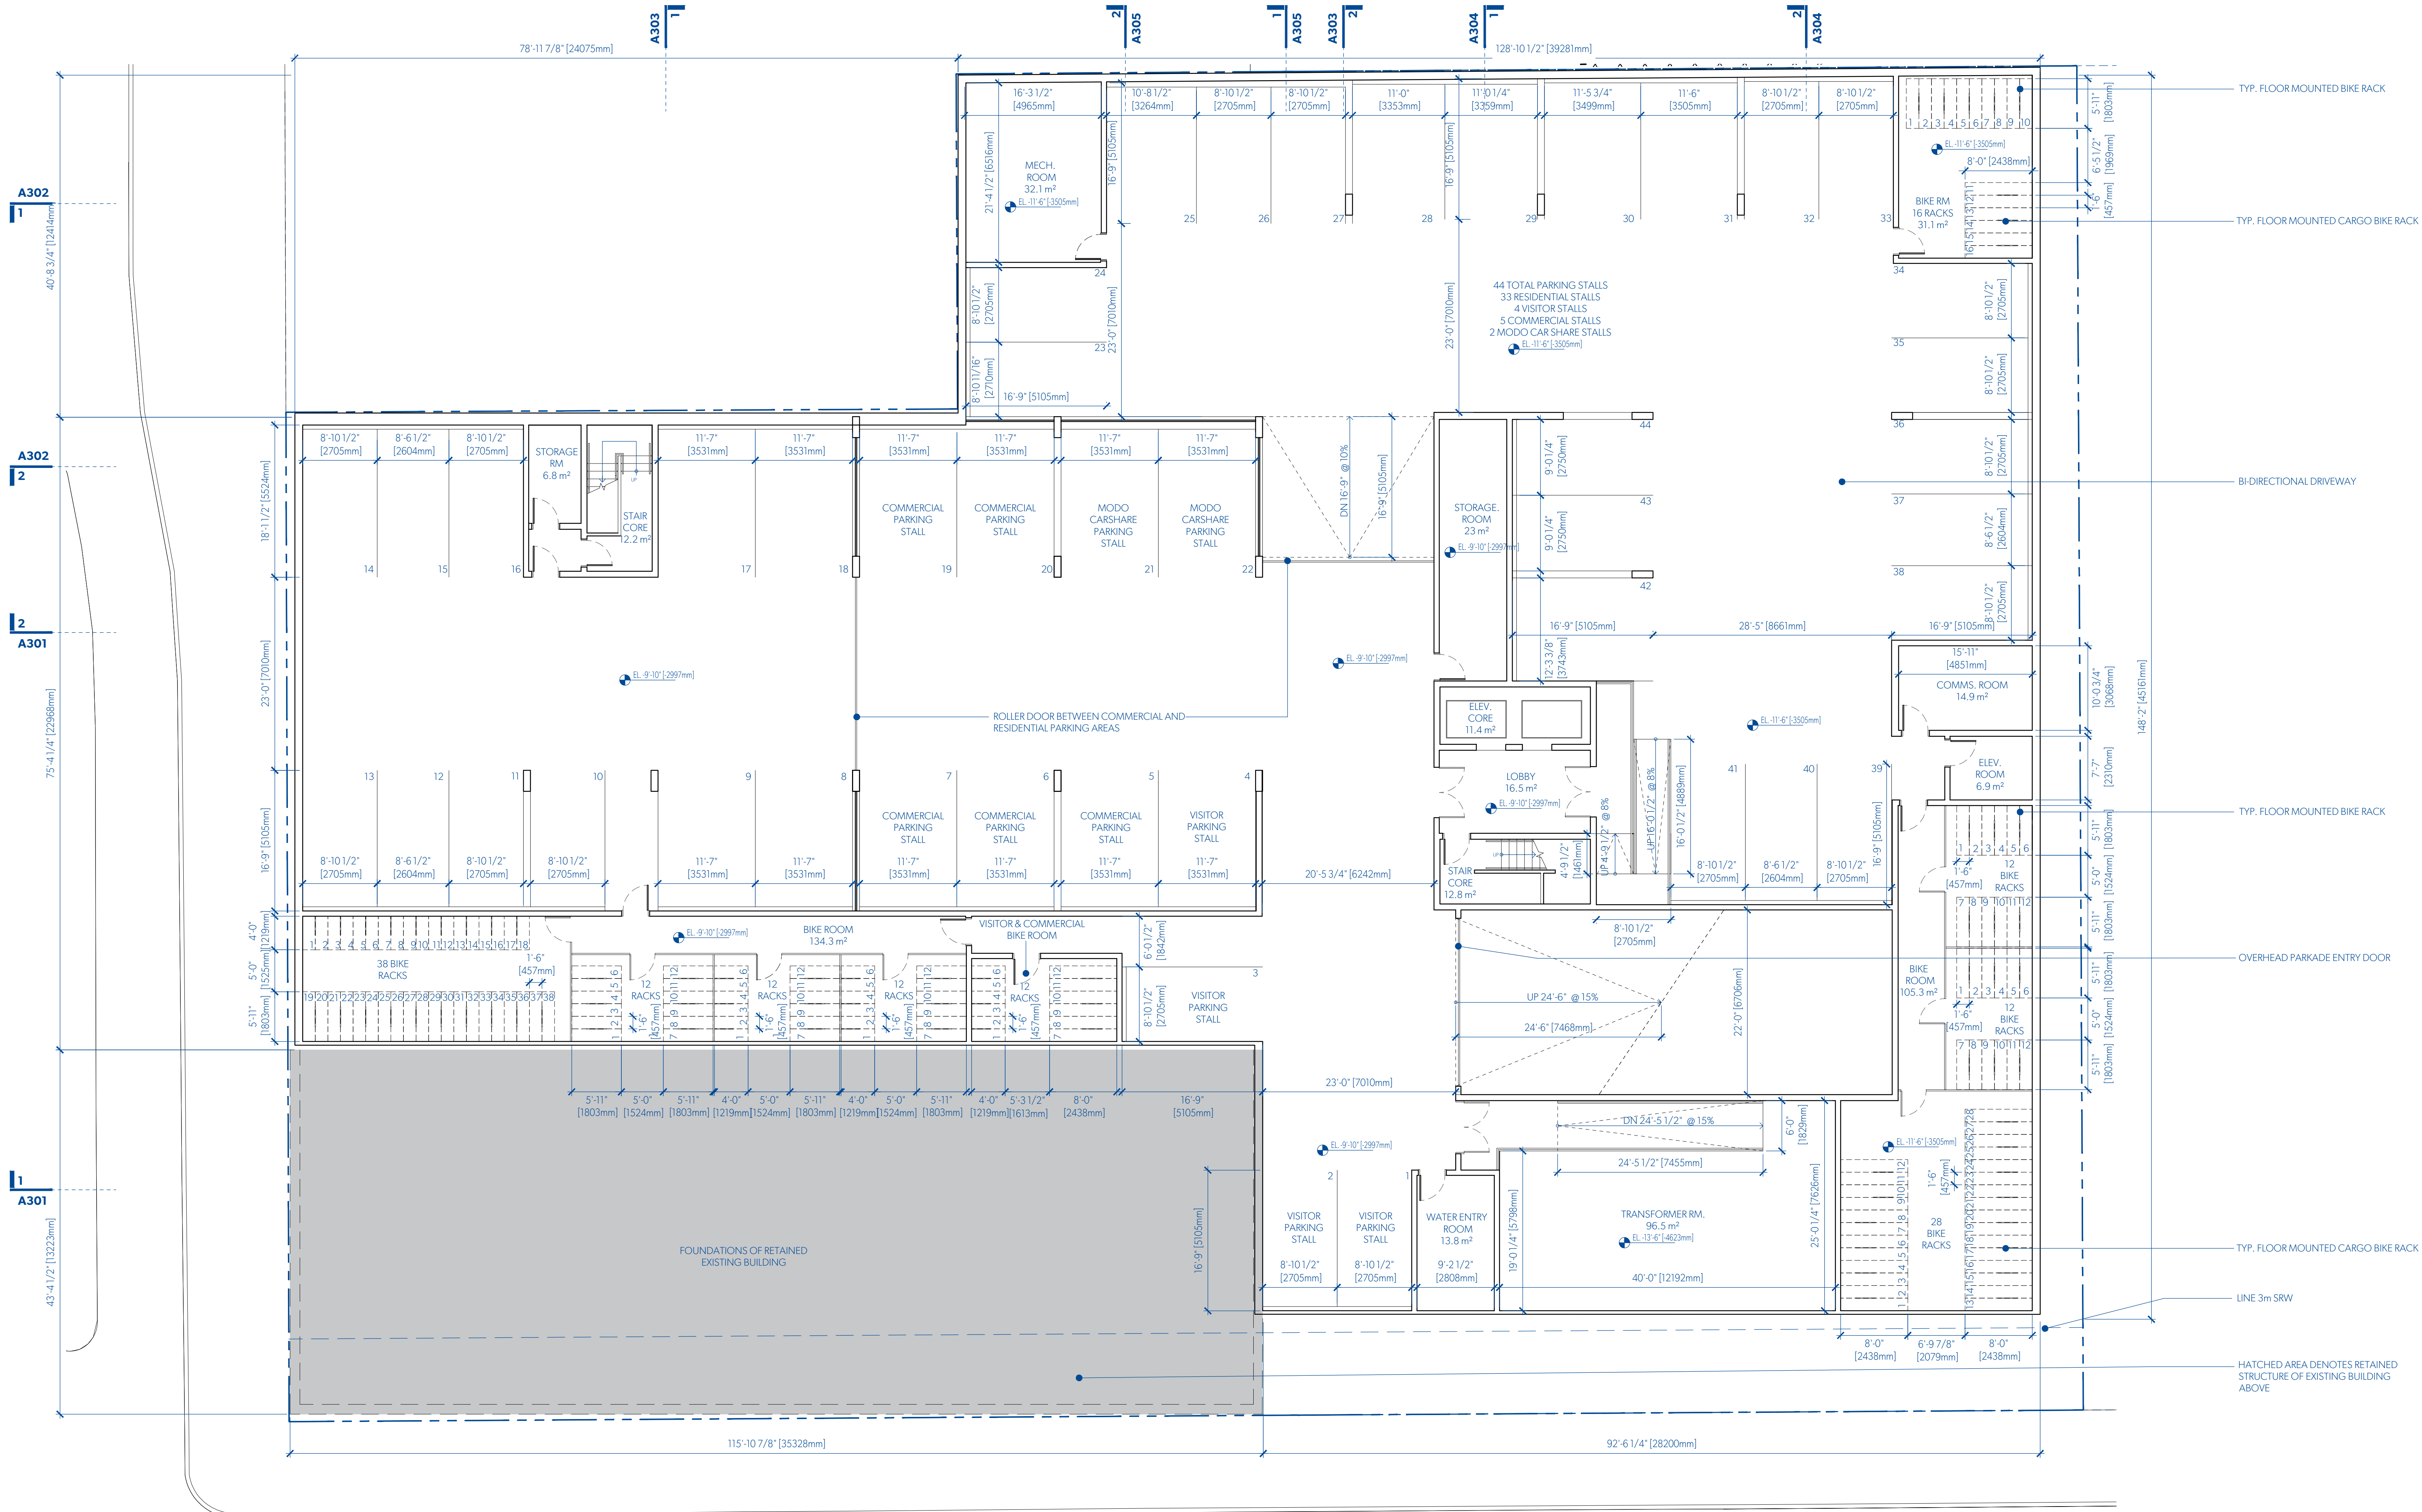BICYCLE PARKING SHORT TERM					
RESIDENTIAL	Parking Rate	area (m ²)	Stalls req'd	Stalls prov'd	
1/Unit		10	10	10	
1/100m ²	222	3	3	3	
1/200m ²	888	5	5	5	
TOTAL SHORT TERM BIKE PARKING			18	18	

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CANADA V6J 1J8

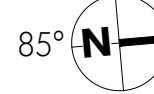


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2018-001



UNIT CALCULATIONS										
CITY	m2	U1	U2	U3	U4	U5	U6	TOTAL		
STUDIO A	56.0			1	1			2		
STUDIO B	52.6						1	2		
ST & DEN A	66.0		4					4		
ST & DEN B	72.7			1				1		
ST & DEN C	57.7				1			1		
ST & DEN D	53.6					1		1		
1 BED A	52.1	1	1	1	1			4		
1 BED B	52.8		1	1	1			4		
1 BED C	56.1			1	1			2		
1 BED D	48.3			1				1		
1 BED E	48.6			1	1			3		
1 BED F	51.6				5			10		
1 BED G	46.8			1				2		
1 BED H	36.2					1		1		
1 BED I	51.1				5			10		
1 BED J	36.7			1	1	1		4		
1 BED K	47.8			1	1	1		4		
1 BED L	53.4					1		1		
1 BED M	45.0						1	1		
1 BED N	48.4						1	1		
1 BED O	49.0							1		
1 BED P	48.6						1	1		
1 BED Q	49.0					1		1		
1 BED R	51.9	1						1		
1 BED S	51.1						1	1		
1 BED T	45.0							1		
1 B&D A	61.5		1					1		
1 B&D B	51.6				1			1		
1 B&D C	62.2		1	2	2			7		
1 B&D D	59.1							1		
1 B&D E	51.4					1		2		
1 B&D F	54.2				1			1		
1 B&D G	51.0							1		
1 B&D H	58.0		1					1		
1 B&D I	62.2			1	1			3		
1 B&D J	93.9							1		
1 B&D K	81.2							1		
1 B&D L	73.0	2						2		
1 B&D M	68.7		1					1		
2 BED A	72.5						1	1		
2 BED B	68.8		1					1		
2 BED C	73.5			1				1		
2 BED D	60.0			1	1			3		
2 BED E	79.5							1		
2 BED F	67.2	1			1			3		
2 BED G	75.4						1	1		
2 B&D A	90.8			1				2		
2 B&D B	96.1				1			1		
2 B&D C	76.1							1		
TOTAL UNITS		8	24	21	21	15	14	103		

MICHAEL GREEN ARCHITECTURE
1535 W 3RD AVENUE, VANCOUVER BC
CANADA V6J 1J8

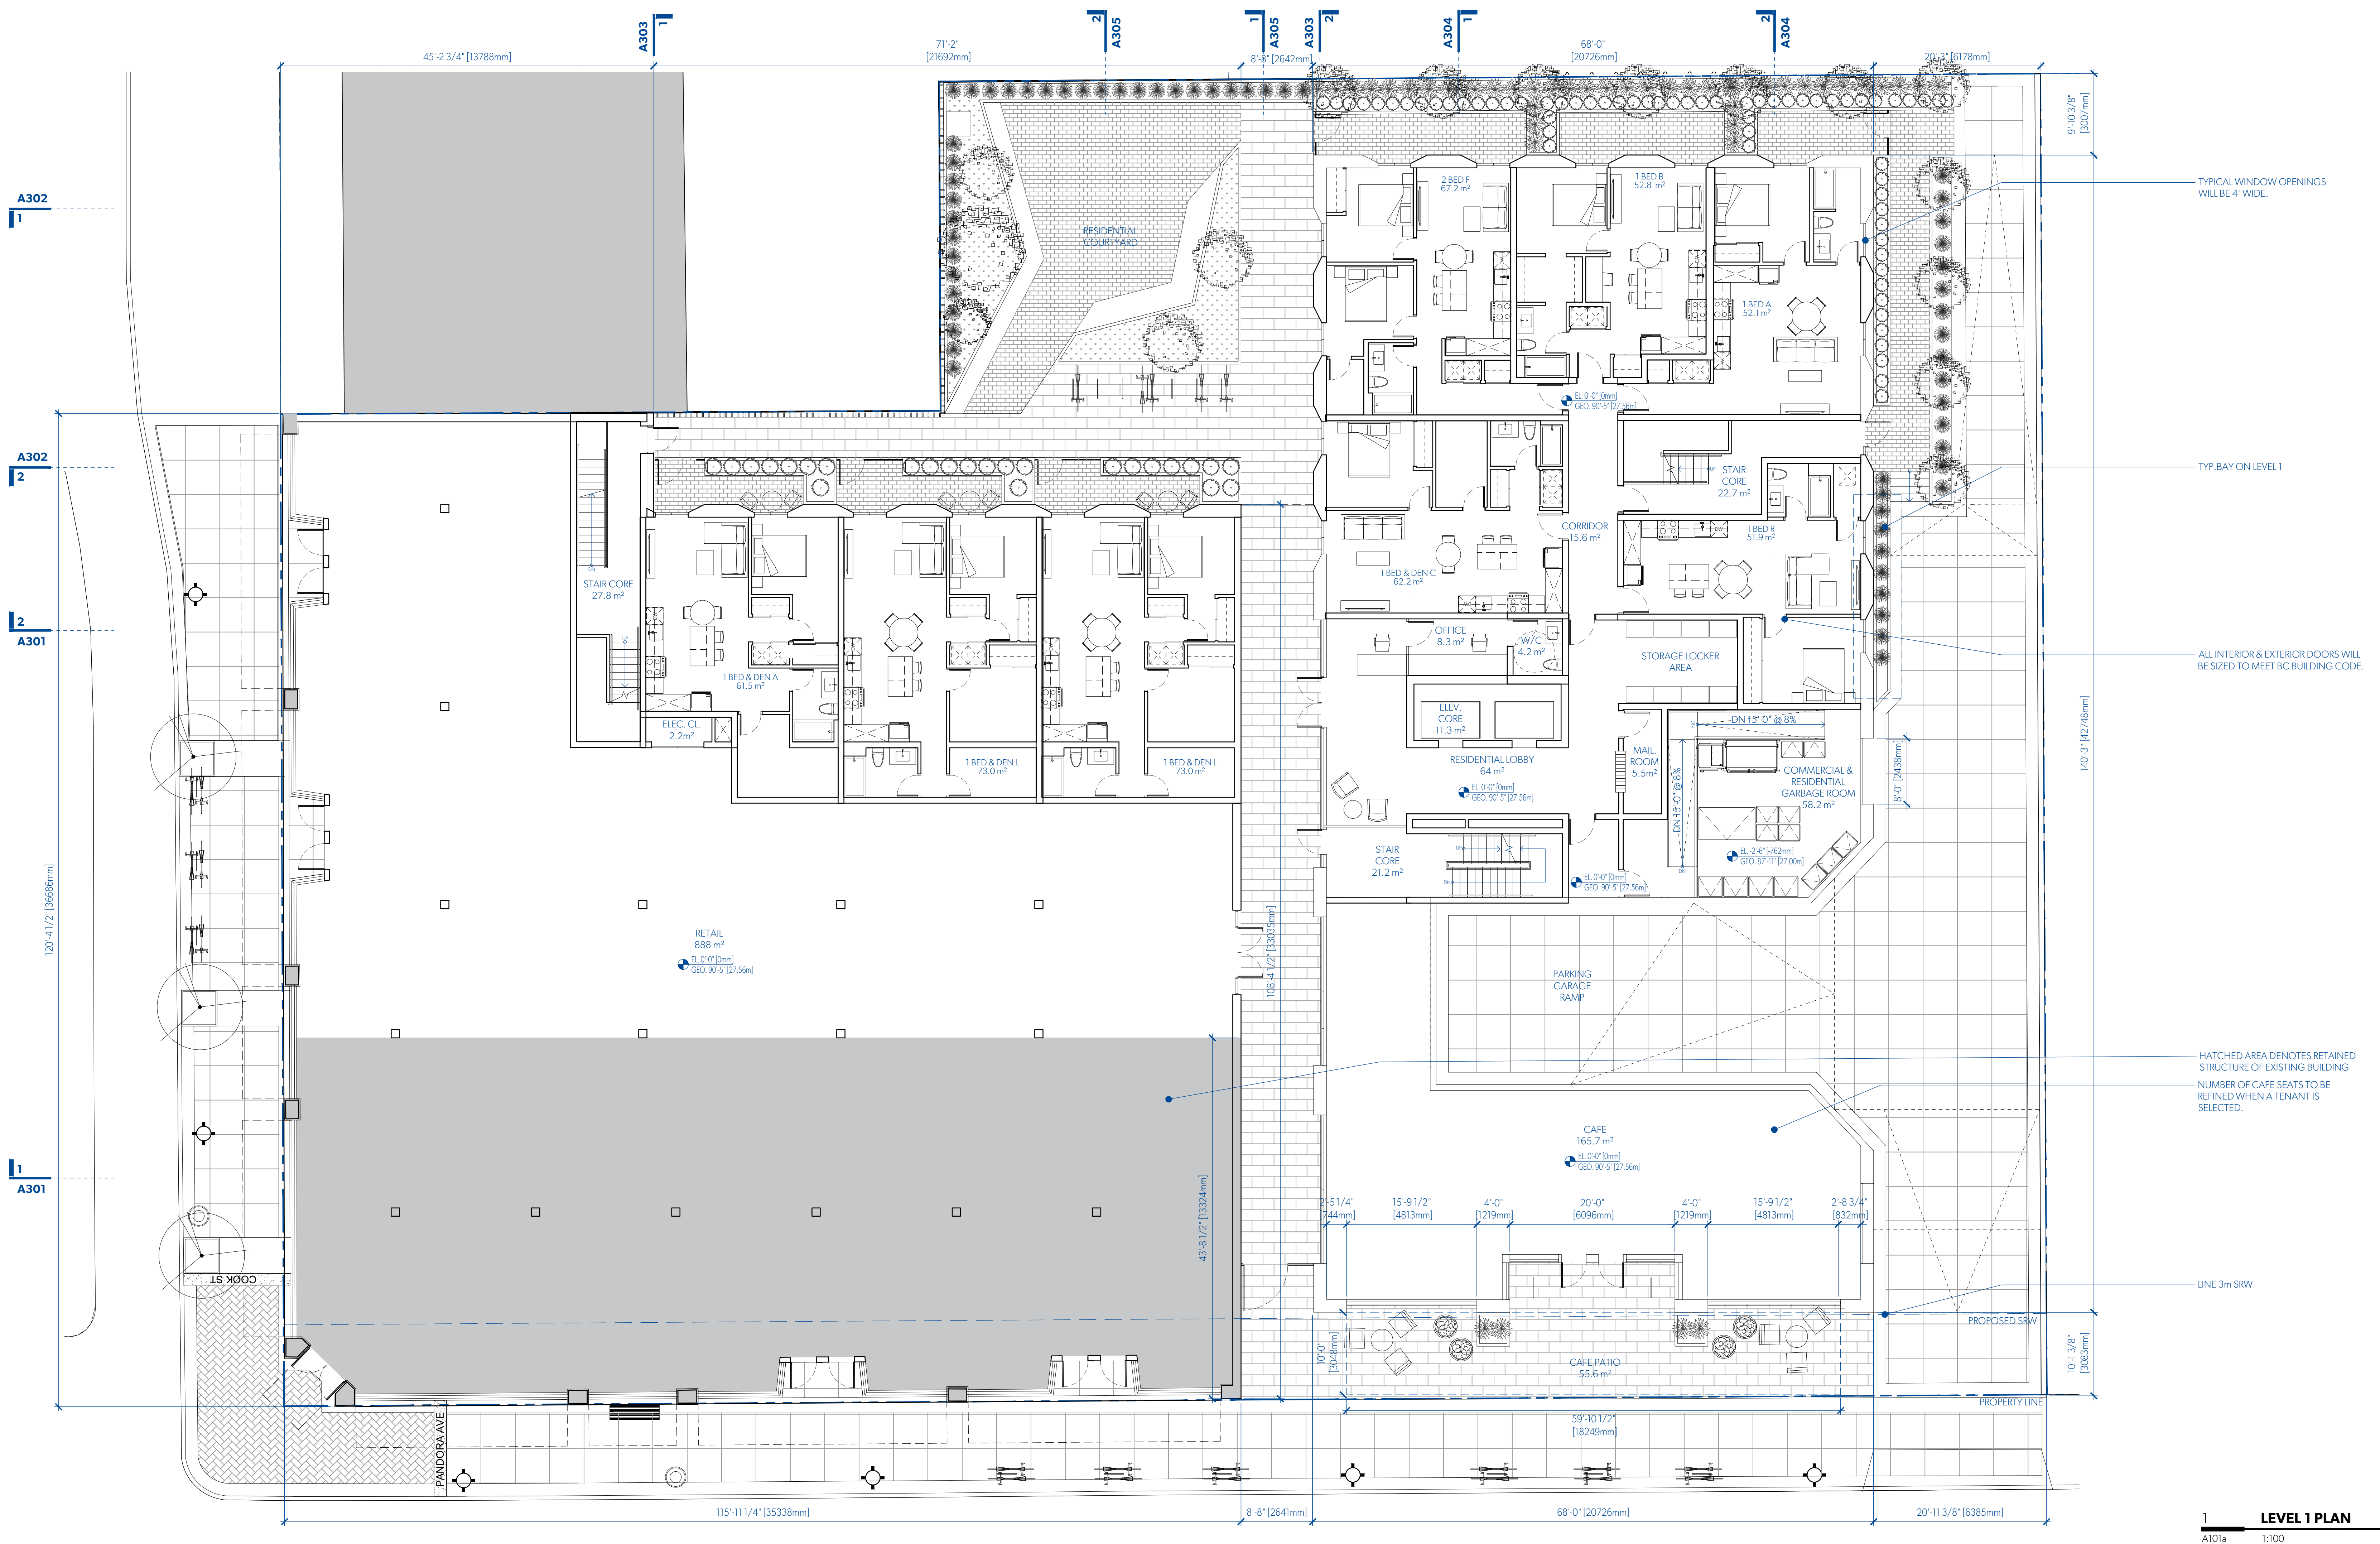2020-03-20	3	REVISED FOR REZONING
2019-10-30	2	REVISED FOR REZONING
2019-09-13	1	REVISED FOR REZONING
2019-05-15	0	ISSUED FOR REZONING

DATE	REVISION	DESCRIPTION
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PARKWAY
1050 PANDORA AVE + 1518 COOK STREET
VICTORIA, BC
2018-001



MGA

UNIT CALCULATIONS										
CITY	m2	U1	U2	U3	U4	U5	U6	TOTAL		
STUDIO A	56.0			1	1			2		
STUDIO B	52.6				1		1	2		
ST & DEN A	66.0		4					4		
ST & DEN B	72.7		1					1		
ST & DEN C	57.7			1				1		
ST & DEN D	53.6			1				1		
1BED A	52.1	1	1	1	1			4		
1BED B	52.8	1	1	1	1			4		
1BED C	56.1							1		
1BED D	48.3							1		
1BED E	48.6			1	1			2		
1BED F	51.6			5		5		10		
1BED G	46.8			1		1		2		
1BED H	36.2							1		
1BED I	51.1				5		5	10		
1BED J	36.7			1	1	1	1	4		
1BED K	47.8				1	1	1	3		
1BED L	53.4							1		
1BED M	45.0							1		
1BED N	48.4							1		
1BED O	49.0							1		
1BED P	48.6							1		
1BED Q	49.0							1		
1BED R	51.9	1						1		
1BED S	51.1							1		
1BED T	45.0							1		
1B&D A	61.5	1			1			2		
1B&D B	51.6							1		
1B&D C	62.2	1	2	2	2			7		
1B&D D	59.1							1		
1B&D E	51.4						1	2		
1B&D F	54.2				1	1		2		
1B&D G	51.0							1		
1B&D H	58.0							1		
1B&D I	62.2			1	1	1		3		
1B&D J	93.9							1		
1B&D K	81.2							1		
1B&D L	73.0	2						2		
1B&D M	68.7		1					1		
2BED A	72.5						1	1		
2BED B	68.8							1		
2BED C	73.5							1		
2BED D	60.0			1	1	1		3		
2BED E	79.5							1		
2BED F	67.2	1		1	1	1		3		
2BED G	75.4							1		
2B&D A	90.8			1	1	1		3		
2B&D B	96.1							1		
2B&D C	76.1			1	1	1		3		
TOTAL UNITS										
		8	24	21	21	15	14	103		

MICHAEL GREEN ARCHITECTURE
1535 W 3RD AVENUE, VANCOUVER BC
CANADA V6J 1J8

- 2020-03-20 3 REVISED FOR REZONING
- 2019-10-30 2 REVISED FOR REZONING
- 2019-09-13 1 REVISED FOR REZONING
- 2019-05-15 0 ISSUED FOR REZONING

DATE REVISION DESCRIPTION

PARKWAY
1050 PANDORA AVE + 1518 COOK STREET
VICTORIA, BC
2018-001

A102
LEVEL 2 PLAN



UNIT CALCULATIONS										
CITY	m2	U1	U2	U3	U4	U5	U6	TOTAL		
STUDIO A	56.0			1	1			2		
STUDIO B	52.6						1	2		
ST & DEN A	66.0		4					4		
ST & DEN B	72.7			1				1		
ST & DEN C	57.7				1			1		
ST & DEN D	53.6					1		1		
1 BED A	52.1	1	1	1	1			4		
1 BED B	52.8	1	1	1	1			4		
1 BED C	56.1					1		1		
1 BED D	48.3			1				1		
1 BED E	48.6				1			1		
1 BED F	51.6					5		5		
1 BED G	46.8			1				1		
1 BED H	36.2							1		
1 BED I	51.1					5		5		
1 BED J	36.7			1	1	1		4		
1 BED K	47.8				1	1	1	4		
1 BED L	53.4						1	1		
1 BED M	45.0							1		
1 BED N	48.4							1		
1 BED O	49.0							1		
1 BED P	48.6						1	1		
1 BED Q	49.0					1		1		
1 BED R	51.9	1						1		
1 BED S	51.1							1		
1 BED T	45.0							1		
1 B&D A	61.5	1						1		
1 B&D B	51.6				1			1		
1 B&D C	62.2	1	2	2	2			7		
1 B&D D	59.1							1		
1 B&D E	51.4						1	1		
1 B&D F	54.2				1			1		
1 B&D G	51.0							1		
1 B&D H	38.0							1		
1 B&D I	62.2			1	1			3		
1 B&D J	93.9							1		
1 B&D K	81.2							1		
1 B&D L	73.0	2						2		
1 B&D M	68.7		1					1		
2 BED A	72.5						1	1		
2 BED B	68.8			1				1		
2 BED C	73.5							1		
2 BED D	60.0			1	1			3		
2 BED E	79.5			1				1		
2 BED F	67.2	1			1	1		3		
2 BED G	75.4						1	1		
2 B&D A	90.8			1				1		
2 B&D B	96.1				1			1		
2 B&D C	76.1							1		
TOTAL UNITS		8	24	21	21	15	14	103		


MICHAEL GREEN ARCHITECTURE
1535 W 3RD AVENUE, VANCOUVER BC
CANADA V6J 1J8

- 2020-03-20 3 REVISED FOR REZONING
- 2019-10-30 2 REVISED FOR REZONING
- 2019-09-13 1 REVISED FOR REZONING
- 2019-05-15 0 ISSUED FOR REZONING

DATE	REVISION	DESCRIPTION
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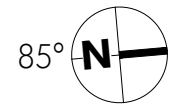
PARKWAY

1050 PANDORA AVE + 1518 COOK STREET
VICTORIA, BC
2018-001

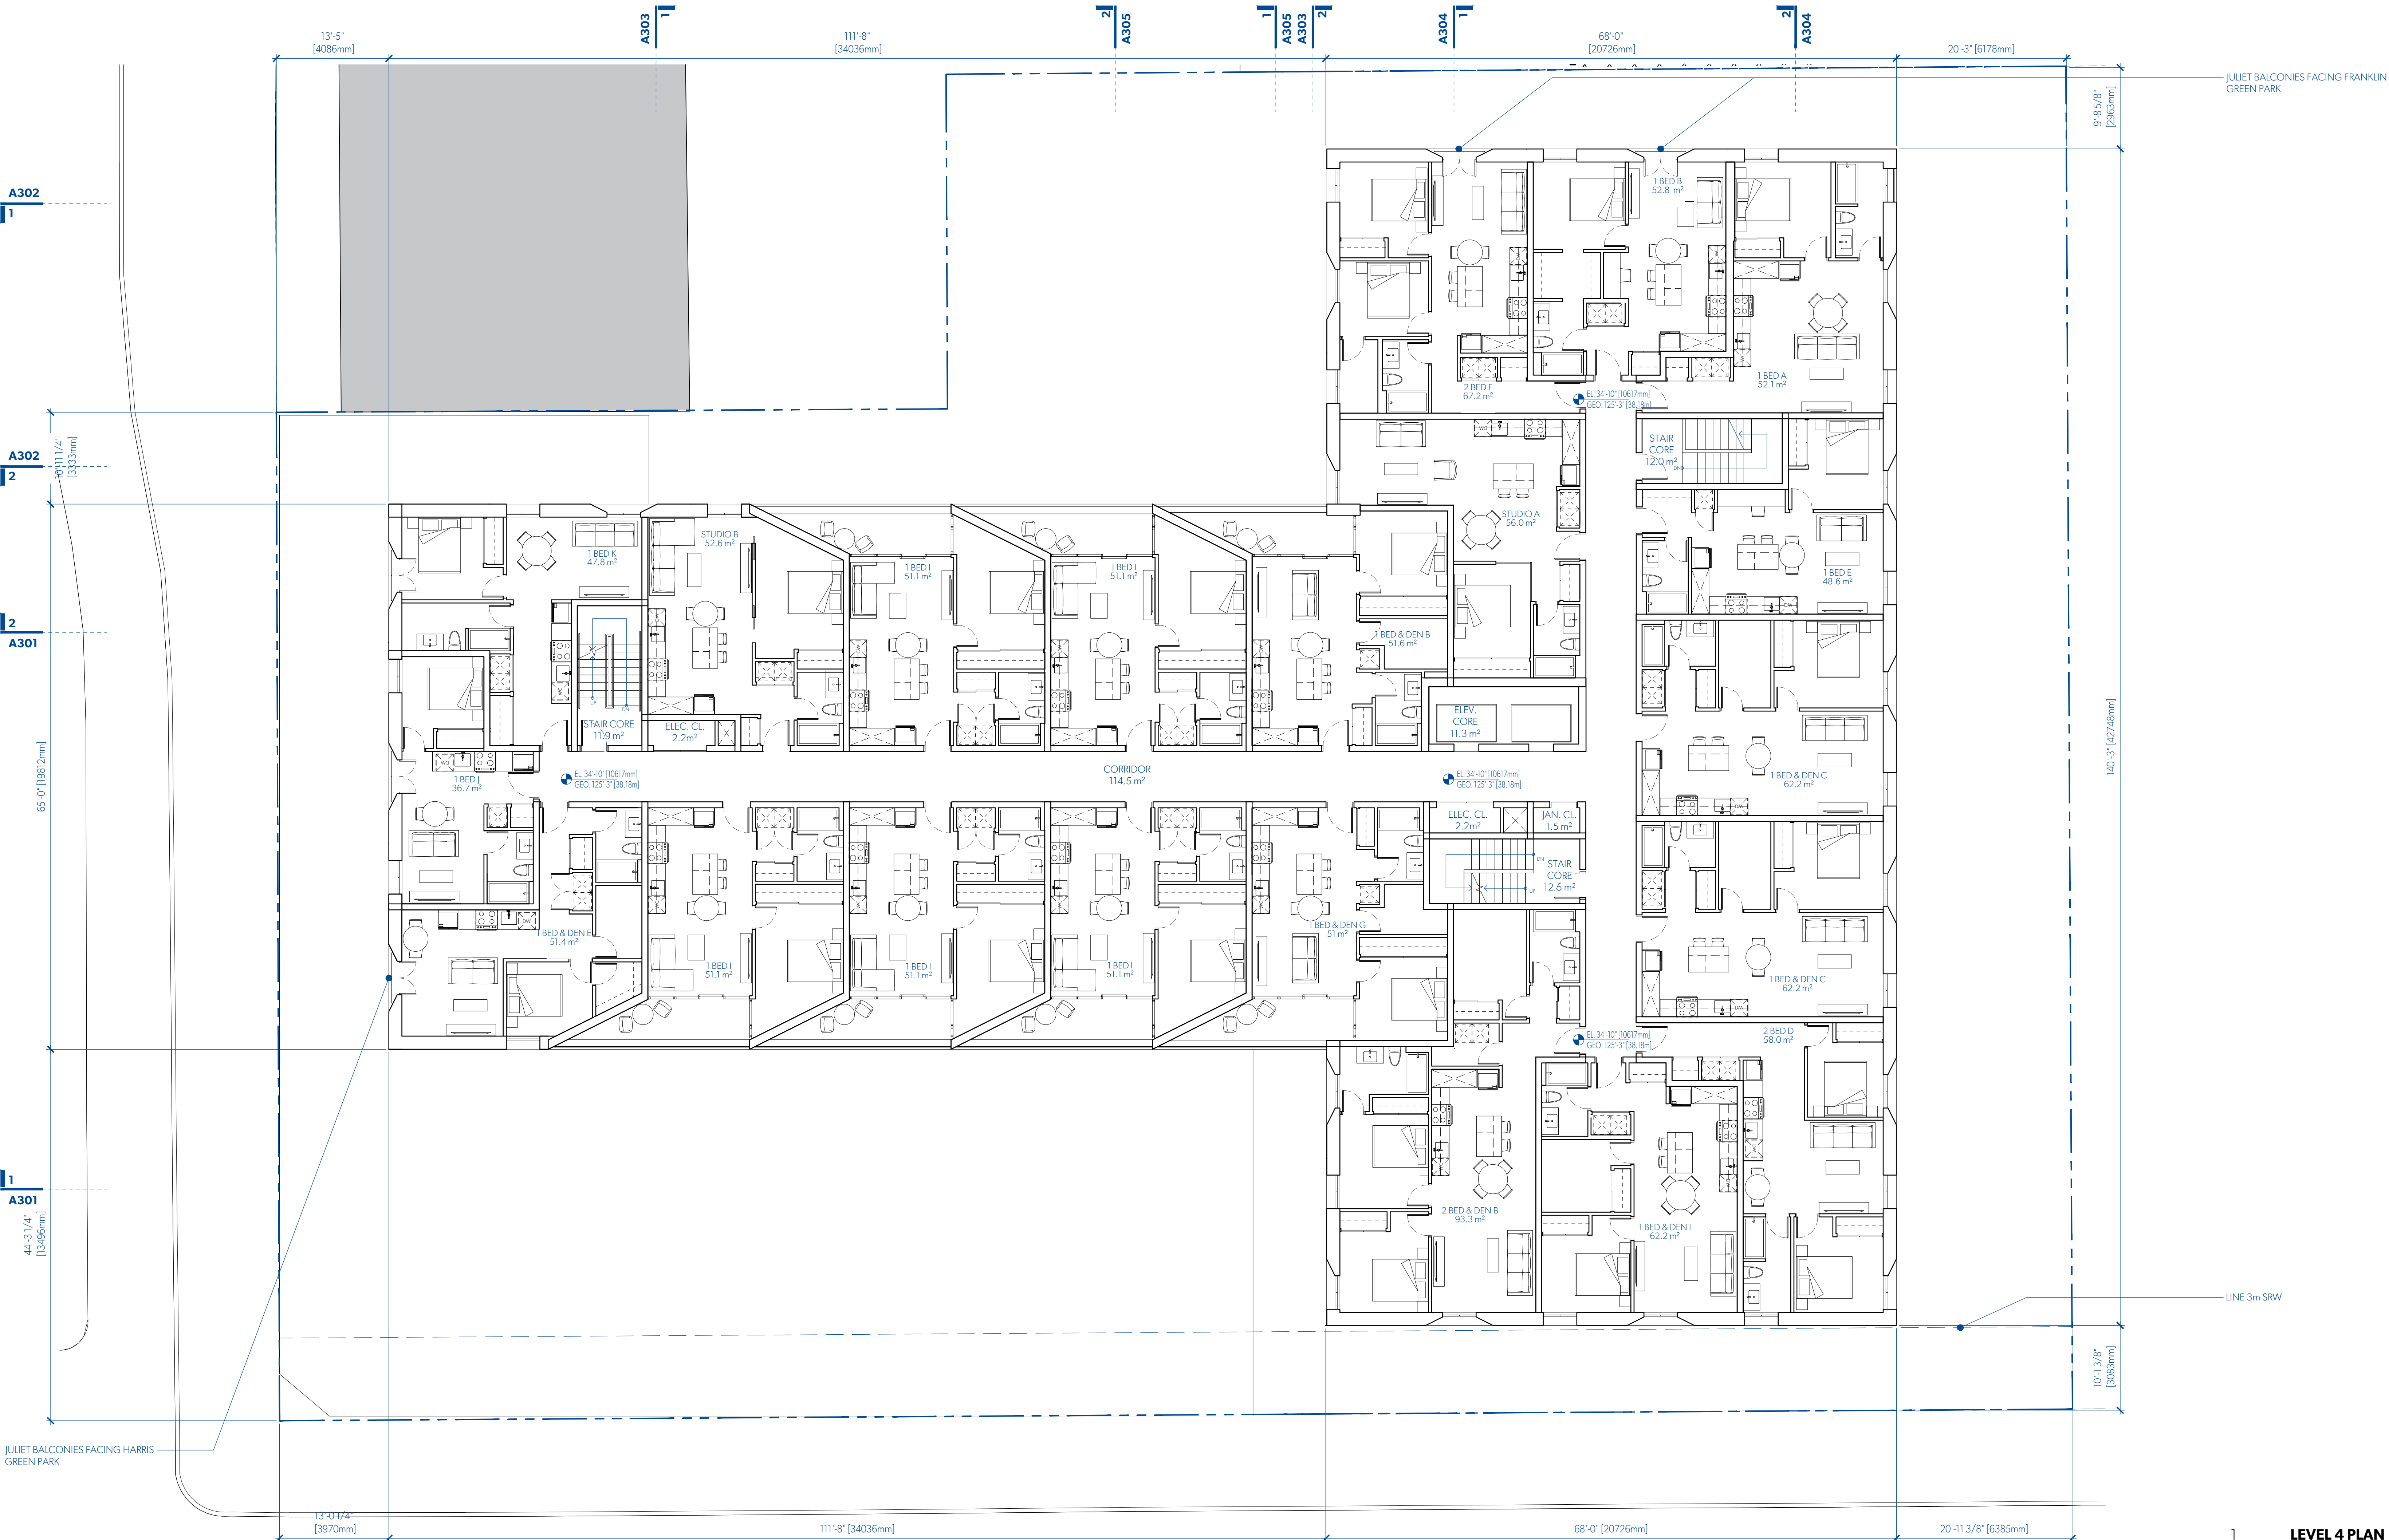

UNIT CALCULATIONS									
CITY	m2	U1	U2	U3	U4	U5	U6	TOTAL	
STUDIO A	56.0			1	1			2	
STUDIO B	52.6					1	1	2	
ST & DEN A	66.0		4					4	
ST & DEN B	72.7			1				1	
ST & DEN C	57.7				1			1	
ST & DEN D	53.6				1			1	
1 BED A	52.1	1	1	1	1			4	
1 BED B	52.8	1	1	1	1			4	
1 BED C	56.1		1					1	
1 BED D	48.3		1					1	
1 BED E	48.6			1	1			2	
1 BED F	51.6				5			5	10
1 BED G	46.8			1				1	2
1 BED H	36.2								1
1 BED I	51.1				5			5	10
1 BED J	36.7			1	1	1		3	4
1 BED K	47.8				1	1	1	3	4
1 BED L	53.4								1
1 BED M	45.0								1
1 BED N	48.4								1
1 BED O	49.0								1
1 BED P	48.6								1
1 BED Q	49.0					1		1	1
1 BED R	51.9	1							1
1 BED S	51.1								1
1 BED T	45.0								1
1 B&D A	61.5	1			1			2	1
1 B&D B	51.6								1
1 B&D C	62.2	1	2	2	2			7	1
1 B&D D	59.1								1
1 B&D E	51.4						1	1	2
1 B&D F	54.2				1	1		2	1
1 B&D G	51.0								1
1 B&D H	58.0								1
1 B&D I	62.2			1	1	1		3	1
1 B&D J	93.9								1
1 B&D K	81.2								1
1 B&D L	73.0	2						2	1
1 B&D M	68.7		1					1	1
2 BED A	72.5						1	1	1
2 BED B	68.8		1					1	1
2 BED C	73.5								1
2 BED D	60.0			1	1	1		3	1
2 BED E	79.5			1	1	1		3	1
2 BED F	67.2	1			1	1		3	1
2 BED G	75.4						1	1	1
2 B&D A	90.8		1		1			2	1
2 B&D B	96.1								1
2 B&D C	76.1		1		1			2	1
TOTAL UNITS									
		8	24	21	21	15	14	103	

MICHAEL GREEN ARCHITECTURE
1535 W 3RD AVENUE, VANCOUVER BC
CANADA V6J 1J8



2020-03-20	3	REVISED FOR REZONING
2019-10-30	2	REVISED FOR REZONING
2019-09-13	1	REVISED FOR REZONING
2019-05-15	0	ISSUED FOR REZONING

DATE	REVISION	DESCRIPTION
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PARKWAY

1050 PANDORA AVE + 1518 COOK STREET
VICTORIA, BC
2018-001



UNIT CALCULATIONS										
CITY	m2	U1	U2	U3	U4	U5	U6	TOTAL		
STUDIO A	56.0			1	1			2		
STUDIO B	52.6				1		1	2		
ST & DEN A	66.0		4					4		
ST & DEN B	72.7							1		
ST & DEN C	57.7			1				1		
ST & DEN D	53.6				1			1		
1 BED A	52.1	1	1	1	1			4		
1 BED B	52.8	1	1	1	1			4		
1 BED C	56.1			1				1		
1 BED D	48.3		1					1		
1 BED E	48.6			1	1			3		
1 BED F	51.6				5			5		
1 BED G	46.8		1					1		
1 BED H	36.2					1		1		
1 BED I	51.1				5			5		
1 BED J	36.7			1	1	1		4		
1 BED K	47.8			1	1	1		4		
1 BED L	53.4					1		1		
1 BED M	45.0						1	1		
1 BED N	48.4							1		
1 BED O	49.0							1		
1 BED P	48.6						1	1		
1 BED Q	49.0					1		1		
1 BED R	51.9	1						1		
1 BED S	51.1							1		
1 BED T	45.0						1	1		
1 B&D A	61.5		1					1		
1 B&D B	51.6				1			1		
1 B&D C	62.2		1	2	2	2		7		
1 B&D D	59.1			1				1		
1 B&D E	51.4						1	1		
1 B&D F	54.2				1		1	2		
1 B&D G	51.0							1		
1 B&D H	58.0							1		
1 B&D I	62.2			1	1	1		3		
1 B&D J	93.9							1		
1 B&D K	81.2							1		
1 B&D L	73.0	2						2		
1 B&D M	68.7		1					1		
2 BED A	72.5						1	1		
2 BED B	68.8							1		
2 BED C	73.5							1		
2 BED D	60.0			1	1	1		3		
2 BED E	79.5			1				1		
2 BED F	67.2	1			1	1		3		
2 BED G	75.4						1	1		
2 B&D A	90.8			1	1			2		
2 B&D B	96.1							1		
2 B&D C	76.1		1		1			2		
TOTAL UNITS		8	24	21	21	15	14	103		

MICHAEL GREEN ARCHITECTURE
1535 W 3RD AVENUE, VANCOUVER BC
CANADA V6J 1J8

- 2020-03-20 3 REVISED FOR REZONING
- 2019-10-30 2 REVISED FOR REZONING
- 2019-09-13 1 REVISED FOR REZONING
- 2019-05-15 0 ISSUED FOR REZONING


DATE	REVISION	DESCRIPTION
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PARKWAY

1050 PANDORA AVE + 1518 COOK STREET
VICTORIA, BC
2018-001




MICHAEL GREEN ARCHITECTURE
1535 W 3RD AVENUE, VANCOUVER BC
CANADA V6J 1J8

**PARKWAY**

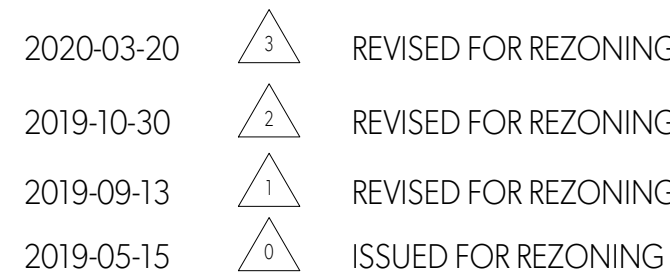
1050 PANDORA AVE + 1518 COOK STREET
VICTORIA, BC
2018-001

A106

LEVEL 6 PLAN

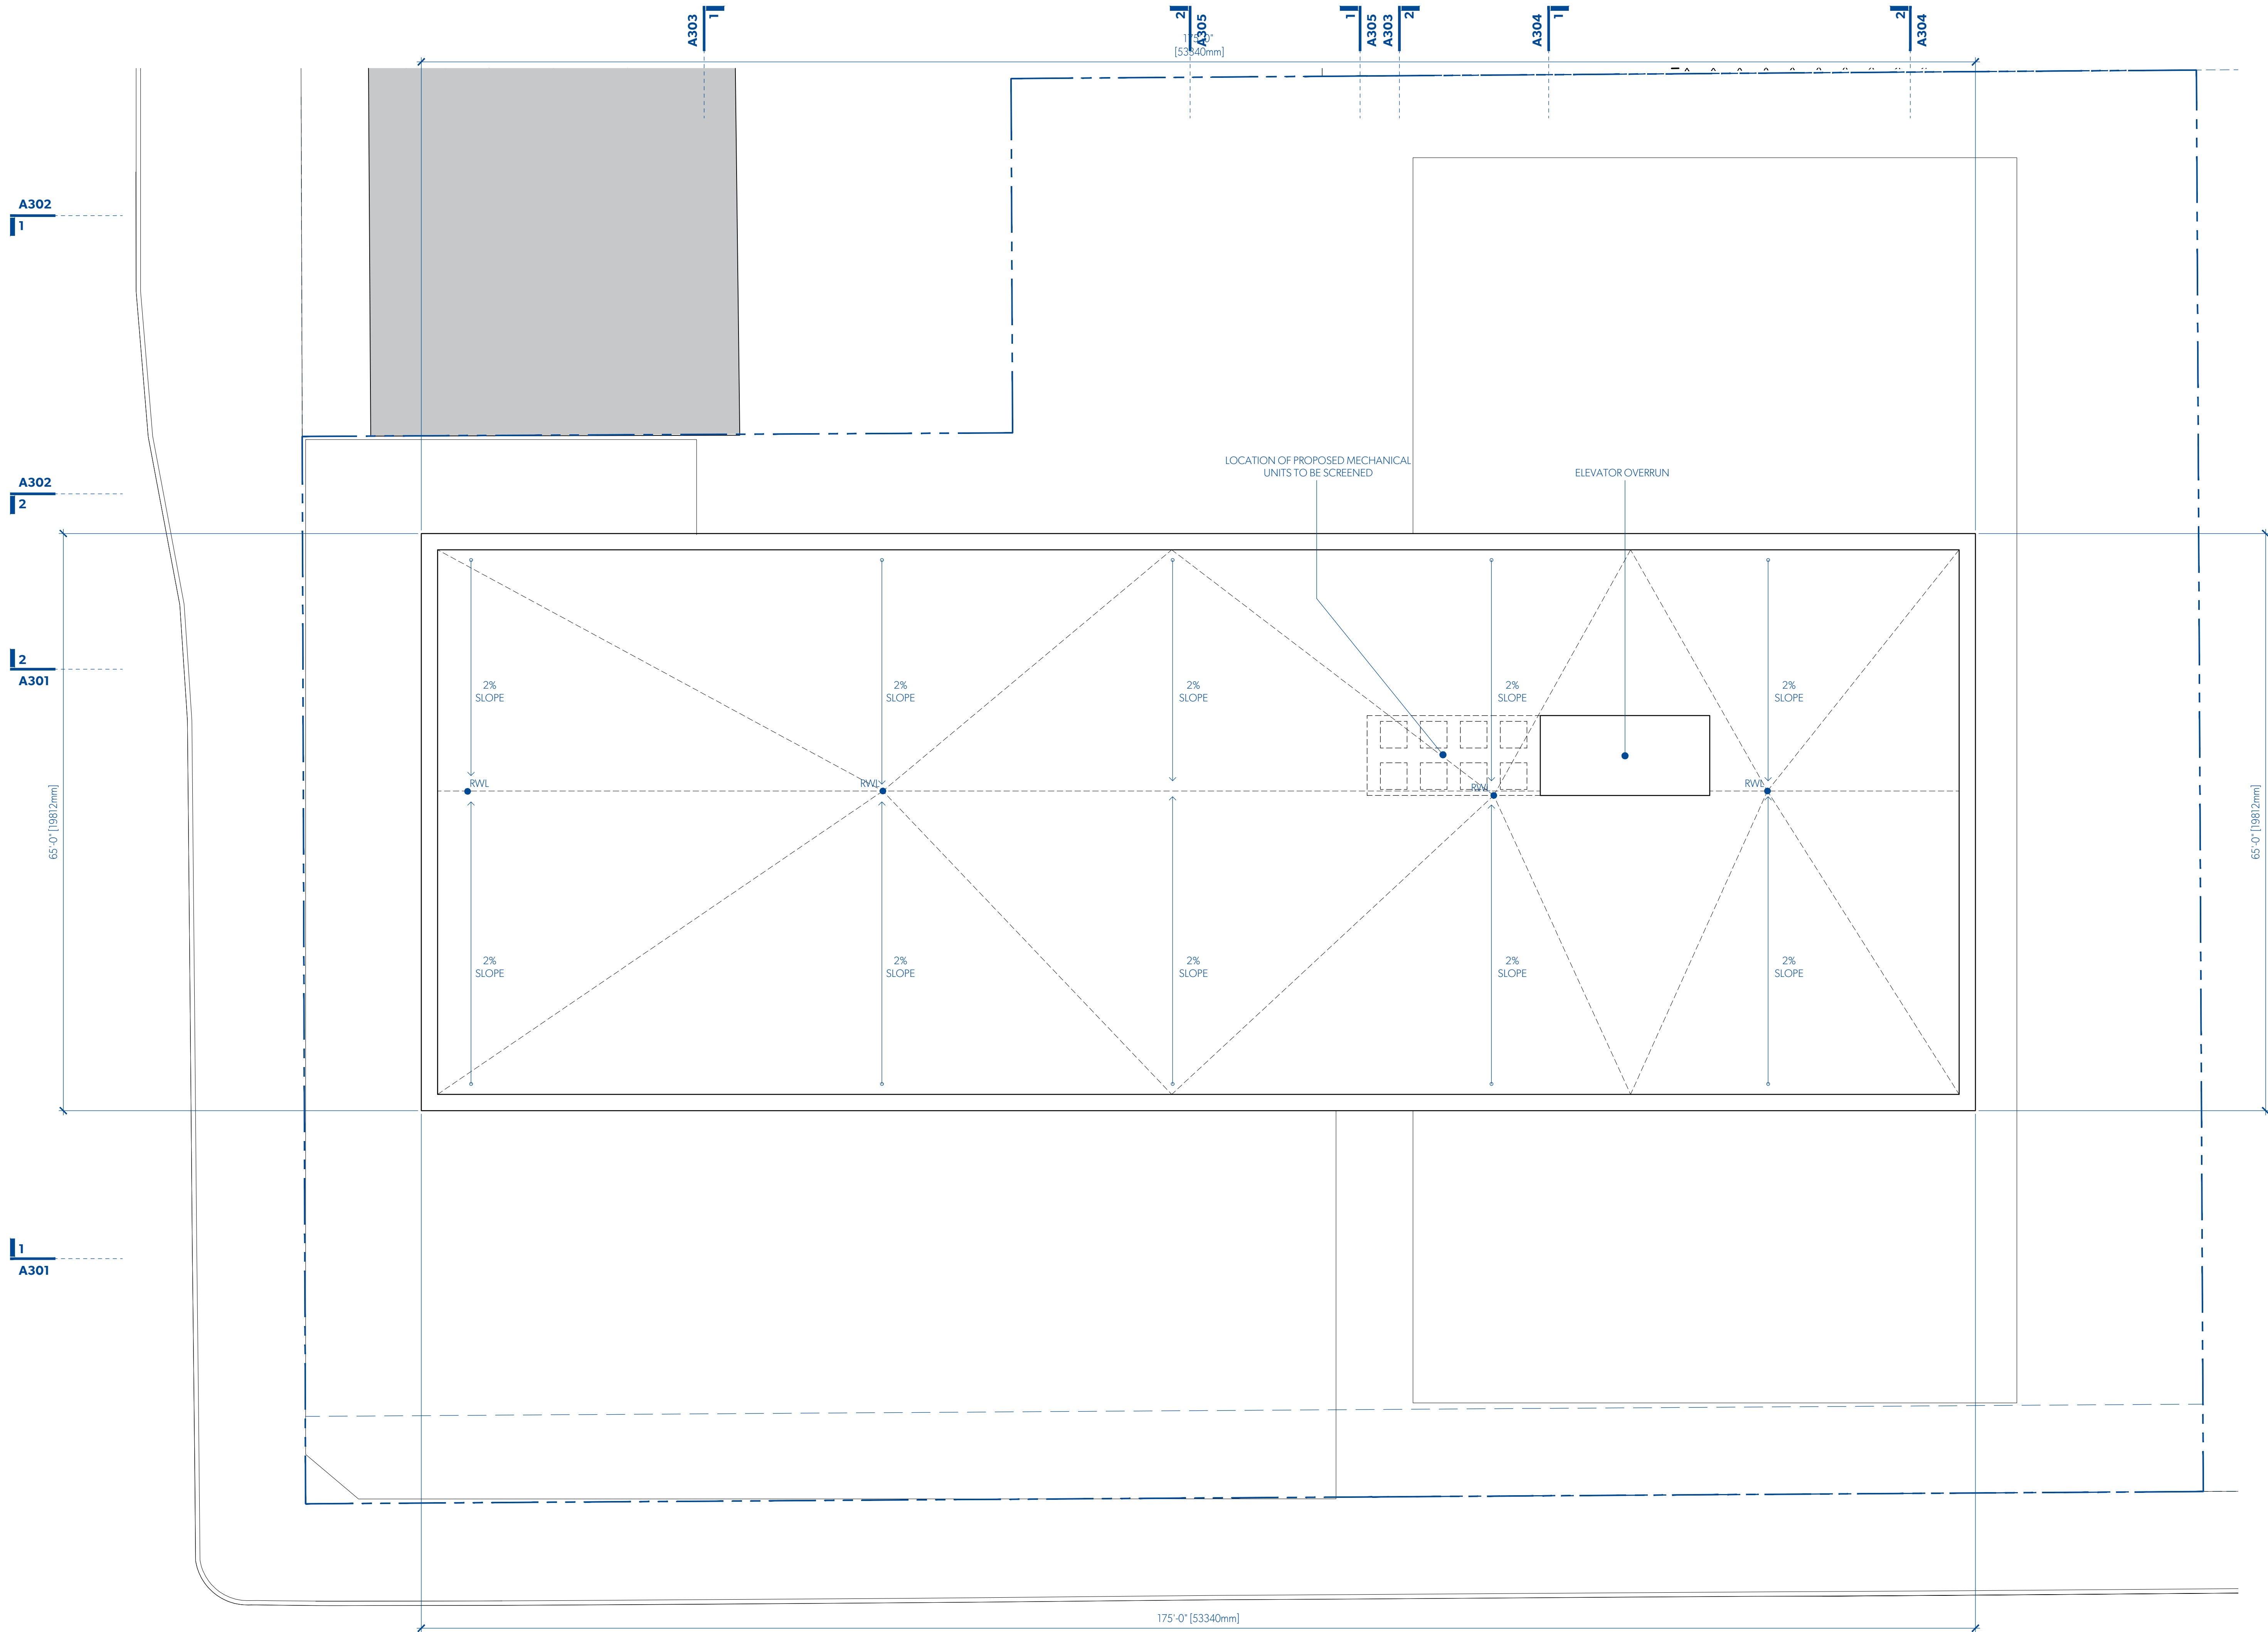

1 **ROOF PLAN**
A107 1:100

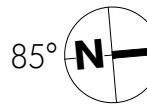

2020-03-20	3	REVISED FOR REZONING
2019-10-30	2	REVISED FOR REZONING
2019-09-13	1	REVISED FOR REZONING
2019-05-15	0	ISSUED FOR REZONING


DATE	REVISION	DESCRIPTION
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PARKWAY

1050 PANDORA AVE + 1518 COOK STREET
VICTORIA, BC
2018-001



1 SOUTH ELEVATION
A201 1:150

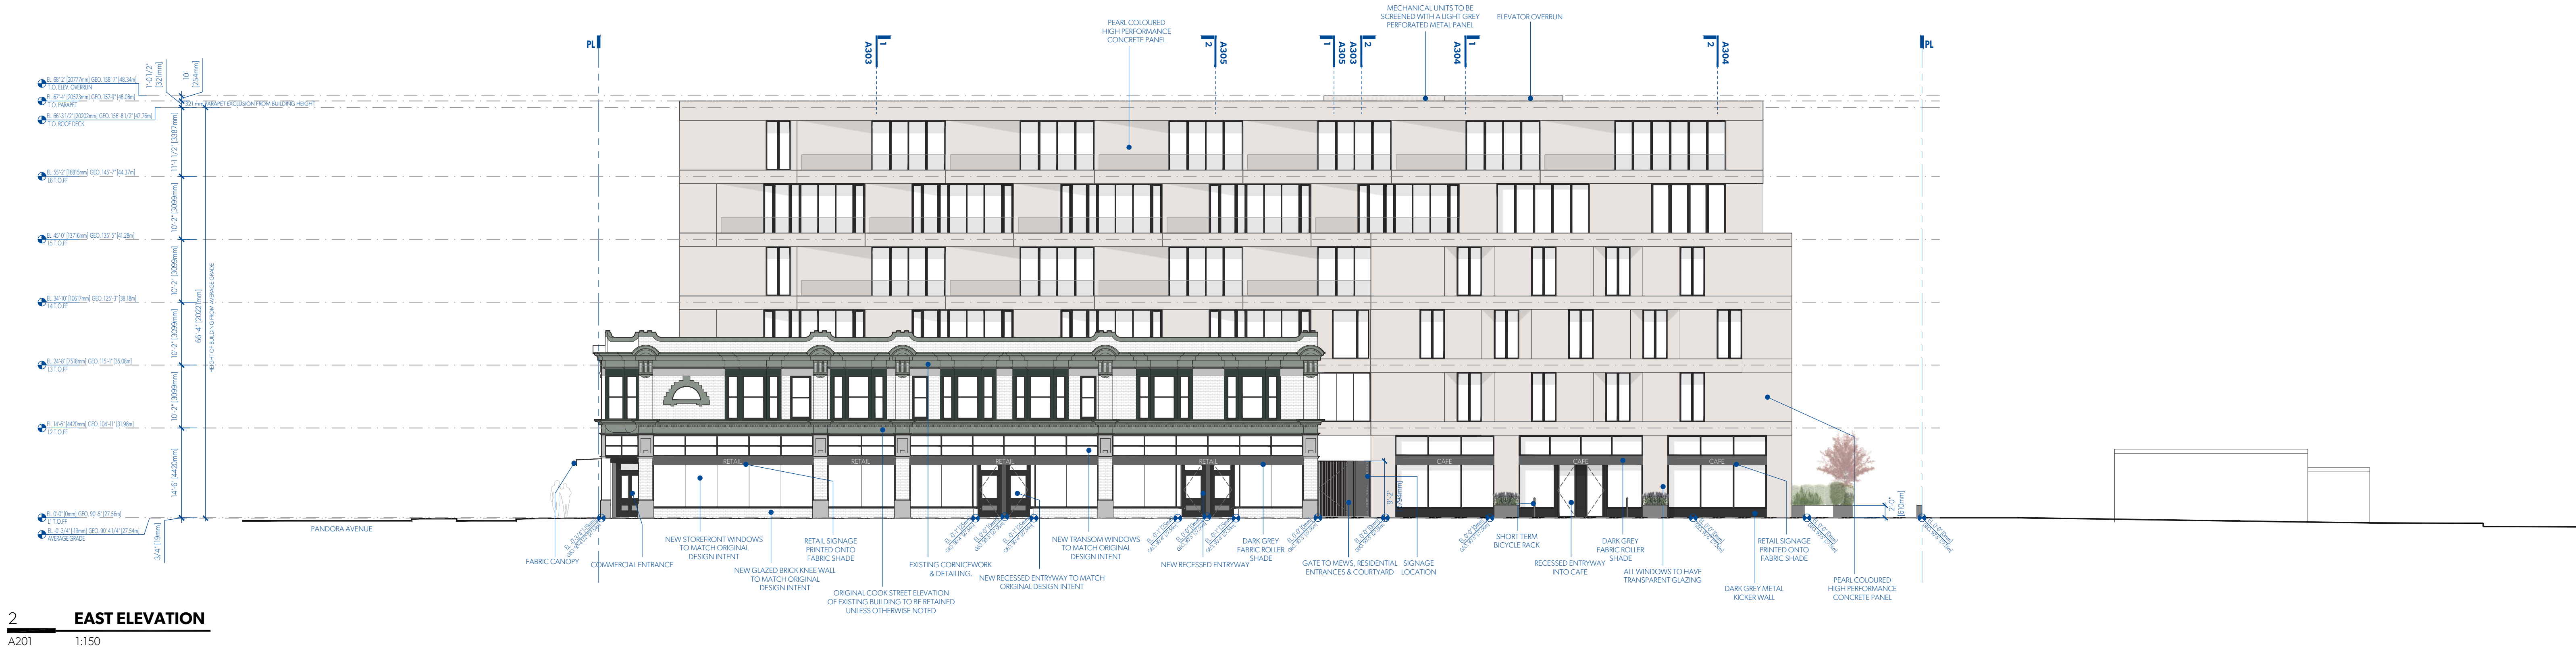

2 EAST ELEVATION
A201 1:150

MGA

MATERIALITY



PEARL COLOURED, ULTRA-HIGH PERFORMANCE CONCRETE PANEL.



TRANSPARENT GLAZING WITH DARK GREY FRAMES.



EXISTING WHITE GLAZED BRICK



EXISTING ORNAMENTAL DETAILING RESTORED TO HERITAGE COLOUR PALETTE



JULIET BALCONIES WITH CLEAR GLASS ON LIVING SPACE WINDOWS FACING FRANKLIN GREEN PARK & HARRIS GREEN PARK

MICHAEL GREEN ARCHITECTURE
1535 W 3RD AVENUE, VANCOUVER BC
CANADA V6J 1J8


2020-03-20	3	REVISED FOR REZONING
2019-10-30	2	REVISED FOR REZONING
2019-09-13	1	REVISED FOR REZONING
2019-05-15	0	ISSUED FOR REZONING

DATE REVISION DESCRIPTION


PARKWAY

1050 PANDORA AVE + 1518 COOK STREET
VICTORIA, BC
2018-001

A201
ELEVATIONS

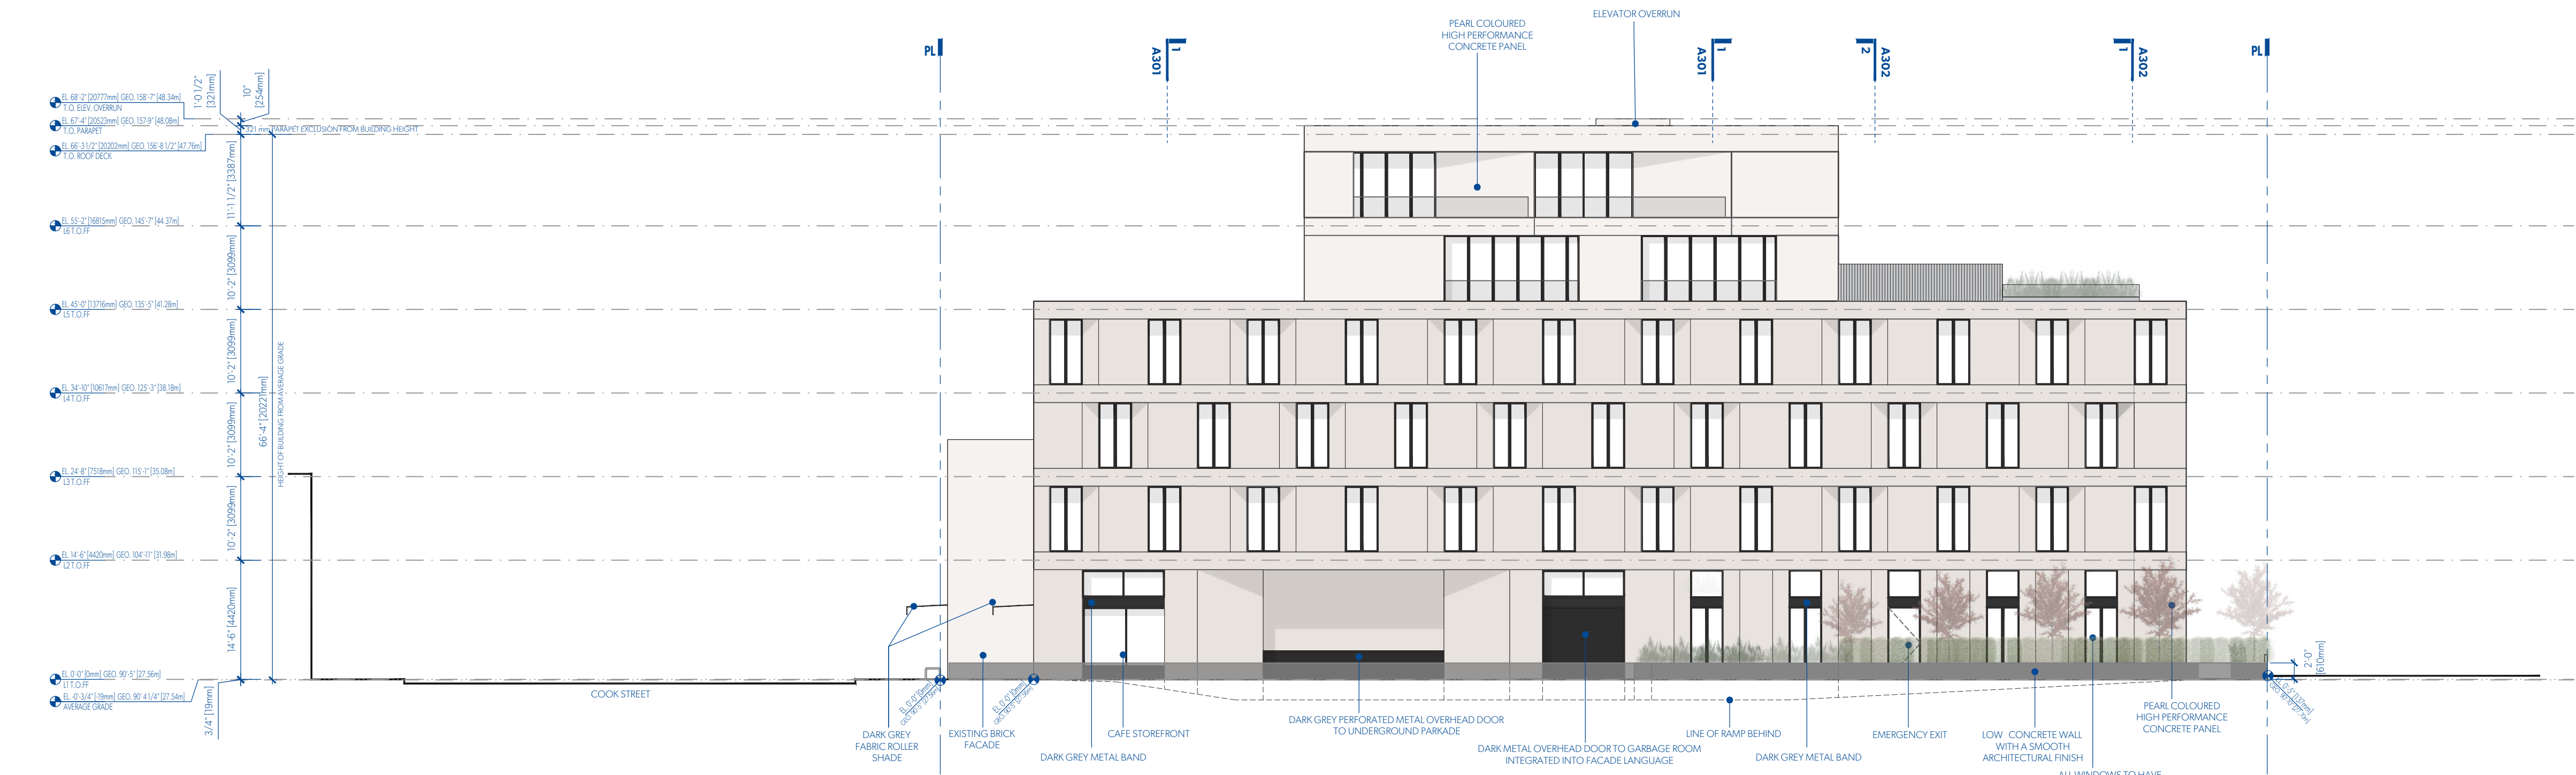

1 NORTH ELEVATION THROUGH PUBLIC WALKWAY
A202 1:150

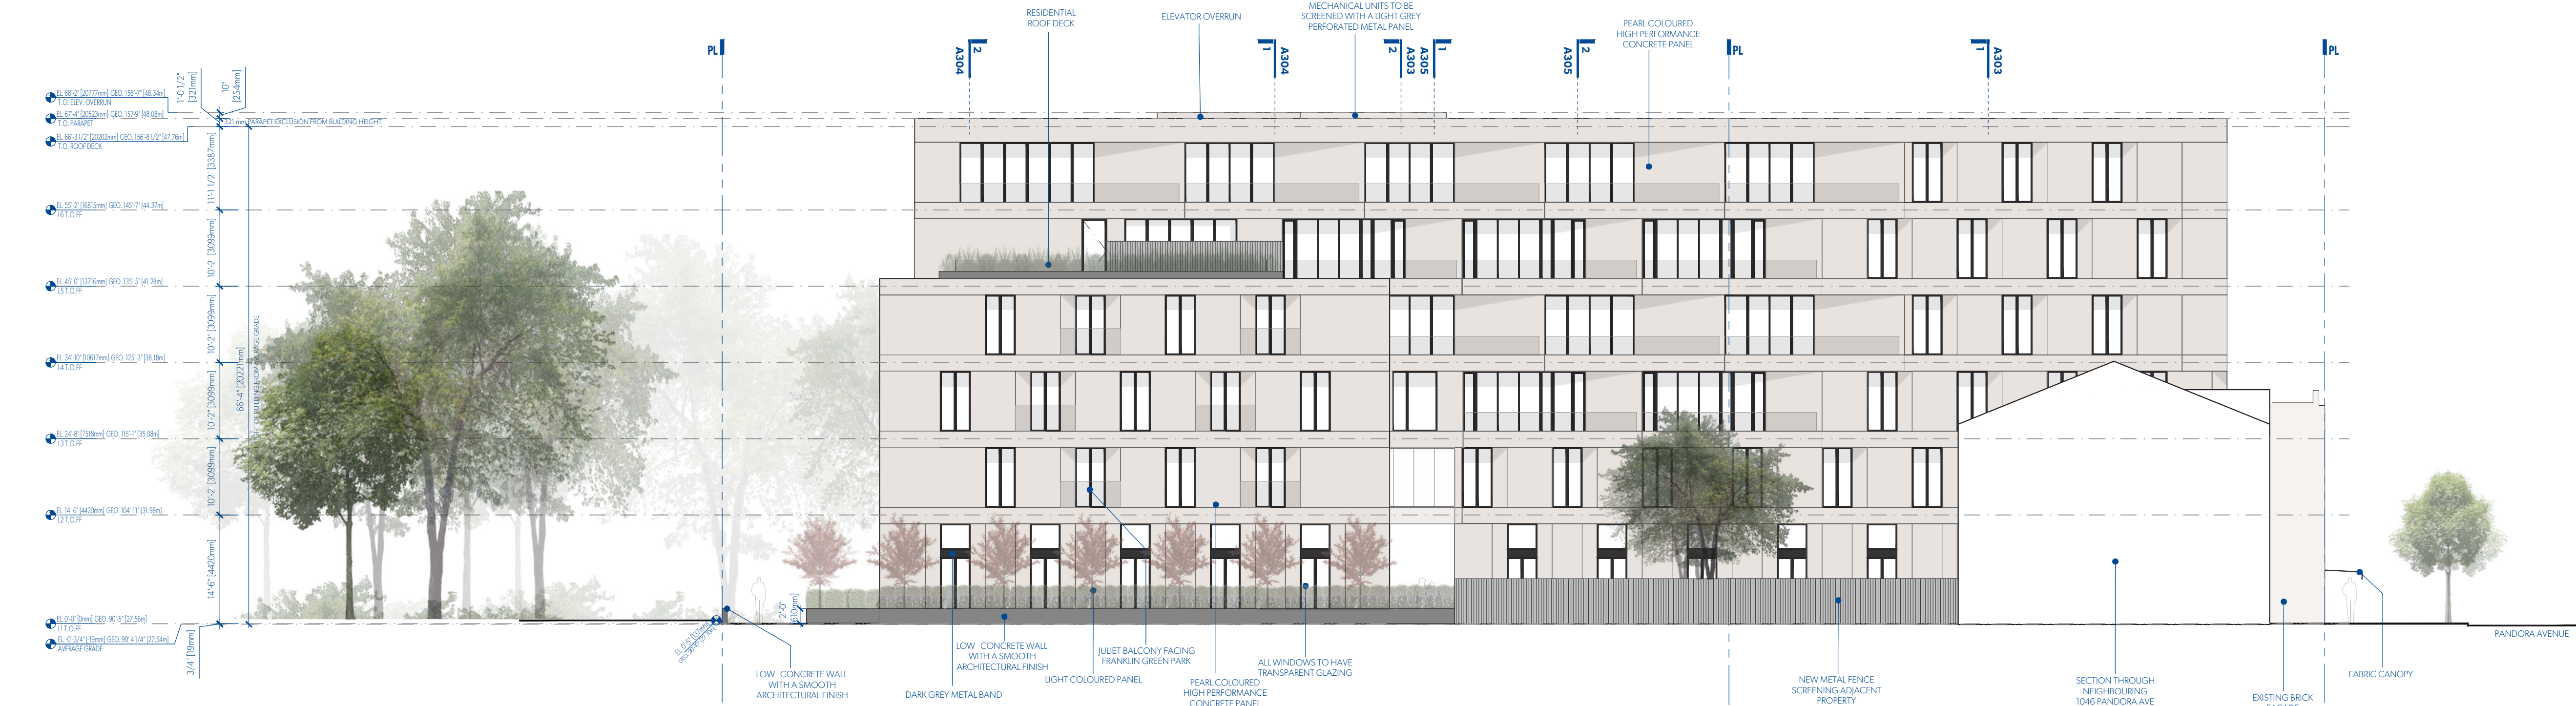

2 WEST ELEVATION
A202 1:150

MGA

© MGA 2016

MATERIALITY



PEARL COLOURED, ULTRA-HIGH PERFORMANCE CONCRETE PANEL



TRANSPARENT GLAZING WITH DARK GREY FRAMES



EXISTING WHITE GLAZED BRICK



EXISTING ORNAMENTAL DETAILING RESTORED TO HERITAGE COLOUR PALETTE



JULIET BALCONIES WITH CLEAR GLASS ON LIVING SPACE WINDOWS FACING FRANKLIN GREEN PARK & HARRIS GREEN PARK

MICHAEL GREEN ARCHITECTURE
1535 W 3RD AVENUE, VANCOUVER BC
CANADA V6J 1J8

2020-03-20	3	REVISED FOR REZONING
2019-10-30	2	REVISED FOR REZONING
2019-09-13	1	REVISED FOR REZONING
2019-05-15	0	ISSUED FOR REZONING

DATE	REVISION	DESCRIPTION
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PARKWAY

1050 PANDORA AVE + 1518 COOK STREET
VICTORIA, BC
2018-001

A202
ELEVATIONS



1 **COOK ST ORIGINAL ELEVATION STUDY**
A203 1:100



2 **COOK ST PROPOSED ELEVATION STUDY**
A203 1:100



3 **PANDORA AVE ORIGINAL ELEVATION STUDY**
A203 1:100



4 **PANDORA AVE PROPOSED ELEVATION STUDY**
A203 1:100



PEARL COLOURED, ULTRA HIGH PERFORMANCE CONCRETE PANEL



TRANSPARENT GLAZING WITH DARK GREY FRAMES



EXISTING WHITE GLAZED BRICK



EXISTING ORNAMENTAL DETAILING RESTORED TO HERITAGE COLOUR PALETTE



JULIET BALCONIES WITH CLEAR GLASS ON LIVING SPACE WINDOWS FACING FRANKLIN GREEN PARK & HARRIS GREEN PARK


MICHAEL GREEN ARCHITECTURE
1535 W 3RD AVENUE, VANCOUVER BC
CANADA V6J 1J8

2020-03-20	3	REVISED FOR REZONING
2019-10-30	2	REVISED FOR REZONING
2019-09-13	1	REVISED FOR REZONING
2019-05-15	0	ISSUED FOR REZONING


DATE REVISION DESCRIPTION

PARKWAY


1050 PANDORA AVE + 1518 COOK STREET
VICTORIA, BC
2018-001

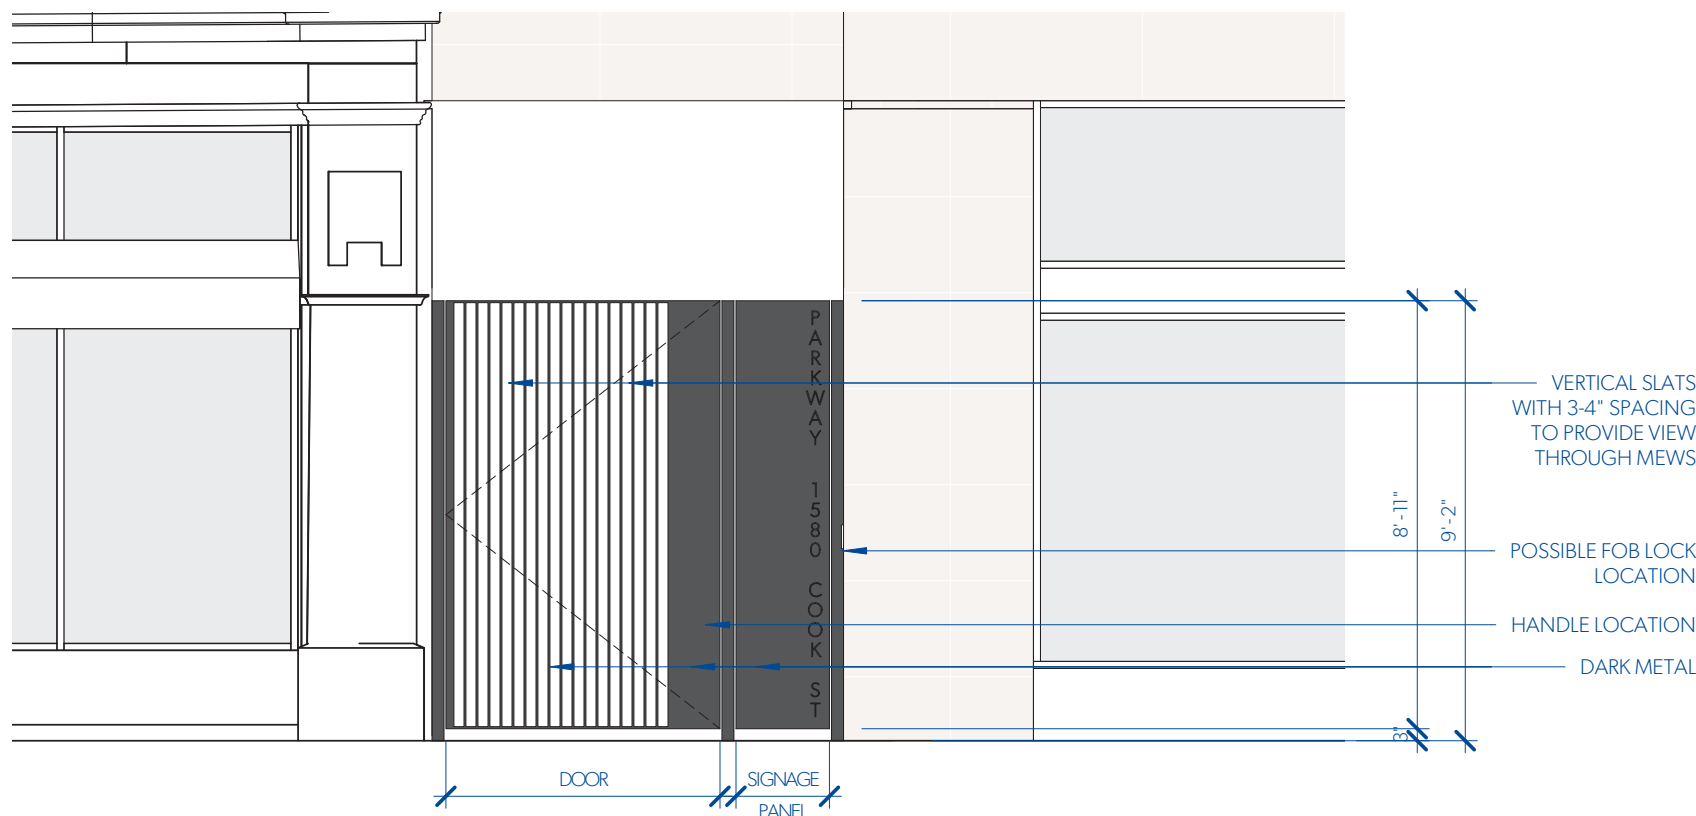


1 ENTRY GATE (CLOSED) - ELEVATION
A204 1:50

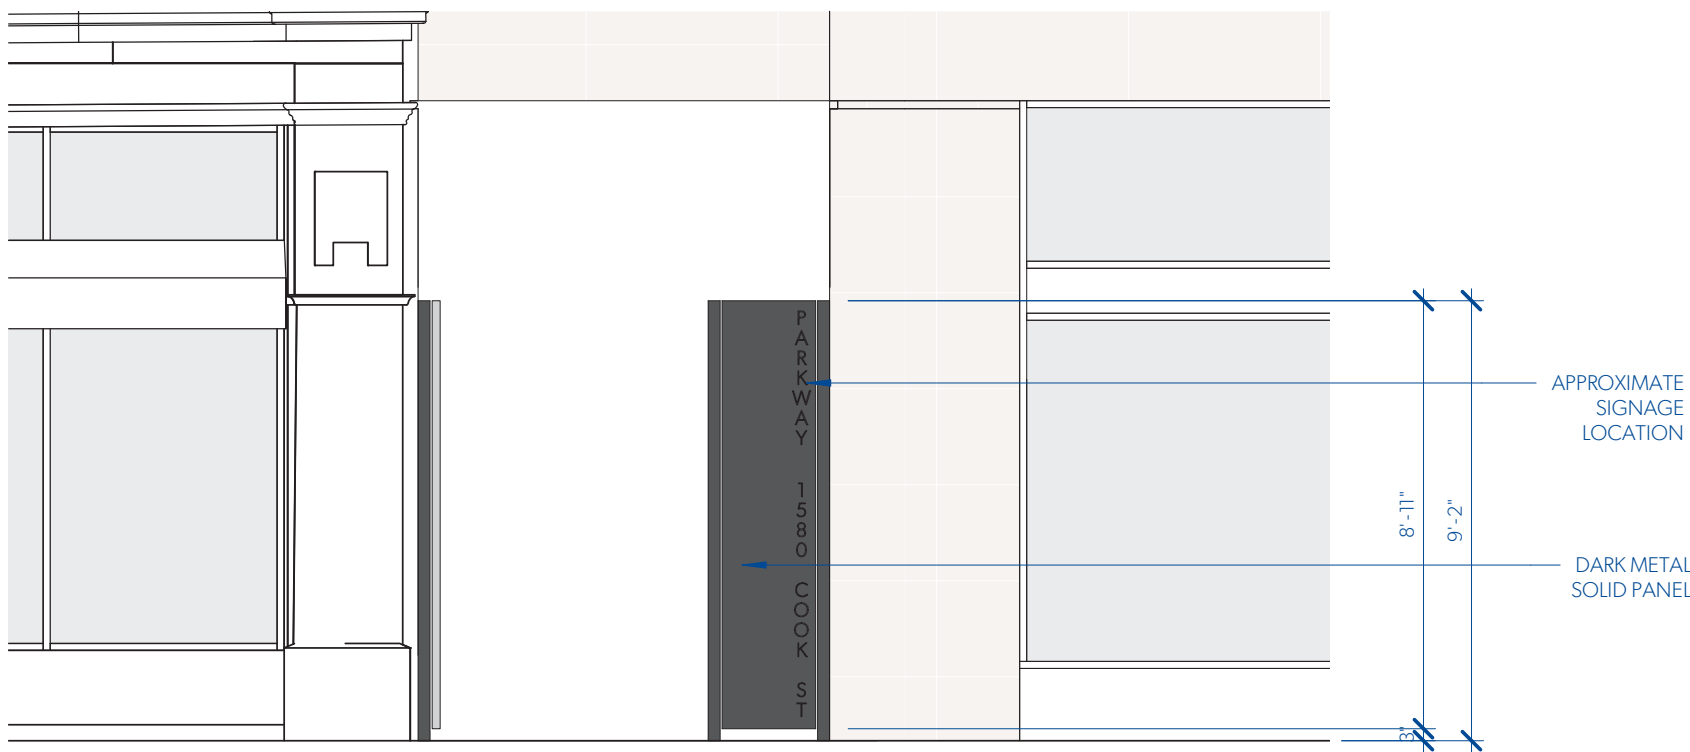


2 ENTRY GATE (OPEN) - ELEVATION
A204 1:50

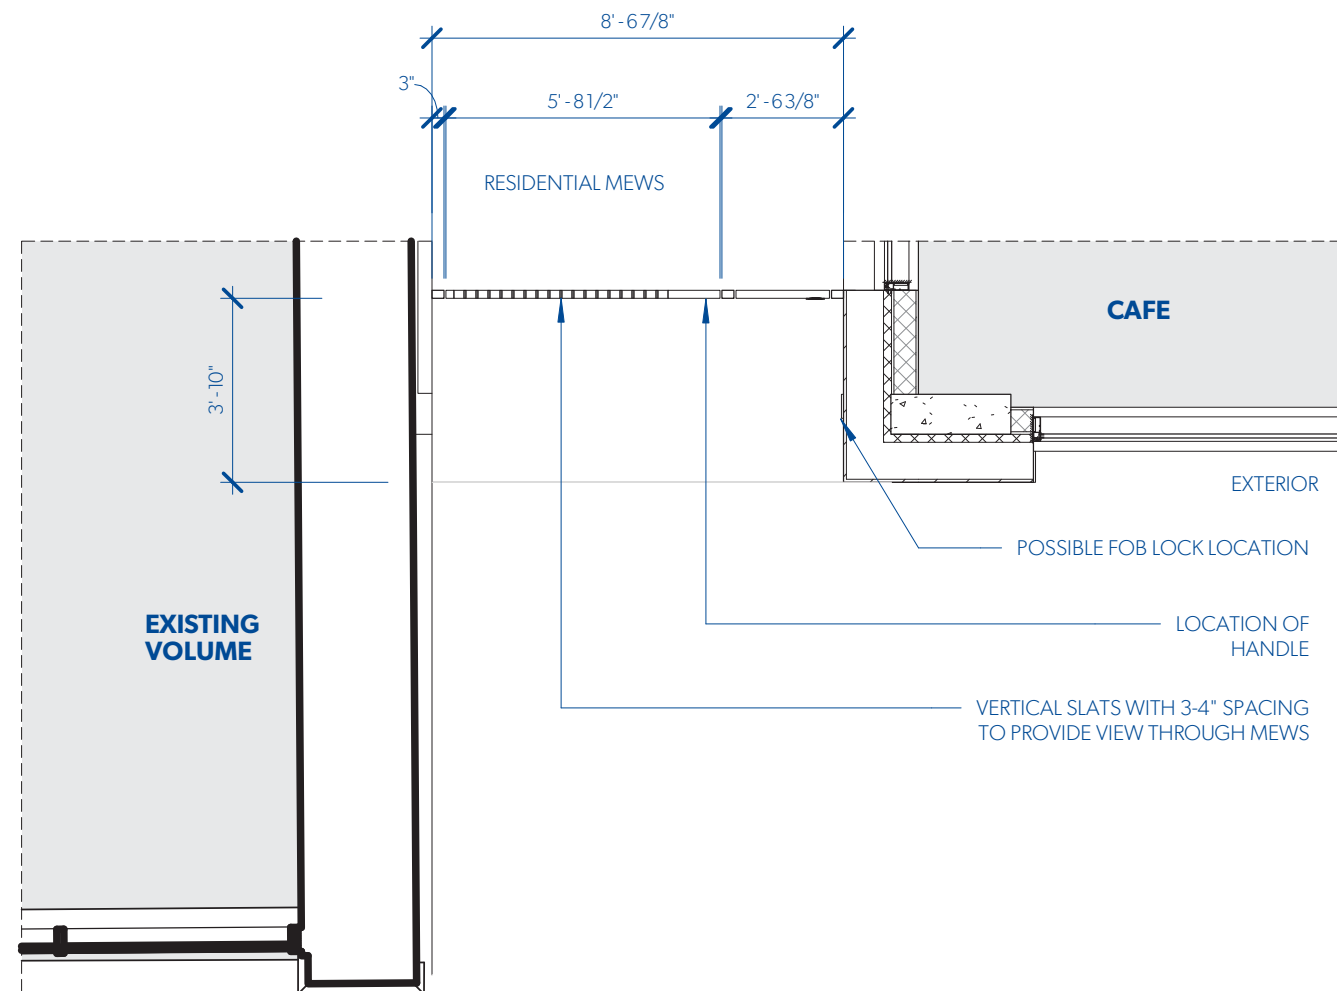


3 ENTRY GATE (CLOSED) - PLAN
A204 1:50

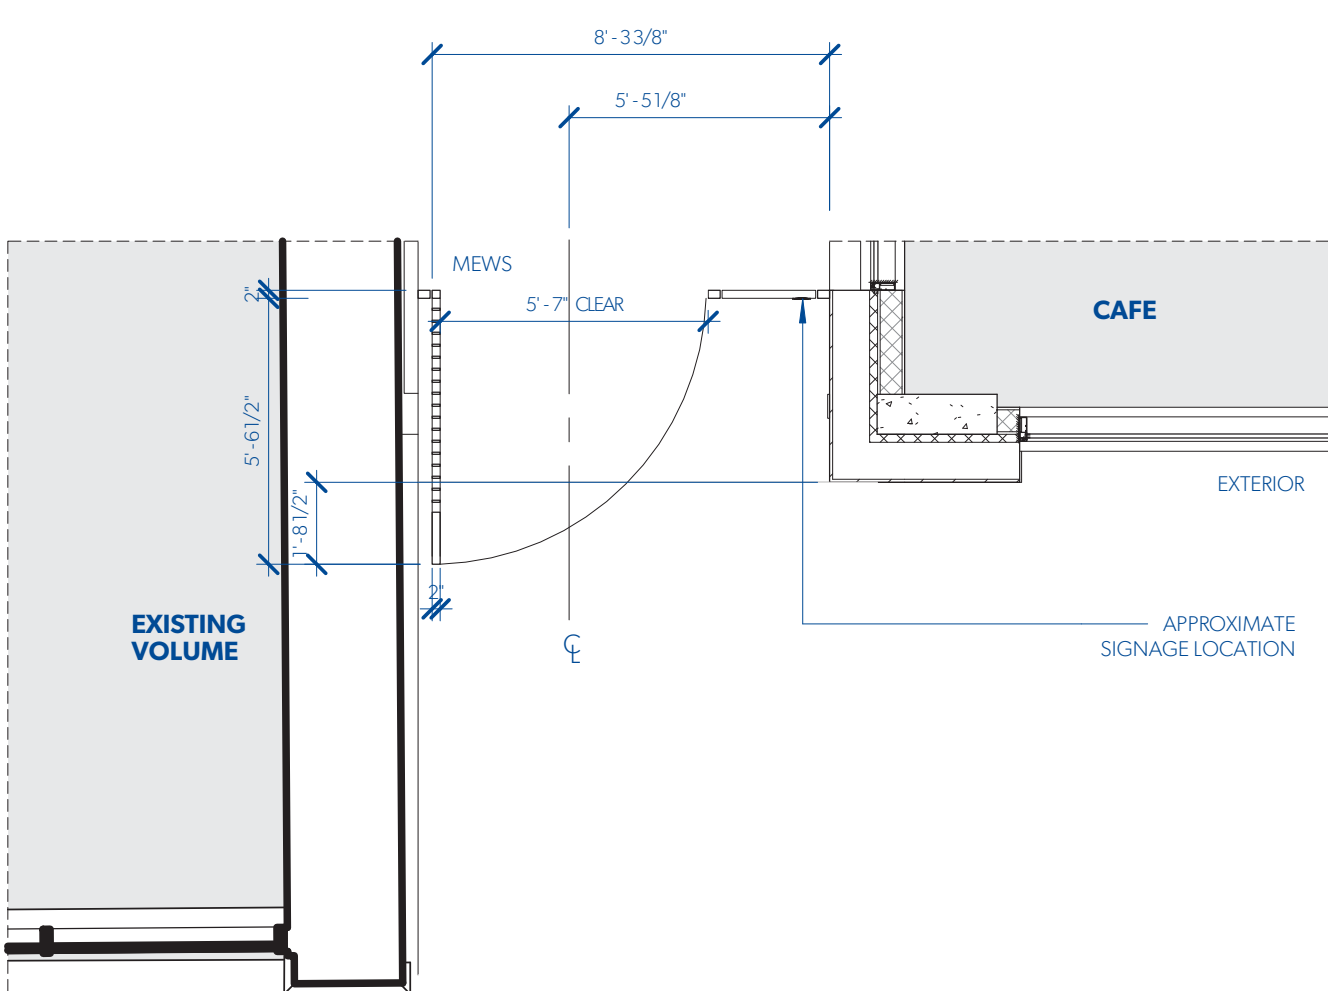

4 ENTRY GATE (OPEN) - PLAN
A204 1:50

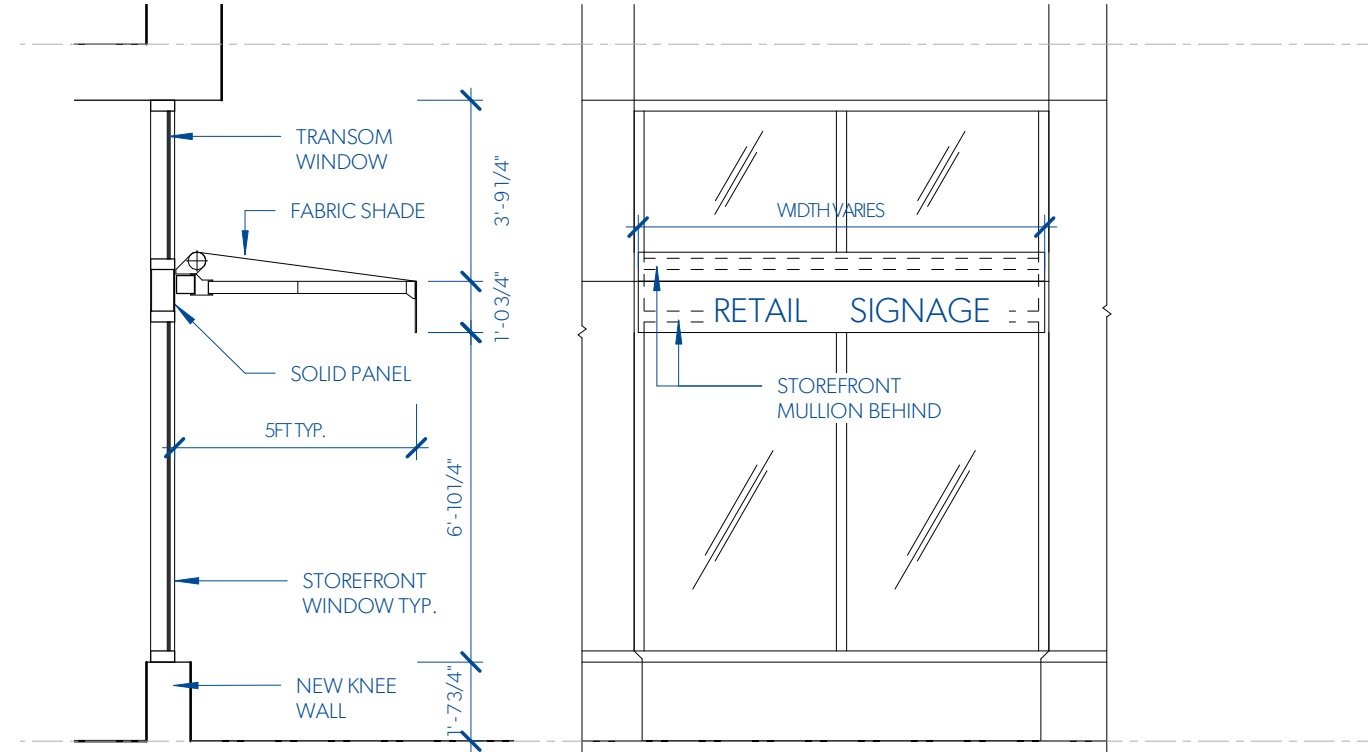

5 CANOPY & SIGNAGE STUDY
A204 1:50

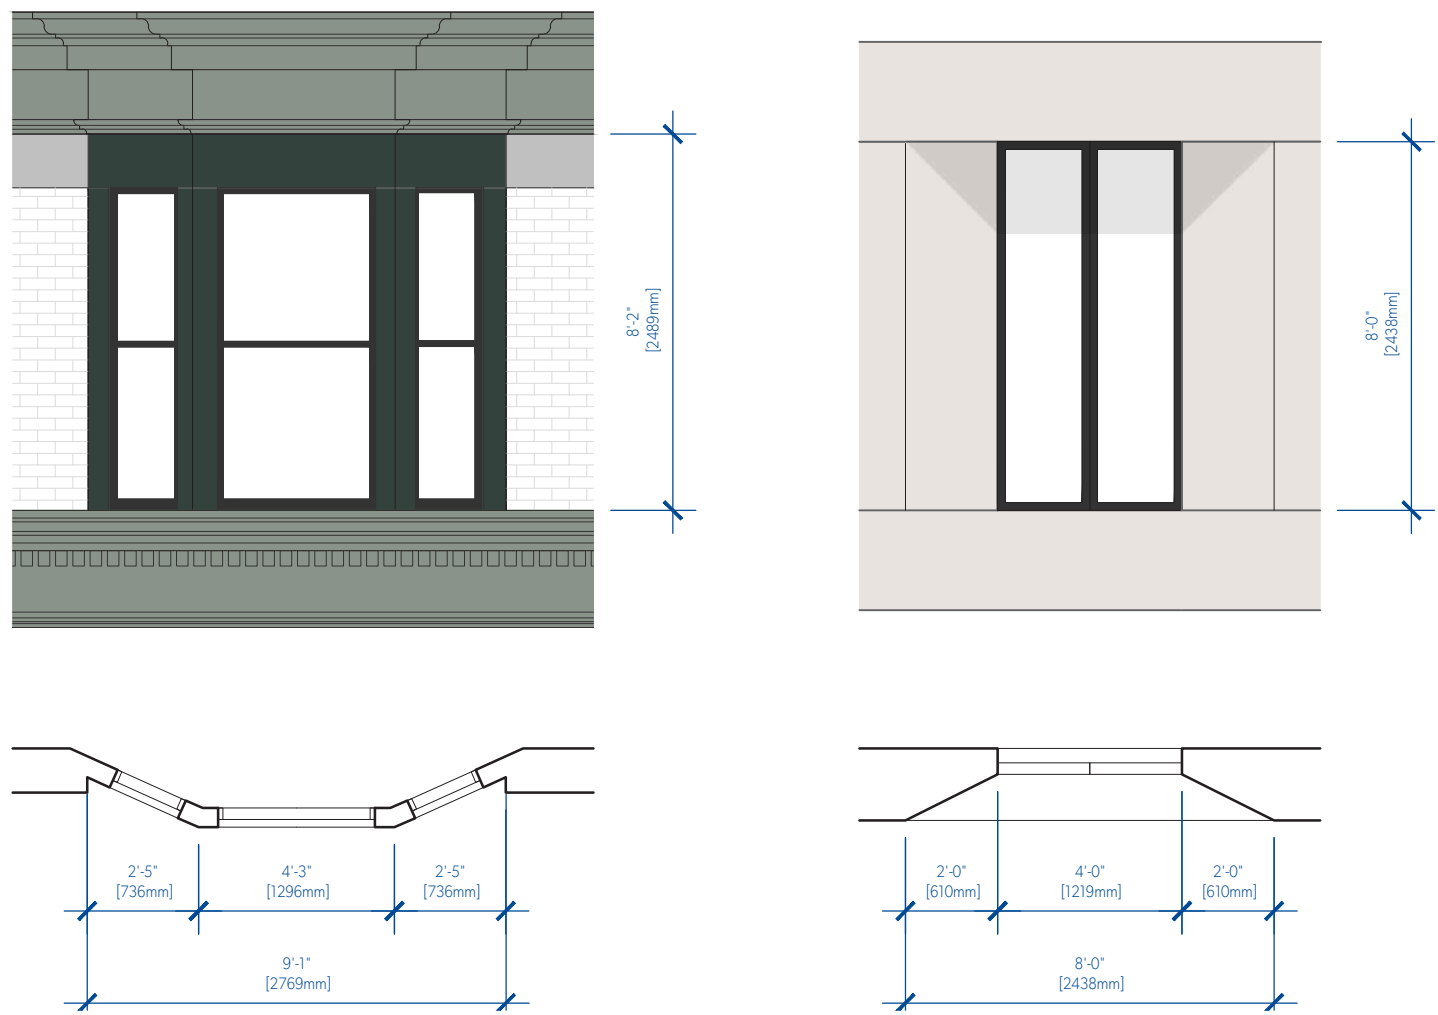

6 WINDOW PROPORTION STUDY
A204 1:50

MGA

MATERIALITY



PEARL COLOURED, ULTRA-HIGH PERFORMANCE CONCRETE PANEL



TRANSPARENT GLAZING WITH DARK GREY FRAMES



EXISTING WHITE GLAZED BRICK



EXISTING ORNAMENTAL DETAILING RESTORED TO HERITAGE COLOUR PALETTE



JULIET BALCONIES WITH CLEAR GLASS ON LIVING SPACE WINDOWS FACING FRANKLIN GREEN PARK & HARRIS GREEN PARK

MICHAEL GREEN ARCHITECTURE
1535 W 3RD AVENUE, VANCOUVER BC
CANADA V6J 1J8

2020-03-20	3	REVISED FOR REZONING
2019-10-30	2	REVISED FOR REZONING
2019-09-13	1	REVISED FOR REZONING
2019-05-15	0	ISSUED FOR REZONING

DATE	REVISION	DESCRIPTION
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PARKWAY

1050 PANDORA AVE + 1518 COOK STREET
VICTORIA, BC
2018-001

A204
FACADE STUDIES



1 PANDORA AVENUE STREETSCAPE
A251 NTS




2 COOK STREET STREETSCAPE
A251 NTS

2020-03-20	3	REVISED FOR REZONING
2019-10-30	2	REVISED FOR REZONING
2019-09-13	1	REVISED FOR REZONING
2019-05-15	0	ISSUED FOR REZONING


DATE	REVISION	DESCRIPTION
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PARKWAY

1050 PANDORA AVE + 1518 COOK STREET
VICTORIA, BC
2018-001

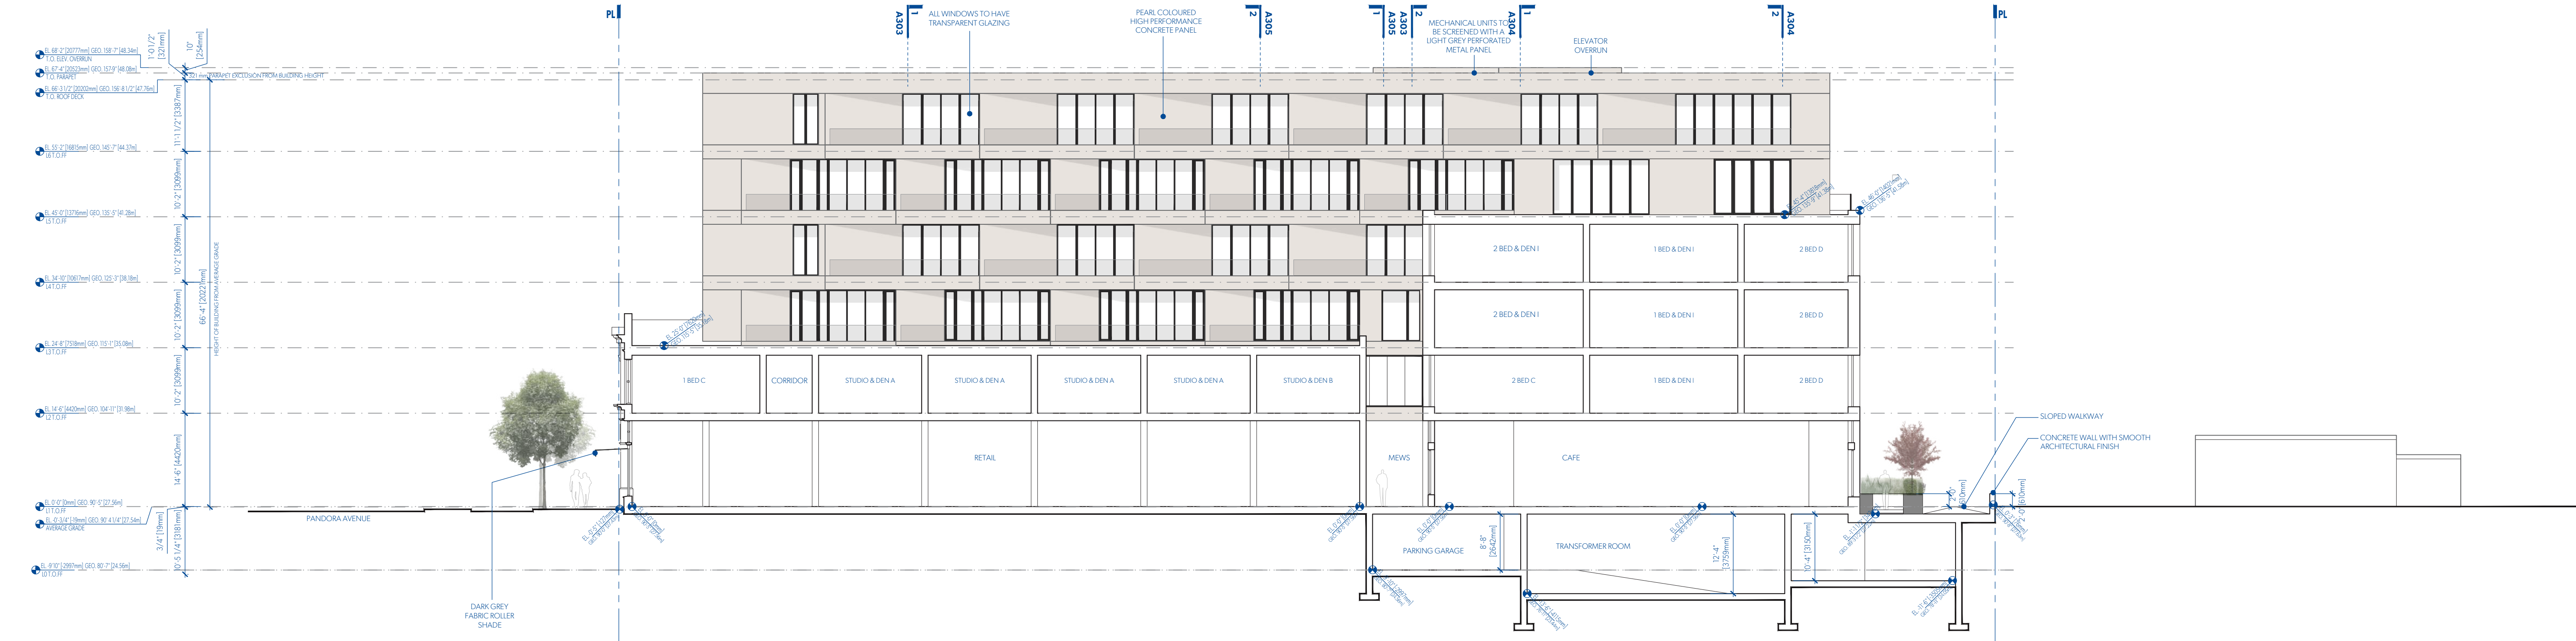

1 SECTION LOOKING WEST THROUGH EXISTING BUILDING & NEW 4 STOREY VOLUME
A301 1:150

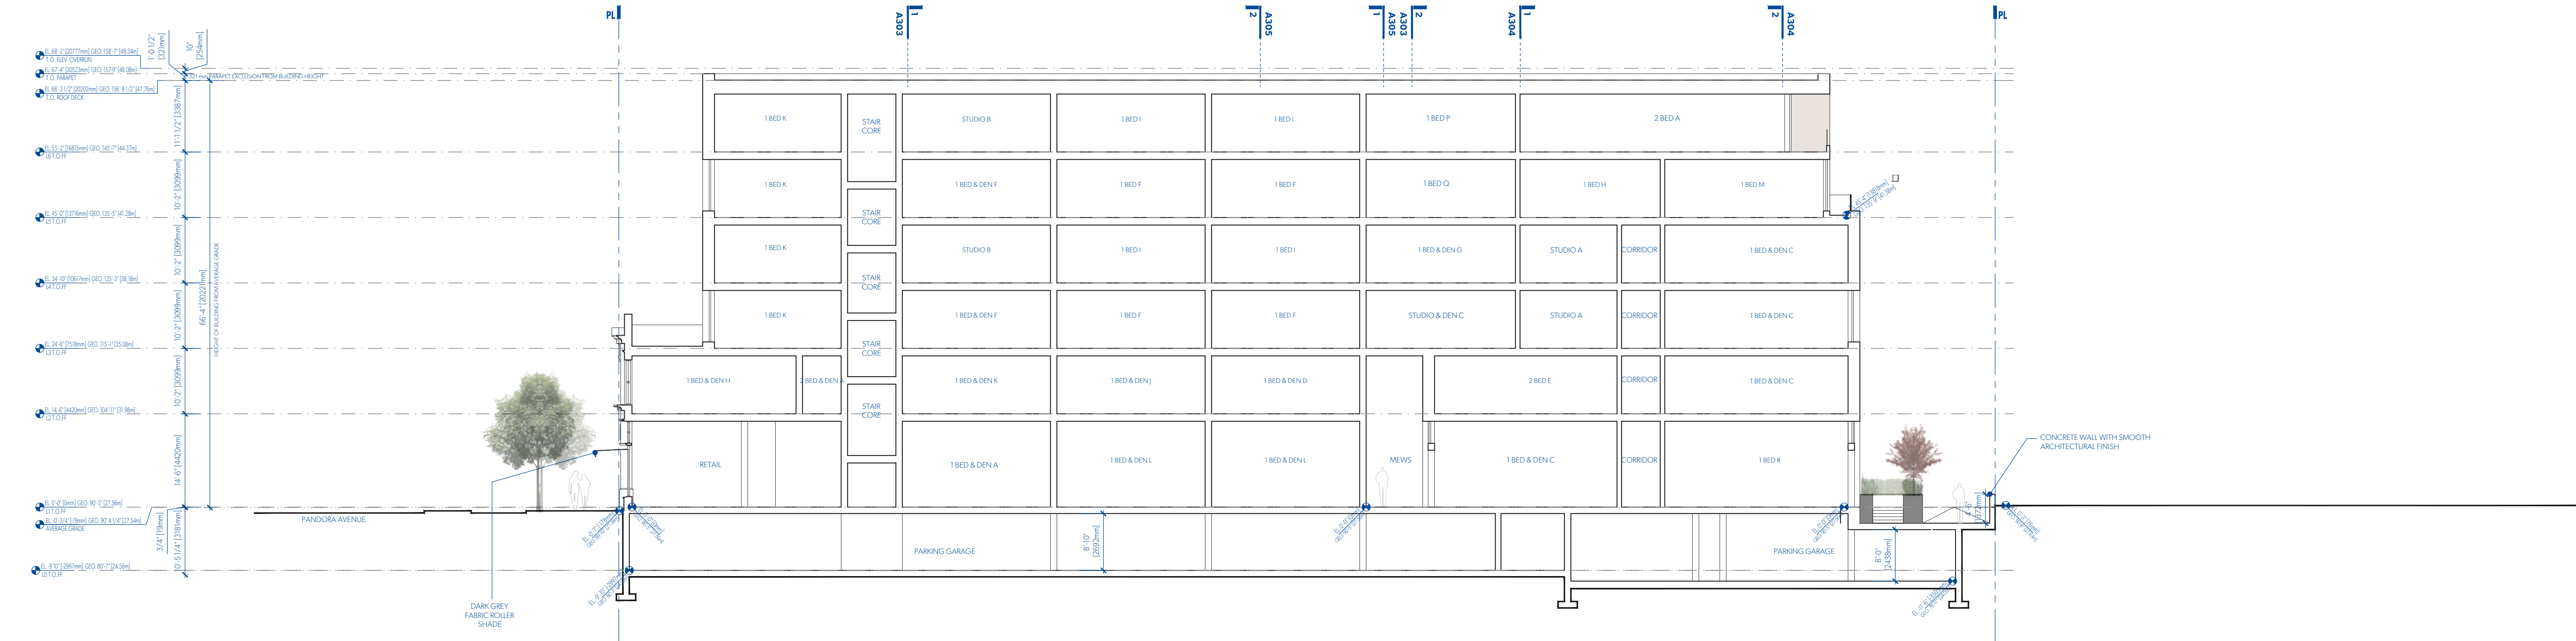

2 SECTION LOOKING WEST THROUGH NEW 6 STOREY VOLUME
A301 1:150

MGA

MATERIALITY



PEARL COLOURED, ULTRA-HIGH PERFORMANCE CONCRETE PANEL



TRANSPARENT GLAZING WITH DARK GREY FRAMES



EXISTING WHITE GLAZED BRICK



EXISTING ORNAMENTAL DETAILING RESTORED TO HERITAGE COLOUR PALETTE



JULIET BALCONIES WITH CLEAR GLASS ON LIVING SPACE WINDOWS FACING FRANKLIN GREEN PARK & HARRIS GREEN PARK

MICHAEL GREEN ARCHITECTURE
1535 W 3RD AVENUE, VANCOUVER BC
CANADA V6J 1J8


2020-03-20	3	REVISED FOR REZONING
2019-10-30	2	REVISED FOR REZONING
2019-09-13	1	REVISED FOR REZONING
2019-05-15	0	ISSUED FOR REZONING

DATE REVISION DESCRIPTION


PARKWAY

1050 PANDORA AVE + 1518 COOK STREET
VICTORIA, BC
2018-001

A301
SECTIONS

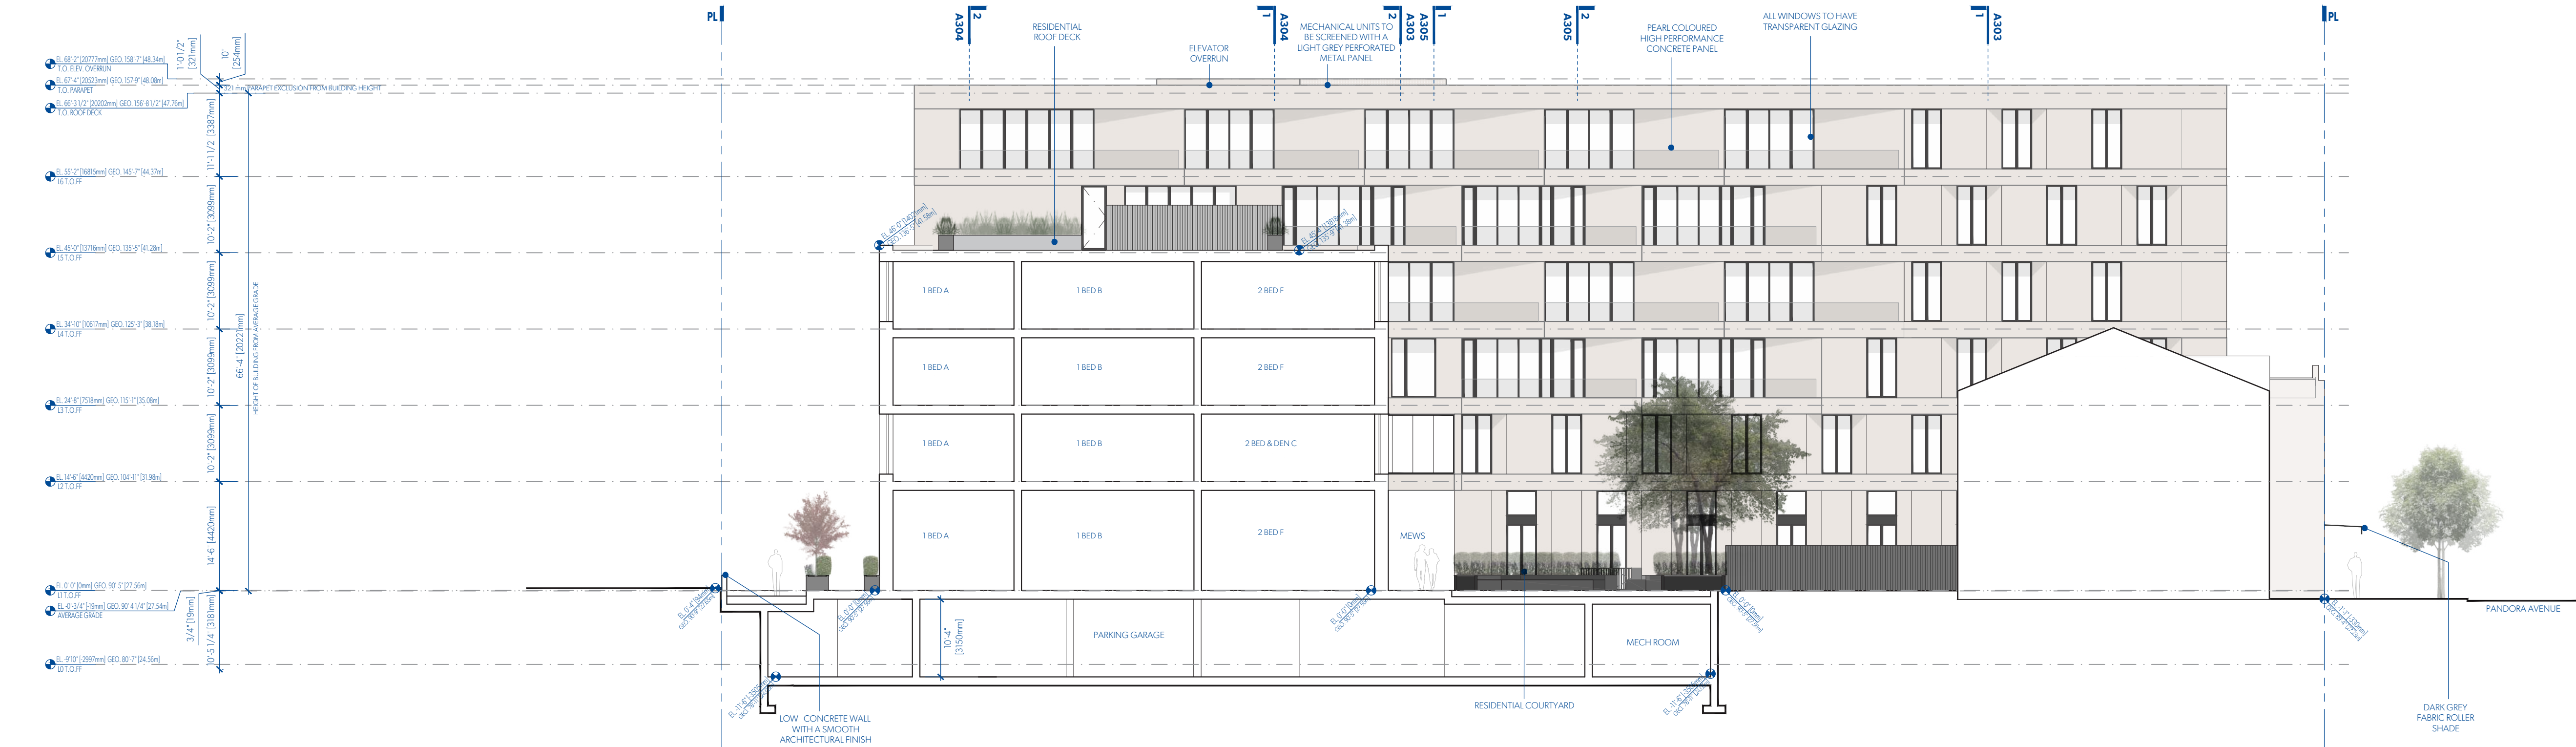

1 SECTION LOOKING EAST THROUGH NEW 4 STOREY VOLUME
A302 1:150

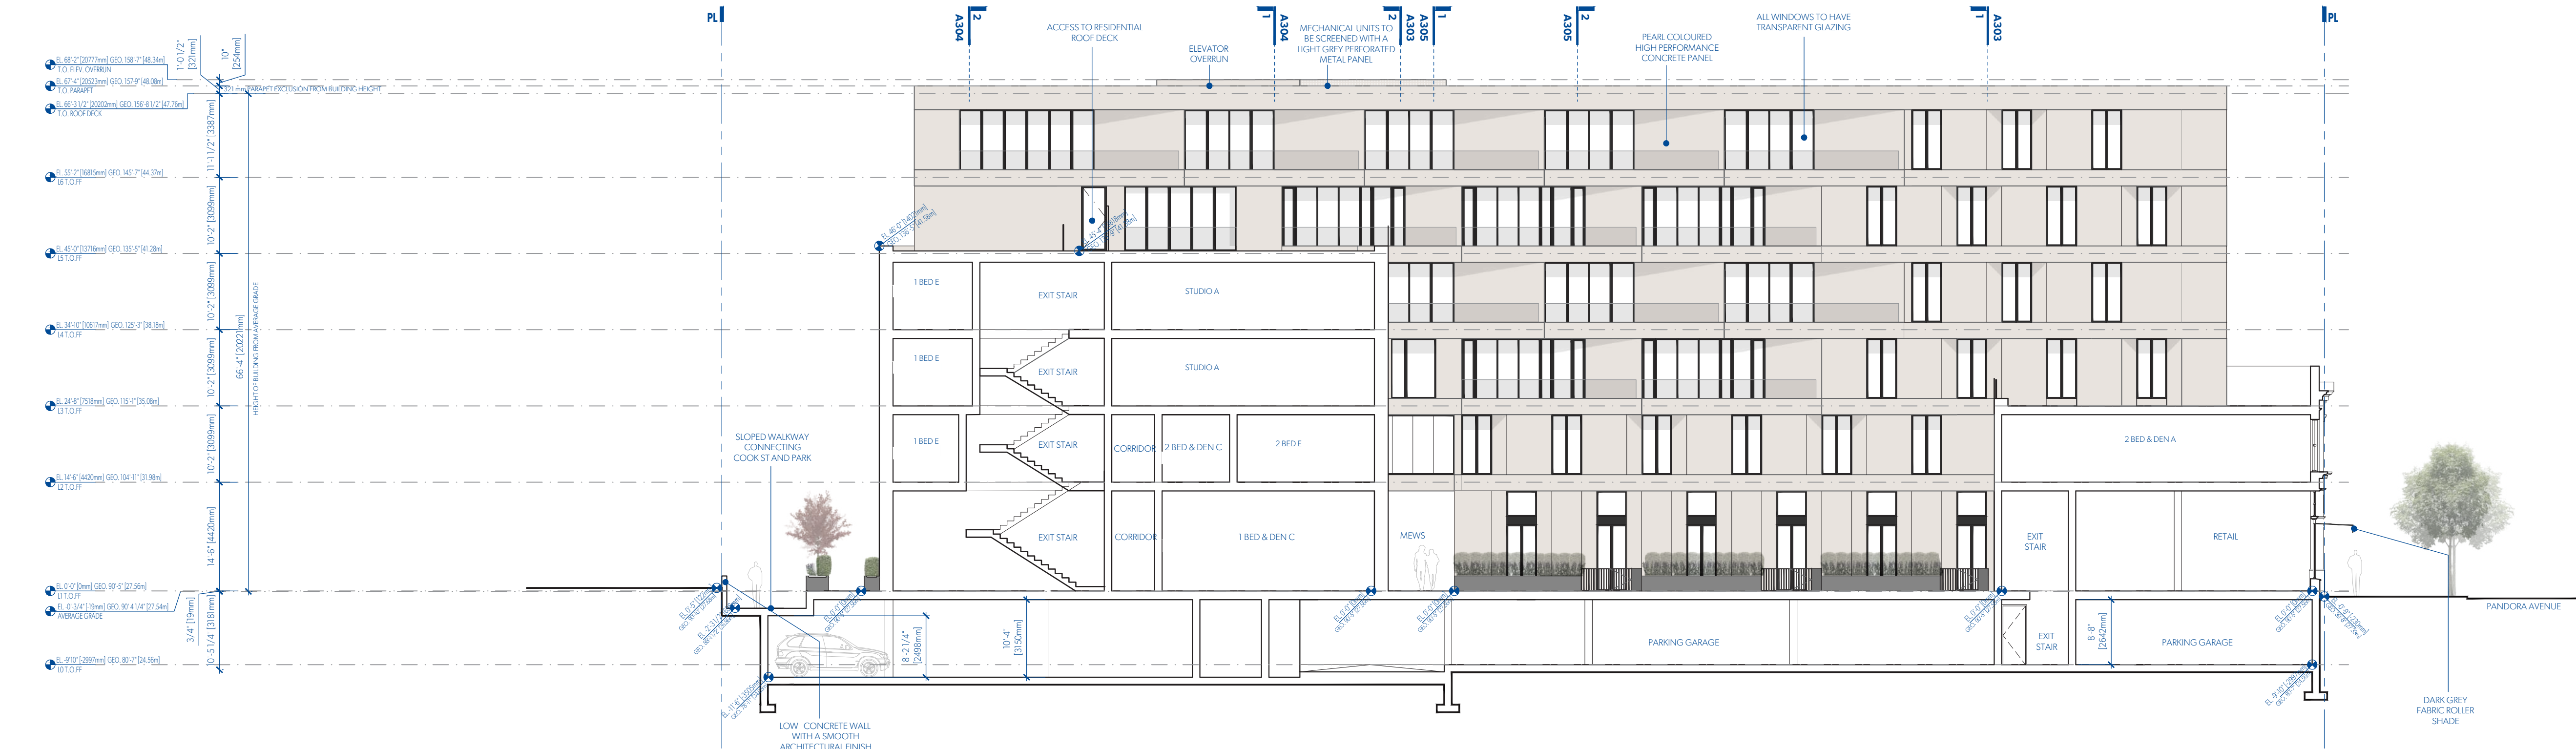

2 SECTION LOOKING EAST THROUGH NEW 4 STOREY VOLUME & EXISTING BUILDING
A302 1:150



PEARL COLOURED, ULTRA-HIGH PERFORMANCE CONCRETE PANEL



TRANSPARENT GLAZING WITH DARK GREY FRAMES



EXISTING WHITE GLAZED BRICK



EXISTING ORNAMENTAL DETAILING RESTORED TO HERITAGE COLOUR PALETTE



JULIET BALCONIES WITH CLEAR GLASS ON LIVING SPACE WINDOWS FACING FRANKLIN GREEN PARK & HARRIS GREEN PARK


MICHAEL GREEN ARCHITECTURE
1535 W 3RD AVENUE, VANCOUVER BC
CANADA V6J 1J8

2020-03-20	3	REVISED FOR REZONING
2019-10-30	2	REVISED FOR REZONING
2019-09-13	1	REVISED FOR REZONING
2019-05-15	0	ISSUED FOR REZONING


DATE	REVISION	DESCRIPTION
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PARKWAY

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VICTORIA, BC
2018-001

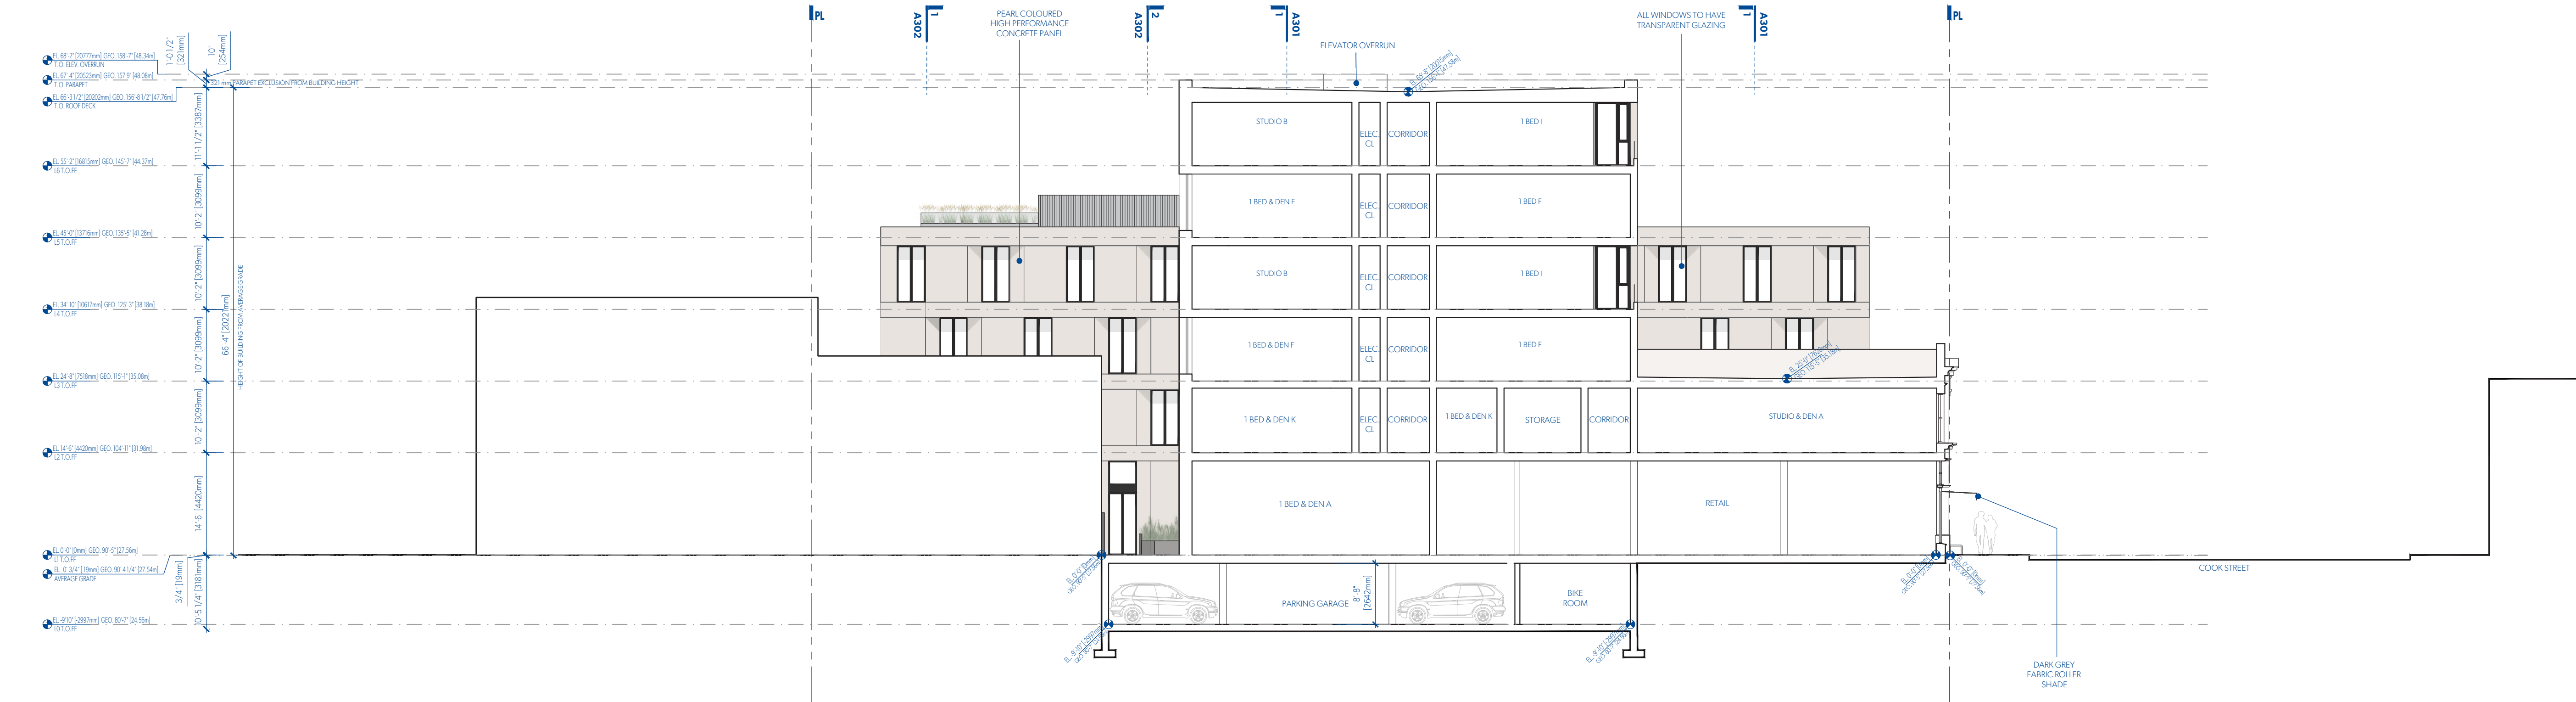

1 SECTION LOOKING NORTH THROUGH EXISTING BUILDING & NEW 6 STOREY VOLUME
A303 1:150

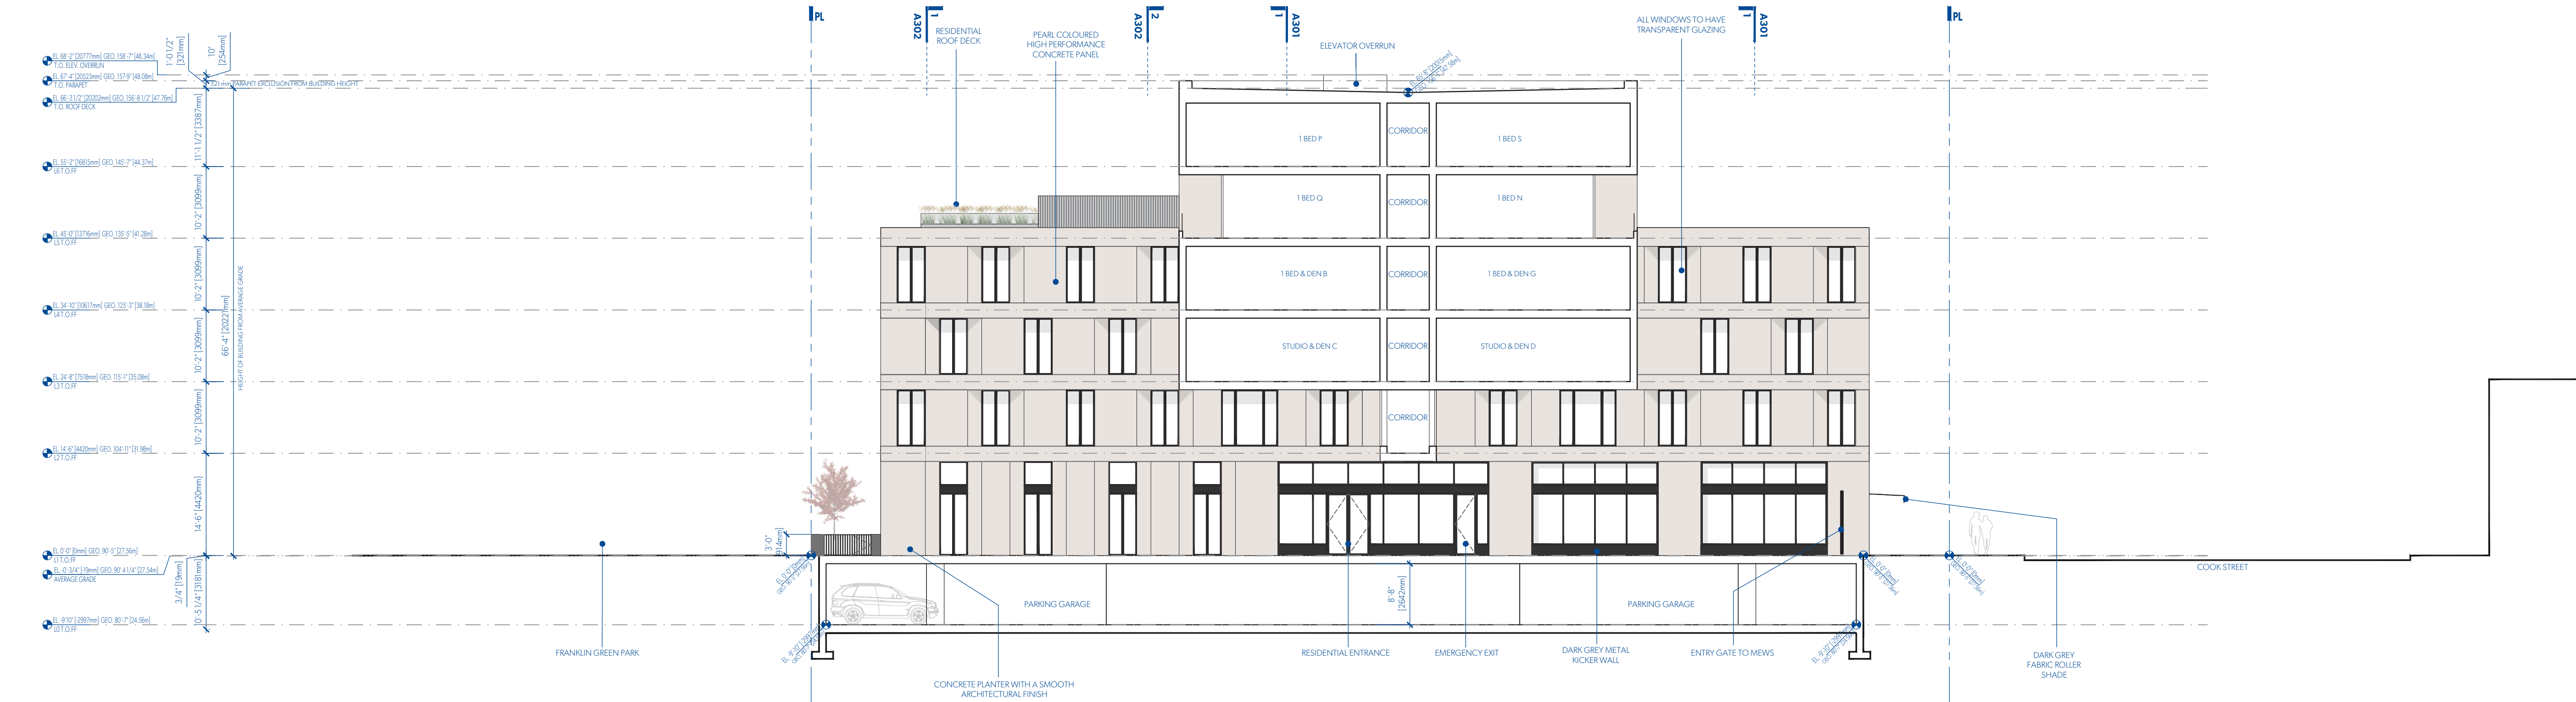

2 SECTION LOOKING NORTH THROUGH NEW 6 STOREY VOLUME
A303 1:150

MGA

MATERIALITY



PEARL COLOURED, ULTRA-HIGH PERFORMANCE CONCRETE PANEL



TRANSPARENT GLAZING WITH DARK GREY FRAMES



EXISTING WHITE GLAZED BRICK



EXISTING ORNAMENTAL DETAILING RESTORED TO HERITAGE COLOUR PALETTE



JULIET BALCONIES WITH CLEAR GLASS ON LIVING SPACE WINDOWS FACING FRANKLIN GREEN PARK & HARRIS GREEN PARK

MICHAEL GREEN ARCHITECTURE
1535 W 3RD AVENUE, VANCOUVER BC
CANADA V6J 1J8


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DATE REVISION DESCRIPTION


PARKWAY

1050 PANDORA AVE + 1518 COOK STREET
VICTORIA, BC
2018-001

A303
SECTIONS

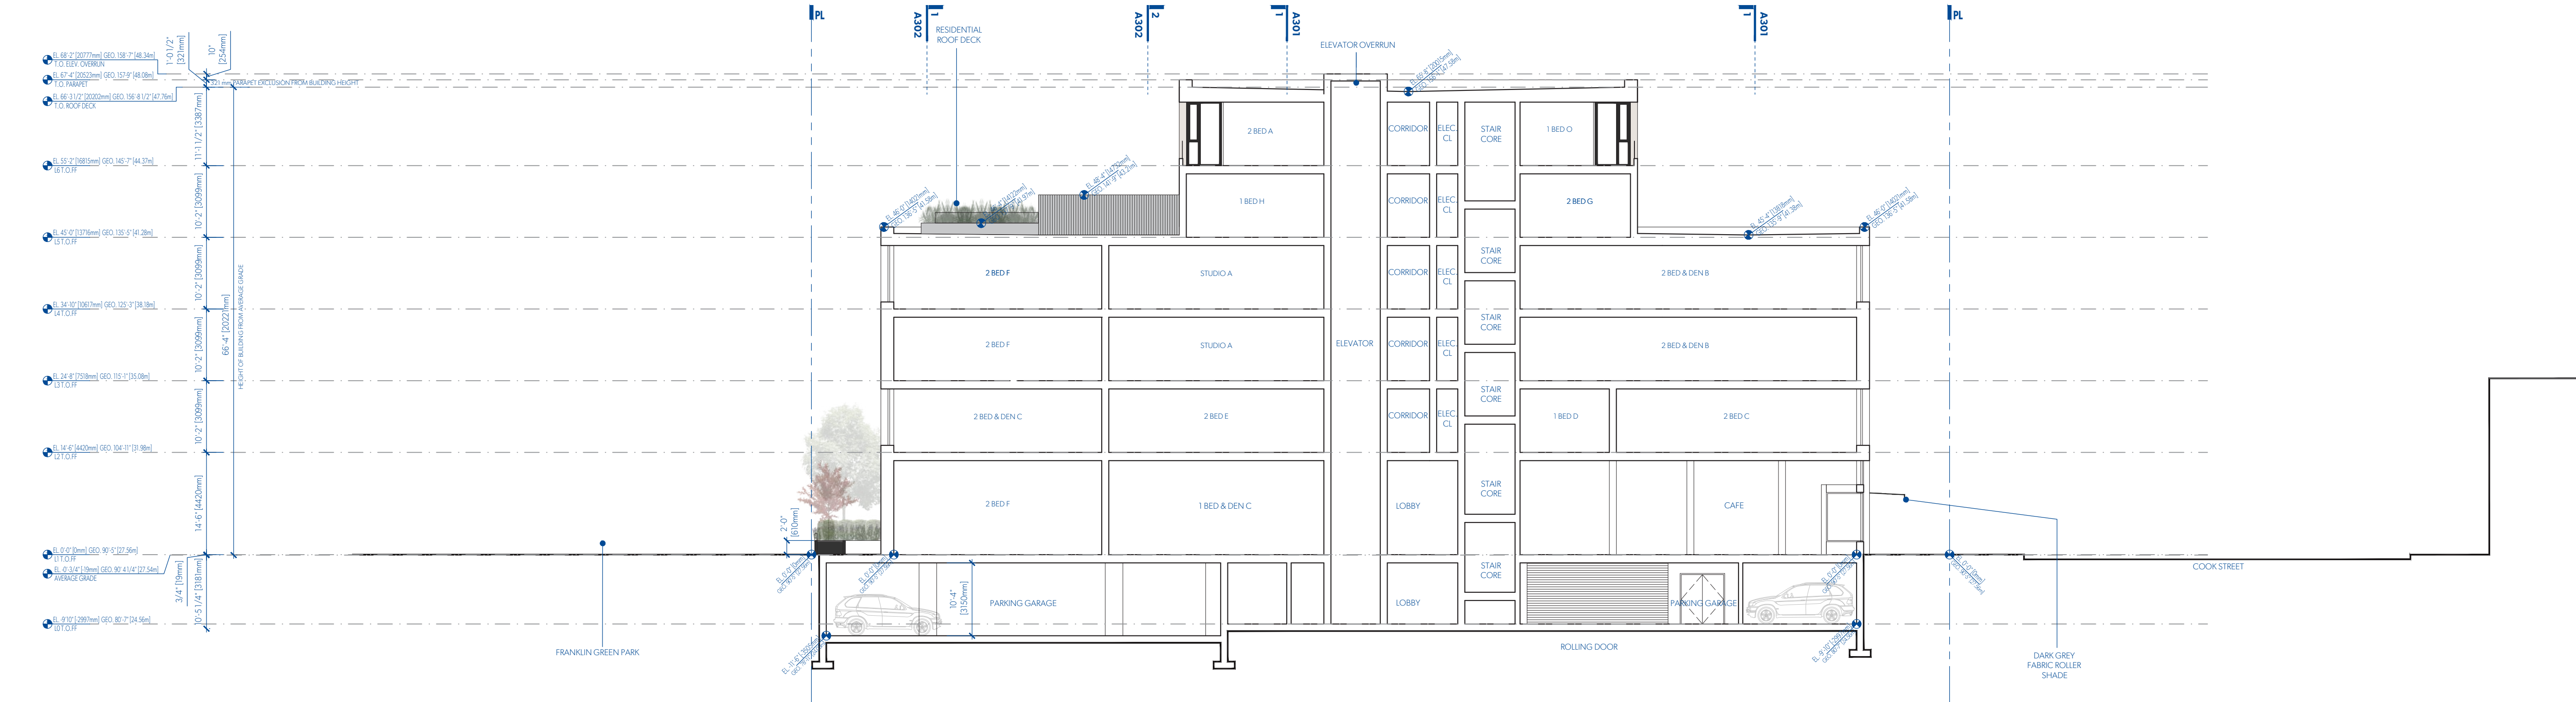

1 SECTION LOOKING NORTH THROUGH NEW 4 & 6 STOREY VOLUME
A304 1:150

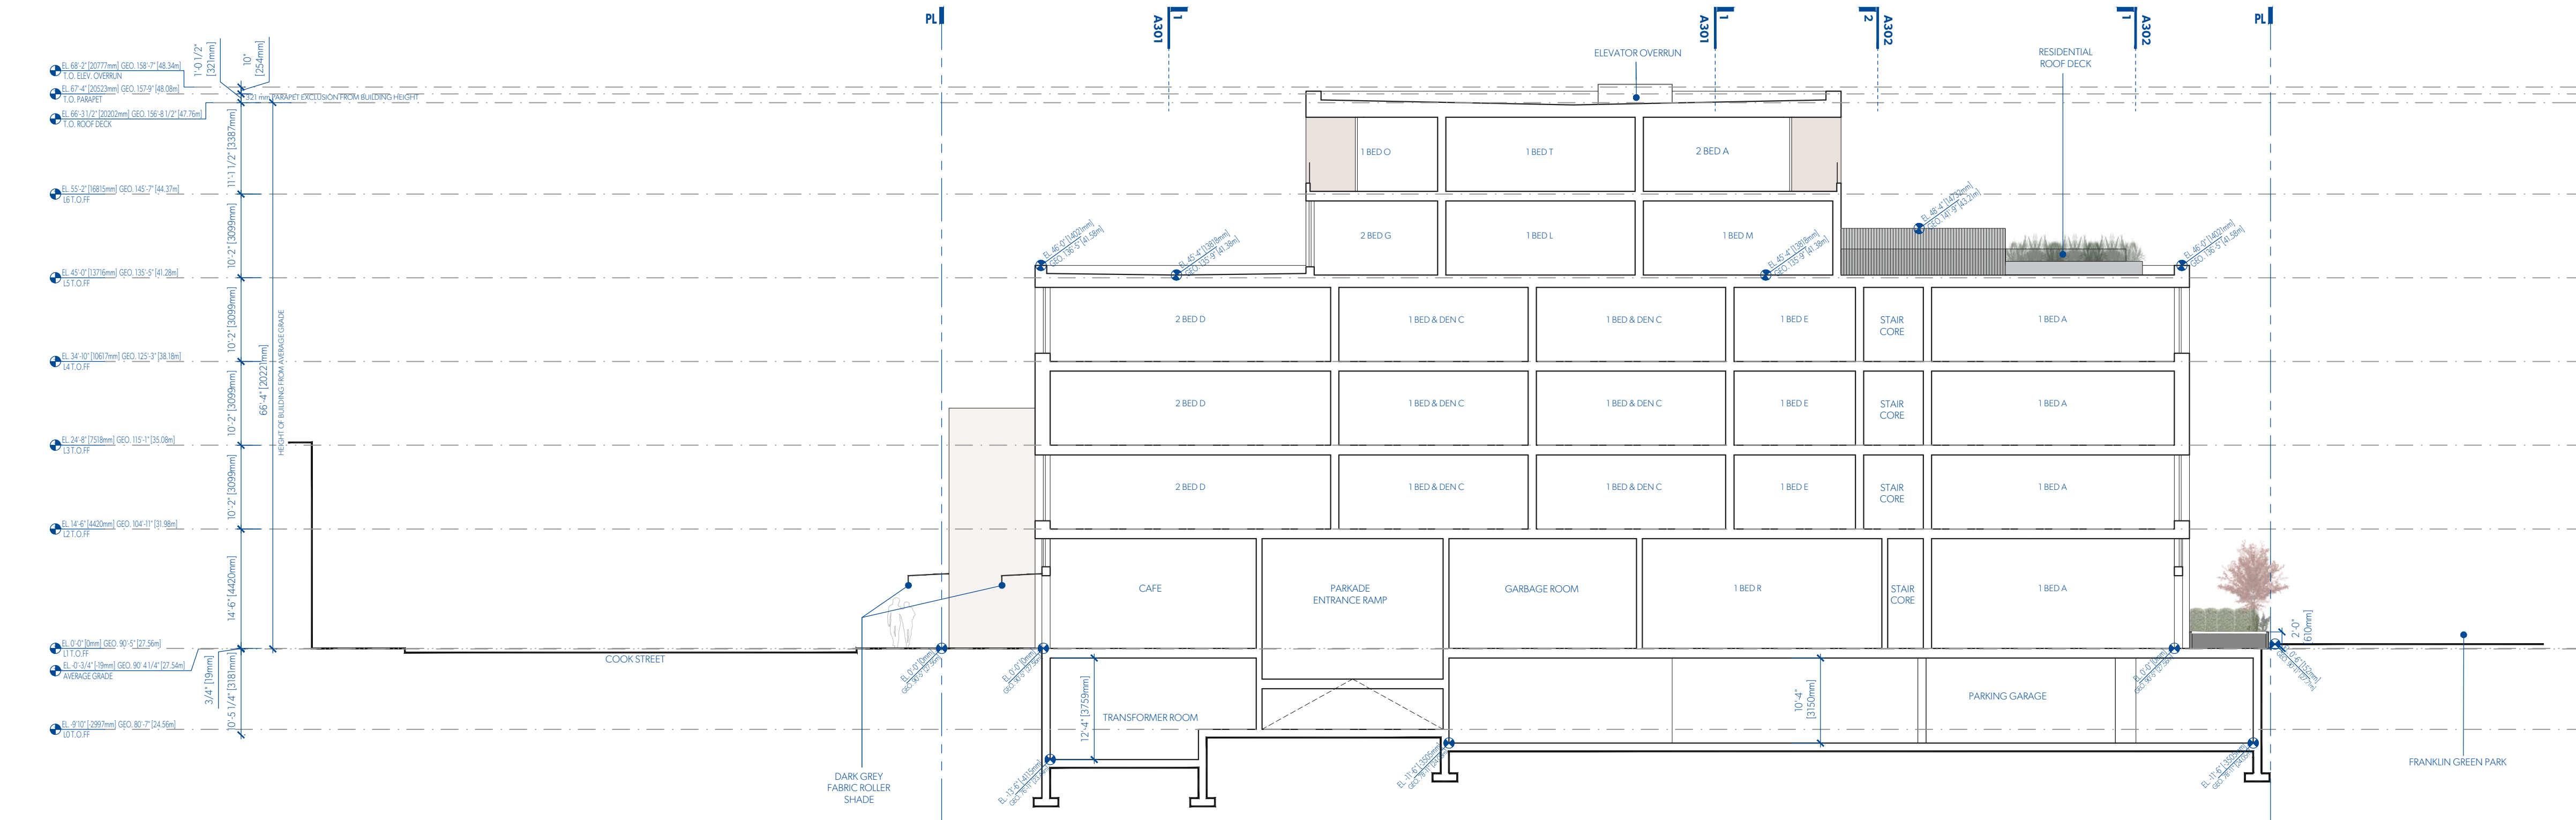

2 SECTION LOOKING SOUTH THROUGH NEW 4 & 6 STOREY VOLUME
A304 1:150

MGA

MATERIALITY



PEARL COLOURED, ULTRA-HIGH PERFORMANCE CONCRETE PANEL.



TRANSPARENT GLAZING WITH DARK GREY FRAMES.



EXISTING WHITE GLAZED BRICK



EXISTING ORNAMENTAL DETAILING RESTORED TO HERITAGE COLOUR PALETTE



JULIET BALCONIES WITH CLEAR GLASS ON LIVING SPACE WINDOWS FACING FRANKLIN GREEN PARK & HARRIS GREEN PARK

MICHAEL GREEN ARCHITECTURE
1535 W 3RD AVENUE, VANCOUVER BC
CANADA V6J 1J8


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2019-10-30	2	REVISED FOR REZONING
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2019-05-15	0	ISSUED FOR REZONING

DATE	REVISION	DESCRIPTION
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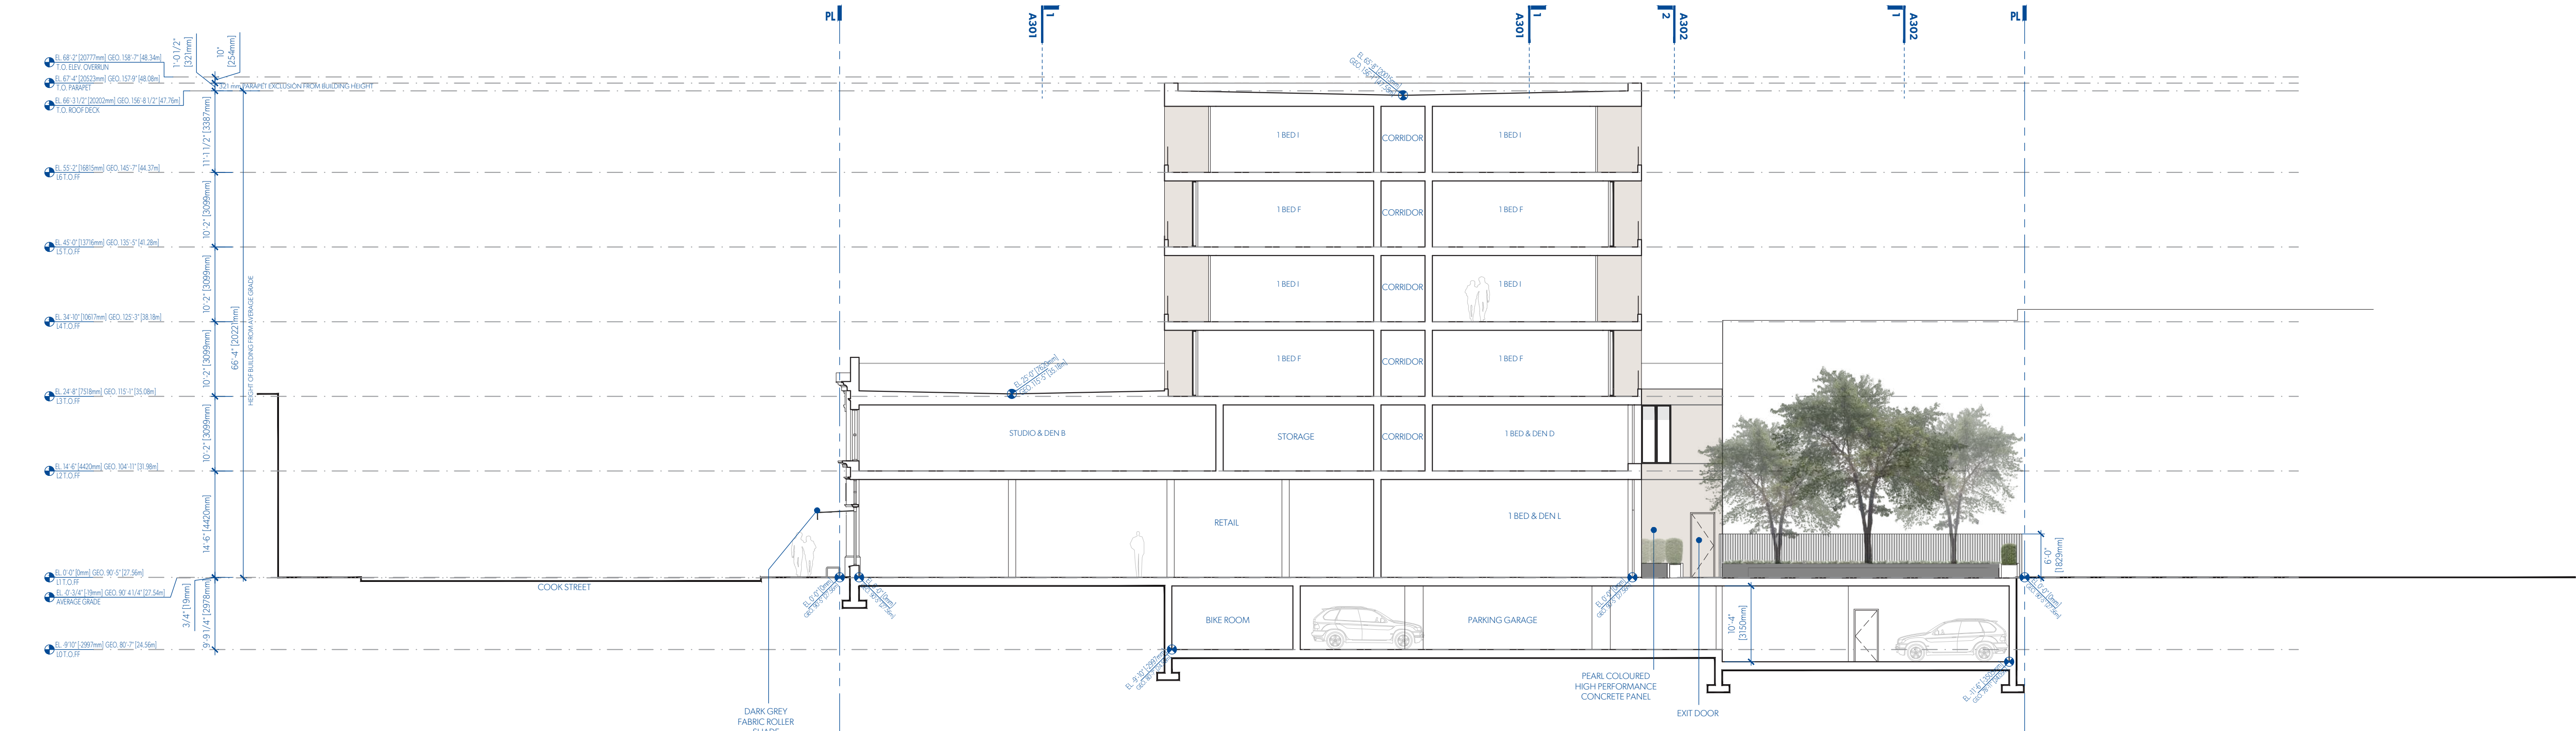
PARKWAY

1050 PANDORA AVE + 1518 COOK STREET
VICTORIA, BC
2018-001

A304
SECTIONS

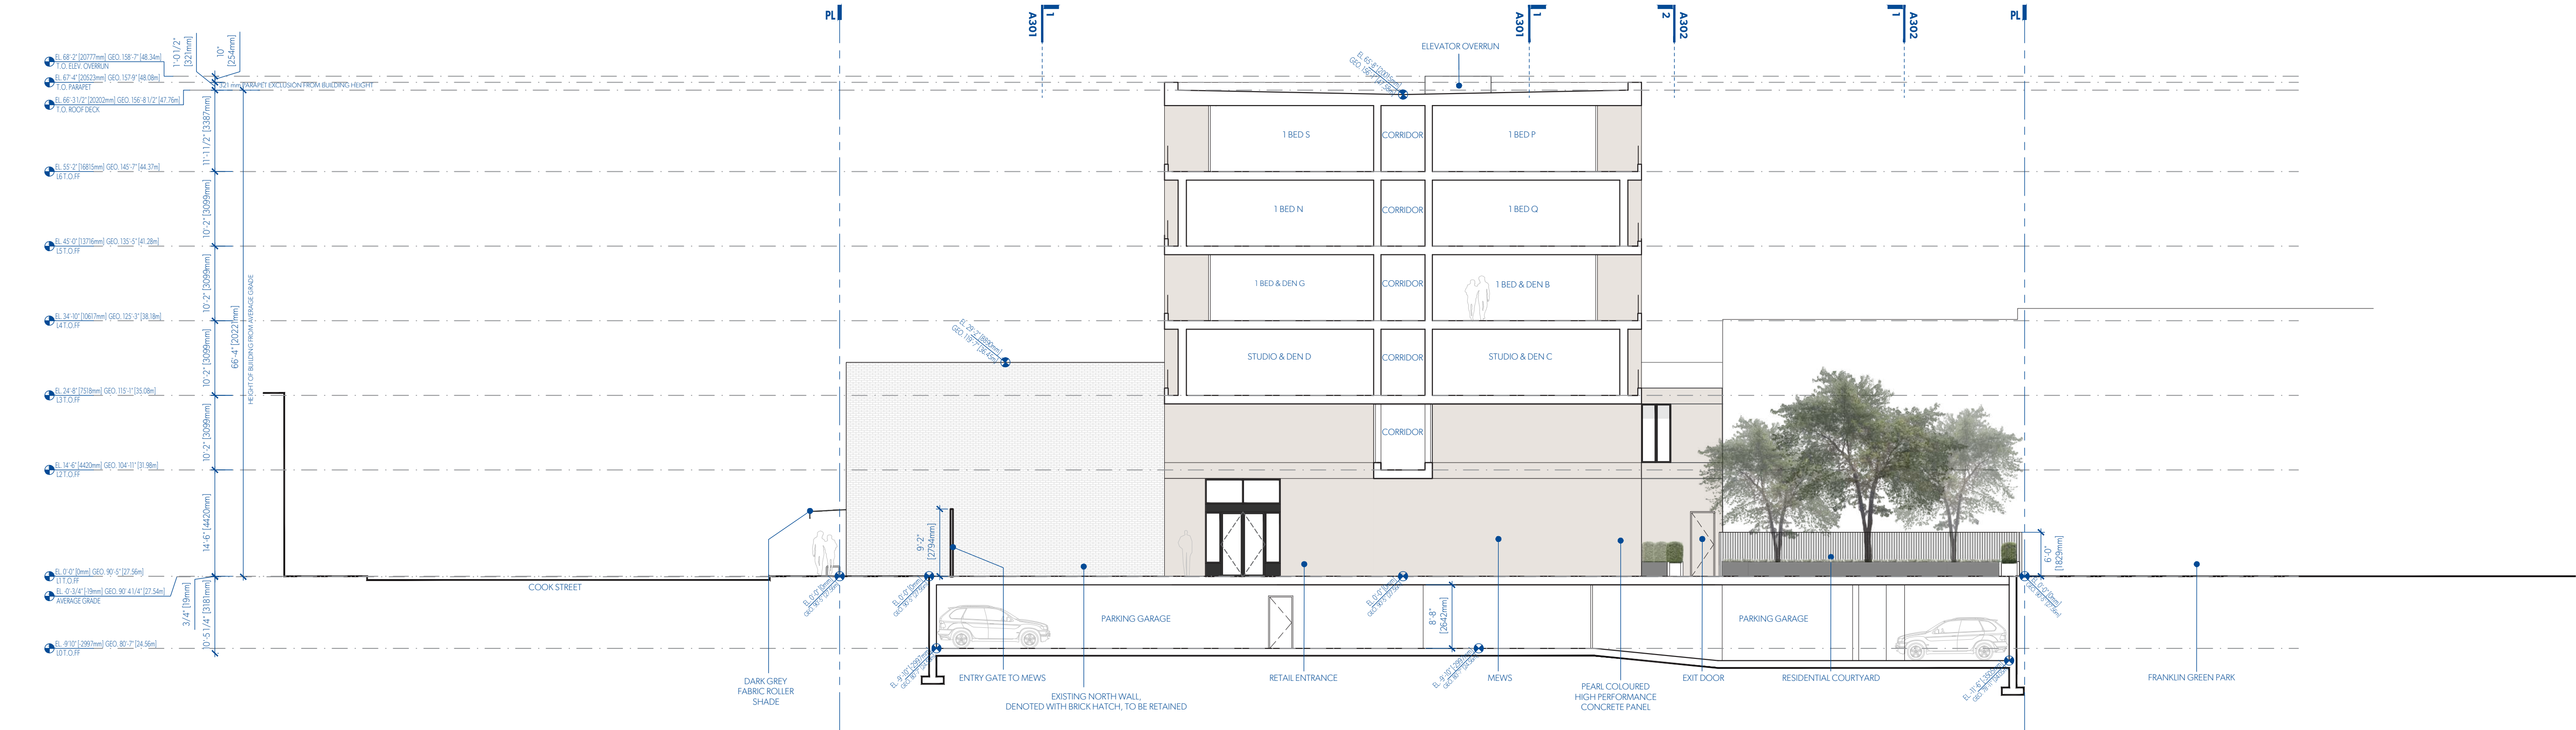

1 SECTION LOOKING SOUTH THROUGH NEW 6 STOREY VOLUME
A305 1:150



2 SECTION LOOKING SOUTH THROUGH EXISTING BUILDING NEW 6 STOREY VOLUME
A305 1:150

MGA

MATERIALITY



PEARL COLOURED, ULTRA-HIGH PERFORMANCE CONCRETE PANEL



TRANSPARENT GLAZING WITH DARK GREY FRAMES



EXISTING WHITE GLAZED BRICK



EXISTING ORNAMENTAL DETAILING RESTORED TO HERITAGE COLOUR PALETTE



JULIET BALCONIES WITH CLEAR GLASS ON LIVING SPACE WINDOWS FACING FRANKLIN GREEN PARK & HARRIS GREEN PARK

MICHAEL GREEN ARCHITECTURE
1535 W 3RD AVENUE, VANCOUVER BC
CANADA V6J 1J8


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DATE REVISION DESCRIPTION


PARKWAY

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VICTORIA, BC
2018-001

A305
SECTIONS

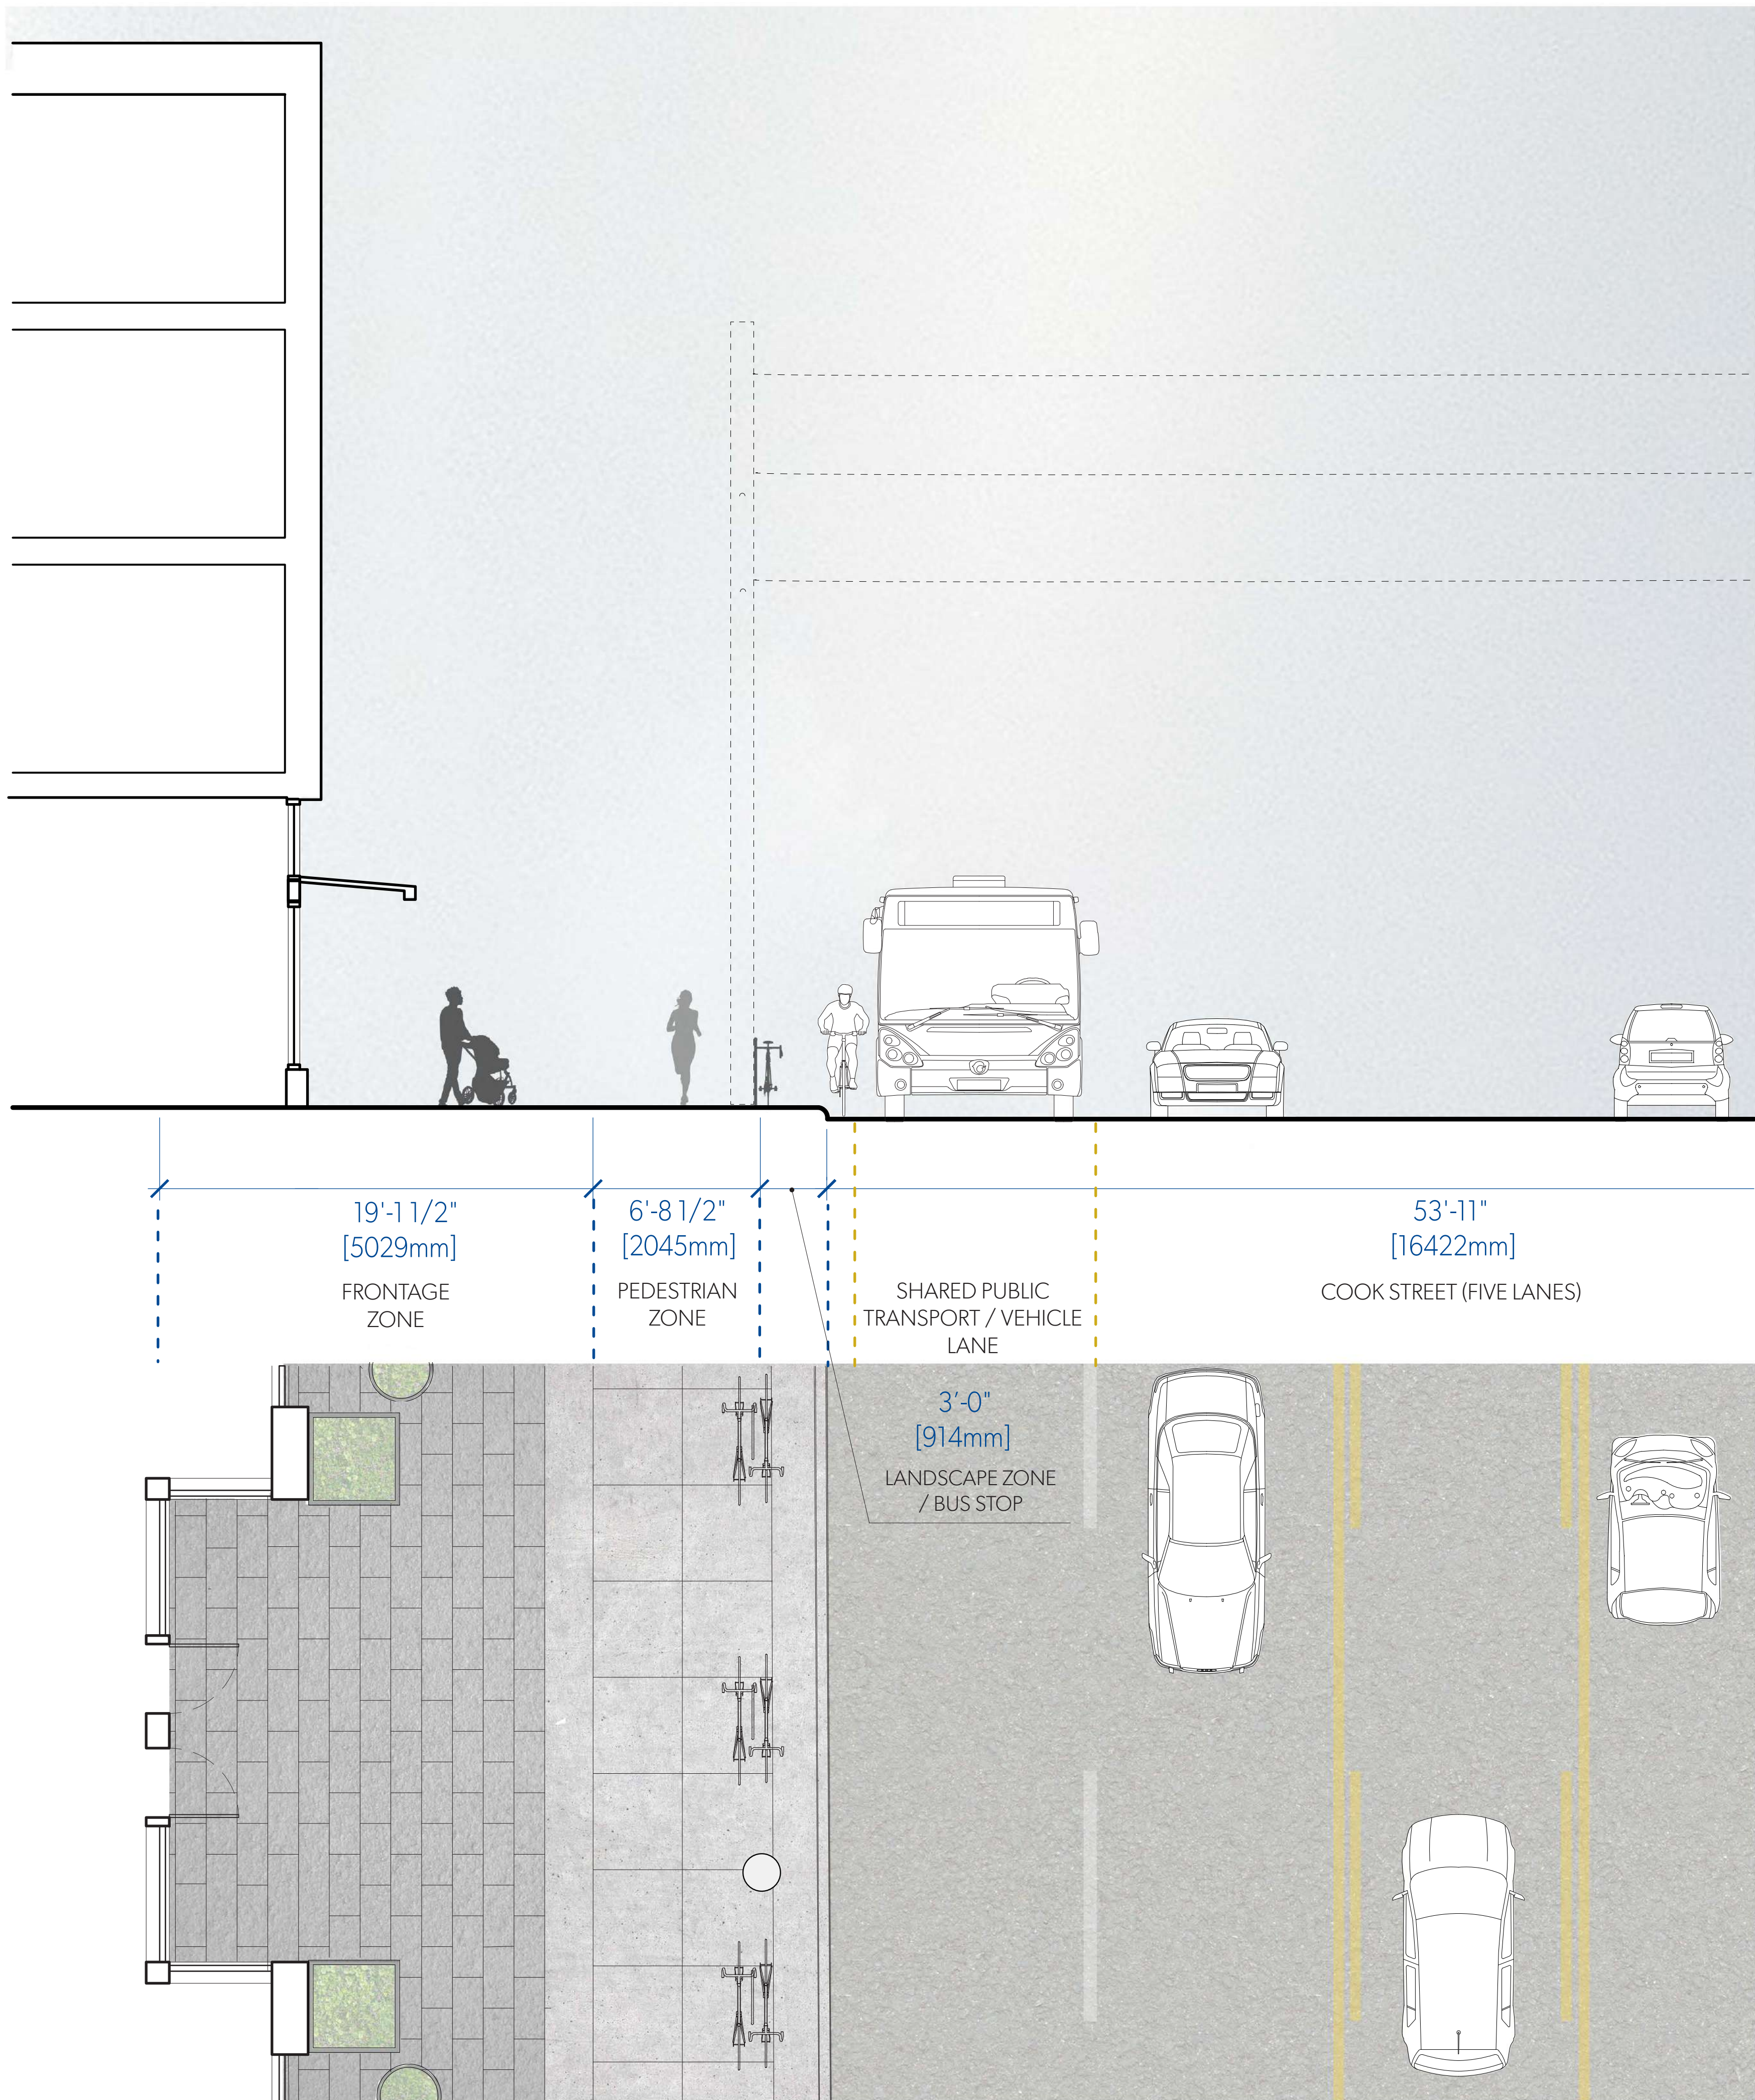

1 **STREETSCAPE SECTION & PLAN THRU COMMERCIAL**
A305 1:50

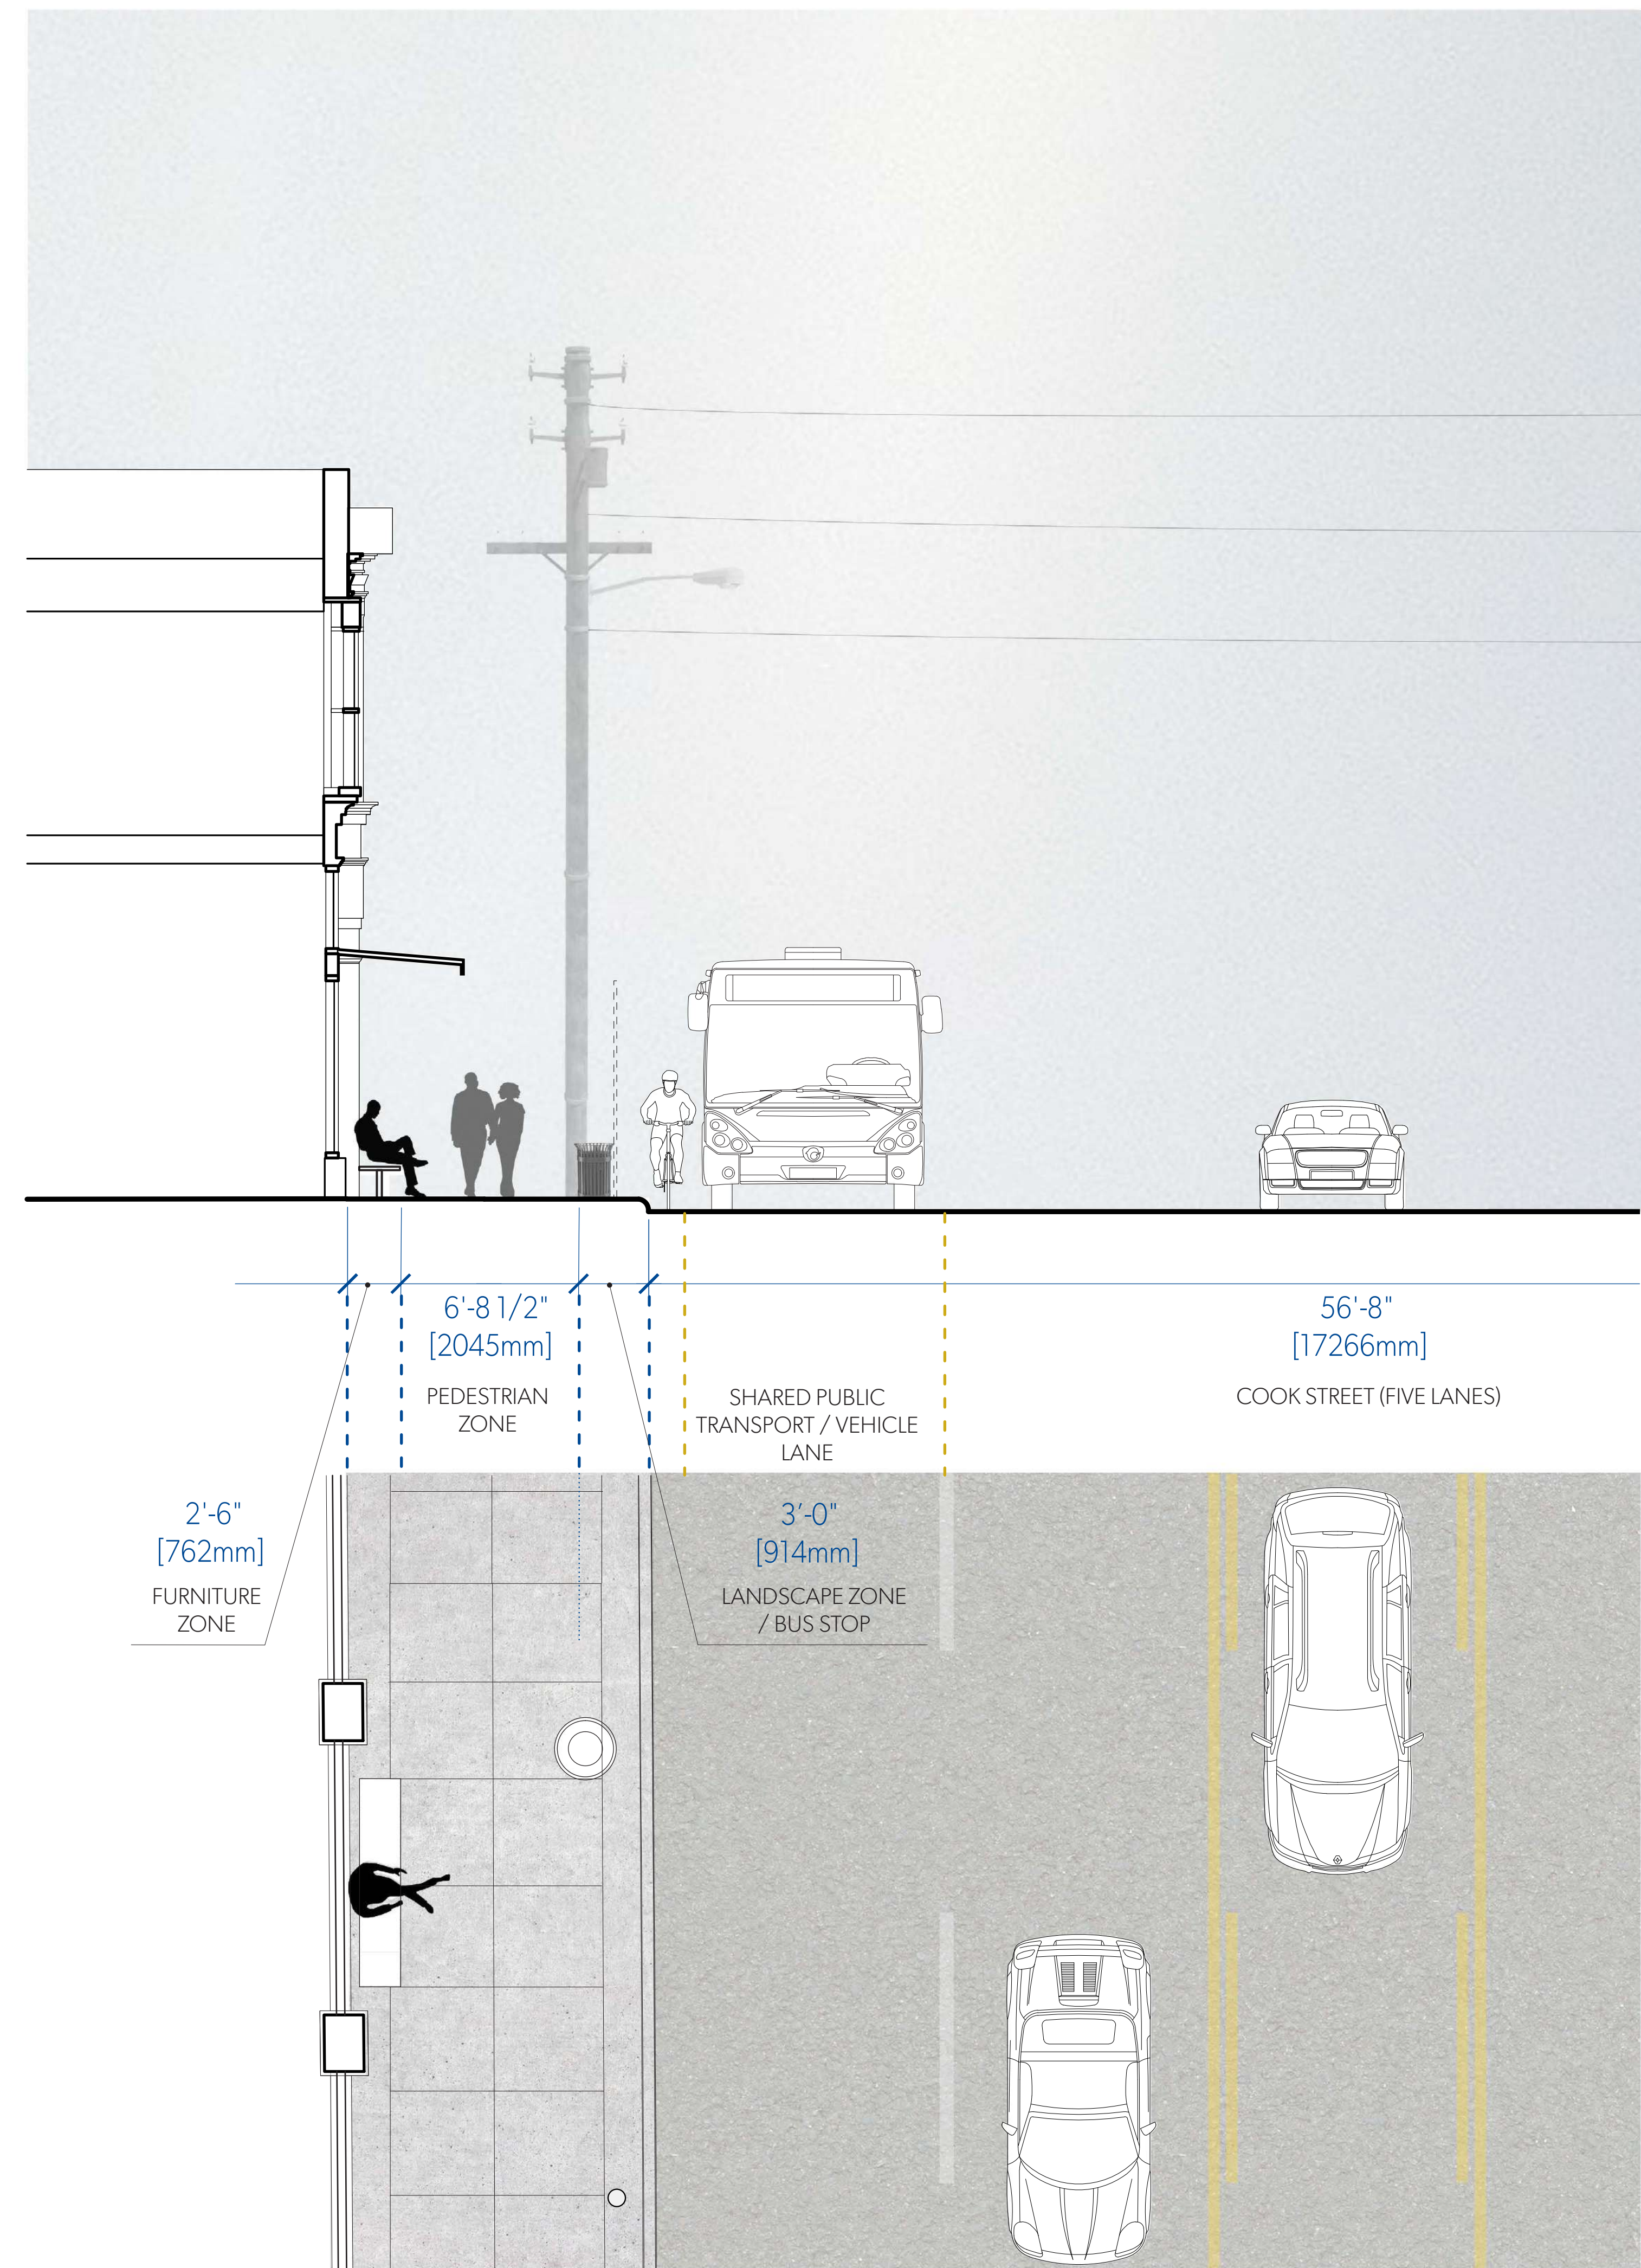

2 **STREETSCAPE SECTION & PLAN THRU CAFE**
A308 1:50

MGA
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MATERIALITY



PEARL COLOURED, ULTRA-HIGH PERFORMANCE CONCRETE PANEL



TRANSPARENT GLAZING WITH DARK GREY FRAMES



EXISTING WHITE GLAZED BRICK



EXISTING ORNAMENTAL DETAILING RESTORED TO HERITAGE COLOUR PALETTE



JULIET BALCONIES WITH CLEAR GLASS ON LIVING SPACE WINDOWS FACING FRANKLIN GREEN PARK & HARRIS GREEN PARK

MICHAEL GREEN ARCHITECTURE
1535 W 3RD AVENUE, VANCOUVER BC
CANADA V6J 1J8




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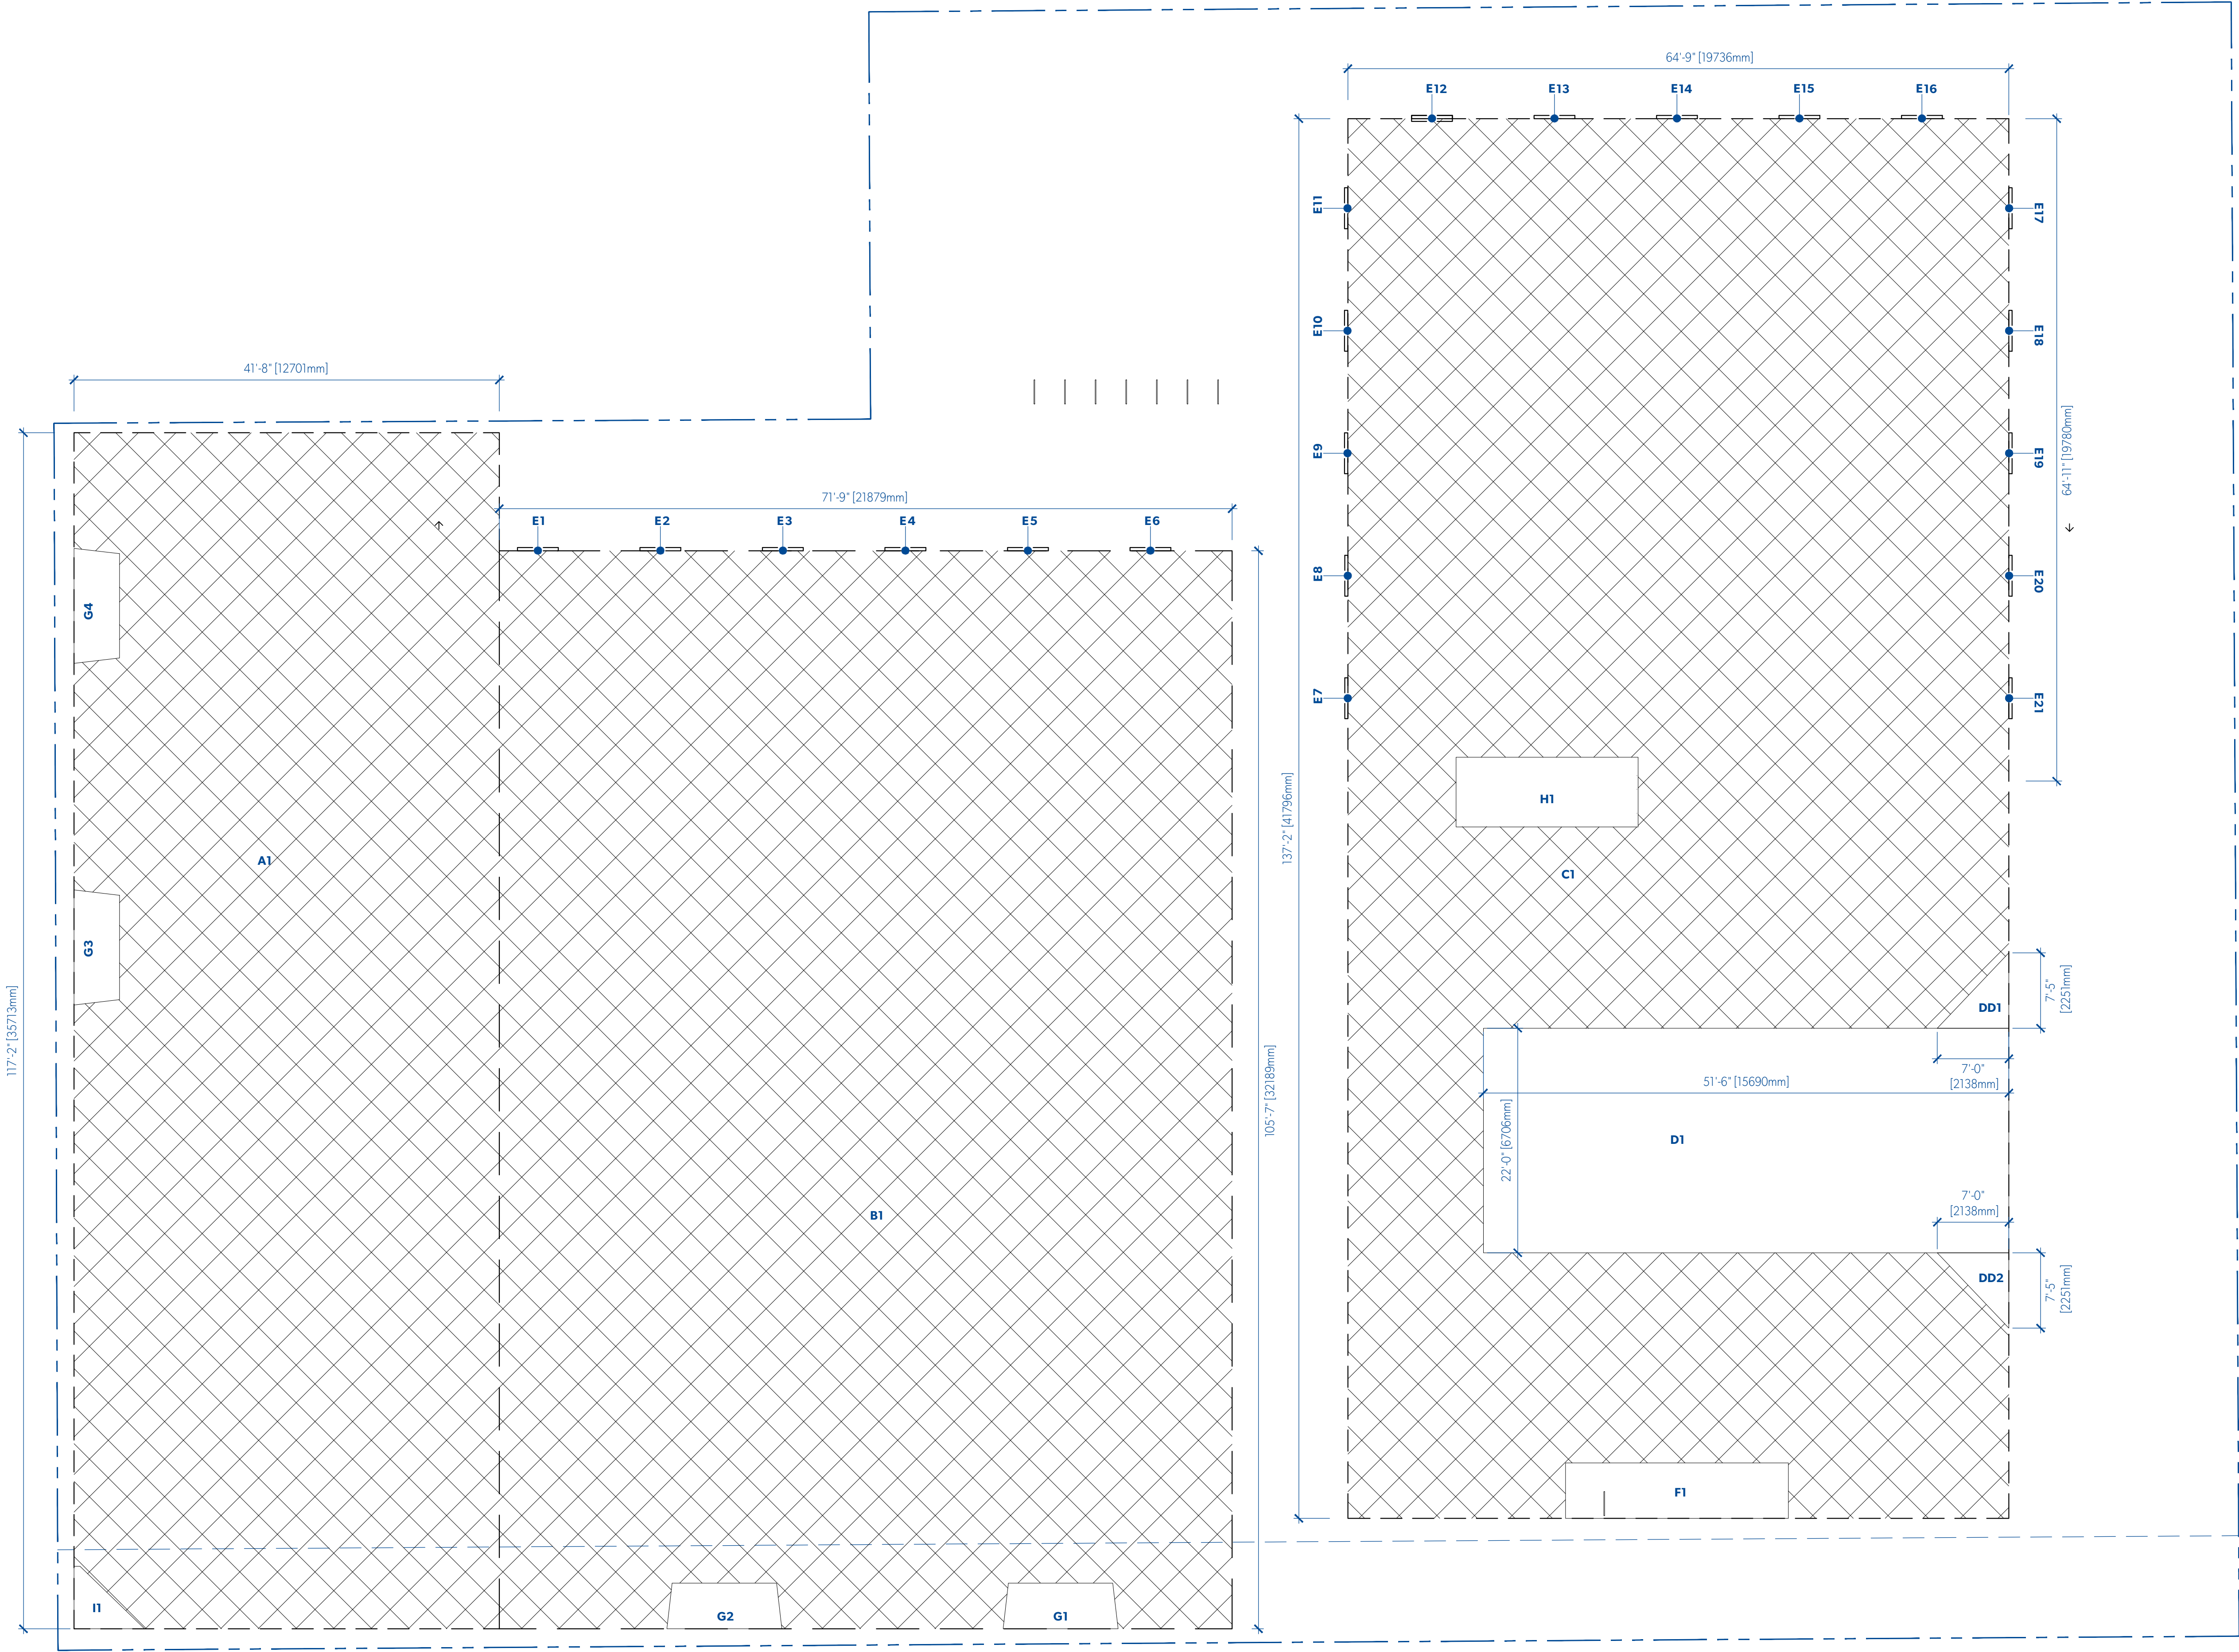
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PARKWAY


1050 PANDORA AVE + 1518 COOK STREET
VICTORIA, BC
2018-001

A308
STREETSCAPE CROSS
SECTIONS




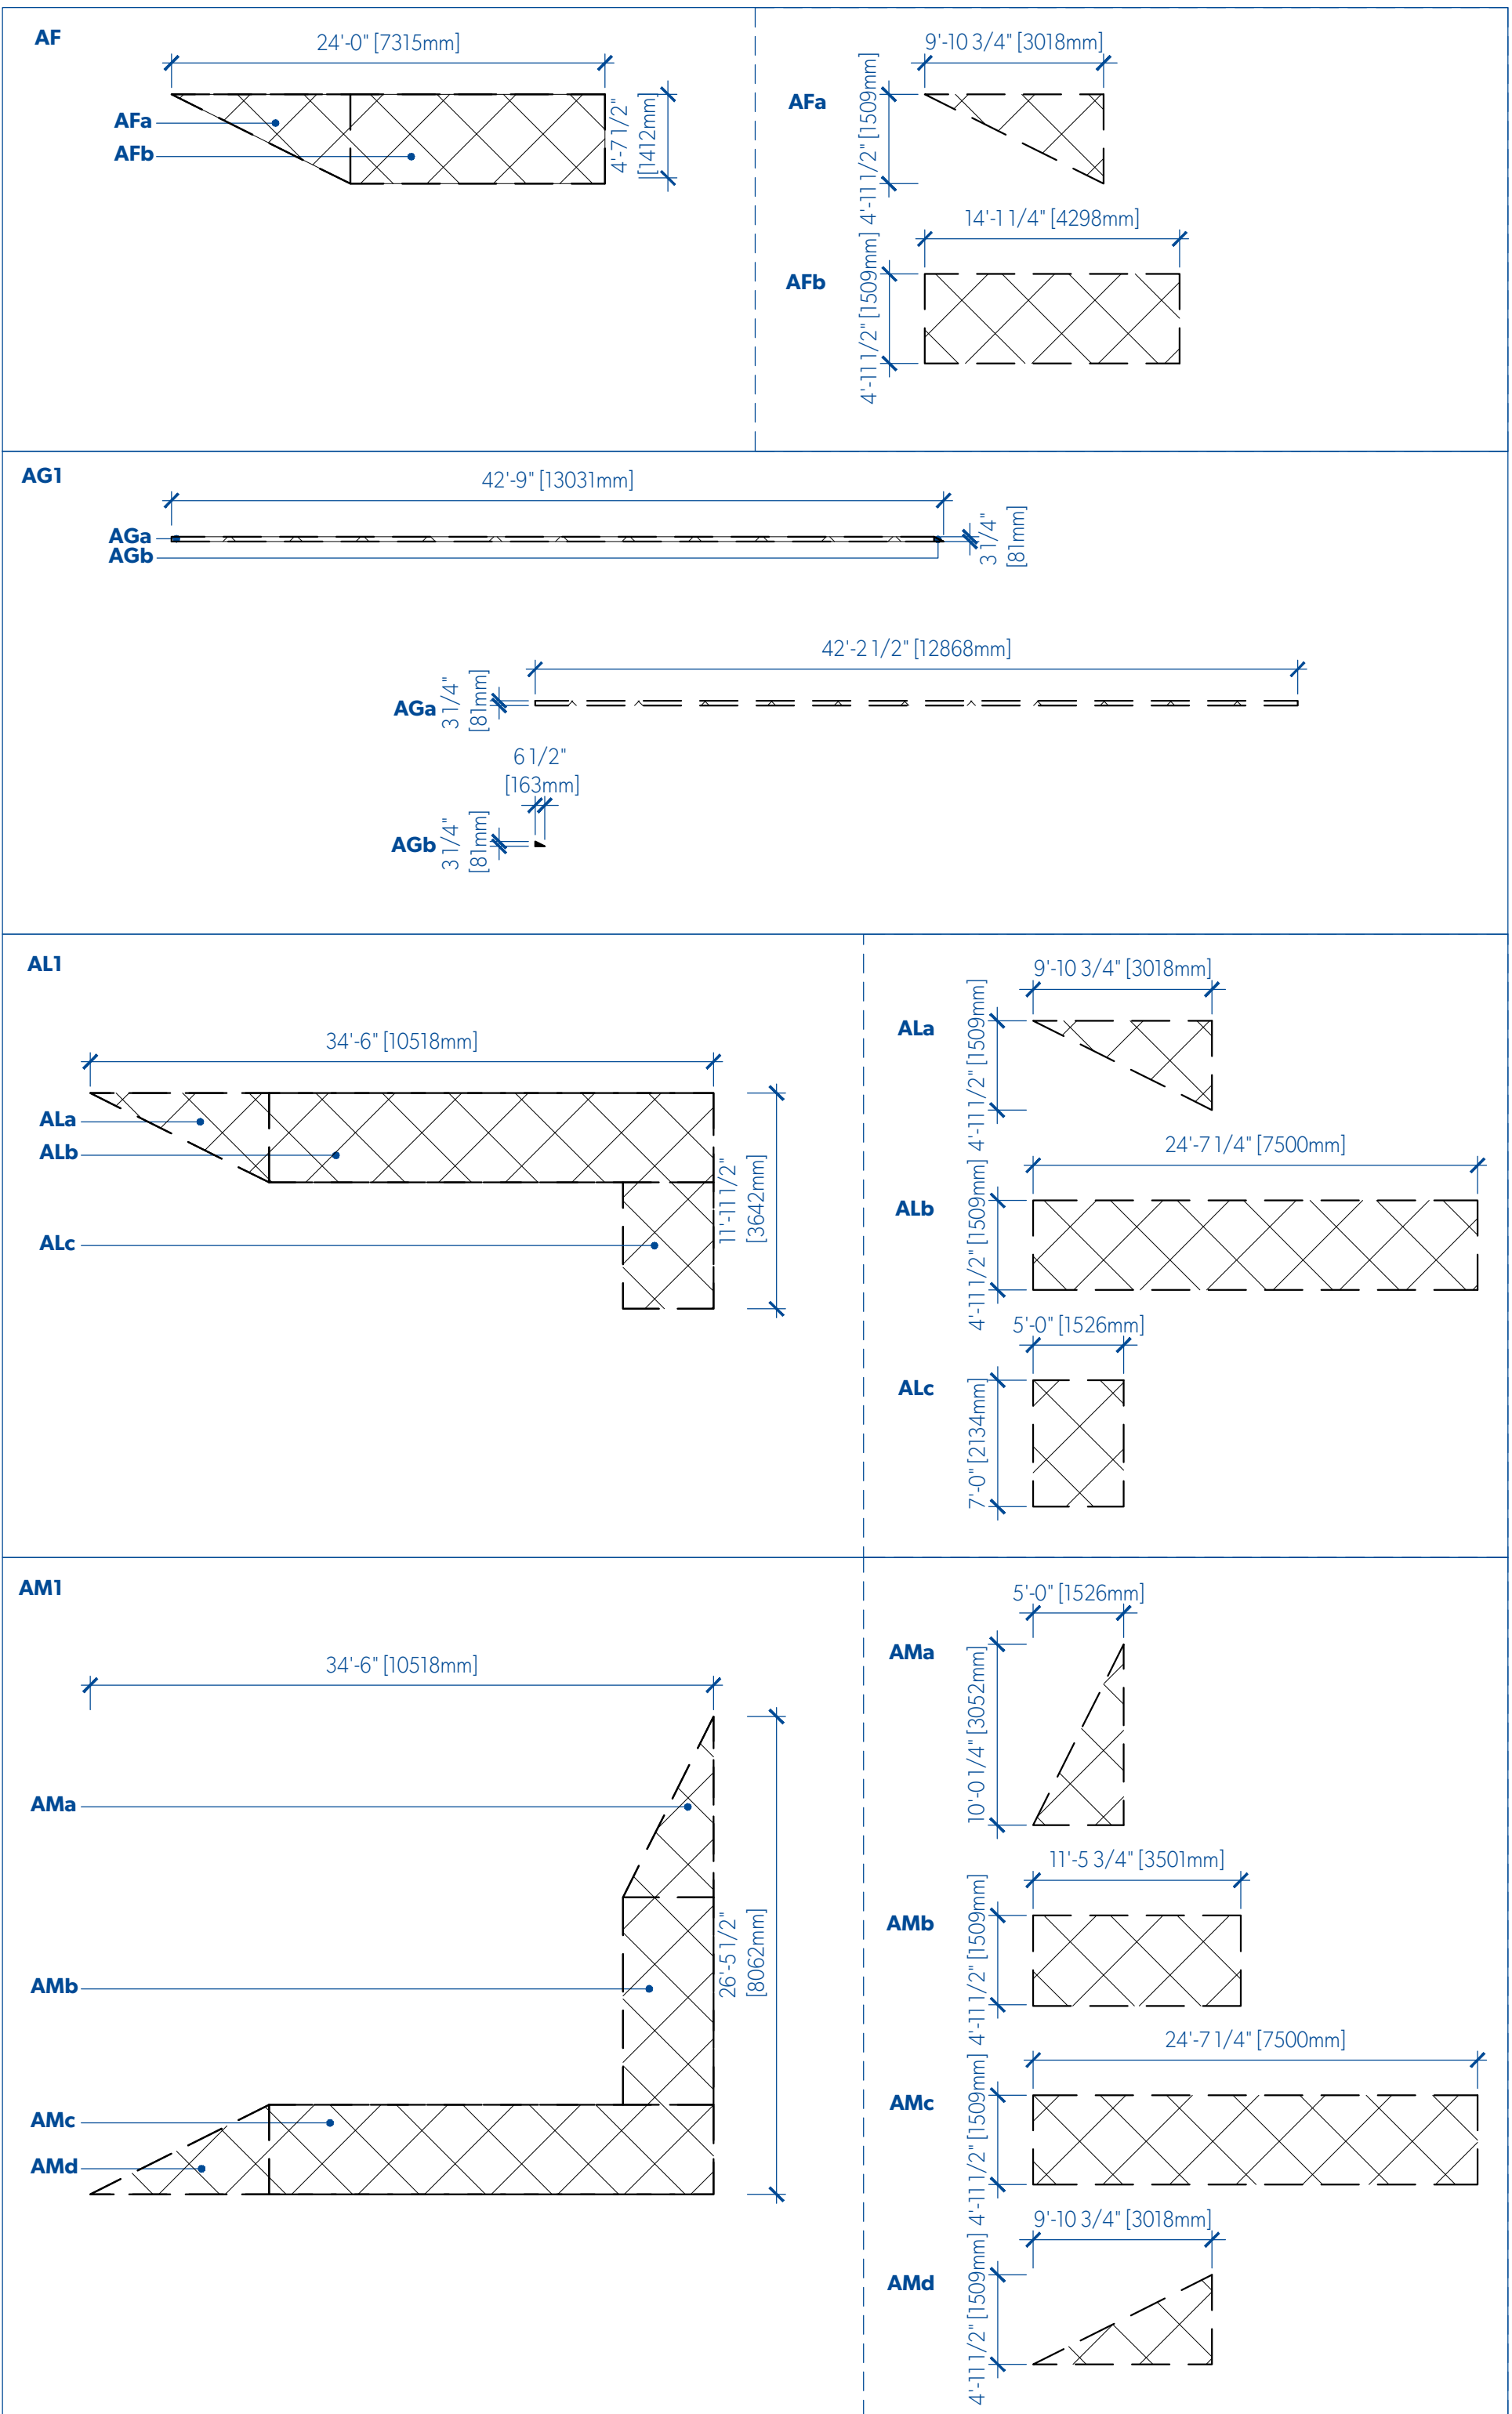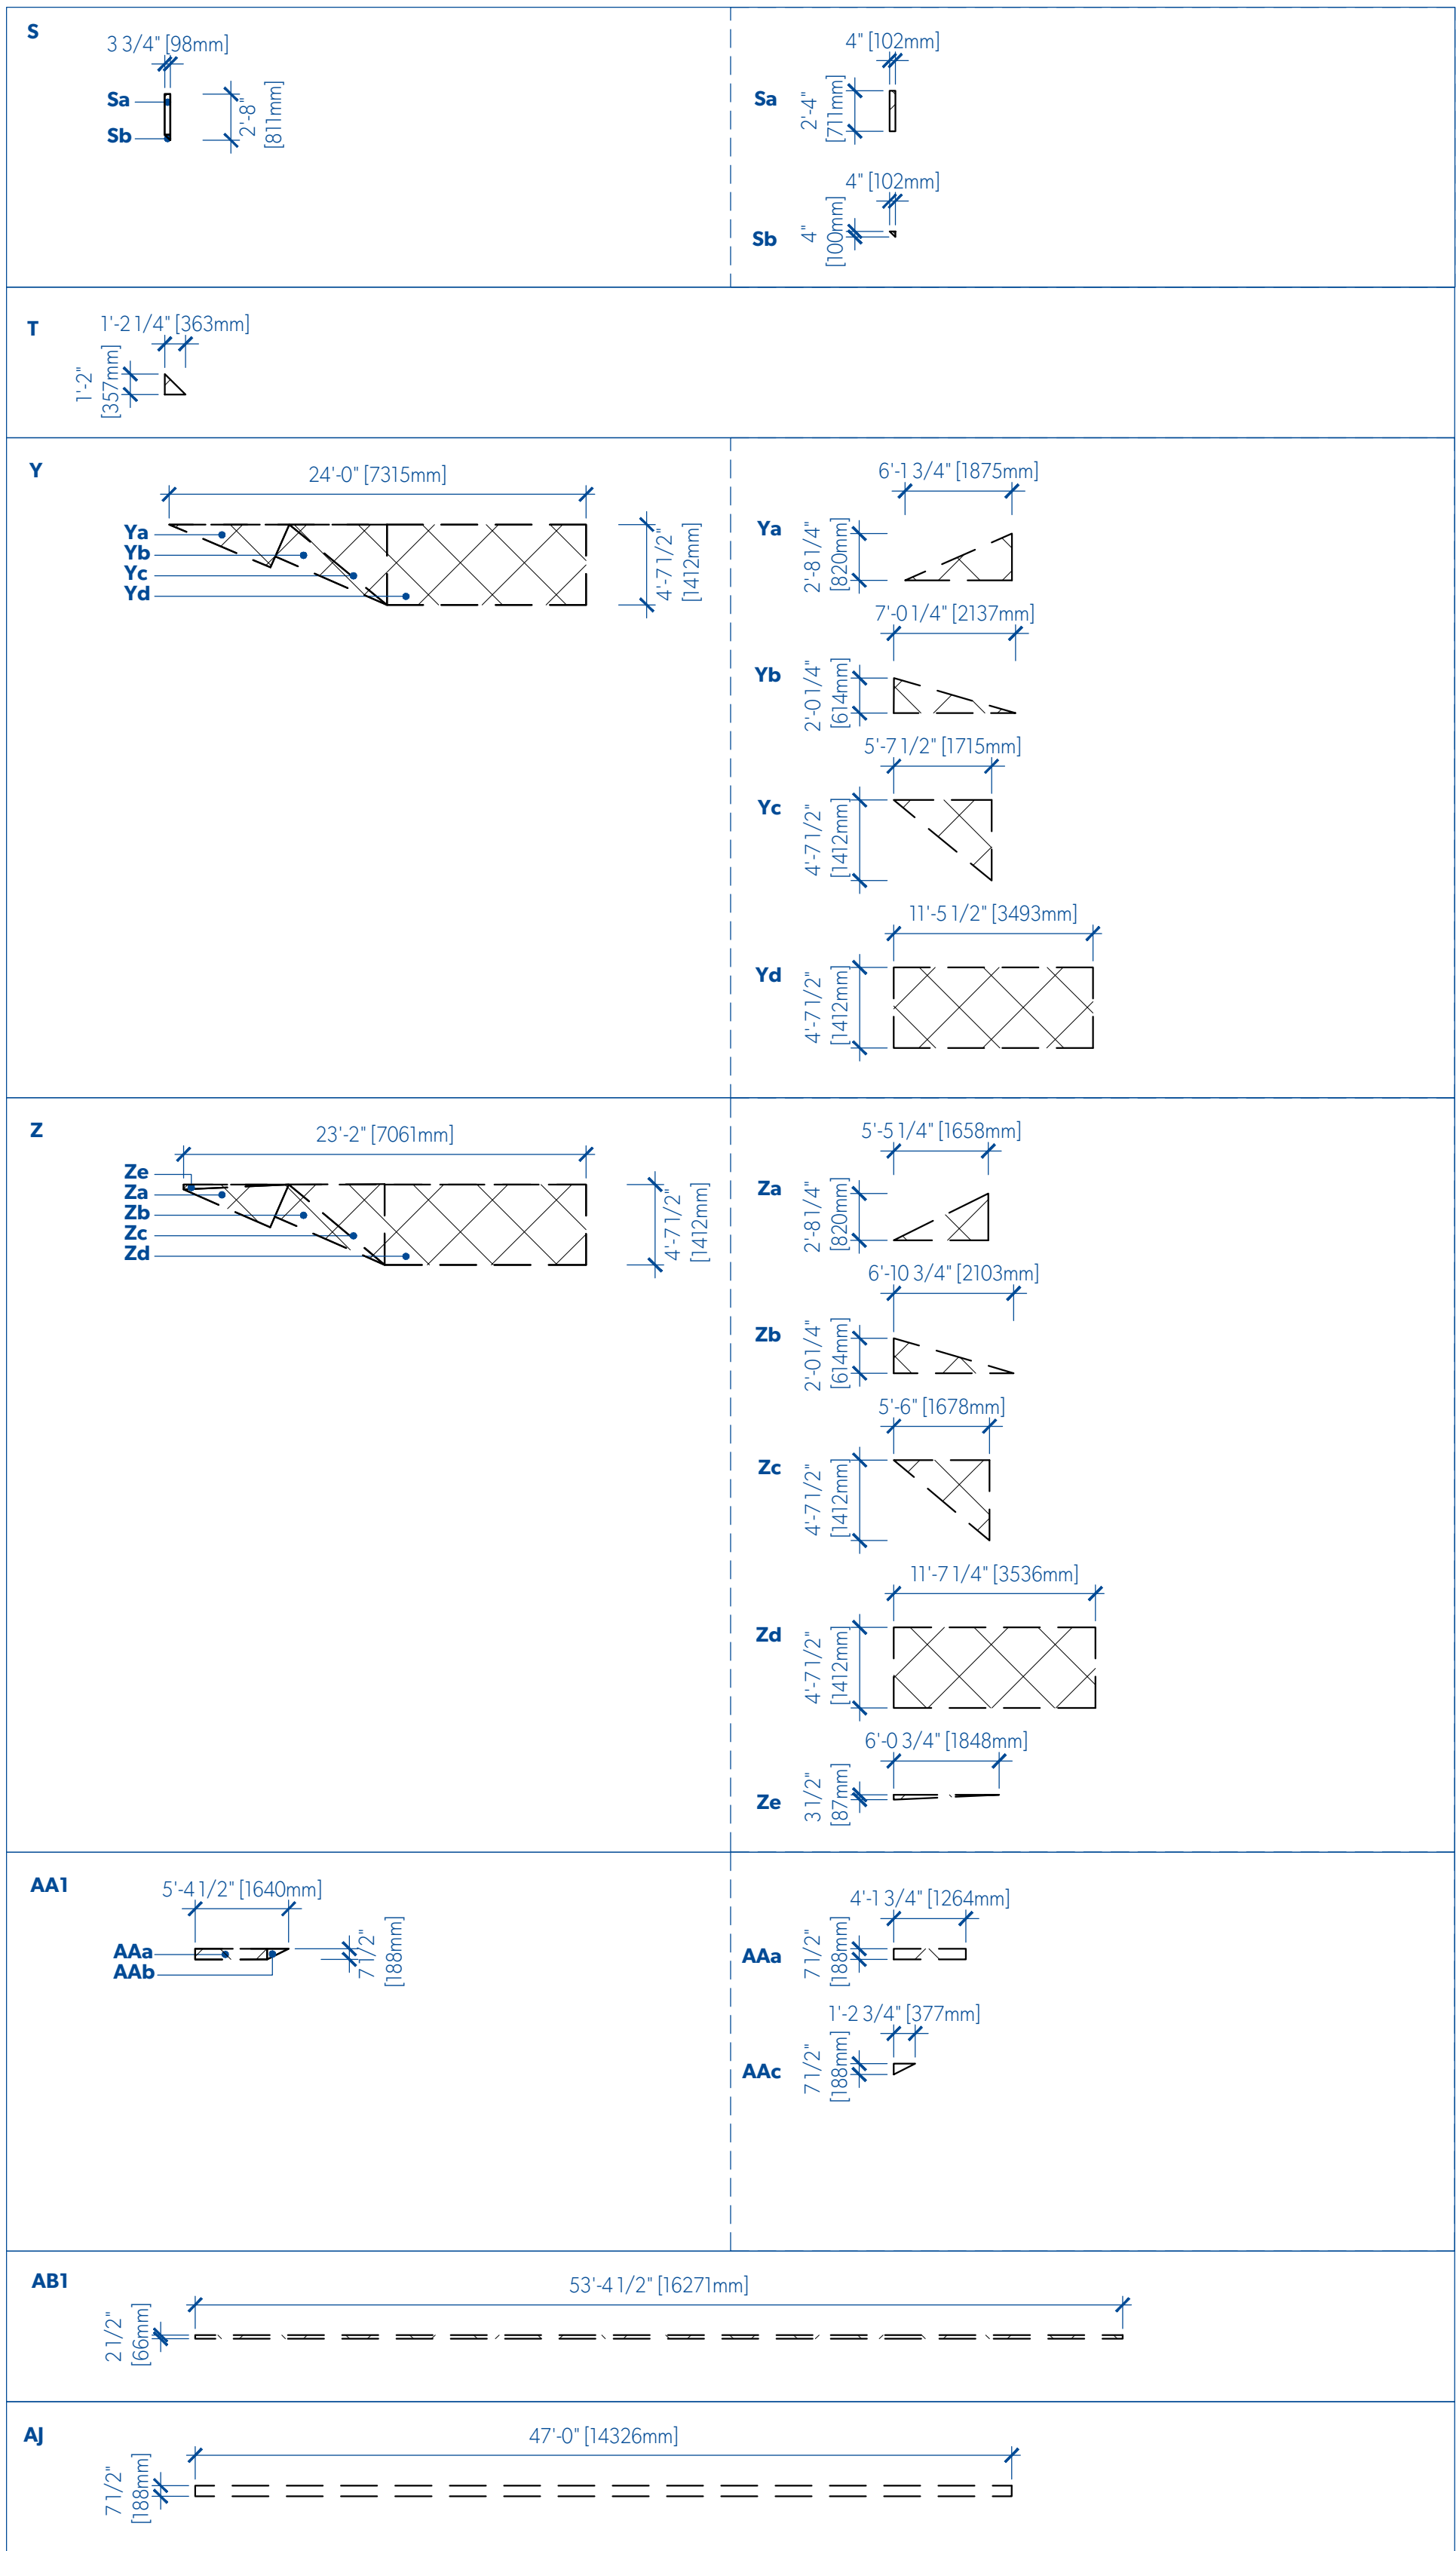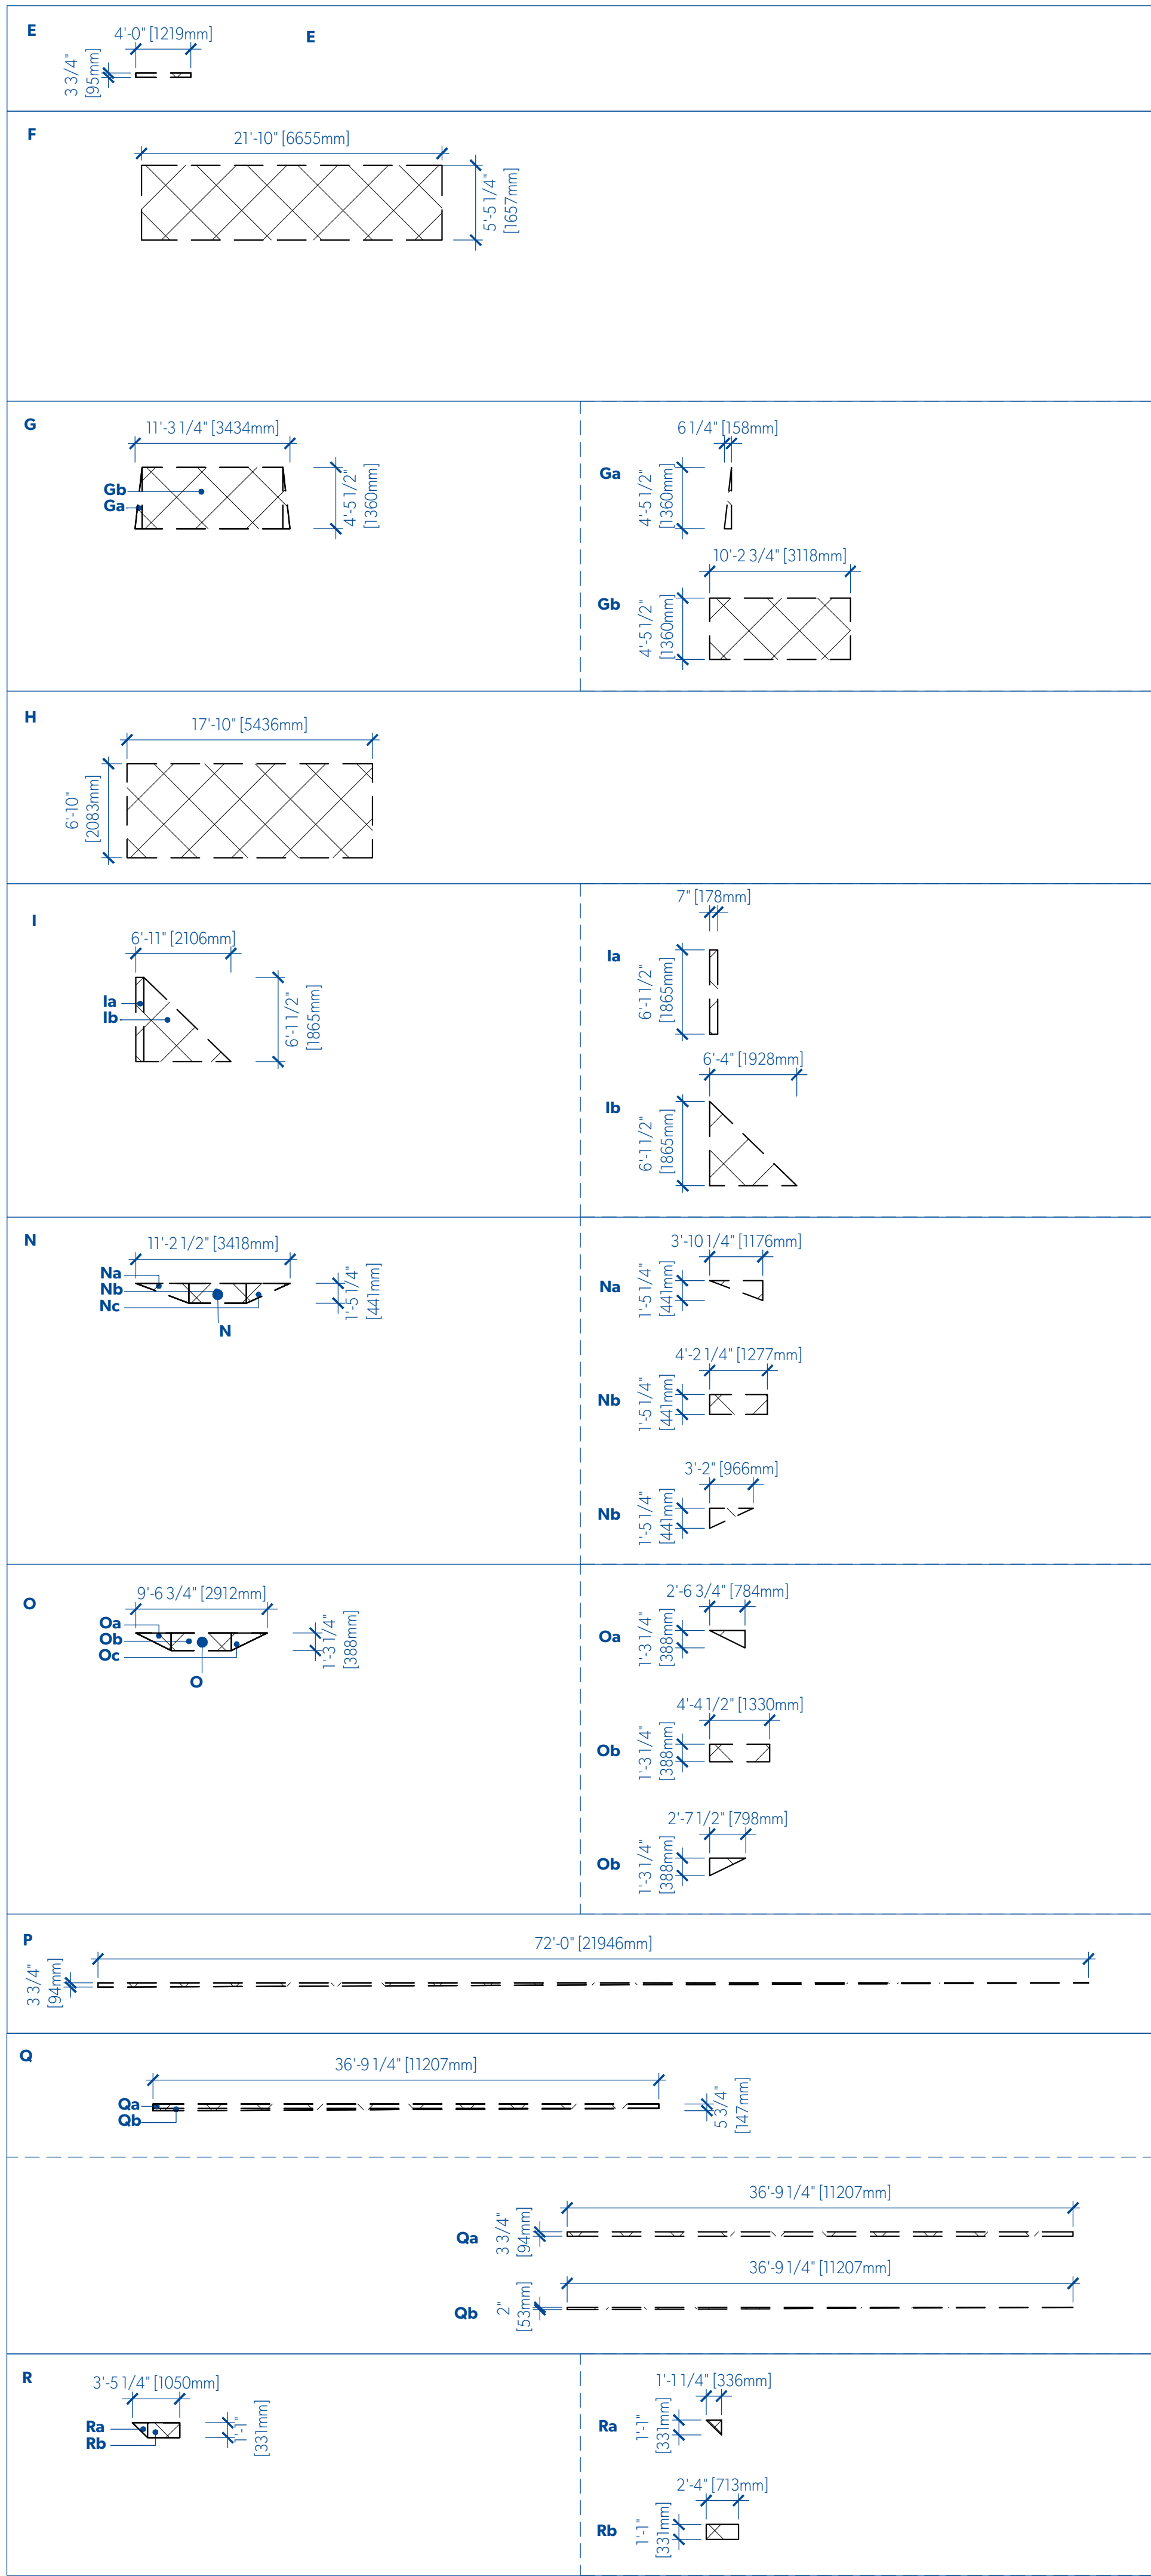


LEVEL 1					
	METRIC (M2)				
	LENGTH	WIDTH	AREA	QTY	TOTAL
GROSS AREA					
A1	35.71	x	12.70	=	453.60 m2 x 1 = 453.60 m2
B1	32.19	x	21.88	=	704.26 m2 x 1 = 704.26 m2
C1	41.80	x	19.74	=	824.89 m2 x 1 = 824.89 m2
E	0.10	x	1.22	=	0.12 m2 x 21 = 2.43 m2
TOTAL GROSS AREA					1985.18 m2
AREA DEDUCTIONS					
D1	15.69	x	6.71	=	105.22 m2 x 1 = 105.22 m2
DD1	2.14	x	2.25	=	4.81 m2 x 1 = 4.81 m2
F	6.66	x	1.66	=	11.06 m2 x 1 = 11.06 m2
G	(SEE G CALCULATIONS)		=	4.45 m2 x 4 =	17.81 m2
H	5.44	x	2.08	=	11.32 m2 x 1 = 11.32 m2
I	(SEE I CALCULATIONS)		=	2.13 m2 x 1 =	2.13 m2
TOTAL DEDUCTIONS					152.36 m2
TOTAL GROSS AREA					1985.18 m2
TOTAL DEDUCTIONS					152.36 m2
TOTAL NET AREA					1832.82 m2
G CALCULATIONS					
GROSS AREA					
Ga	1.36	x	0.16	=	0.21 m2 x 1 = 0.21 m2
Gb	1.36	x	3.12	=	4.24 m2 x 1 = 4.24 m2
TOTAL NET AREA					4.45 m2
I CALCULATIONS					
GROSS AREA					
Ia	1.87	x	0.18	=	0.33 m2 x 1 = 0.33 m2
Ib	1.87	x	1.93	=	3.60 m2 x 0.5 = 1.80 m2
TOTAL NET AREA					2.13 m2

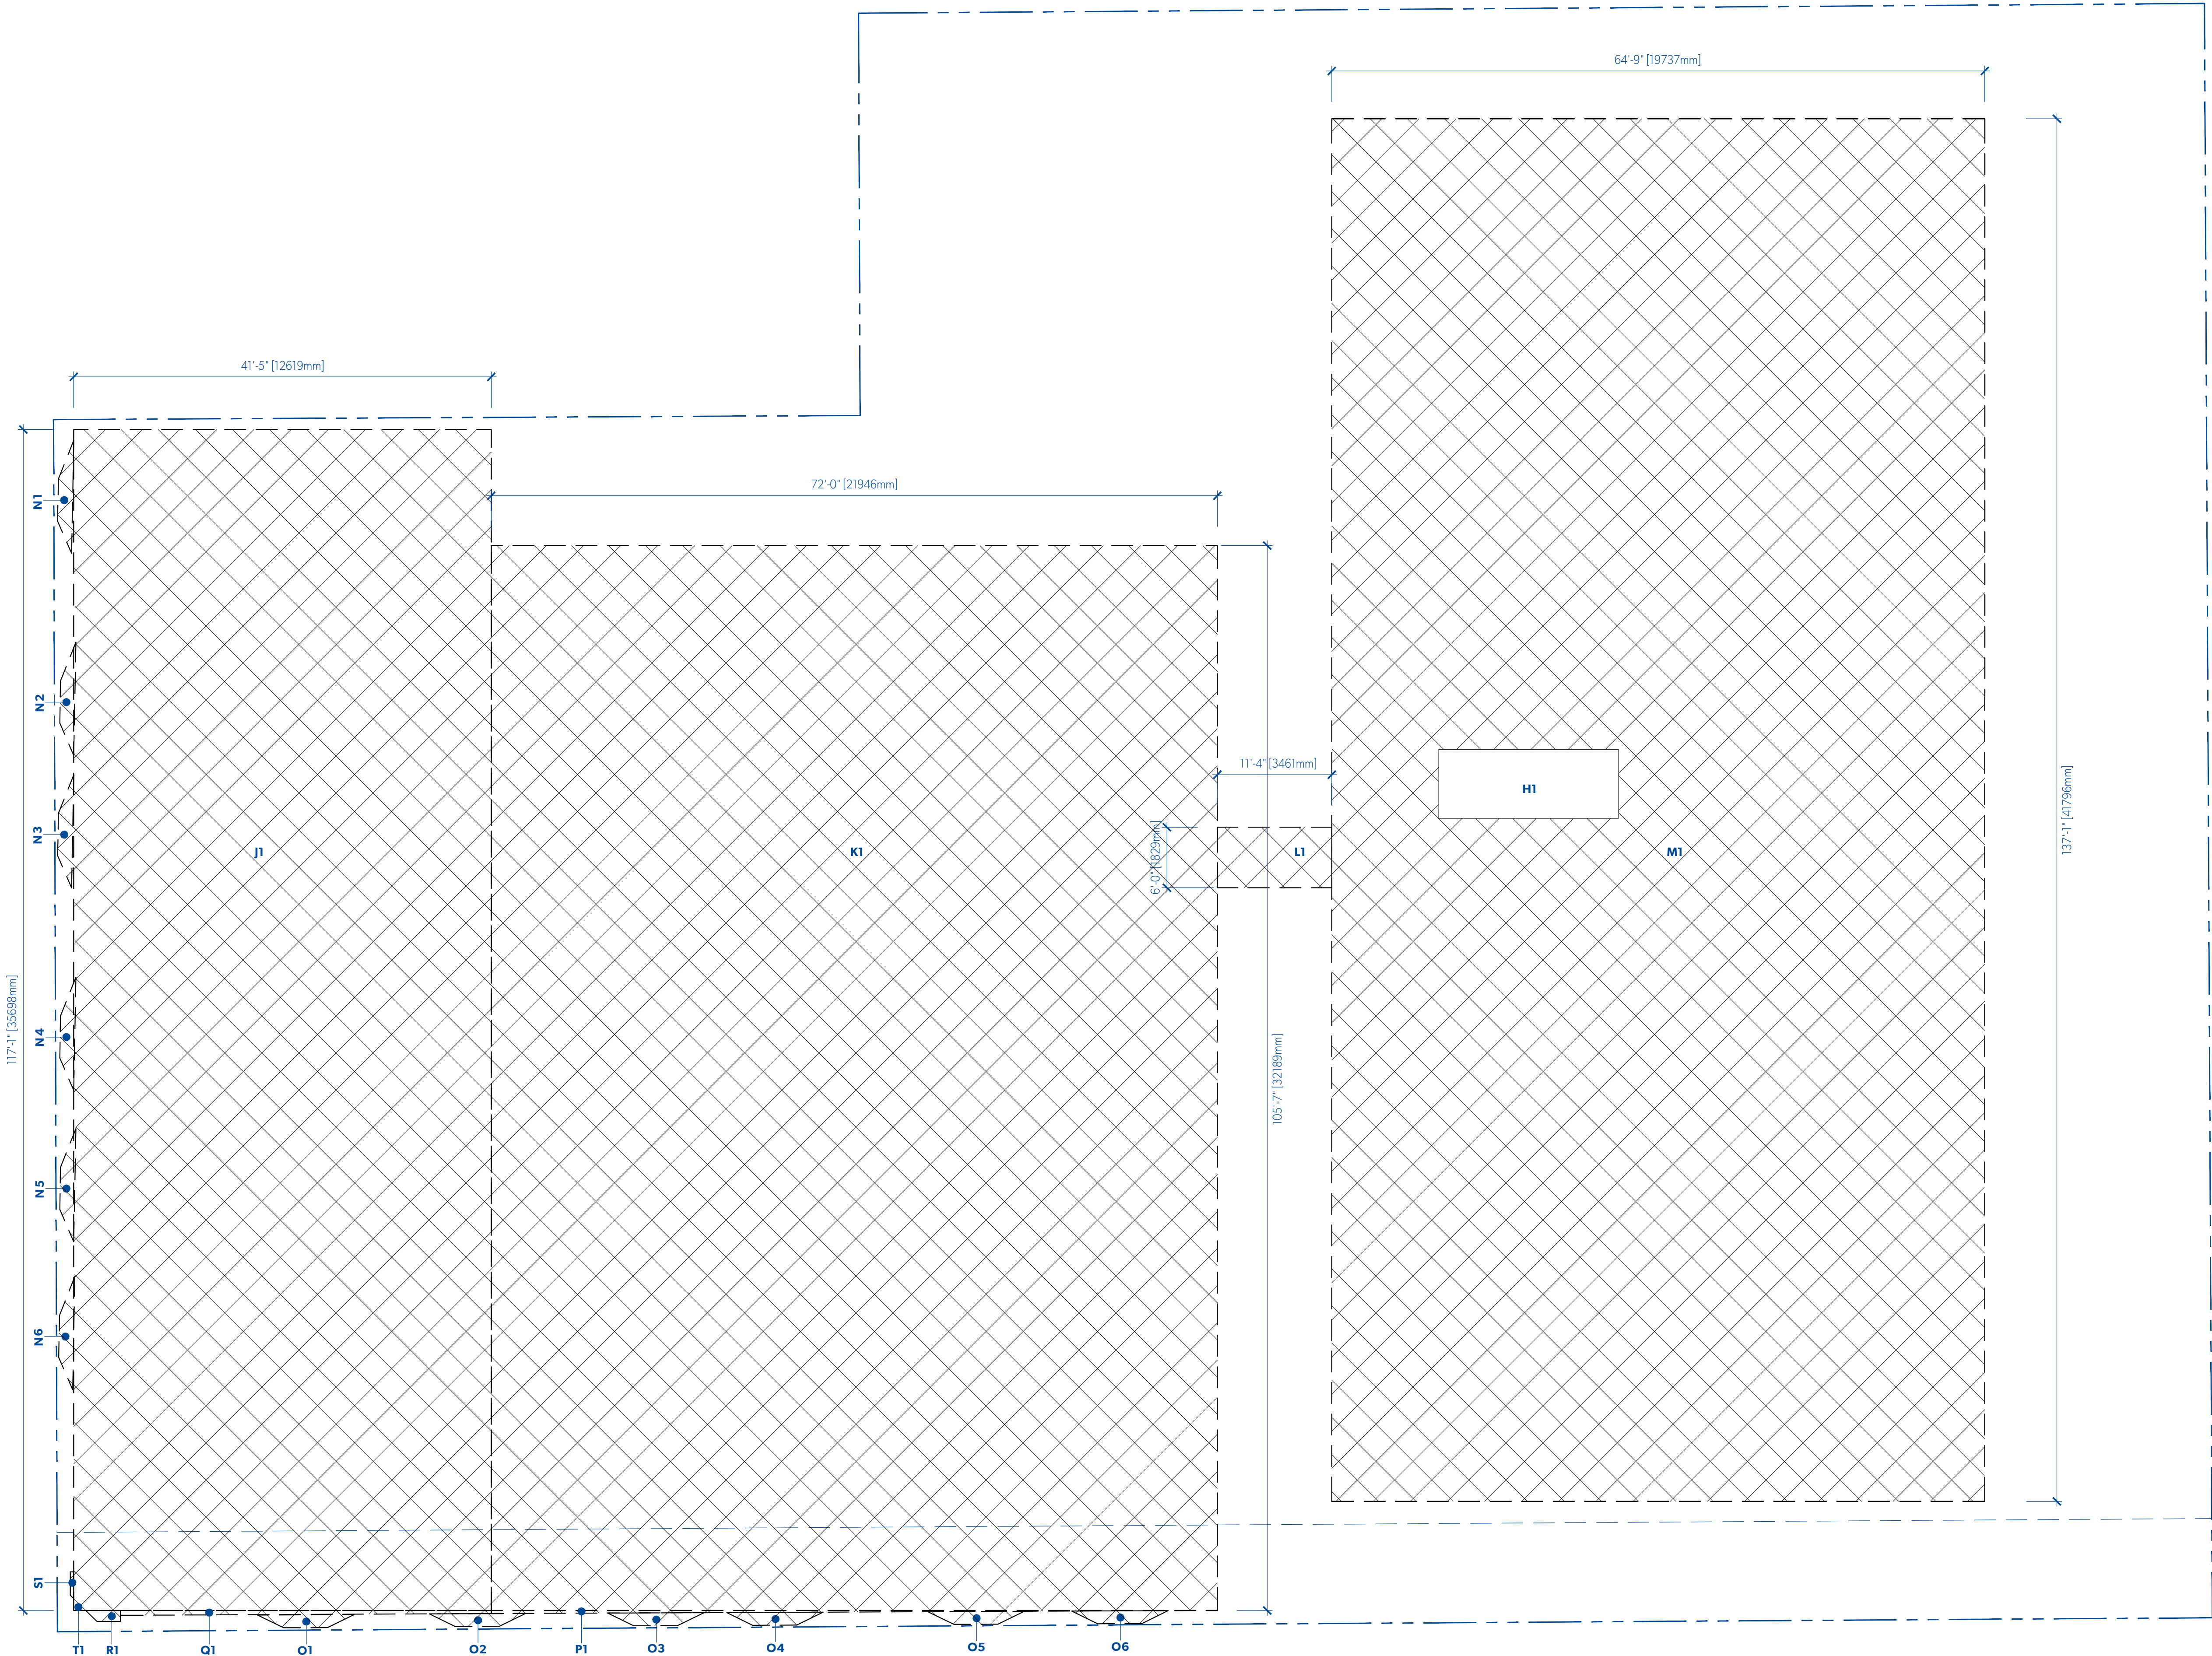


LEVEL 2					
	METRIC (M2)				
	LENGTH	WIDTH	AREA	QTY	TOTAL
GROSS AREA					
J1	35.69	x	12.62	=	450.49 m2
K1	32.19	x	21.95	=	706.41 m2
L1	1.93	x	3.46	=	6.33 m2
M1	41.80	x	19.74	=	824.93 m2
N	(SEE N CALCULATIONS)		=	1.03 m2	x 6 = 6.17 m2
O	(SEE O CALCULATIONS)		=	0.82 m2	x 6 = 4.94 m2
P	0.09	x	21.95	=	2.07 m2
Q	(SEE Q CALCULATIONS)		=	1.35 m2	x 1 = 1.35 m2
R	(SEE R CALCULATIONS)		=	0.29 m2	x 1 = 0.29 m2
S	(SEE S CALCULATIONS)		=	0.08 m2	x 1 = 0.08 m2
TOTAL GROSS AREA					2002.02 m2
AREA DEDUCTIONS					
H	5.44	x	2.08	=	11.32 m2
T	0.36	x	0.36	=	1.32 m2
TOTAL DEDUCTIONS					12.00 m2
TOTAL GROSS AREA					2002.02 m2
TOTAL DEDUCTIONS					12.00 m2
TOTAL NET AREA					1990.02 m2
N CALCULATIONS					
GROSS AREA					
Na	0.44	x	1.17	=	0.51 m2
Nb	0.44	x	1.28	=	0.56 m2
Nc	0.44	x	0.97	=	0.42 m2
TOTAL NET AREA					1.03 m2
O CALCULATIONS					
GROSS AREA					
Oa	0.39	x	0.78	=	0.30 m2
Ob	0.39	x	1.33	=	0.52 m2
Oc	0.39	x	0.80	=	0.31 m2
TOTAL NET AREA					0.82 m2
Q CALCULATIONS					
GROSS AREA					
Qa	0.10	x	11.21	=	1.07 m2
Qb	0.05	x	11.21	=	0.57 m2
TOTAL NET AREA					1.35 m2
R CALCULATIONS					
GROSS AREA					
Ra	0.33	x	0.34	=	0.11 m2
Rb	0.33	x	0.71	=	0.23 m2
TOTAL NET AREA					0.29 m2
S CALCULATIONS					
GROSS AREA					
Sa	0.71	x	0.10	=	0.07 m2
Sb	0.10	x	0.10	=	0.01 m2
TOTAL NET AREA					0.08 m2

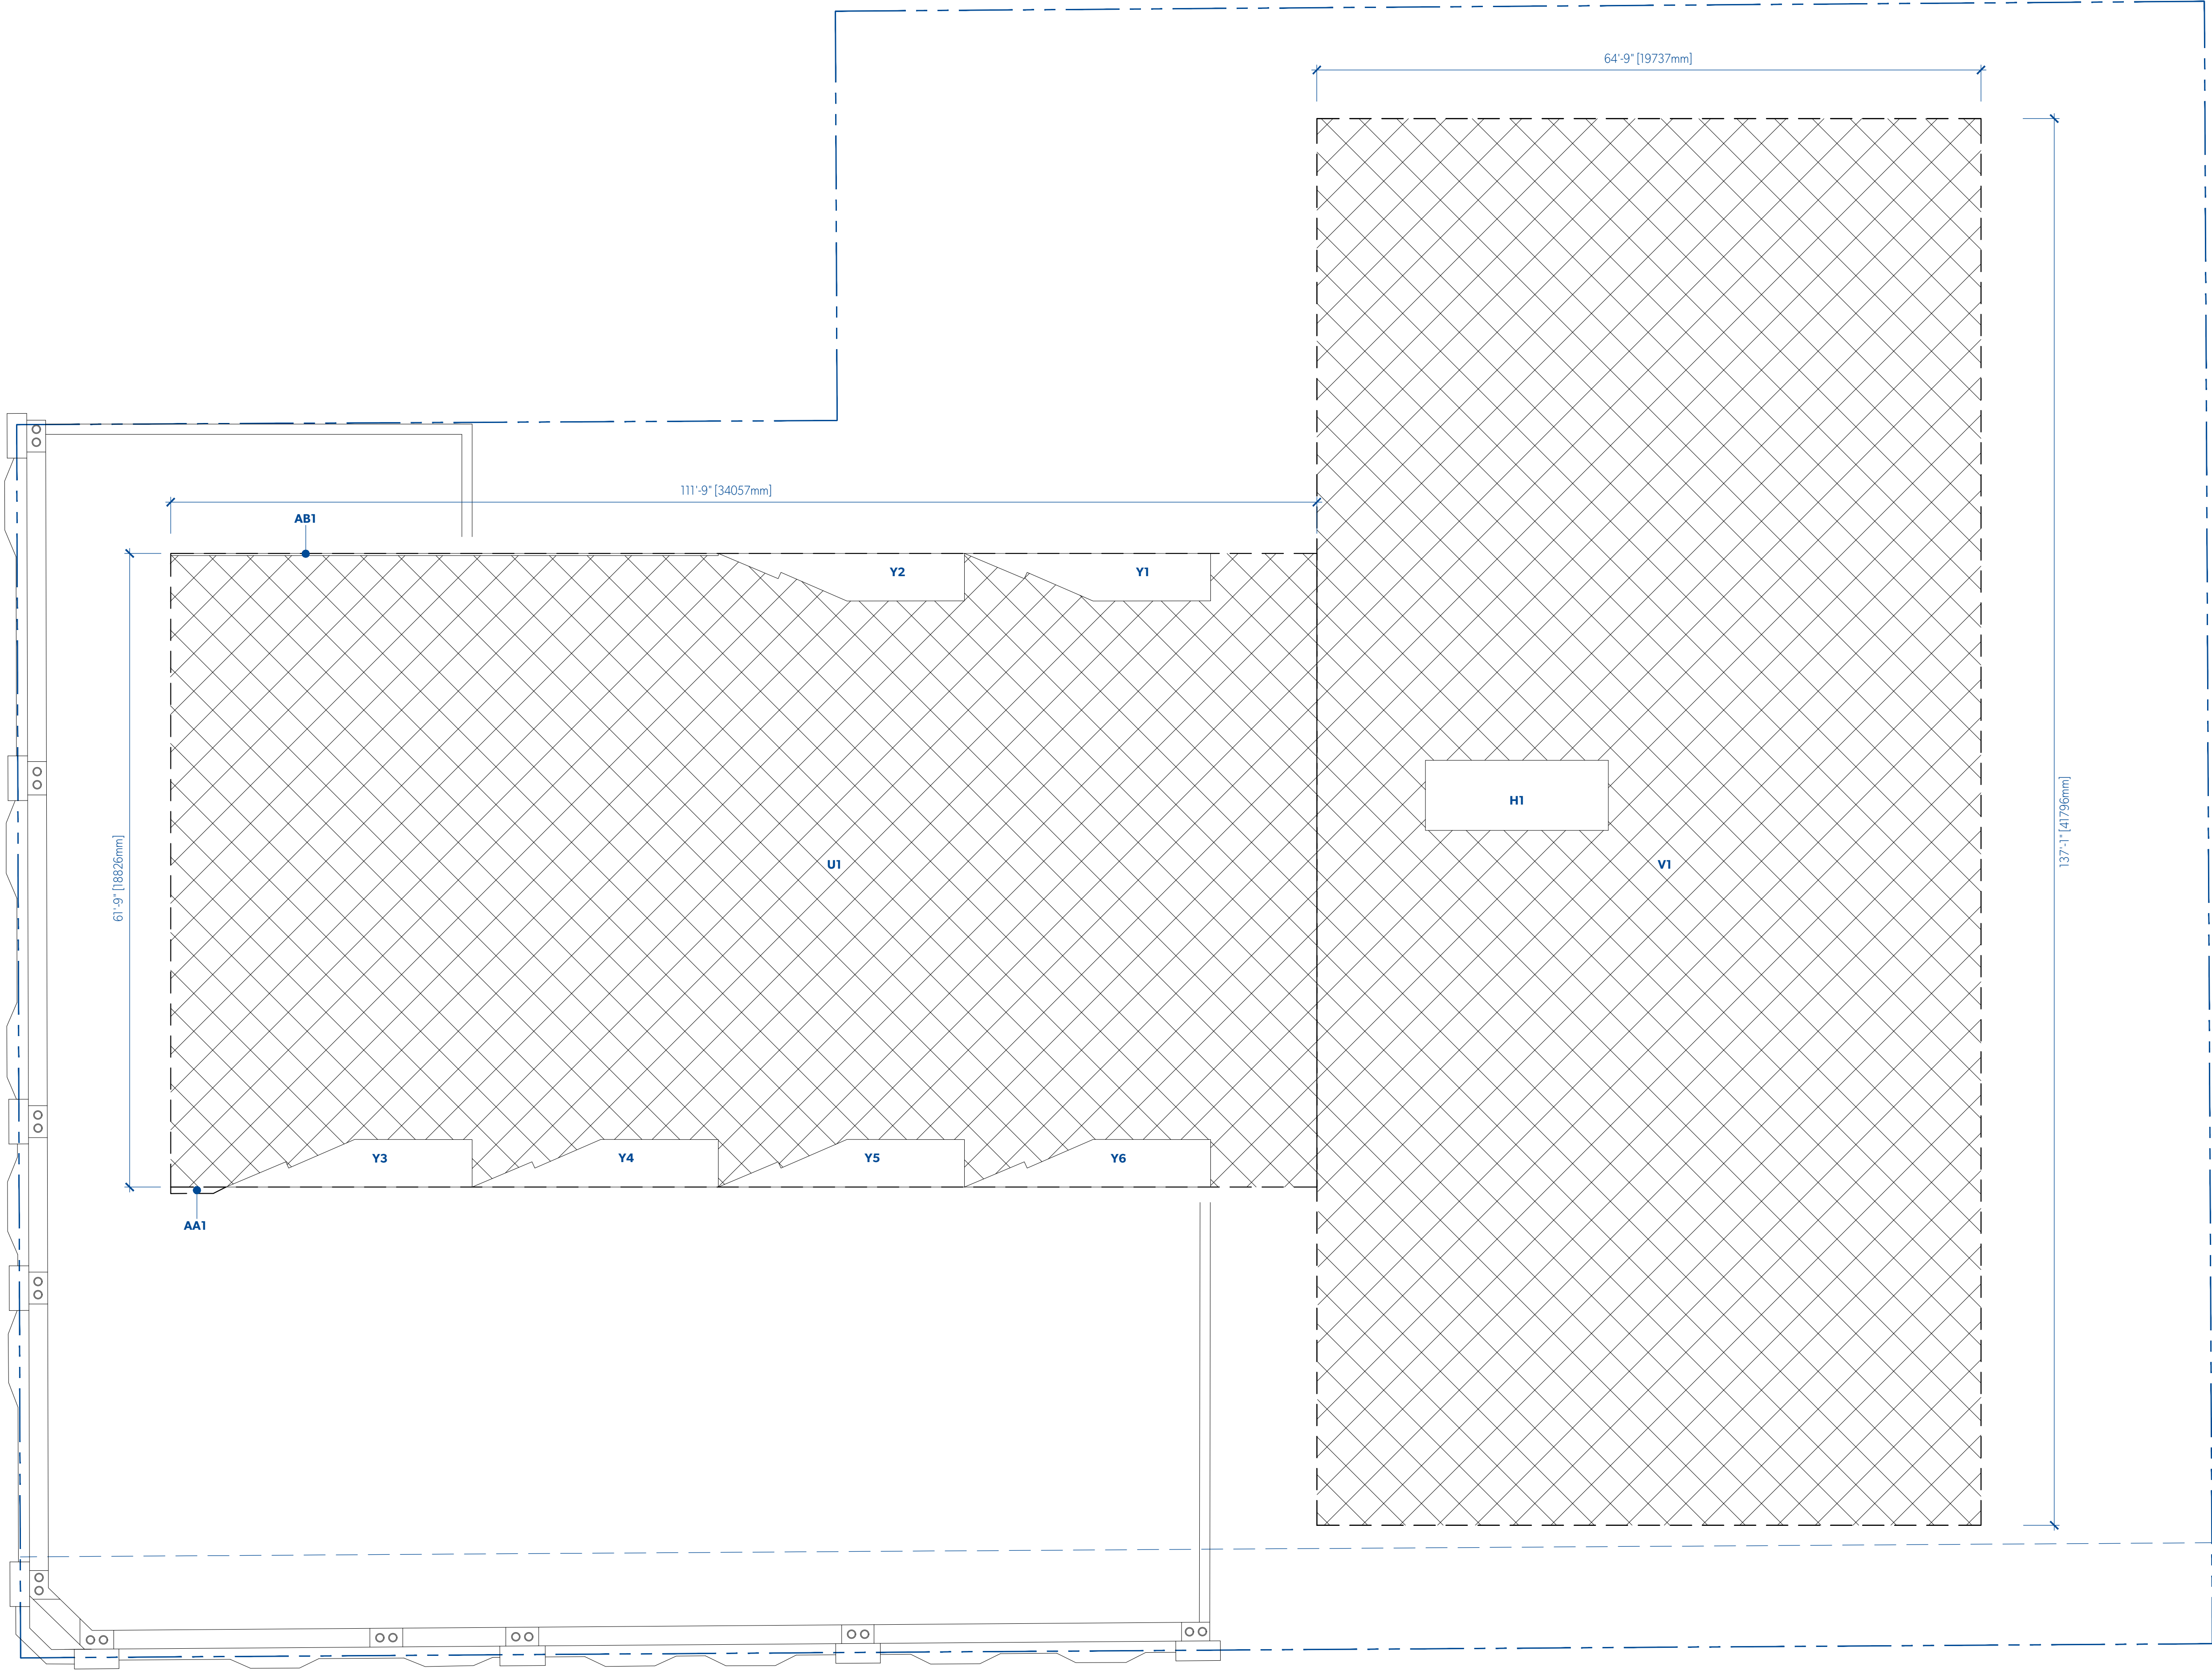


LEVEL 3					
	METRIC (M2)				
	LENGTH	WIDTH	AREA	QTY	TOTAL
GROSS AREA					
U1	18.82	x	34.06	=	641.06 m2
V1	41.80	x	19.74	=	824.93 m2
AA1	(SEE AA CALCULATIONS)		=	0.28 m2	x 1 = 0.28 m2
TOTAL GROSS AREA					1466.26 m2
AREA DEDUCTIONS					
H	5.44	x	2.08	=	11.32 m2
Y	(SEE Y CALCULATIONS)		=	7.56 m2	x 6 = 45.36 m2
AB1	0.06	x	16.27	=	1.03 m2
TOTAL DEDUCTIONS					57.71 m2
TOTAL GROSS AREA					1466.26 m2
TOTAL DEDUCTIONS					57.71 m2
TOTAL NET AREA					1408.55 m2
Y CALCULATIONS					
GROSS AREA					
Y1	0.82	x	1.88	=	1.54 m2
Y2	0.61	x	2.14	=	1.31 m2
Y3	1.72	x	1.41	=	2.42 m2
Y4	1.41	x	3.49	=	4.92 m2
TOTAL NET AREA					7.56 m2
AA CALCULATIONS					
GROSS AREA					
Aaa	0.19	x	1.26	=	0.24 m2
Aab	0.19	x	0.37	=	0.07 m2
TOTAL NET AREA					0.28 m2

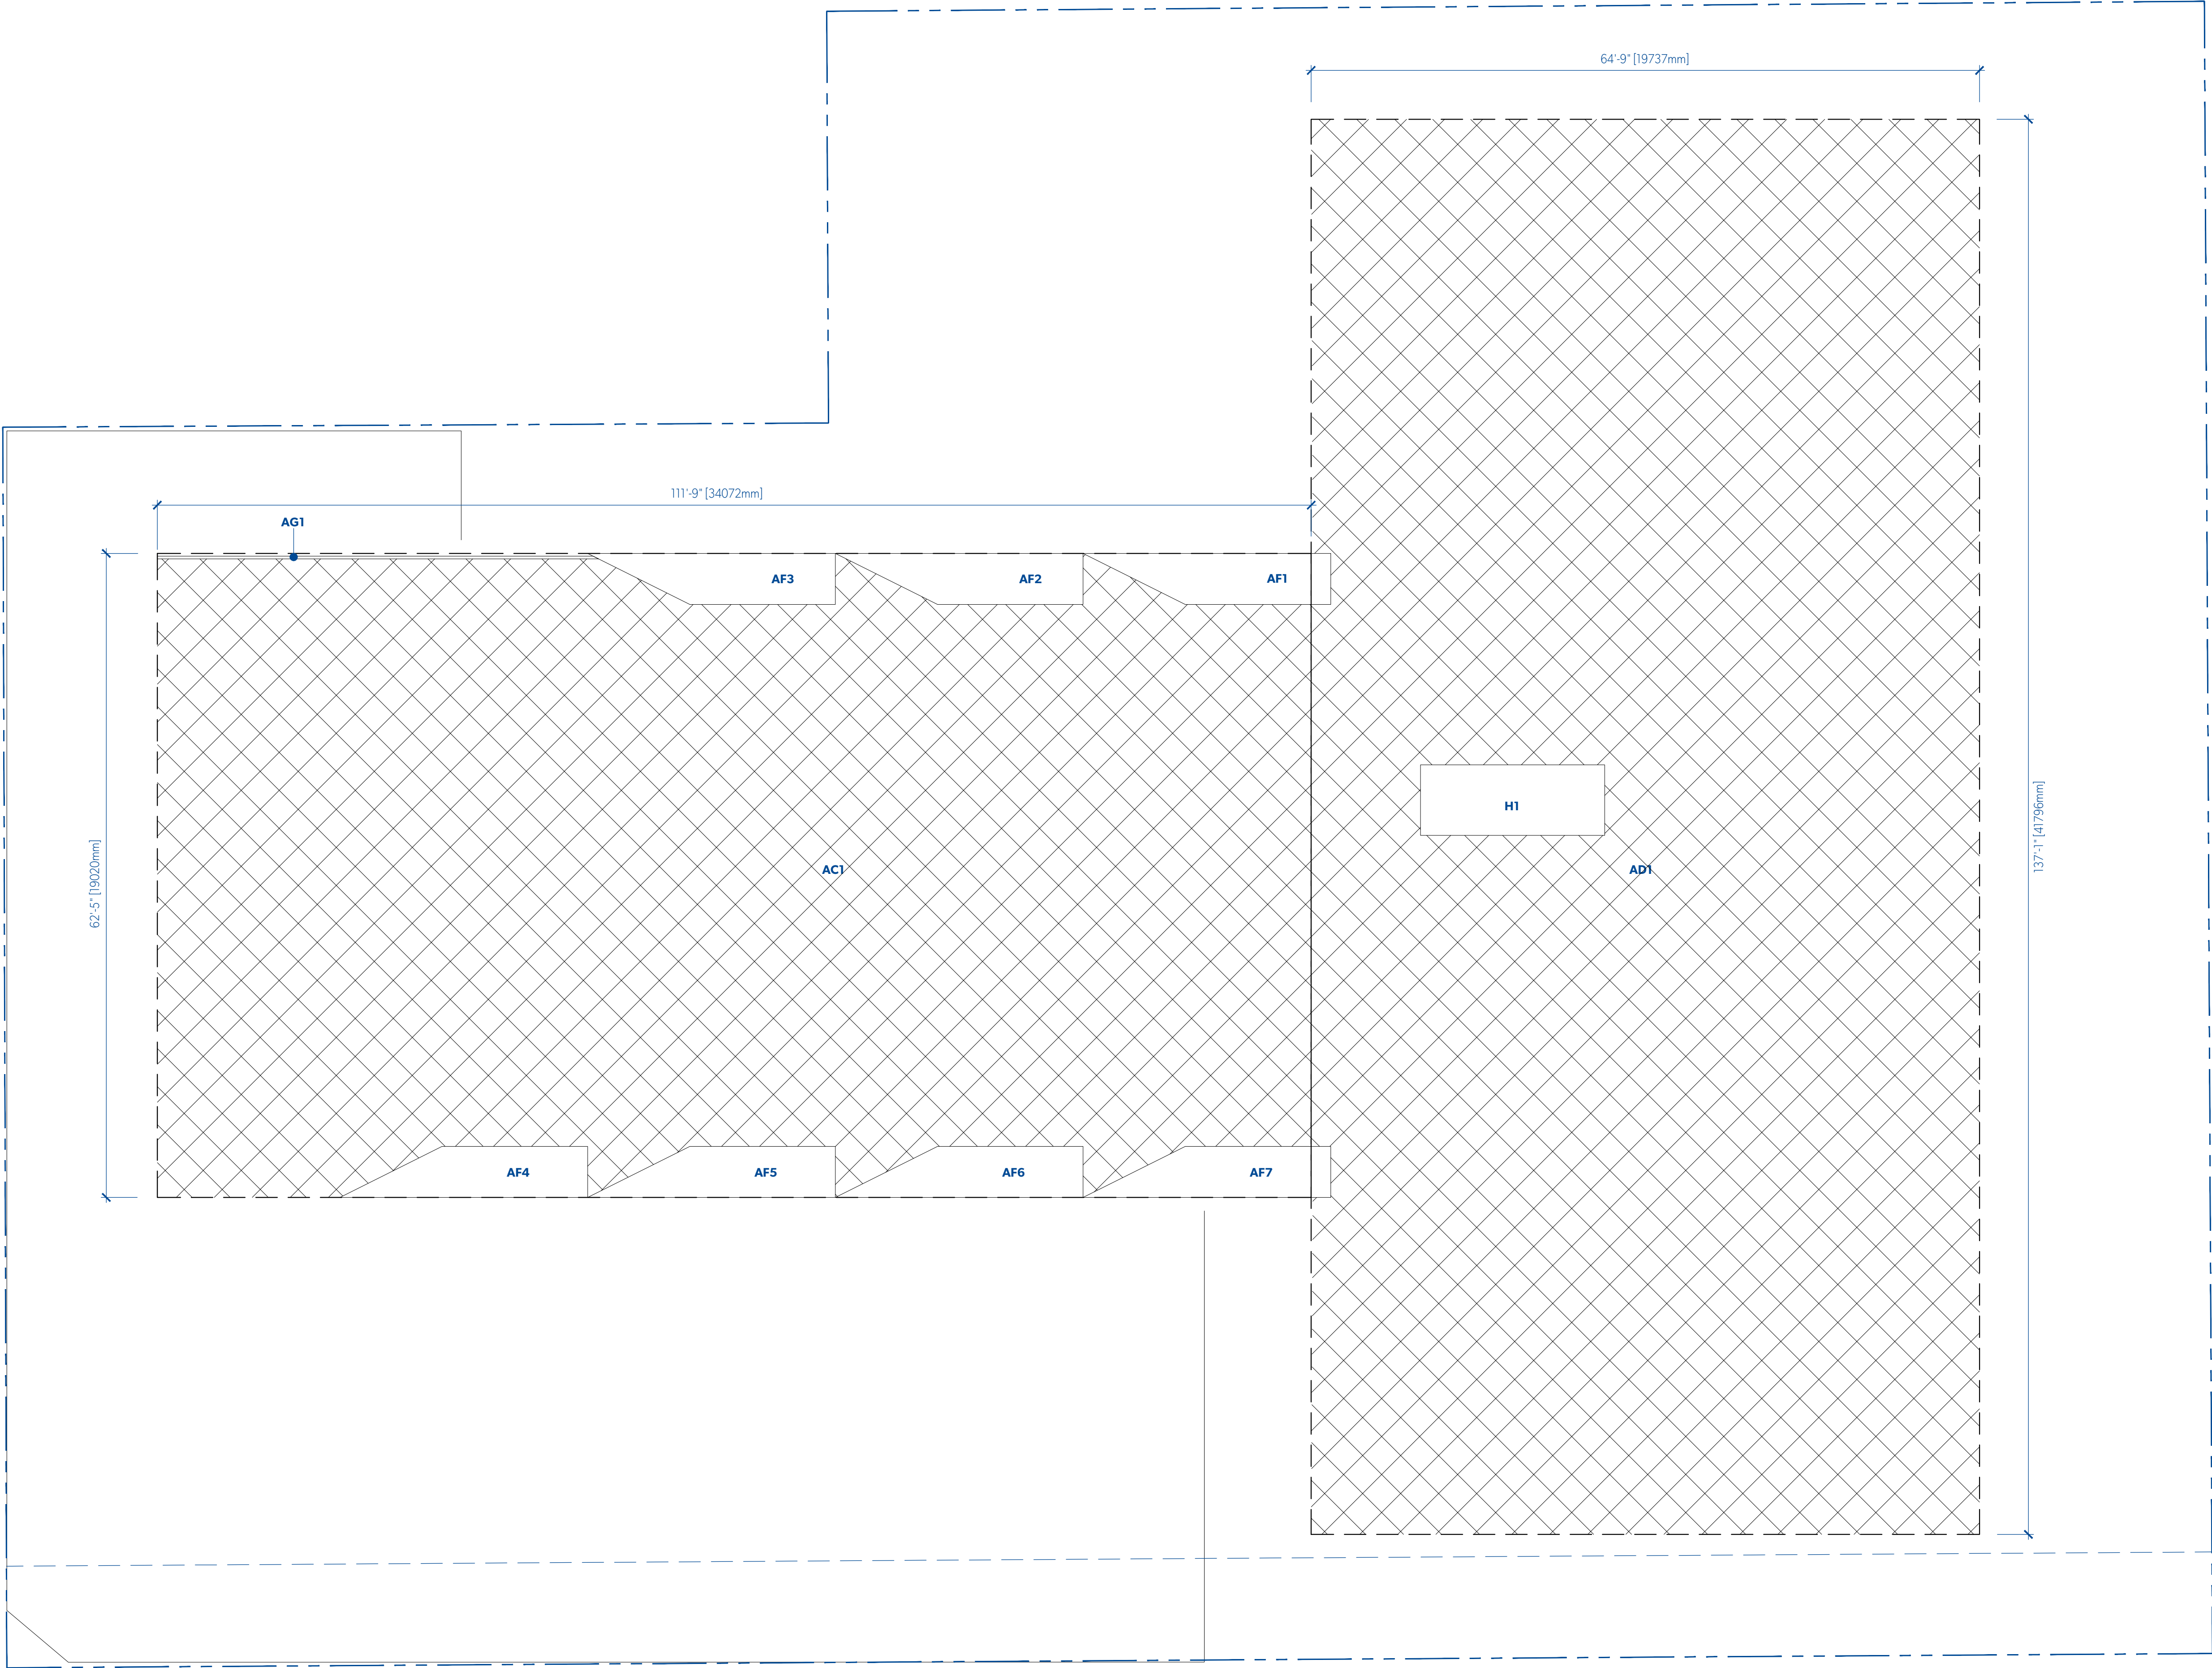

LEVEL 4						
	METRIC (M2)					
	LENGTH		WIDTH		AREA	
GROSS AREA	AC1	19.02	x	34.07	=	648.17 m2
	AD1	41.80	x	19.74	=	824.93 m2
						1
						=
						648.17 m2
						824.93 m2
TOTAL GROSS AREA						1473.10 m2
AREA DEDUCTIONS						
H	5.44	x	2.08	=	11.32 m2	1
	(SEE AF CALCULATIONS)			=	8.78 m2	7
AF				=	61.43 m2	
AG1				=	1.04 m2	1
						11.32 m2
						61.43 m2
						1.04 m2
TOTAL DEDUCTIONS						73.79 m2
TOTAL GROSS AREA						1473.10 m2
TOTAL DEDUCTIONS						73.79 m2
						-
TOTAL NET AREA						1399.30 m2
AF CALCULATIONS						
GROSS AREA						
AFa	1.51	x	3.02	=	4.56 m2	0.5
AFb	1.51	x	4.30	=	6.50 m2	1
						2.28 m2
						6.50 m2
TOTAL NET AREA						6.78 m2
AG1 CALCULATIONS						
GROSS AREA						
AGa	0.08	x	12.87	=	1.03 m2	1
AGb	0.08	x	0.16	=	0.01 m2	0.5
						1.03 m2
						0.01 m2
TOTAL NET AREA						1.04 m2

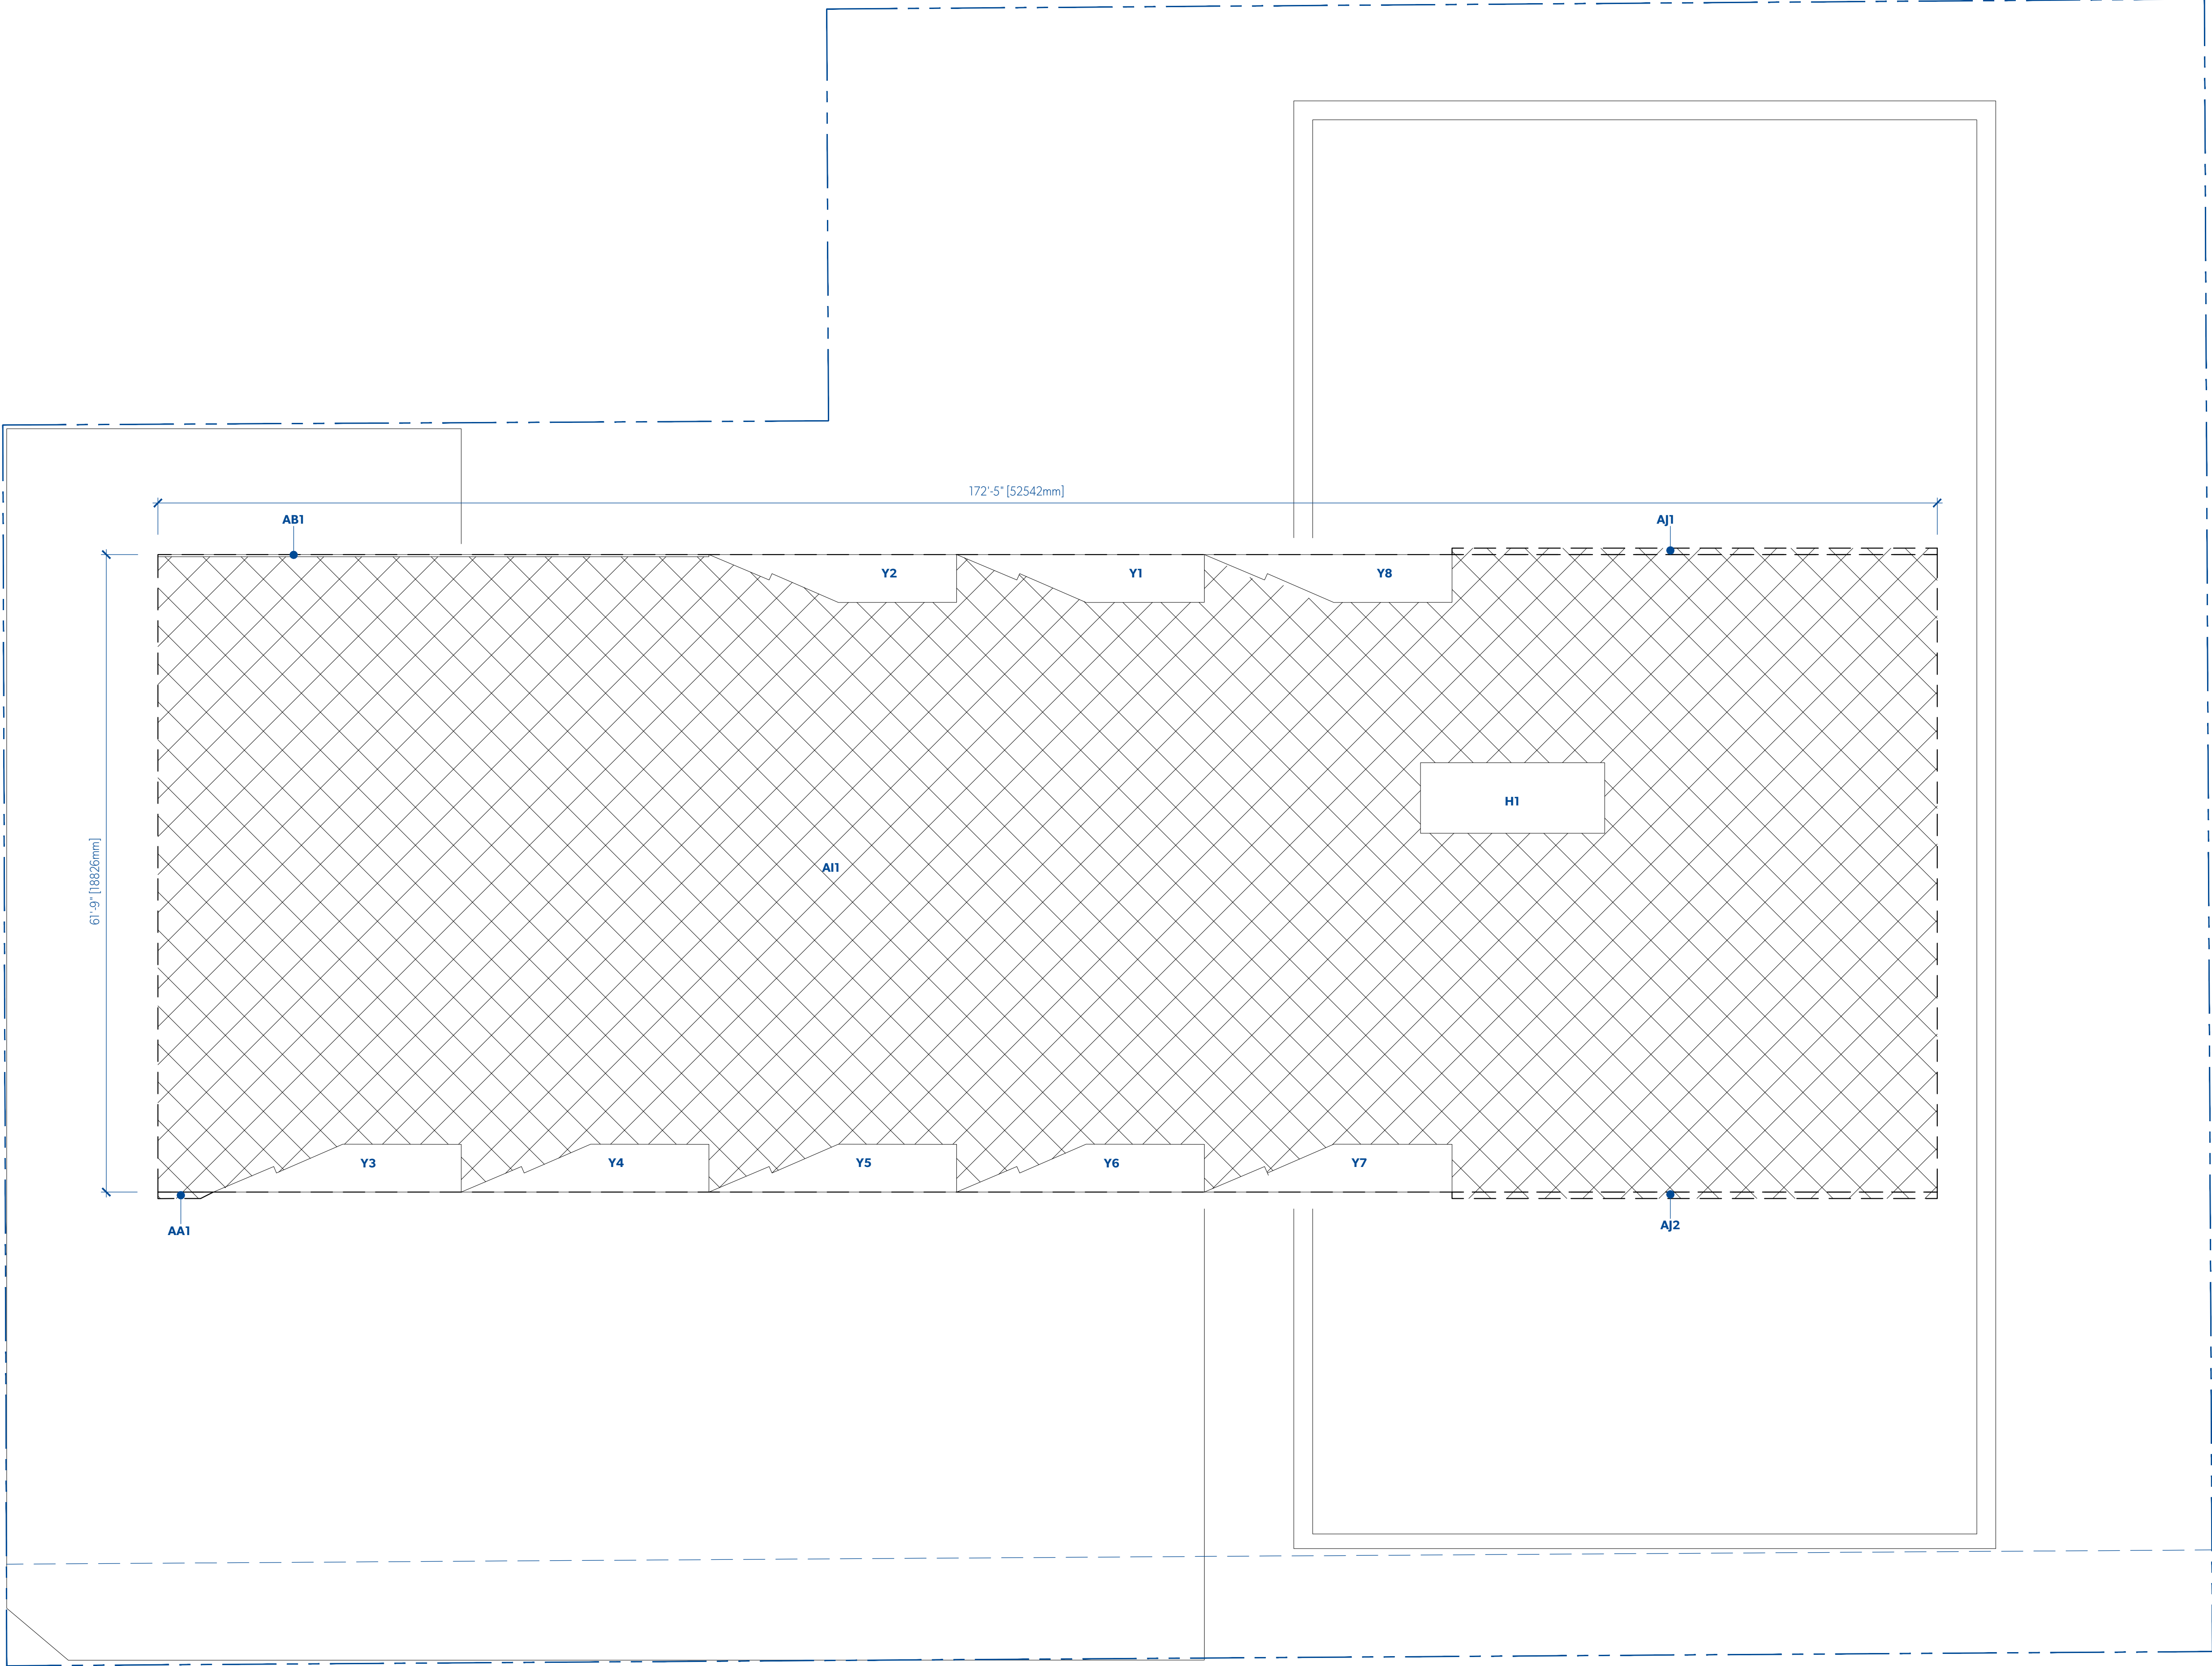

LEVEL 5						
	METRIC (M2)					
	LENGTH	WIDTH		AREA	QTY	TOTAL
GROSS AREA						
AI1	18.82	x	52.50	=	988.12 m2	x 1 =
AJ	0.19	x	14.33	=	2.73 m2	x 2 =
AA1	(SEE AA CALCULATIONS)			=	0.28 m2	x 1 =
TOTAL GROSS AREA					993.86 m2	
AREA DEDUCTIONS						
H	5.44	x	2.08	=	11.32 m2	x 1 =
Y	(SEE Y CALCULATIONS)			=	7.56 m2	x 8 =
AB1	0.06	x	16.27	=	1.03 m2	x 1 =
TOTAL DEDUCTIONS					72.83 m2	
TOTAL GROSS AREA					993.86 m2	
TOTAL DEDUCTIONS					72.83 m2	
TOTAL NET AREA					921.02 m2	
Y CALCULATIONS						
GROSS AREA						
Y1	0.82	x	1.88	=	1.54 m2	x 0.5 =
Yb	0.61	x	2.14	=	1.31 m2	x 0.5 =
Yc	1.72	x	1.41	=	2.42 m2	x 0.5 =
Yd	1.41	x	3.49	=	4.92 m2	x 1 =
TOTAL NET AREA					7.56 m2	
Z CALCULATIONS						
GROSS AREA						
Za	0.82	x	1.66	=	1.36 m2	x 0.5 =
Zb	0.61	x	2.10	=	1.29 m2	x 0.5 =
Zc	1.68	x	1.41	=	2.37 m2	x 0.5 =
Zd	1.41	x	3.54	=	4.99 m2	x 1 =
Ze	0.09	x	1.85	=	0.16 m2	x 0.5 =
TOTAL NET AREA					7.58 m2	
AA CALCULATIONS						
GROSS AREA						
Aaa	0.19	x	1.26	=	0.24 m2	x 1 =
AAb	0.19	x	0.37	=	0.07 m2	x 0.5 =
TOTAL NET AREA					0.28 m2	

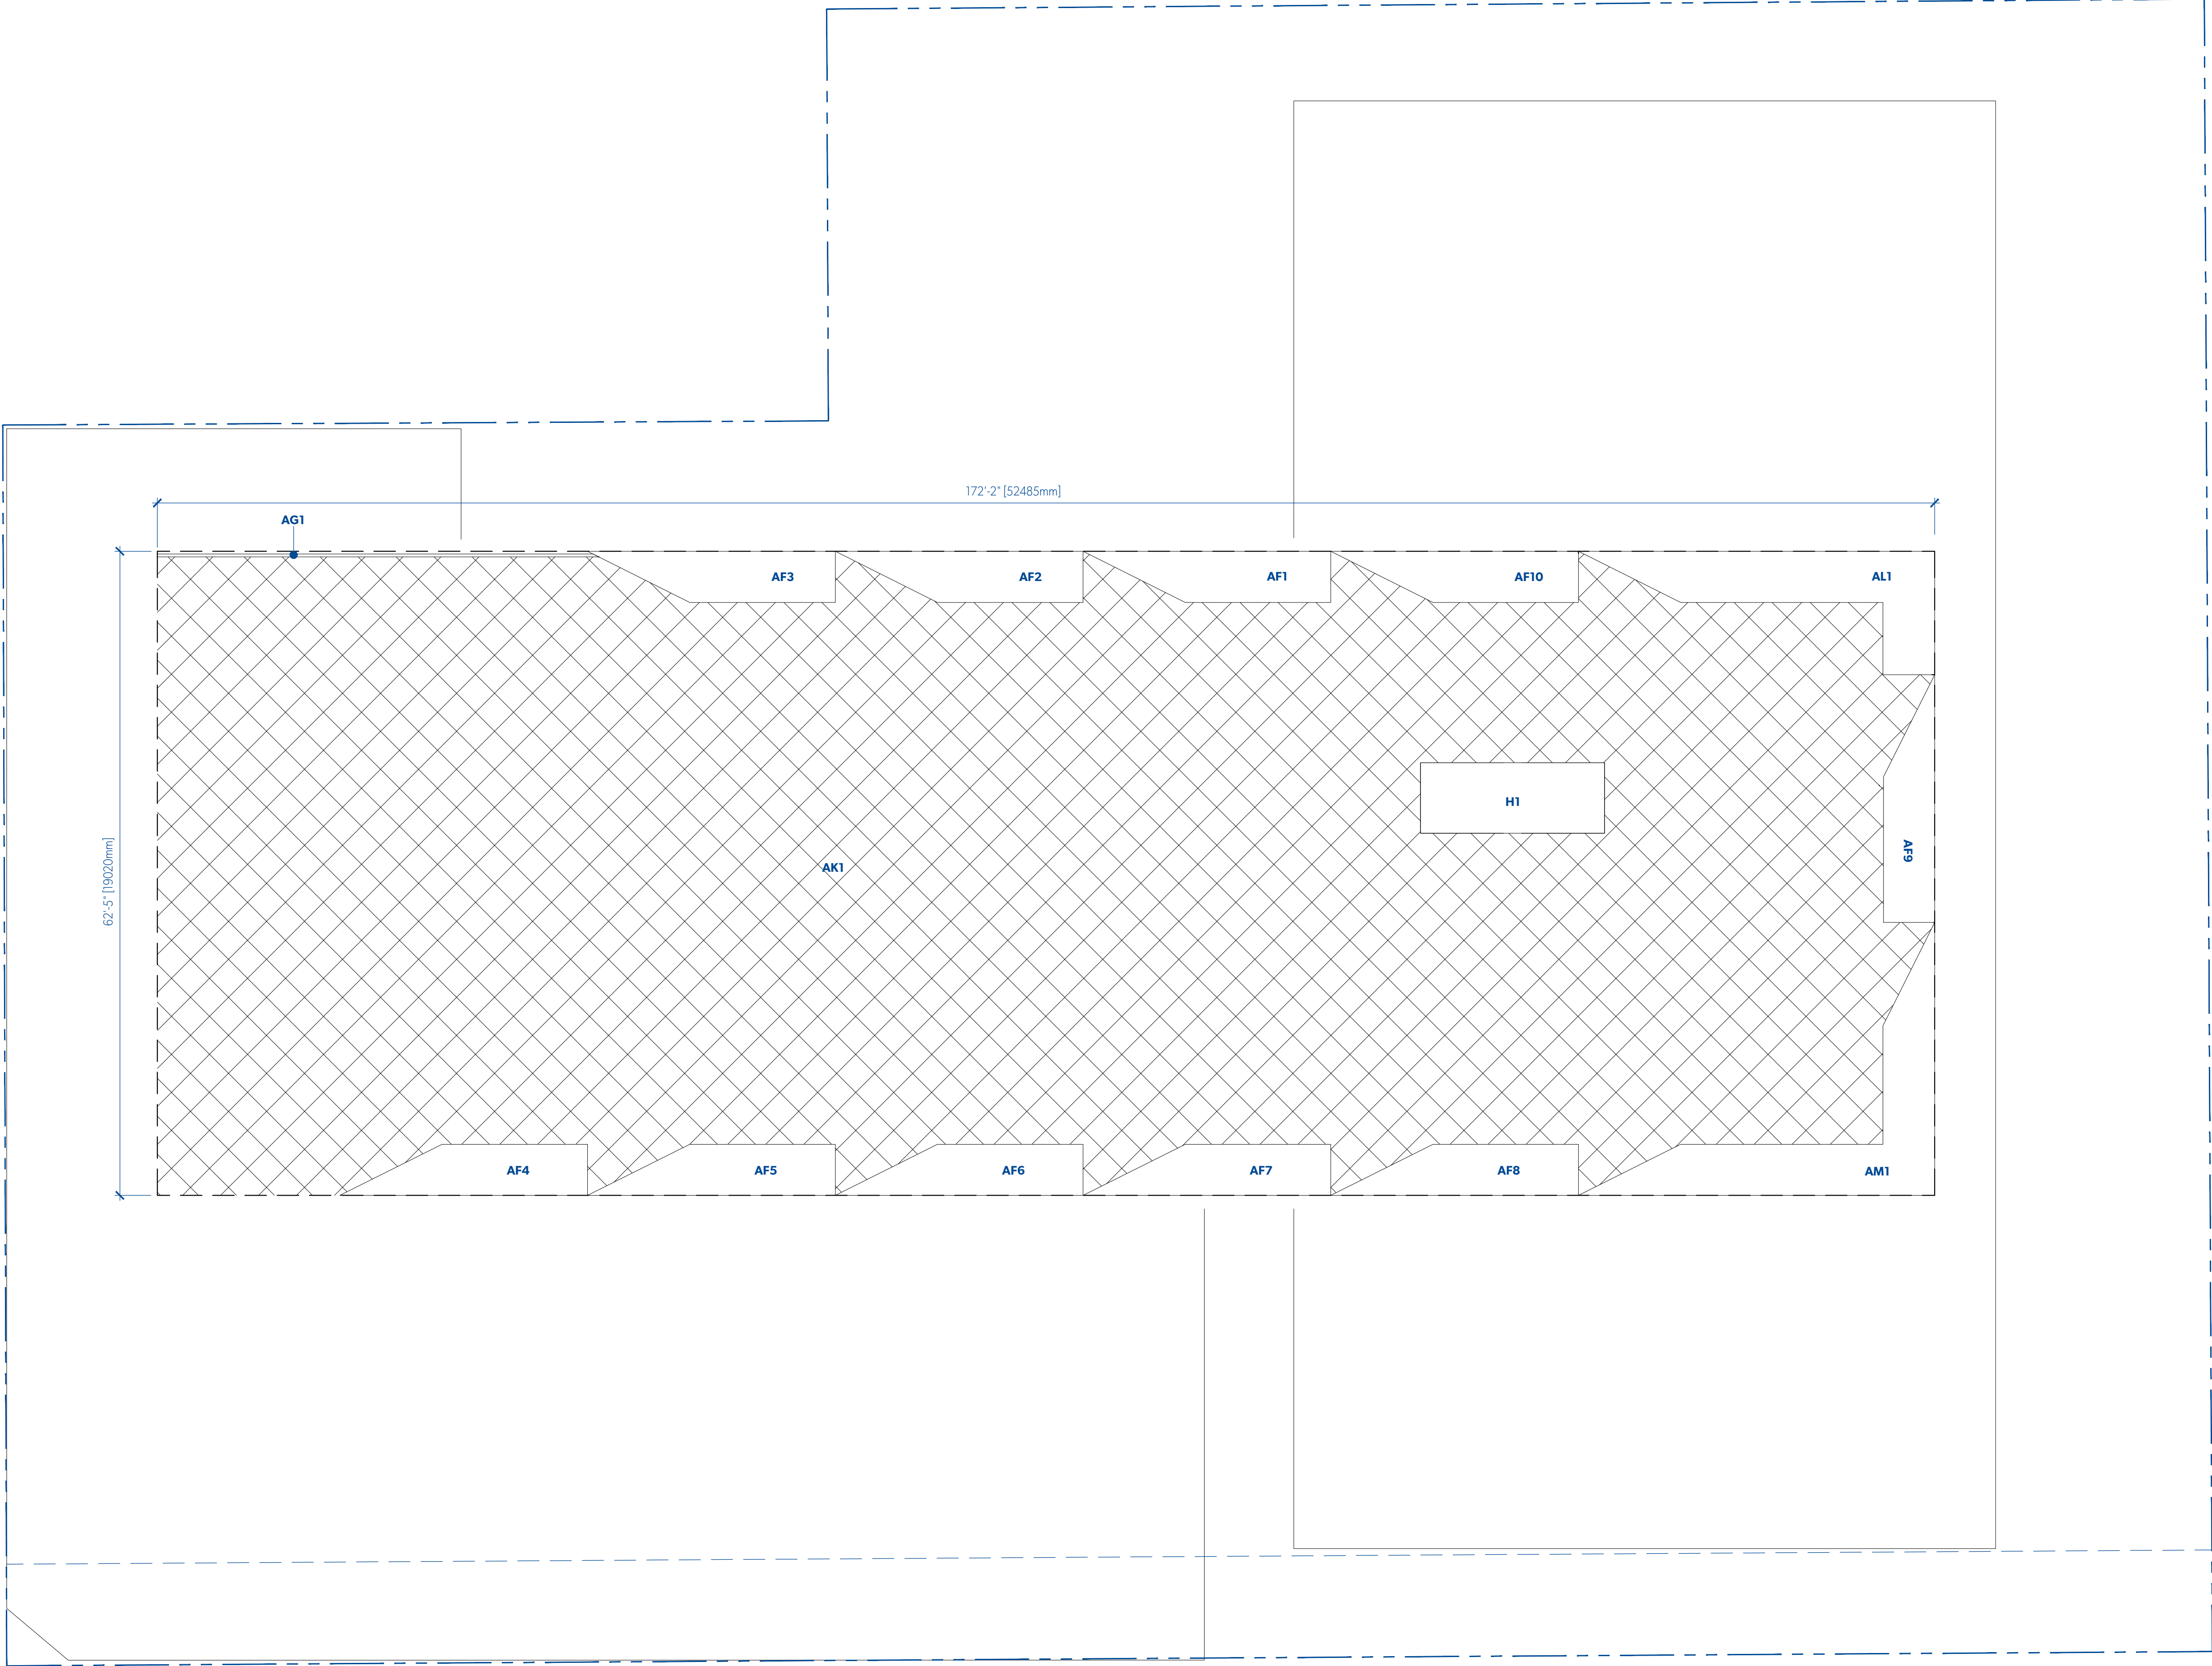

1
A806

FSR LEVEL 6
1:100

LEVEL 6					
	METRIC (M2)				
	LENGTH	WIDTH	AREA	QTY	TOTAL
GROSS AREA					
AK1	19.02	x	52.50	=	998.79 m2 x 1 = 998.79 m2
TOTAL GROSS AREA					998.79 m2
AREA DEDUCTIONS					
H	5.44	x	2.08	=	11.32 m2 x 1 = 11.32 m2
AF	(SEE AF CALCULATIONS)			=	87.76 m2 x 10 = 87.76 m2
AG1	(SEE AG CALCULATIONS)			=	1.04 m2 x 1 = 1.04 m2
AL1	(SEE AL CALCULATIONS)			=	16.86 m2 x 1 = 16.86 m2
AM1	(SEE AM CALCULATIONS)			=	21.23 m2 x 1 = 21.23 m2
TOTAL DEDUCTIONS					138.21 m2
TOTAL GROSS AREA					998.79 m2
TOTAL DEDUCTIONS					- 138.21 m2
TOTAL NET AREA					860.58 m2
AF CALCULATIONS					
GROSS AREA					
AFa	1.51	x	3.02	=	4.56 m2 x 0.5 = 2.28 m2
AFb	1.51	x	4.30	=	6.50 m2 x 1 = 6.50 m2
TOTAL NET AREA					8.78 m2
AG1 CALCULATIONS					
GROSS AREA					
AGa	0.08	x	12.87	=	1.03 m2 x 1 = 1.03 m2
AGb	0.08	x	0.16	=	0.01 m2 x 0.5 = 0.01 m2
TOTAL NET AREA					1.04 m2
AL1 CALCULATIONS					
GROSS AREA					
ALa	1.51	x	3.02	=	4.56 m2 x 0.5 = 2.28 m2
ALb	1.51	x	7.50	=	11.33 m2 x 1 = 11.33 m2
ALc	2.13	x	1.52	=	3.25 m2 x 1 = 3.25 m2
TOTAL NET AREA					16.86 m2
AM1 CALCULATIONS					
GROSS AREA					
AMa	3.05	x	1.52	=	4.65 m2 x 0.5 = 2.33 m2
AMb	1.51	x	3.50	=	5.29 m2 x 1 = 5.29 m2
AMc	1.51	x	7.50	=	11.33 m2 x 1 = 11.33 m2
AMd	1.51	x	3.02	=	4.56 m2 x 0.5 = 2.28 m2
TOTAL NET AREA					21.23 m2

PARKWAY

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MICHAEL GREEN ARCHITECTURE
1535 W 3RD AVENUE, VANCOUVER BC
CANADA V6J 1J8

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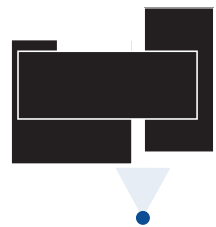
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VICTORIA, BC
2018-001



1 VIEW WEST THROUGH RESIDENTIAL MEWS
A812



MICHAEL GREEN ARCHITECTURE
1535 W 3RD AVENUE, VANCOUVER BC
CANADA V6J 1J8

2020-03-20	3	REVISED FOR REZONING
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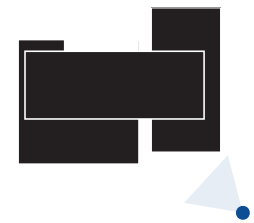
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PARKWAY

1050 PANDORA AVE + 1518 COOK STREET
VICTORIA, BC
2018-001



1 VIEW SOUTHWEST FROM COOK STREET
A813



MICHAEL GREEN ARCHITECTURE
1535 W 3RD AVENUE, VANCOUVER BC
CANADA V6J 1J8

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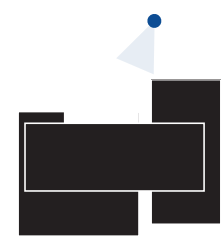
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1050 PANDORA AVE + 1518 COOK STREET
VICTORIA, BC
2018-001



1 VIEW EAST TO COURTYARD
A815



MICHAEL GREEN ARCHITECTURE
1535 W 3RD AVENUE, VANCOUVER BC
CANADA V6J 1J8

2020-03-20	3	REVISED FOR REZONING
2019-10-30	2	REVISED FOR REZONING
2019-09-13	1	REVISED FOR REZONING
2019-05-15	0	ISSUED FOR REZONING

DATE	REVISION	DESCRIPTION
------	----------	-------------

PARKWAY

1050 PANDORA AVE + 1518 COOK STREET
VICTORIA, BC
2018-001



MICHAEL GREEN ARCHITECTURE
1535 W 3RD AVENUE, VANCOUVER BC
CANADA V6J 1J8

2020-03-20	3	REVISED FOR REZONING
2019-10-30	2	REVISED FOR REZONING
2019-09-13	1	REVISED FOR REZONING
2019-05-15	0	ISSUED FOR REZONING

DATE REVISION DESCRIPTION

PARKWAY

1050 PANDORA AVE + 1518 COOK STREET
VICTORIA, BC
2018-001



1 **ADJACENT PROPERTY STUDY | VIEW WEST ACROSS COOK STREET**
A817



3 **ADJACENT PROPERTY STUDY | VIEW EAST ACROSS FRANKLIN GREEN PARK**
A817



2 **ADJACENT PROPERTY STUDY | VIEW SOUTHWEST DOWN COOK STREET**
A817



4 **ADJACENT PROPERTY STUDY | VIEW WEST ALONG NORTH WALKWAY**
A817



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1535 W 3RD AVENUE, VANCOUVER BC
CANADA V6J 1J8

2020-03-20	3	REVISED FOR REZONING
2019-10-30	2	REVISED FOR REZONING
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DATE REVISION DESCRIPTION

PARKWAY

1050 PANDORA AVE + 1518 COOK STREET
VICTORIA, BC
2018-001

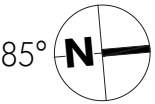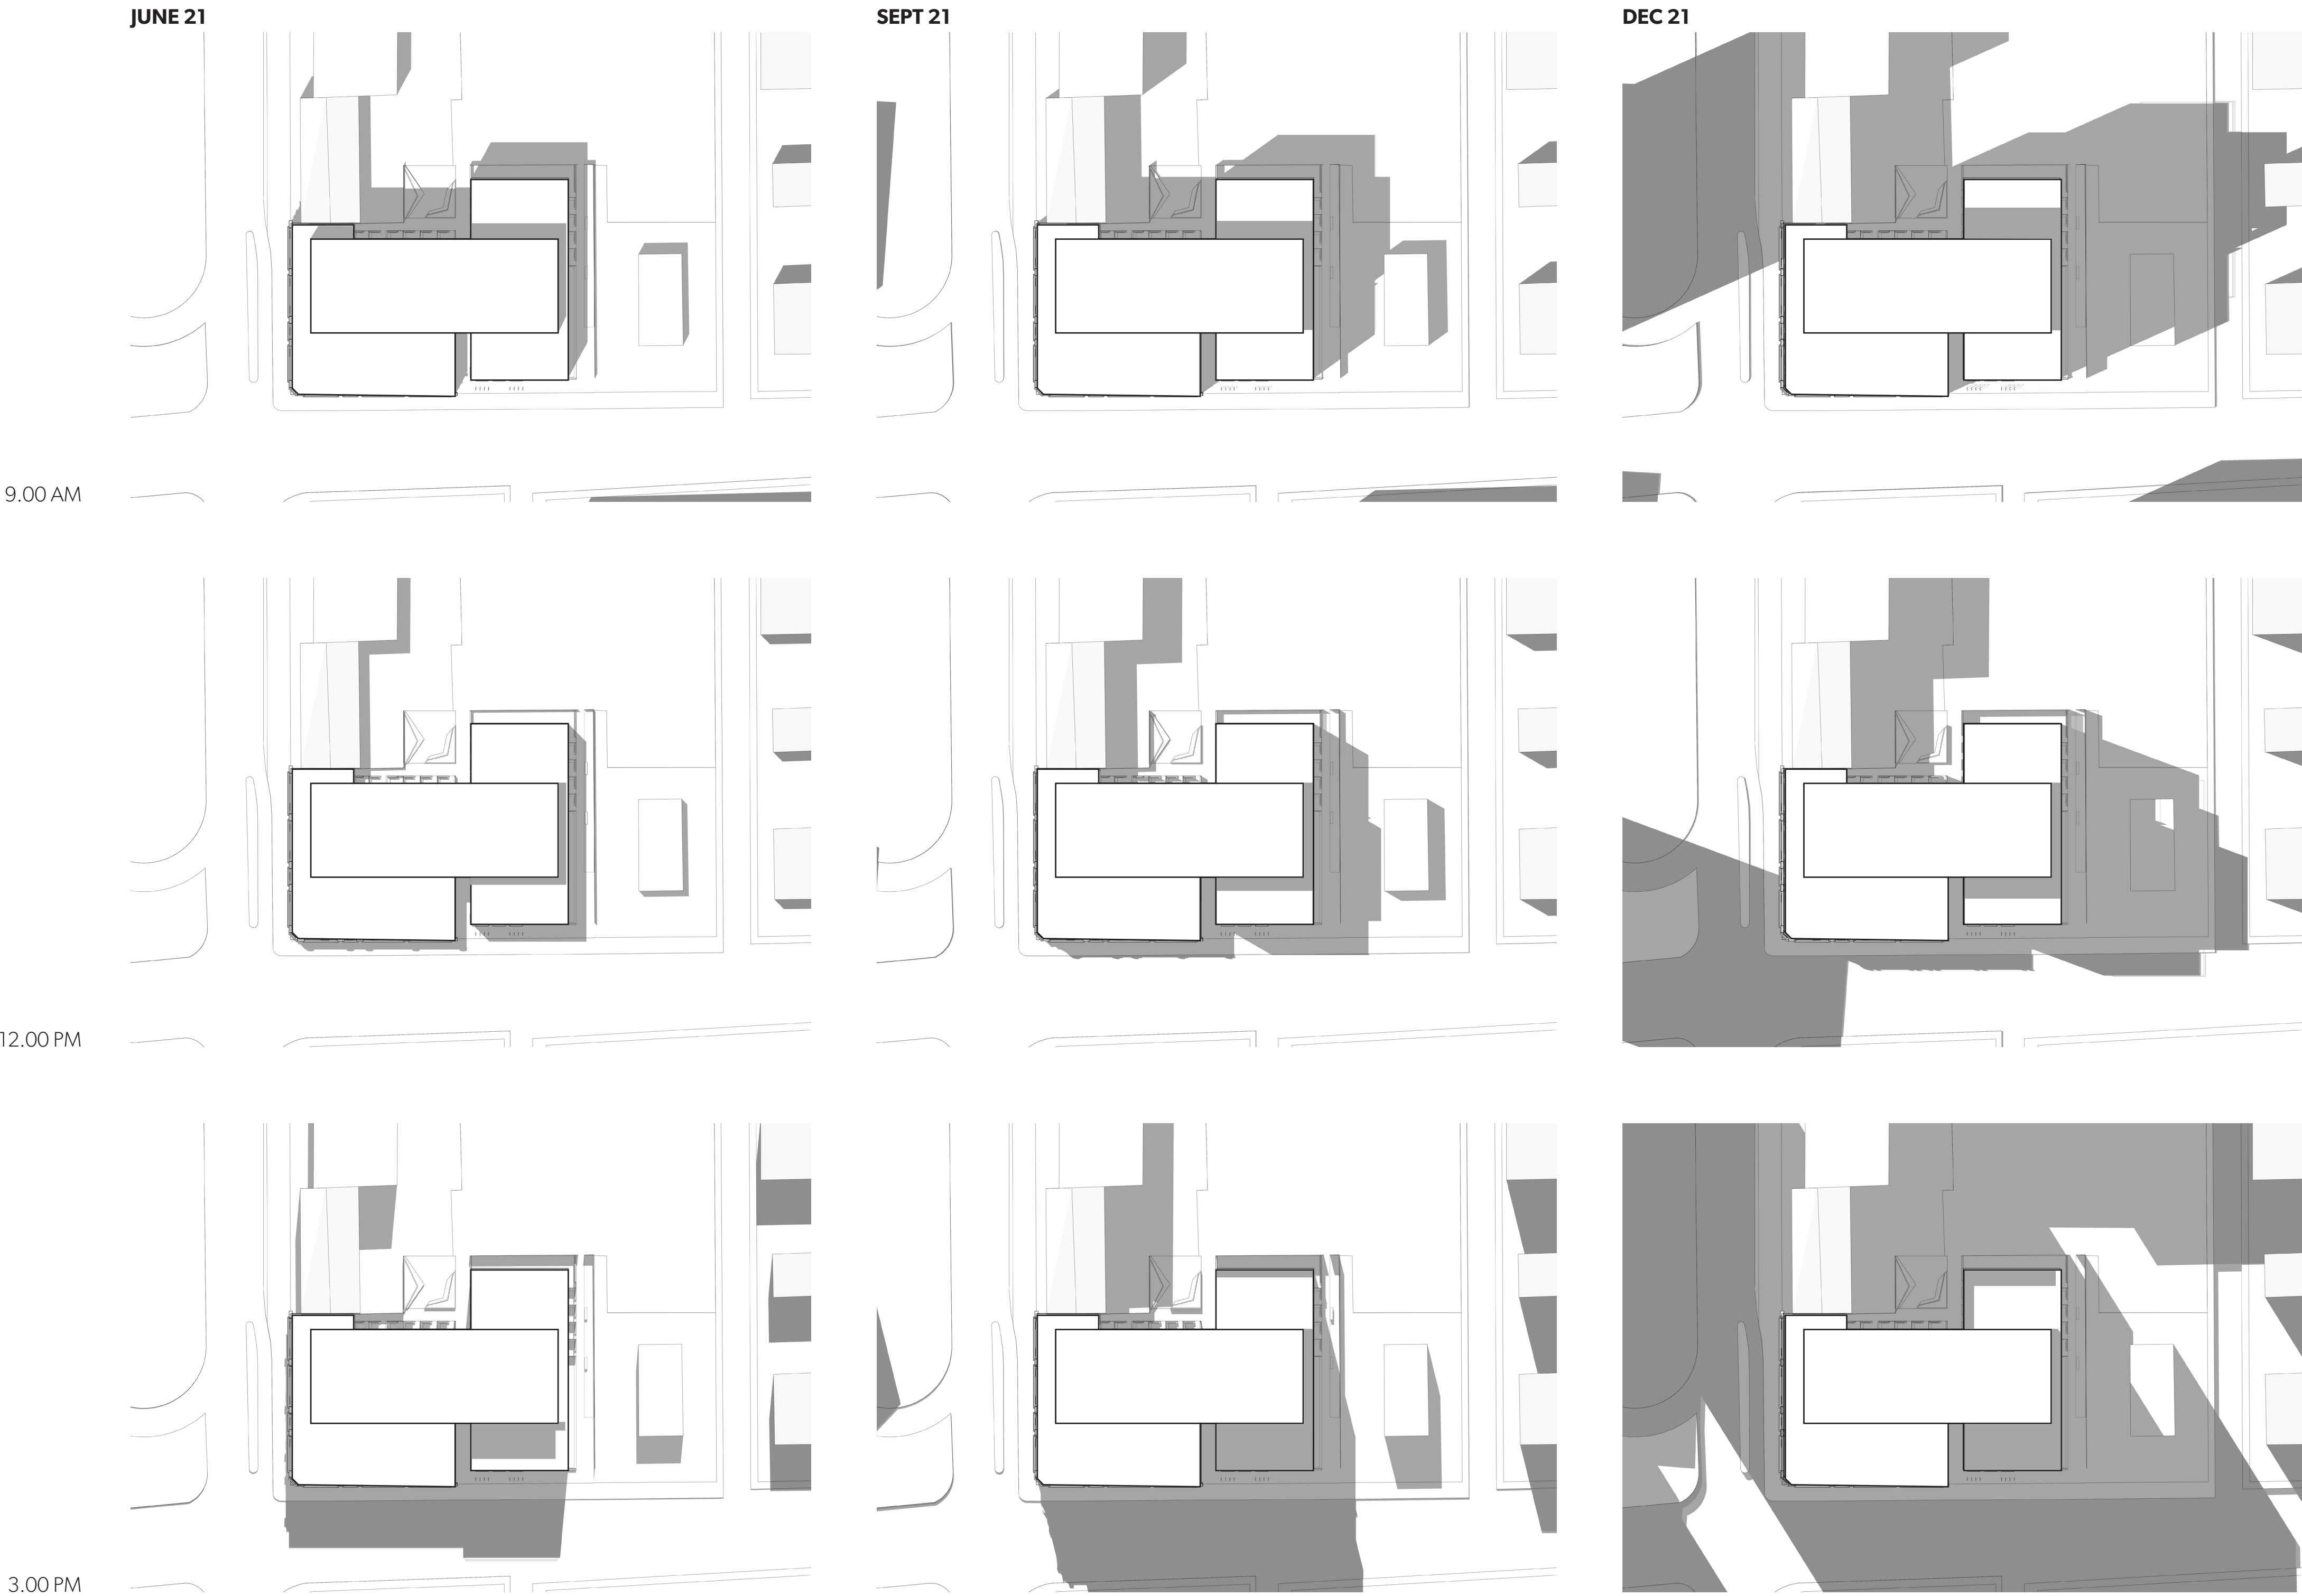


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2019-09-13	1	REVISED FOR REZONING
2019-05-15	0	ISSUED FOR REZONING


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PARKWAY


1050 PANDORA AVE + 1518 COOK STREET
VICTORIA, BC
2018-001

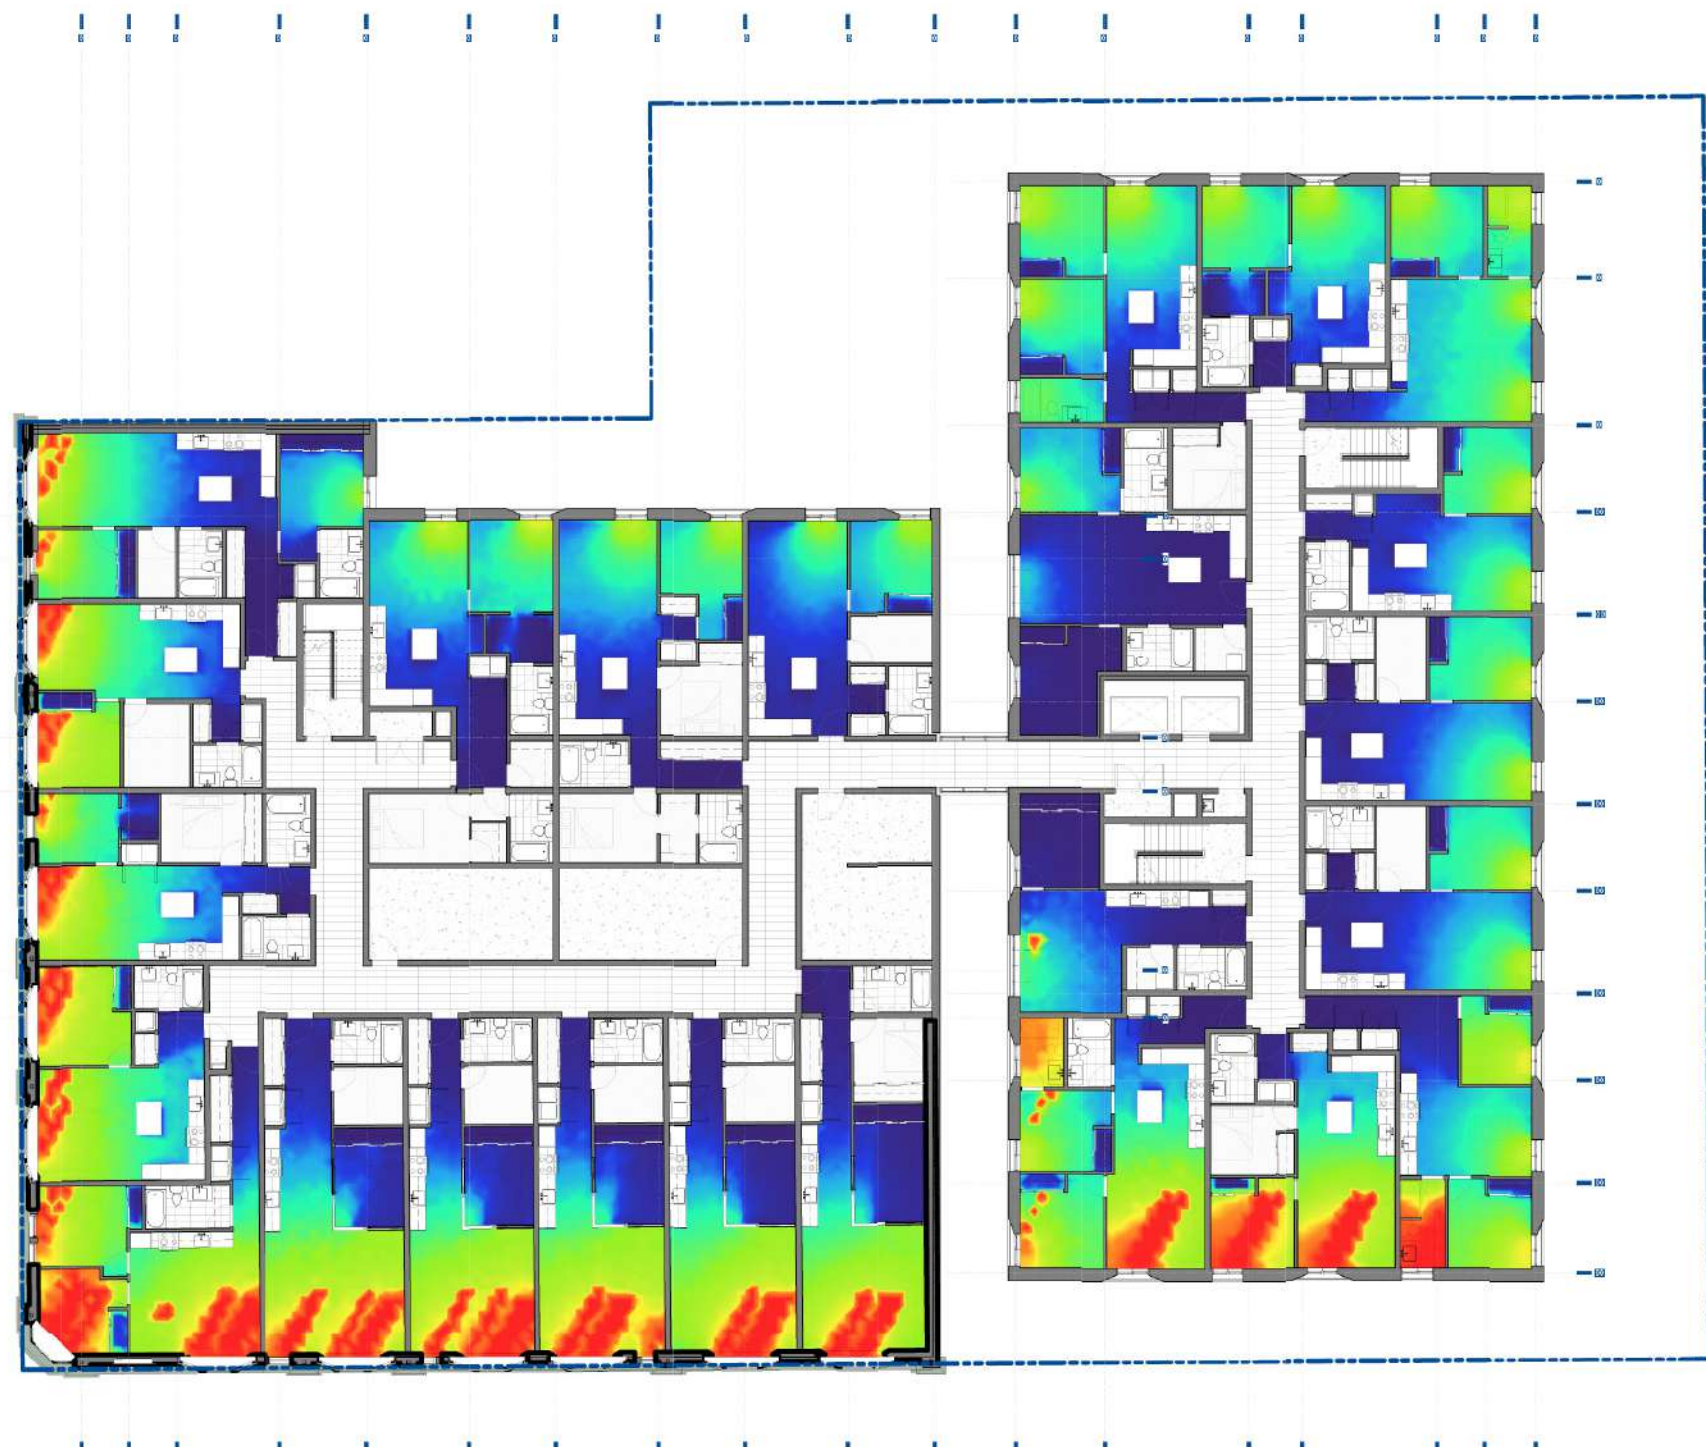


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A822

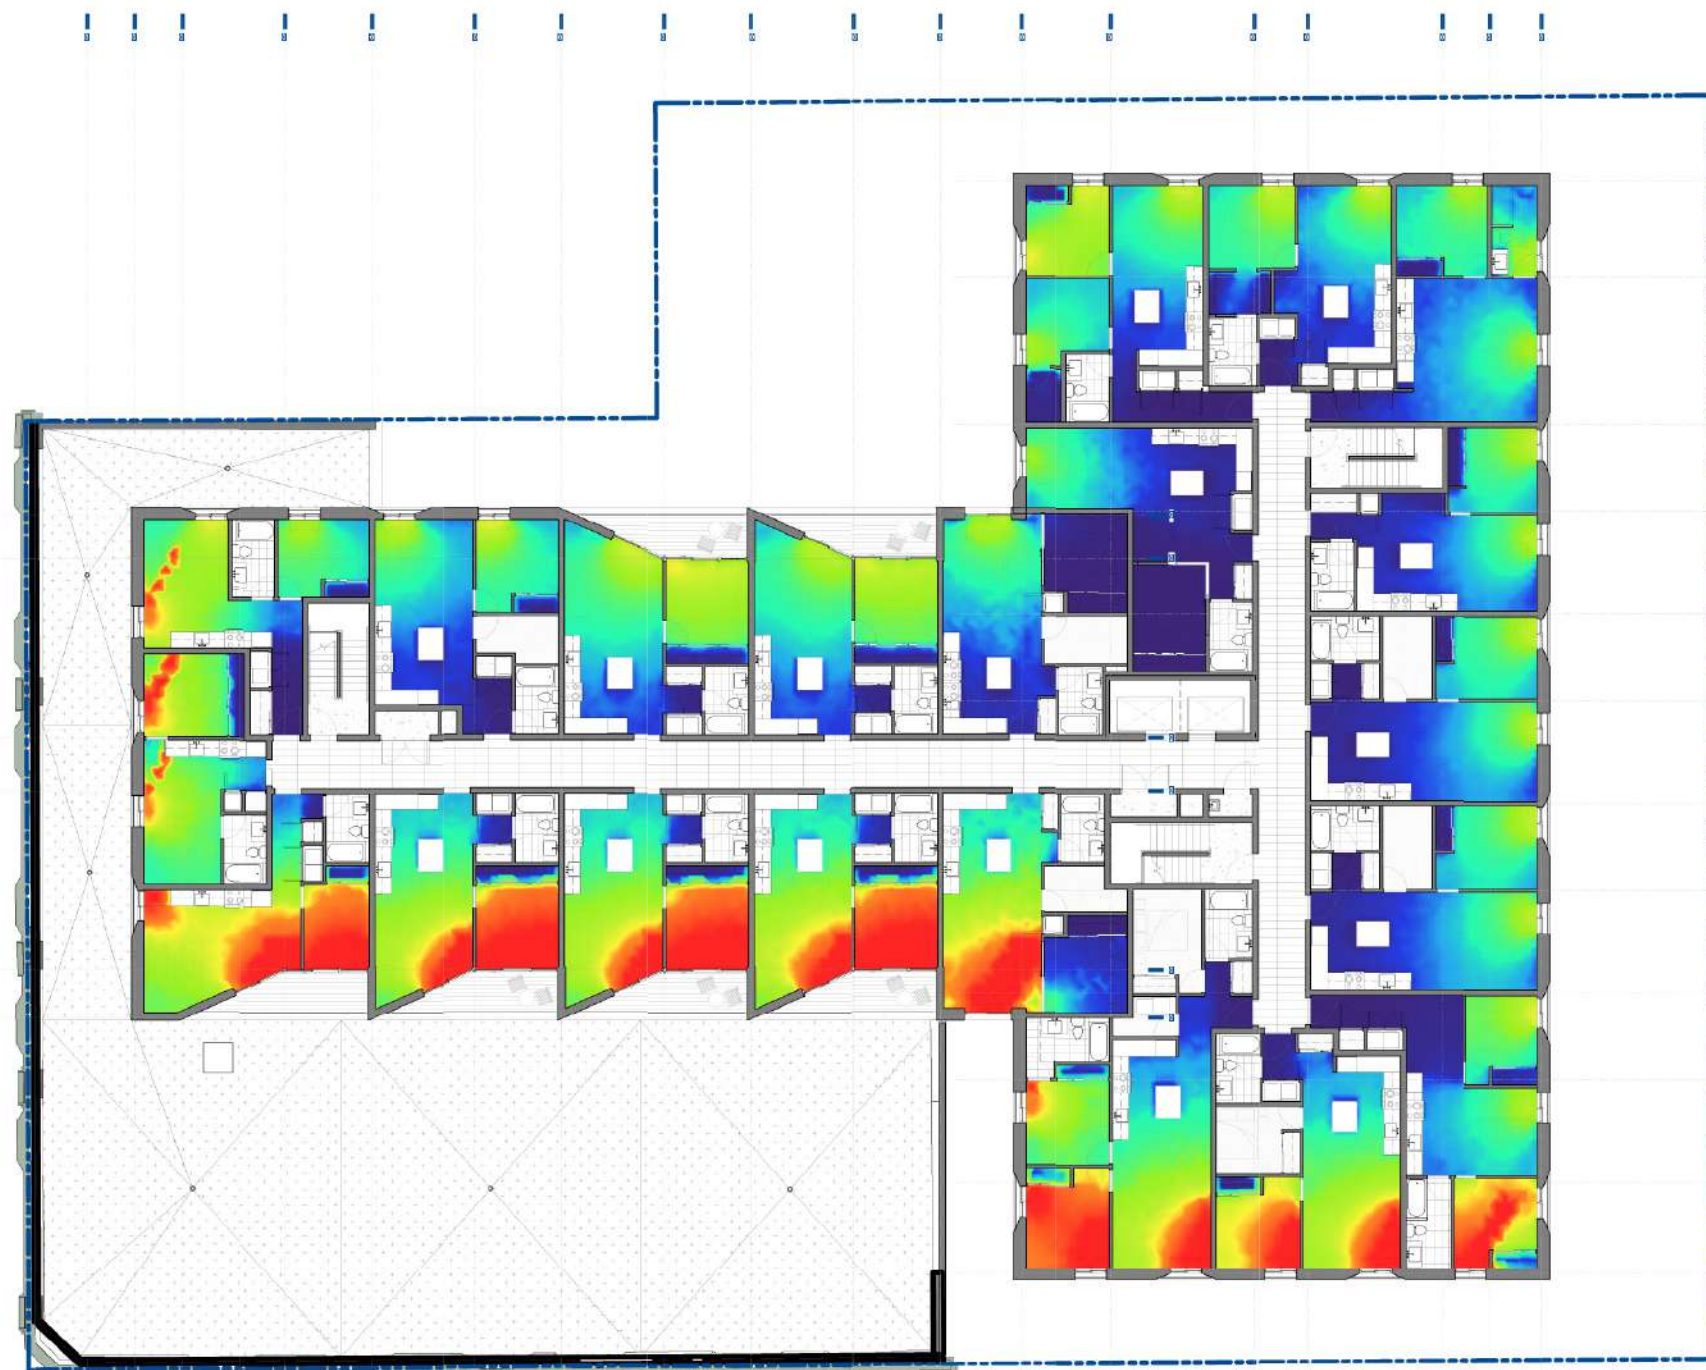


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A822

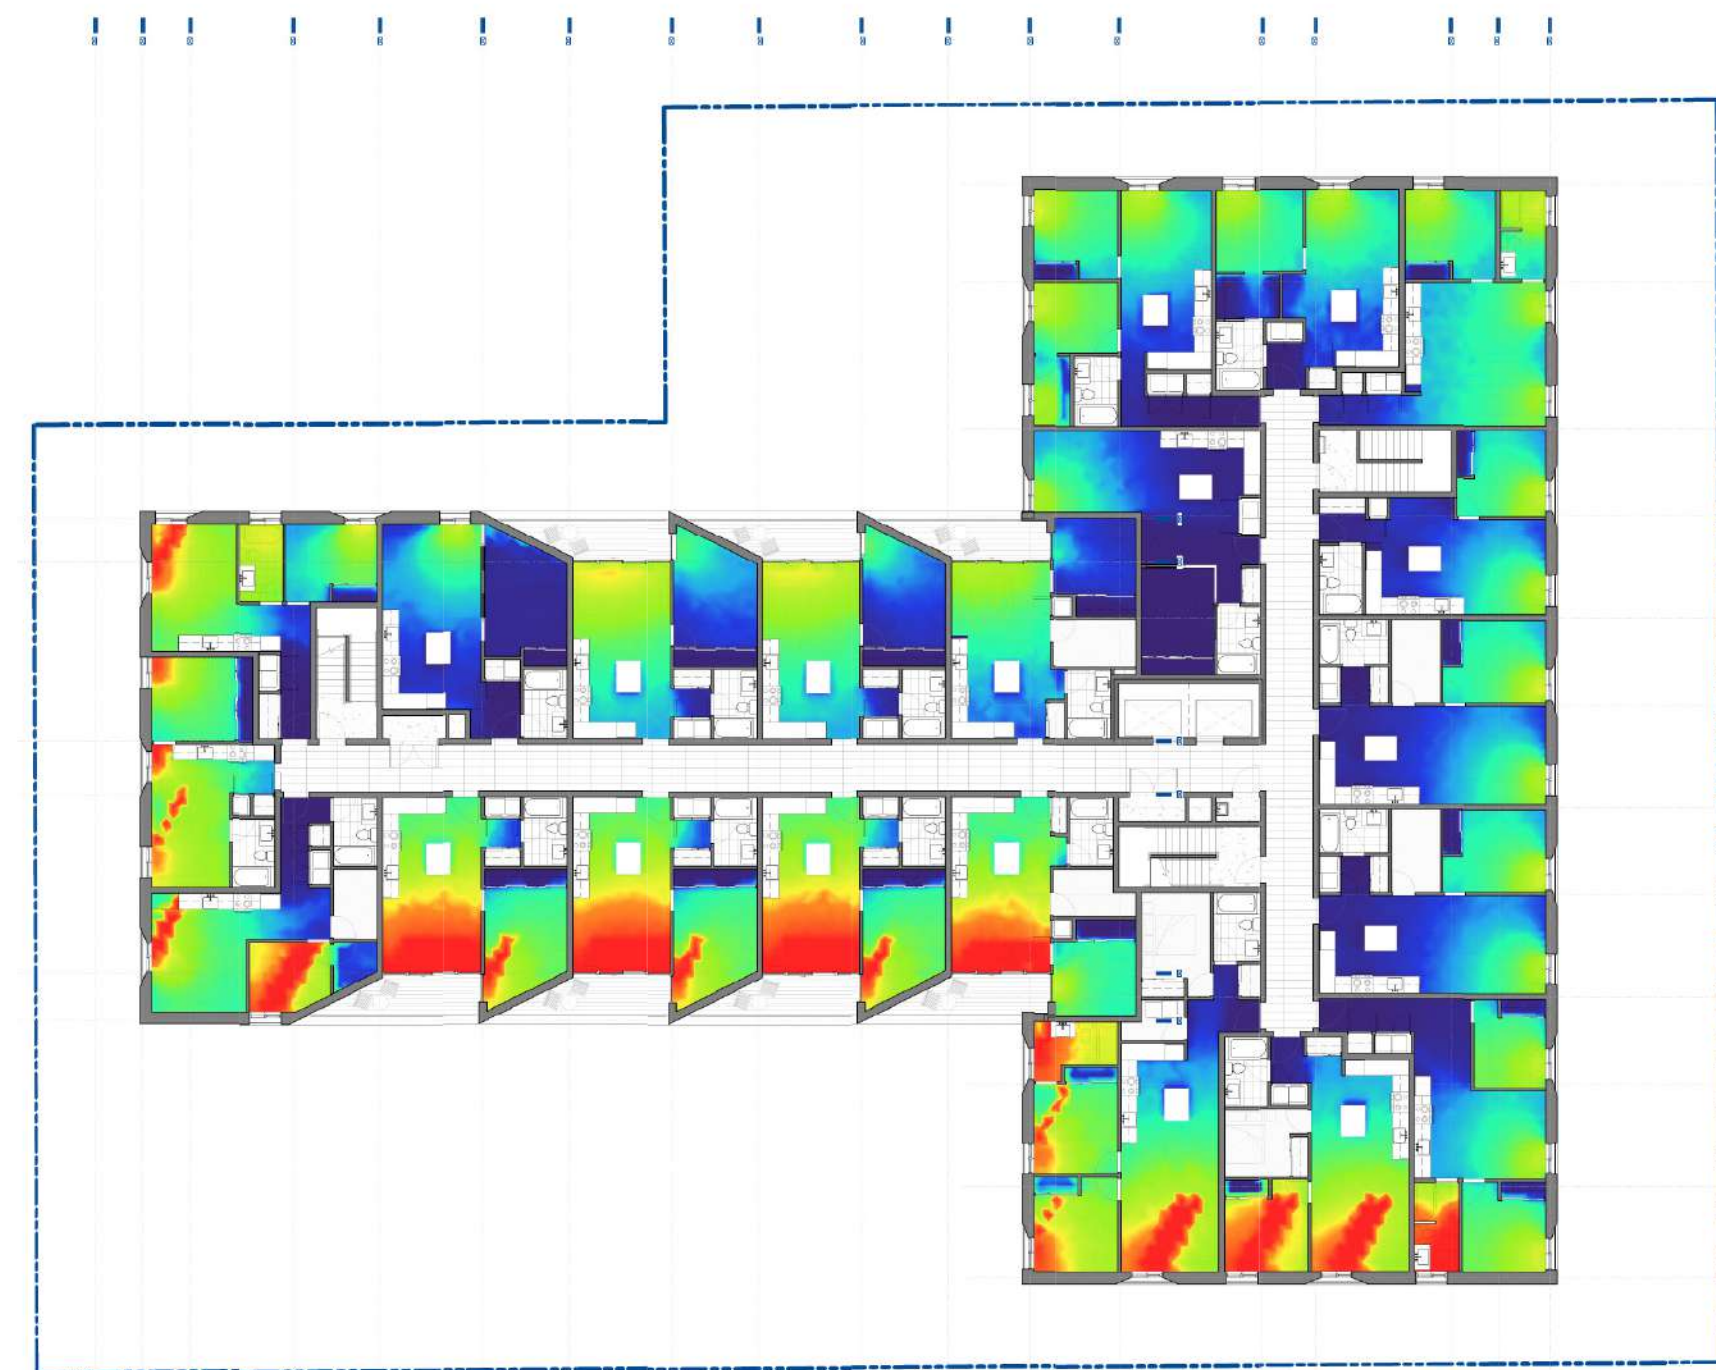


5 LEVEL 4, 9:00 AM, 34.83 (LUX)
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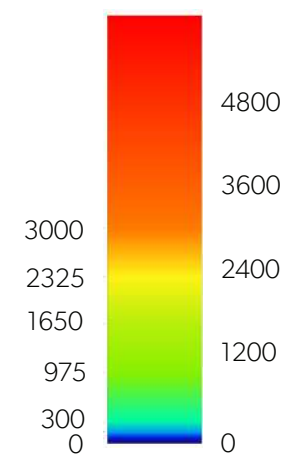
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A822

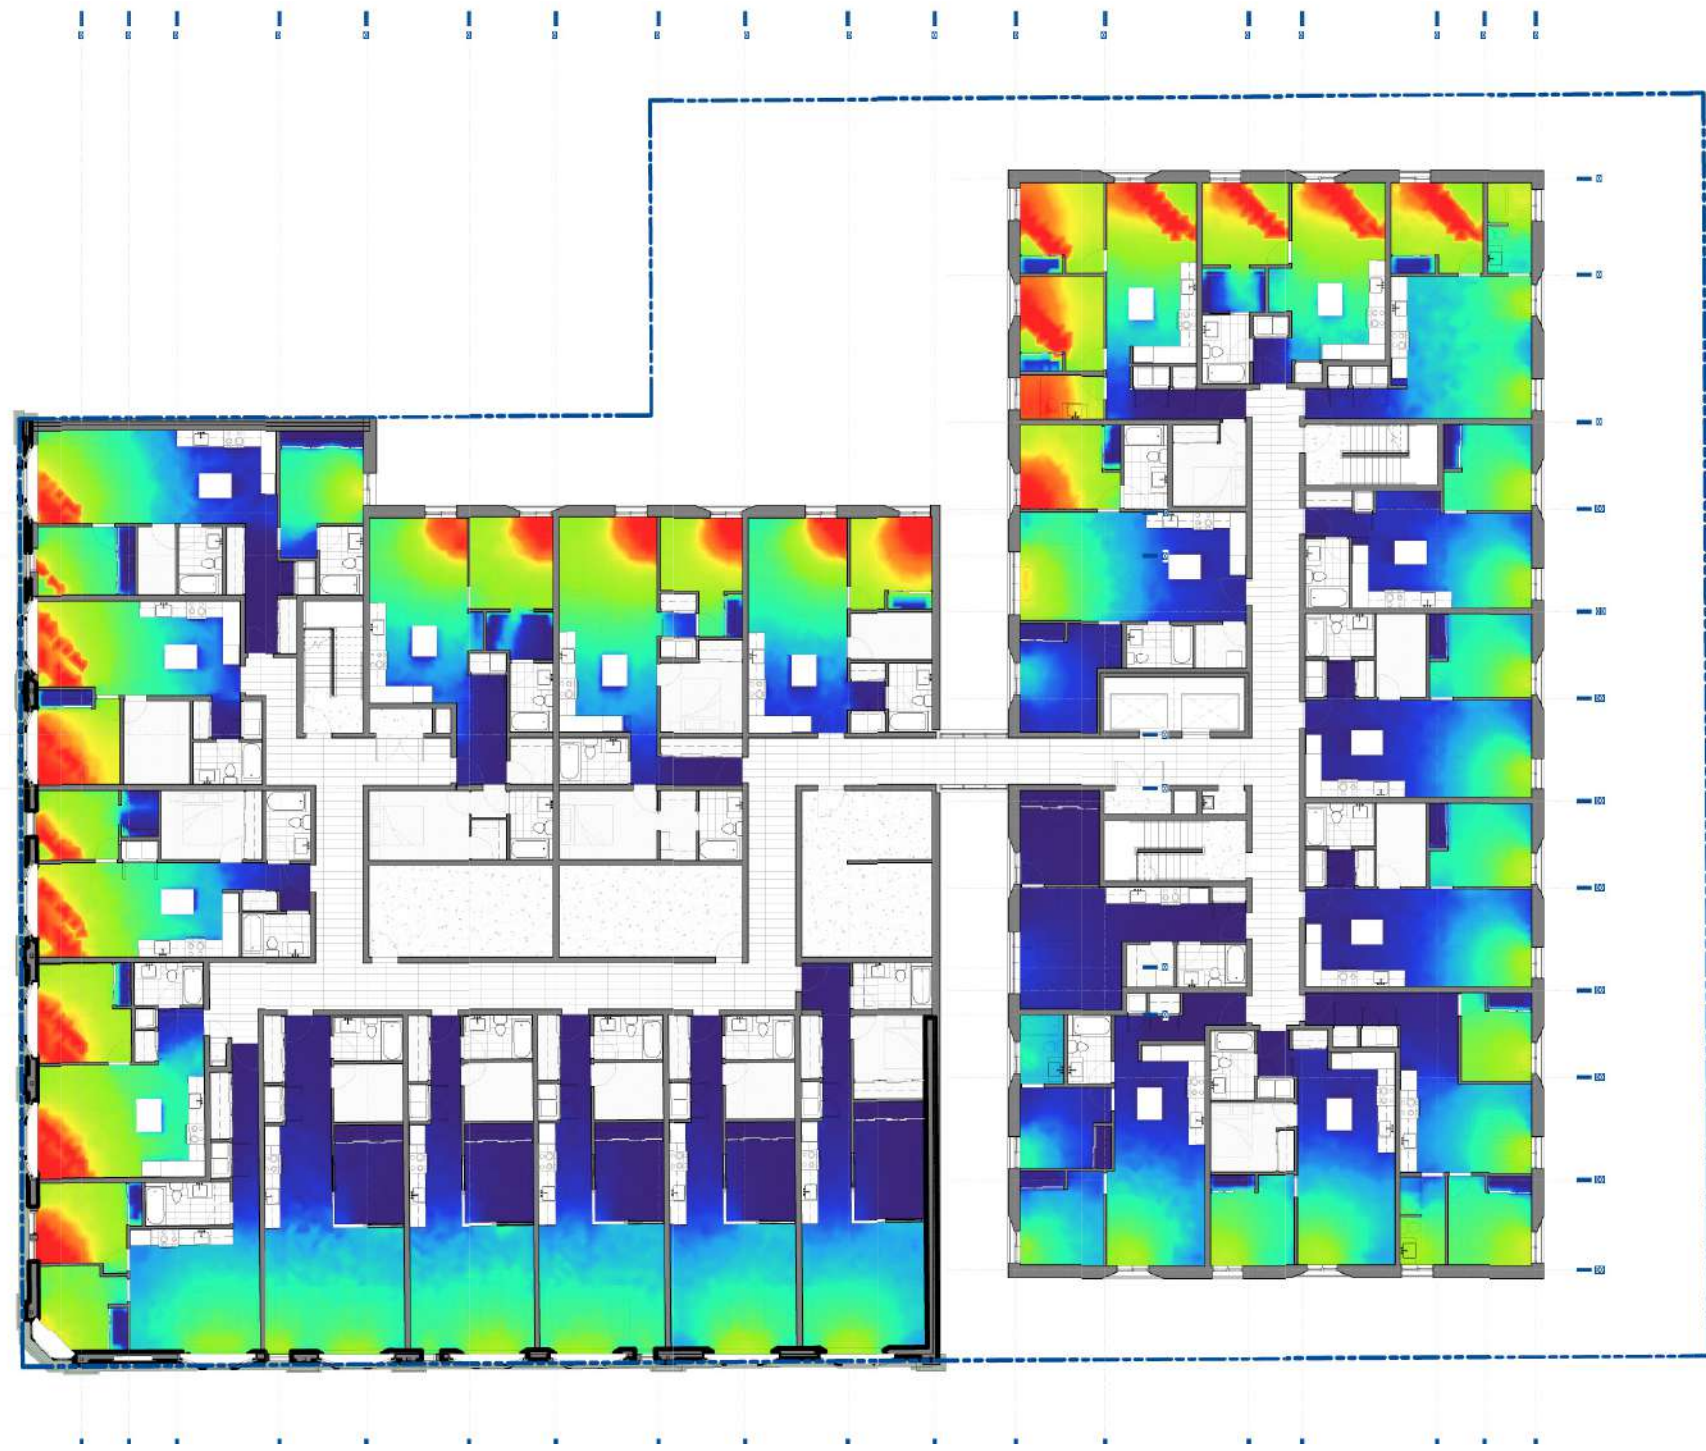


4 LEVEL 3, 3:00 PM, 24.67 (LUX)
A822

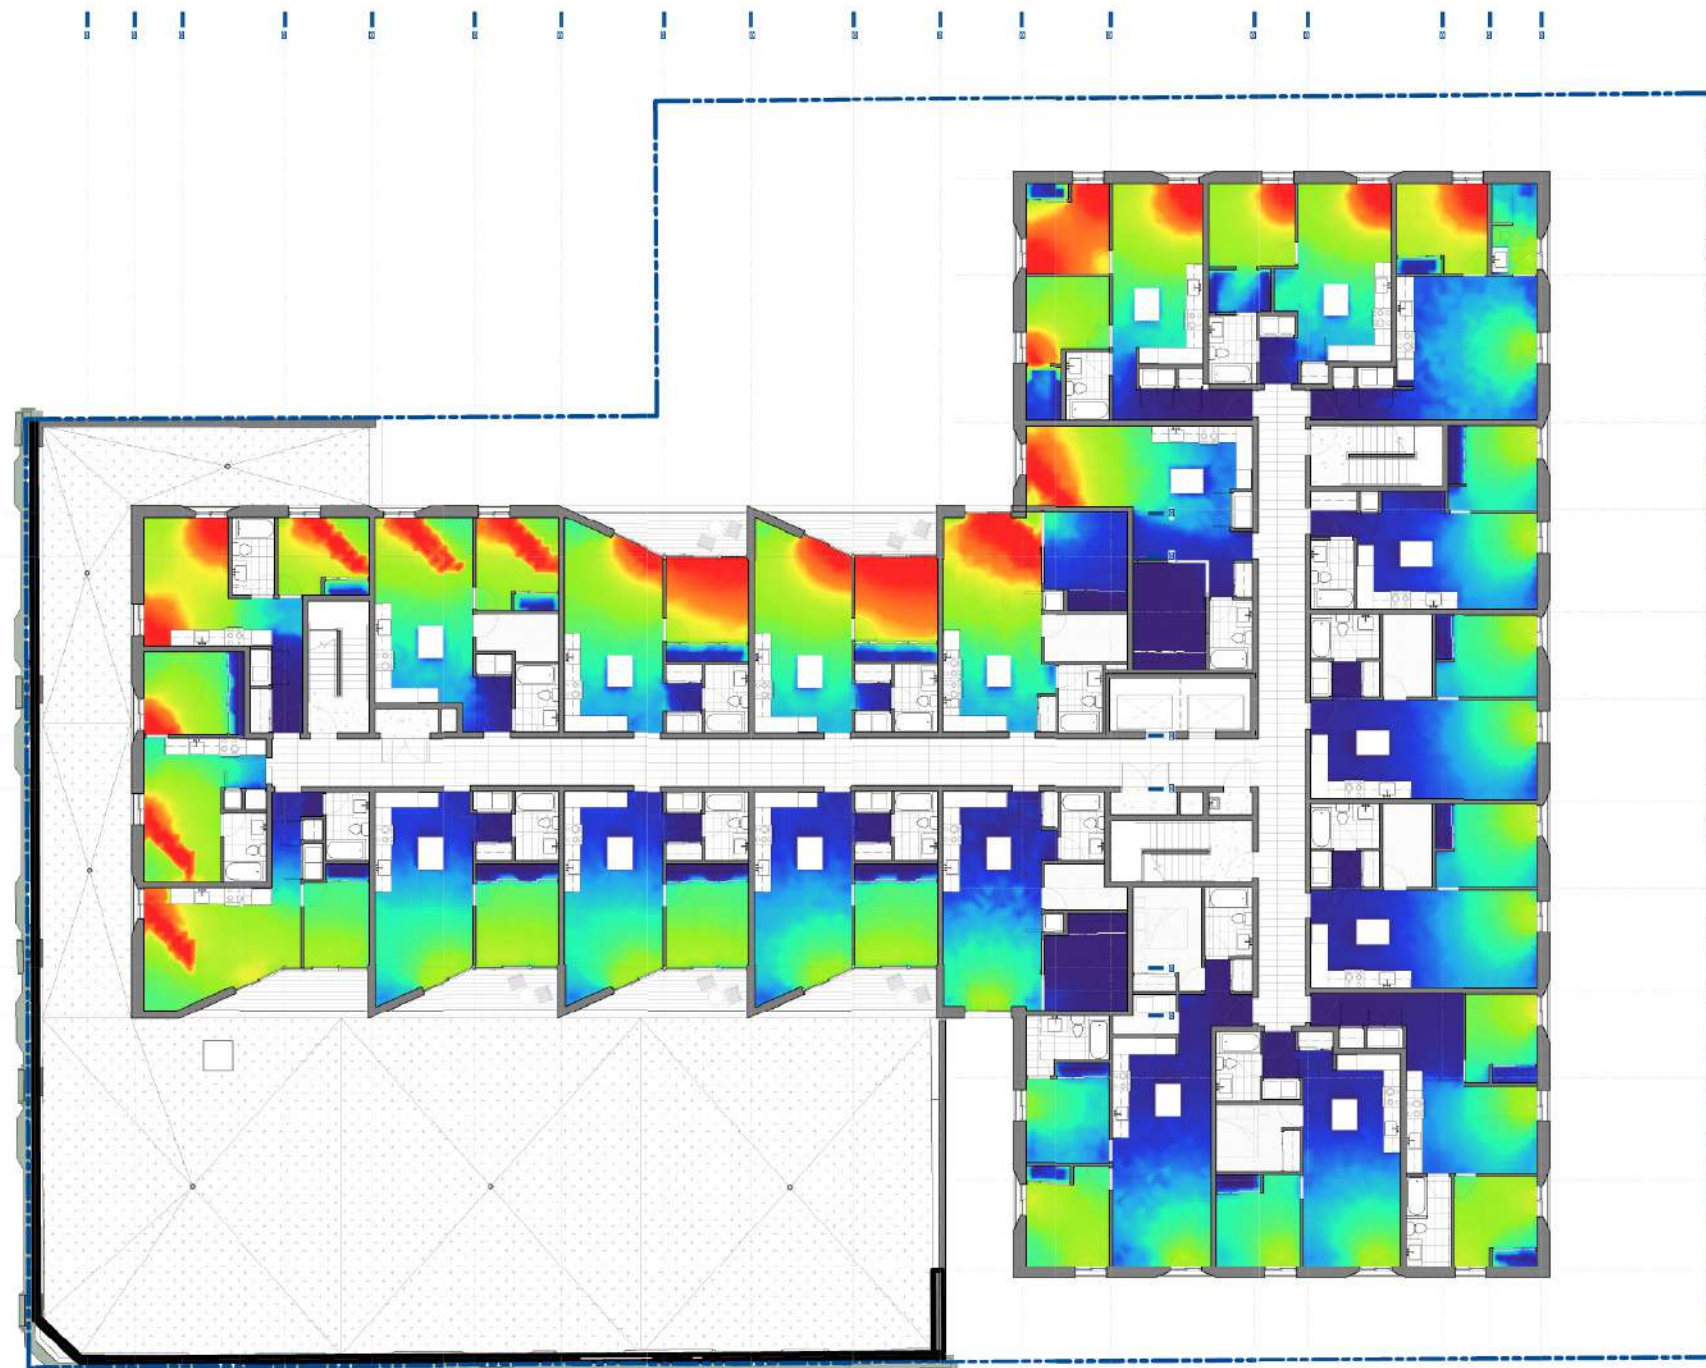

6 LEVEL 4, 3:00 PM, 34.83 (LUX)
A822

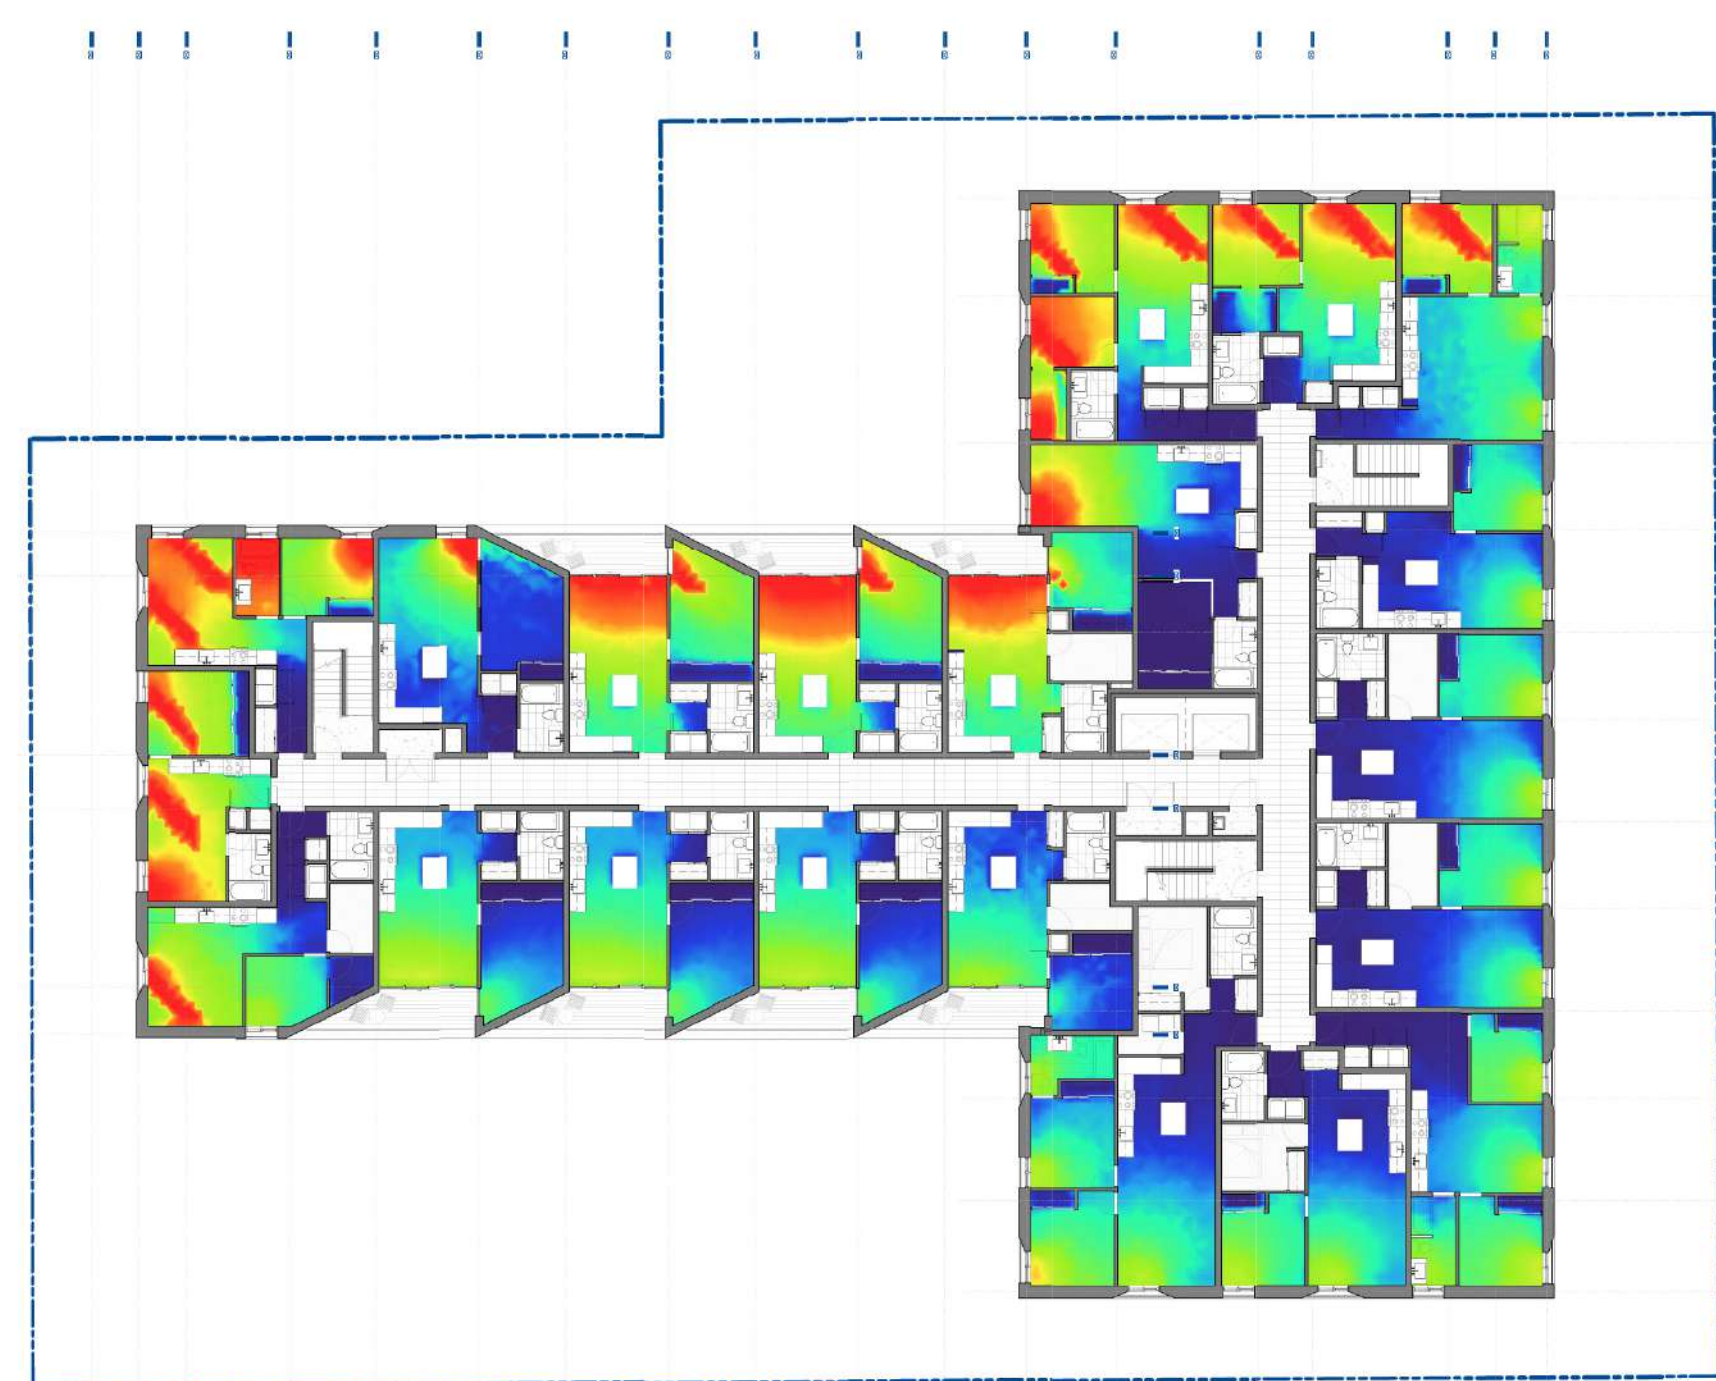

MICHAEL GREEN ARCHITECTURE
1535 W 3RD AVENUE, VANCOUVER BC
CANADA V6J 1J8

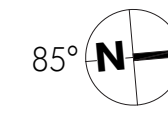


2020-03-20	3	REVISED FOR REZONING
2019-10-30	2	REVISED FOR REZONING
2019-09-13	1	REVISED FOR REZONING
2019-05-15	0	ISSUED FOR REZONING

DATE REVISION DESCRIPTION

PARKWAY

1050 PANDORA AVE + 1518 COOK STREET
VICTORIA, BC
2018-001

A822
Illuminance Analysis

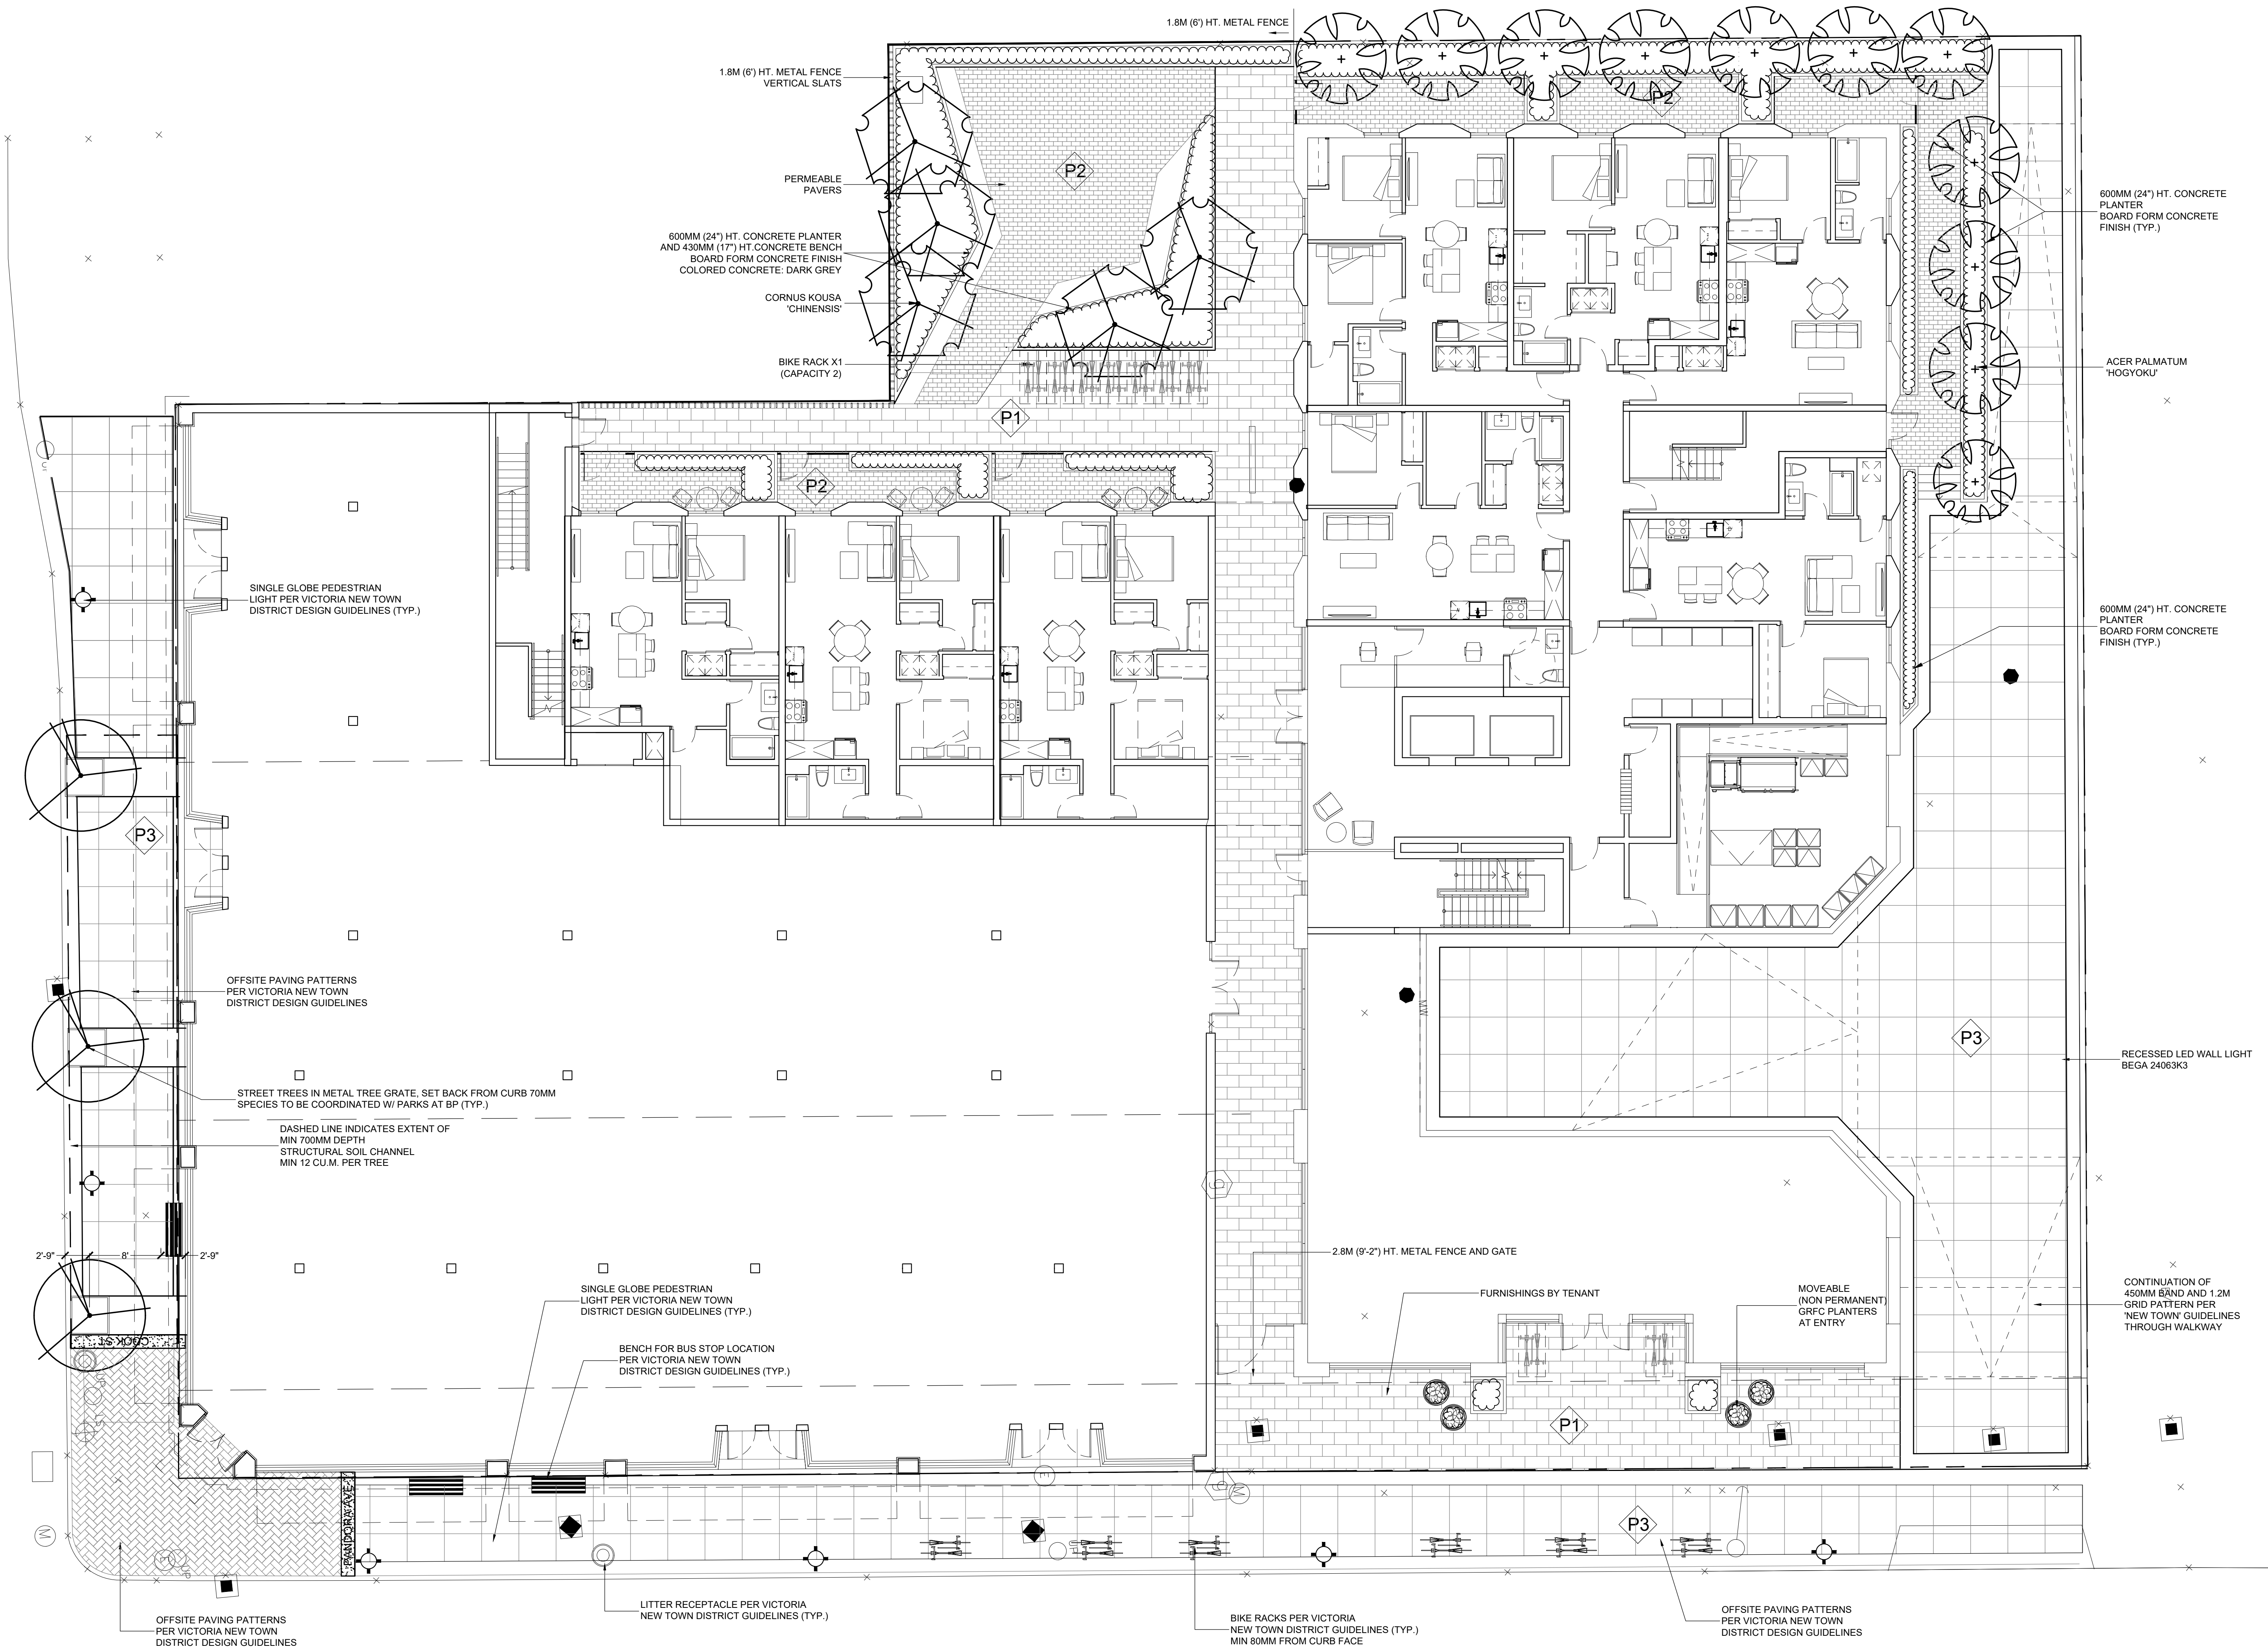


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ARCHITECTS

Suite C100 - 4185 Still Creek Drive
Burnaby, British Columbia, V5C 6G9
p: 604 294-0011 ; f: 604 294-0022

SEAL:

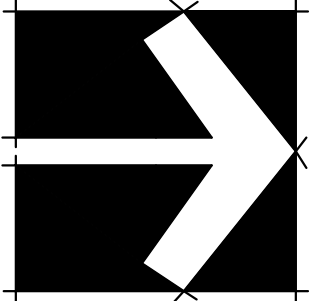

NO.	DATE	REVISION DESCRIPTION	DR.
10	20.MAR.13	REV. PER COV COMMENTS	BA
9	19.NOV.28	100% BP SET	BA
8	19.NOV.04	90% CO SET	BA
7	19.OCT.23	NEW GROUND FLOOR PLAN	DD
6	19.OCT.22	REVISION	DD
5	19.OCT.21	NEW SITE PLAN&CLIENT REQUEST	DD
3	19.OCT.03	60% CO SET	BA
2	19.SEP.27	REZONING	BA
1	21.AUG.19	REV. PER CITY/CLIENT COMMENTS	BA
-	19.JUL.29	30% BP SUBMISSION	BA

NO. DATE REVISION DESCRIPTION DR.

CLIENT:

PROJECT:

**PARKWAY
MIXED USE DEVELOPMENT**

**1050 PANDORA AVENUE
VICTORIA, BC**

DRAWING TITLE:

**LANDSCAPE
PLAN**

DATE: 19 JUL 2019 DRAWING NUMBER:

SCALE: 1:100

DRAWN: BA

DESIGN: BA

CHK'D:


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OF 9

18240-11.ZIP

PMG PROJECT NUMBER:

18240



BRITISH COLUMBIA SOCIETY OF
REGISTERED
MEMBER
MARY CHEN YIP
1977
LANDSCAPE ARCHITECTS

CLIENT:


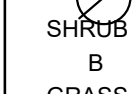
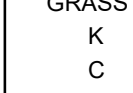
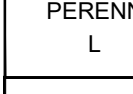
050 PANDORA AVENUE
VICTORIA, BC

SHRUB PLAN





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F 9

8240

PLANT SCHEDULE				PMG PROJECT NUMBER: 18240
KEY	QTY	BOTANICAL NAME	COMMON NAME	PLANTED SIZE / REMARKS
TREE				
	11	ACER PALMATUM 'HOGYOKU'	JEWEL JAPANESE MAPLE	3M HT; B&B; UPRIGHT FORM
	5	CORNUS KOUSA 'CHINENSIS'	CHINESE KOUSA DOGWOOD	3M HT; TREE FORM; B&B
	9	STREET TREE	COORDINATE WITH PARKS DEPT	-
SHRUB				
	91	BUXUS MICROPHYLLA KOREANA	KOREAN BOXWOOD	#3 POT; 40CM
GRASS				
	39	CALAMAGROSTIS ACUTIFLORA 'KARL FOERSTER'	FEATHER REED GRASS	#1 POT
	239	CAREX OSHIMENSIS	JAPANESE SEDGE	#1 POT
PERENNIAL				
	85	LAVENDULA ANGUSTIFOLIA 'MUNSTEAD'	ENGLISH LAVENDER; COMPACT; VIOLET-BLUE	#2 POT
NOTES: * PLANT SIZES IN THIS LIST ARE SPECIFIED ACCORDING TO THE BC LANDSCAPE STANDARD AND CANADIAN LANDSCAPE STANDARD, LATEST EDITION. CONTAINER SIZES SPECIFIED AS PER CNLA STANDARD. BOTH PLANT SIZE AND CONTAINER SIZE ARE THE MINIMUM ACCEPTABLE SIZES. * REFER TO SPECIFICATIONS FOR DEFINED CONTAINER MEASUREMENTS AND OTHER PLANT MATERIAL REQUIREMENTS. * SEARCH AND REVIEW: MAKE PLANT MATERIAL AVAILABLE FOR OPTIONAL REVIEW BY LANDSCAPE ARCHITECT AT SOURCE OF SUPPLY. AREA OF SEARCH TO INCLUDE LOWER MAINLAND AND FRASER VALLEY. * SUBSTITUTIONS: OBTAIN WRITTEN APPROVAL FROM THE LANDSCAPE ARCHITECT PRIOR TO MAKING ANY SUBSTITUTIONS TO THE SPECIFIED MATERIAL. UNAPPROVED SUBSTITUTIONS WILL BE REJECTED. ALLOW A MINIMUM OF FIVE DAYS PRIOR TO DELIVERY FOR REQUEST TO SUBSTITUTE. SUBSTITUTIONS ARE SUBJECT TO BC LANDSCAPE STANDARD AND CANADIAN LANDSCAPE STANDARD - DEFINITION OF CONDITIONS OF AVAILABILITY. * ALL LANDSCAPE MATERIAL AND WORKMANSHIP MUST MEET OR EXCEED BC LANDSCAPE STANDARD AND CANADIAN LANDSCAPE STANDARD LATEST EDITION. * ALL PLANT MATERIAL MUST BE PROVIDED FROM CERTIFIED DISEASE FREE NURSERY. * BIO-SOLIDS NOT PERMITTED IN GROWING MEDIUM UNLESS AUTHORIZED BY LANDSCAPE ARCHITECT.				

CONTRACTOR TO PROVIDE DESIGN-BUILD HIGH EFFICIENCY IRRIGATION SYSTEM THAT MEETS CURRENT IIABC STANDARDS. DEVELOPER AND/OR LANDSCAPE ARCHITECT TO REVIEW DESIGN PRIOR TO INSTALLATION.

ROOF LANDSCAPE LEGEND	
KEY	DESCRIPTION
	SEDUM TILE - ETERA 'COLOR MAX'
	SEDUM TILE - ETERA 'ALL SEASONS'
	SEDUM TILE - ETERA 'BLUE MIX'
	BASALT GRAVEL - 50MM CLEAR

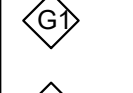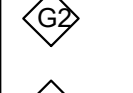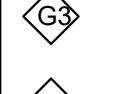


G1 - 'COLOR MAX'



G2 - 'ALL SEASONS'



G3 - 'BLUE MAX'

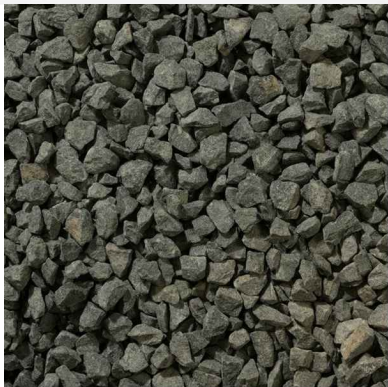




G4 - 50MM CLEAR BASALT GRAVEL



ALUMINUM PLANTER - MEWS AND PATIOS
POWDERCOAT: BLACK

MATERIALS LEGEND

KEY	DESCRIPTION
	BARKMAN BROADWAY PAVER 24X12", COLOR GREY
	EXPOCRETE AQUAROC STANDARD SIZE, PERMEABLE PAVER COLOR GREY
	450MM (18") CONCRETE BAND W/ 1.2M SAWCUT GRID PER VICTORIA NEW TOWN GUIDELINES



P1 - BARKMAN BROADWAY 24X12"



P2 - EXPOCRETE AQUAROC PERMEABLE PAVER



CALAMAGROSTIS ACUTIFLORA
'KARL FOERSTER'



BUXUS M. KOREANA



CAREX OSHIMENSIS



LAVENDULA 'MUNSTEAD'



CALAMAGROSTIS BRACHYTRICHA




ACER PALMATUM 'HOGYOKU'



CORNUS K. CHINESIS



ACER GINNALA

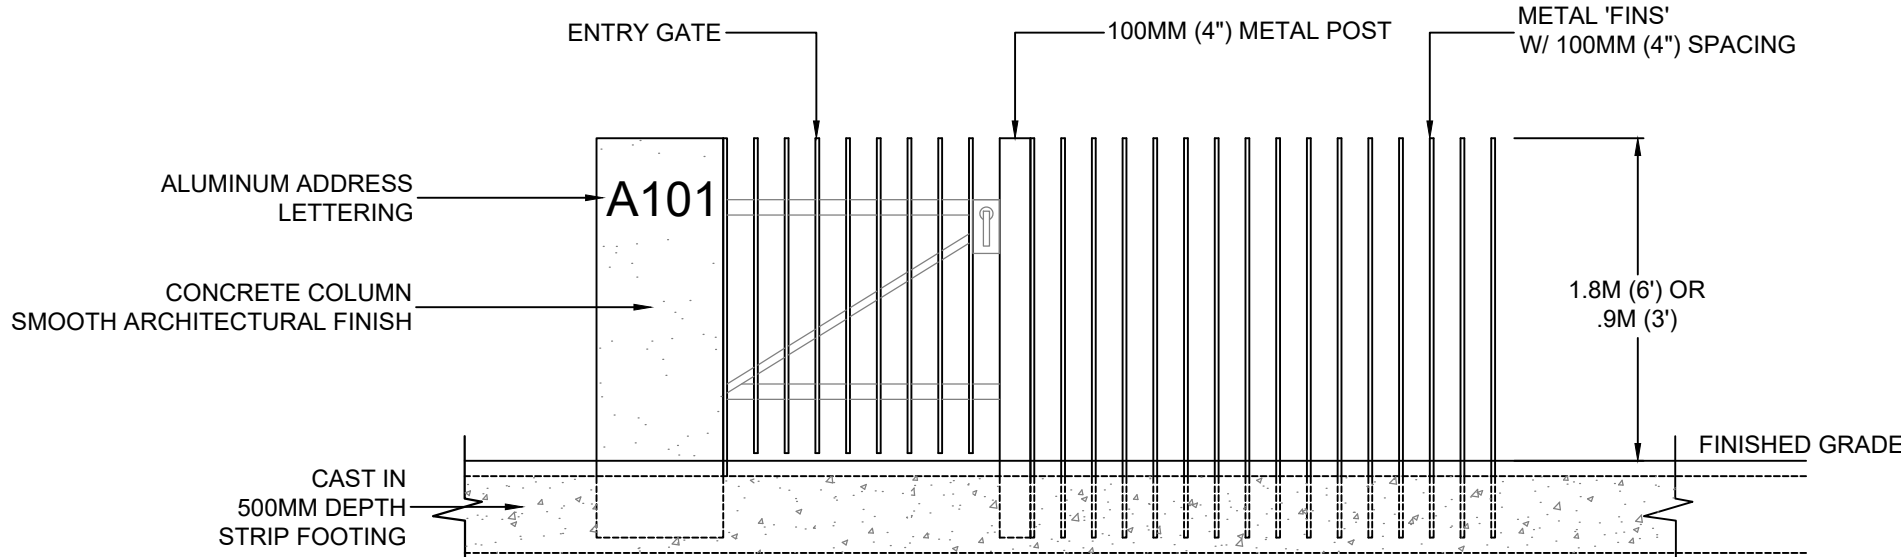

1.8M and .9M HT. VERTICAL SLAT FENCE AND GATE
1:25




1.8M (6') HT. PERIMETER FENCE AND 1.07M (42\") HT. PATIO GATES

Preparation notes:

1. Container grown: remove completely from container.
2. Burlap and rope: remove top 1/3 of covering
3. Wire and Burlap: remove top 1/3 of wire and burlap covering without damaging rootball. Remove all twine.
4. Do not prune leader, only dead or damaged branches.

NOTE: ALL TREES SHALL MEET OR EXCEED THE CITY OF VICTORIA (COV) SCHEDULE C SPECIFICATIONS

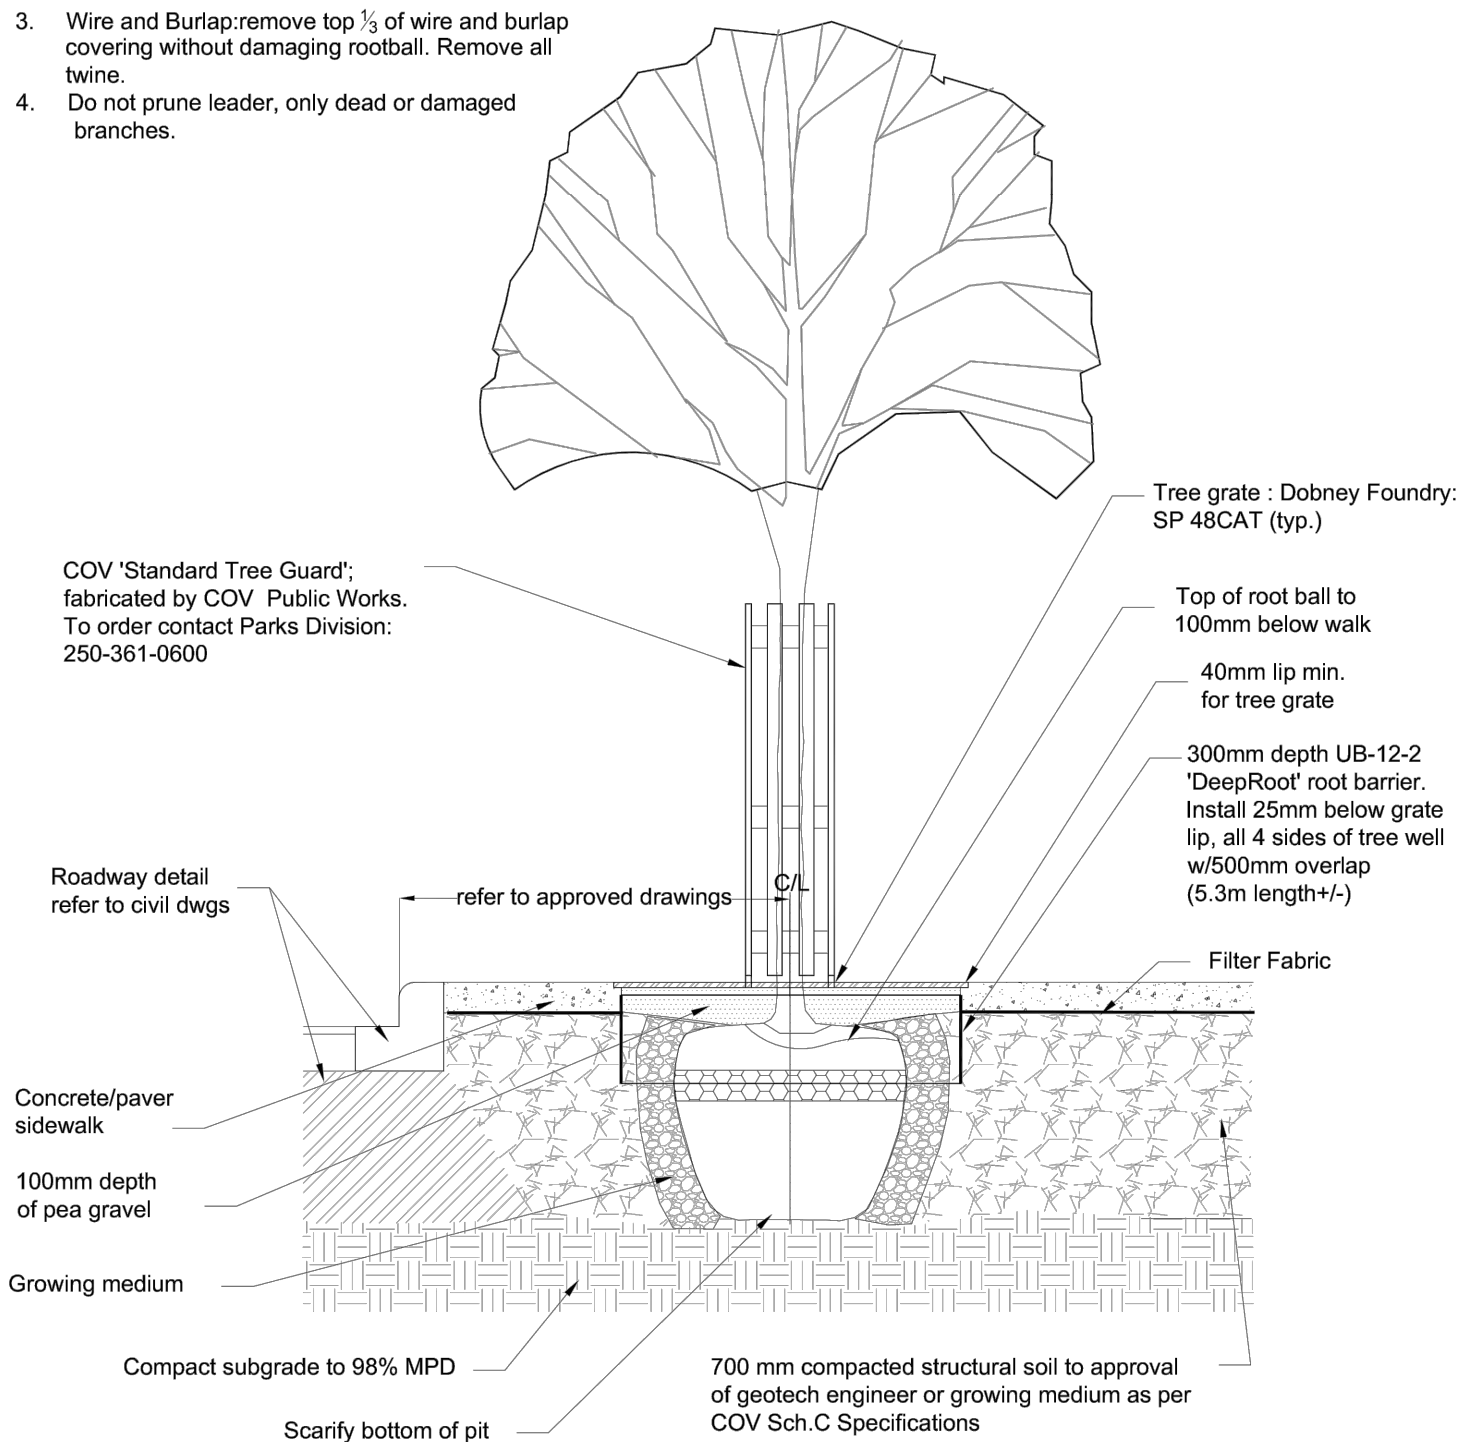

VICTORIA Parks Division

File: v:\design\construct_design_specs\correl_details\PS00\SD_P5

TITLE:	SCALE: Not to Scale	DRAWING
Tree Planting in Sidewalk with Tree Guard	DATE: Feb.27, 2018	SD-P5
	DWN.:	
	APP'D.:	

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Suite C100 - 4185 Still Creek Drive
Burnaby, British Columbia, V5C 6G9
p: 604 294-0011 ; f: 604 294-0022

SEAL:



10	20.MAR.13	REV. PER COV COMMENTS	BA
9	19.NOV.28	100% BP SET	BA
8	19.NOV.04	90% CO SET	BA
7	19.OCT.23	NEW GROUND FLOOR PLAN	DD
6	19.OCT.22	REVISION	DD
5	19.OCT.21	NEW SITE PLAN&CLIENT REQUEST	DD
3	19.OCT.03	60% CO SET	BA
2	19.SEP.27	REZONING	BA
1	21.AUG.19	REV. PER CITY/CLIENT COMMENTS	BA
-	19.JUL.29	30% BP SUBMISSION	BA

NO. DATE REVISION DESCRIPTION DR.

CLIENT:

PROJECT:

**PARKWAY
MIXED USE DEVELOPMENT**

**1050 PANDORA AVENUE
VICTORIA, BC**

DRAWING TITLE:

**LANDSCAPE
DETAILS**

DATE: 19.JUL.10

SCALE: AS SHOWN

DRAWN: BA

DESIGN: BA

CHK'D:


DRAWING NUMBER:

AS SHOWN

BA

BA

OF 9

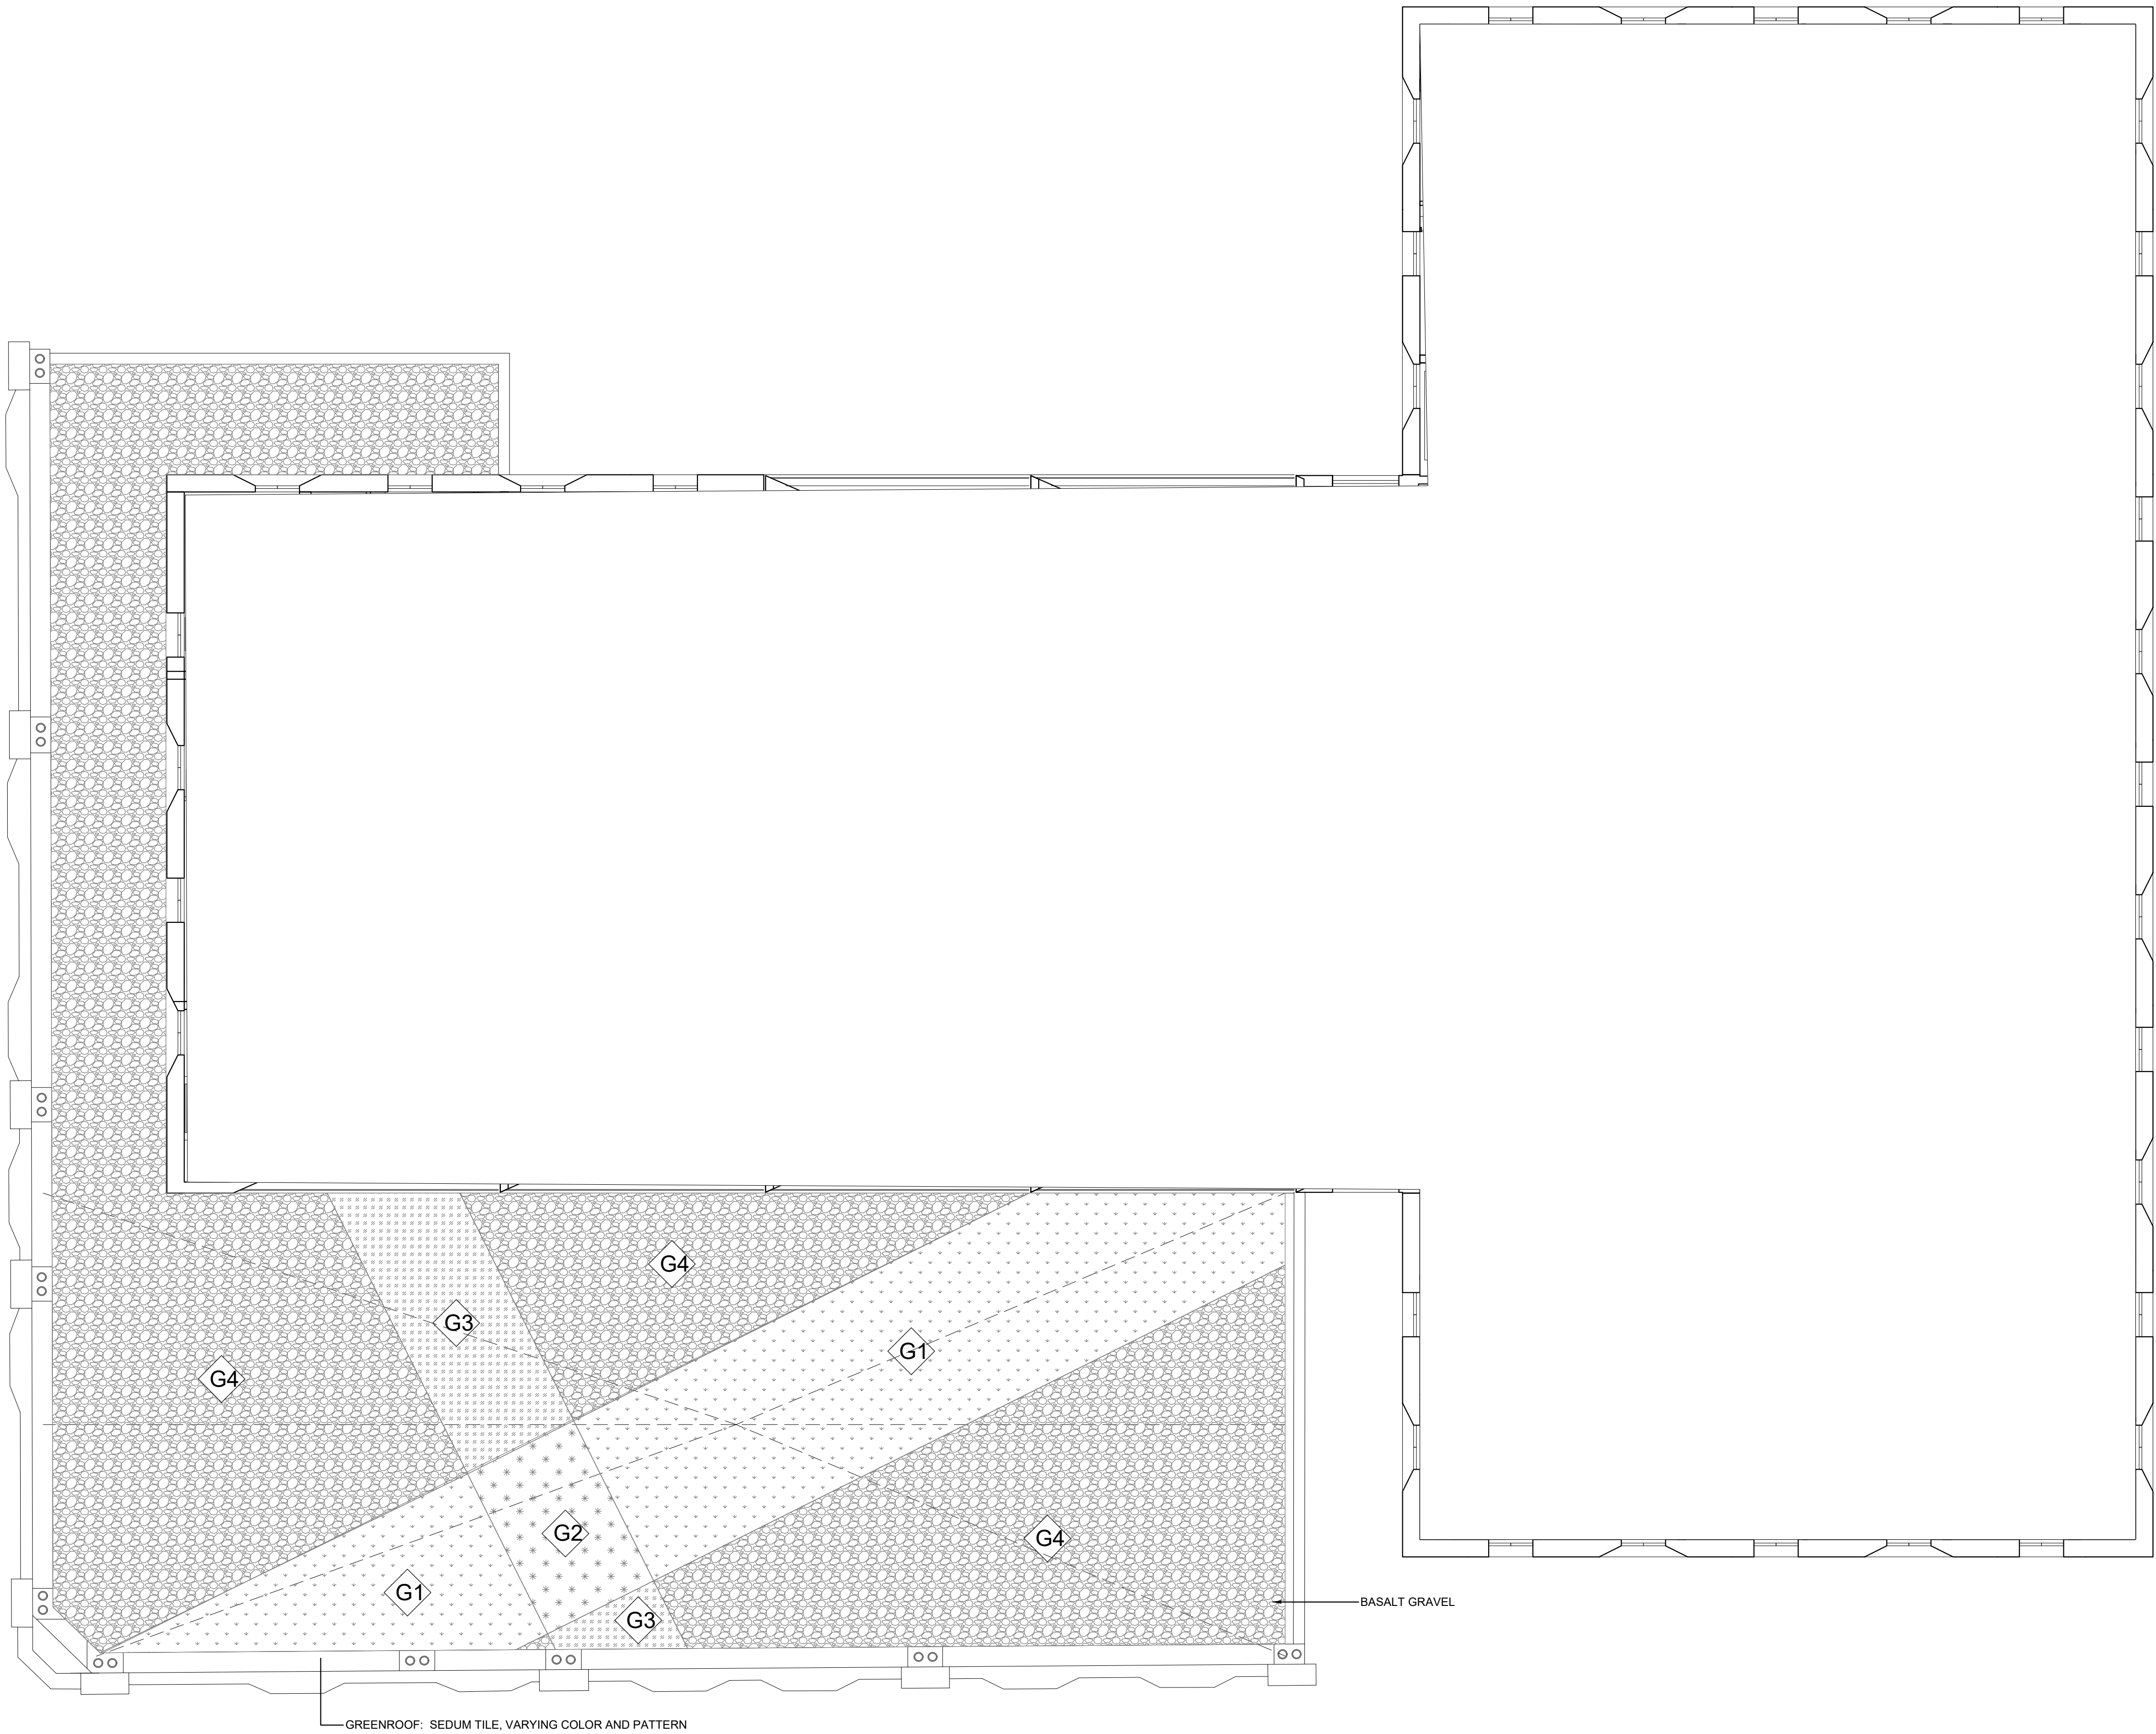

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p: 604 294-0011 ; f: 604 294-0022

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-	19.JUL.29	30% BP SUBMISSION	BA

NO. DATE REVISION DESCRIPTION DR.

CLIENT:

PROJECT:

**PARKWAY
MIXED USE DEVELOPMENT**

**1050 PANDORA AVENUE
VICTORIA, BC**

DRAWING TITLE:

**LEVEL 3
ROOF LANDSCAPE**

DATE: 19.JUL.10 DRAWING NUMBER:
SCALE: 1:100
DRAWN: BA
DESIGN: BA
CHK'D: **L4**
OF 9

SEAL:



10	20.MAR.13	REV. PER COV	COMMENTS	BA
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8	19.NOV.04	90% CO SET		BA
7	19.OCT.23	NEW GROUND FLOOR PLAN		DD
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5	19.OCT.21	NEW SITE PLAN&CLIENT REQUEST		DD
3	19.OCT.03	60% CO SET		BA
2	19.SEP.27	REZONING		BA
1	21.AUG.19	REV. PER CITY/CLIENT COMMENTS		BA
-	19.JUL.29	30% BP SUBMISSION		BA

NO. DATE REVISION DESCRIPTION DR.

CLIENT:

PROJECT:

PARKWAY
MIXED USE DEVELOPMENT

1050 PANDORA AVENUE
VICTORIA, BC

DRAWING TITLE:


LEVEL 5
ROOF LANDSCAPE

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SCALE: 1:100
DRAWN: BA
DESIGN: BA
CHK'D: OF 9

L5

PMG PROJECT NUMBER:


18240

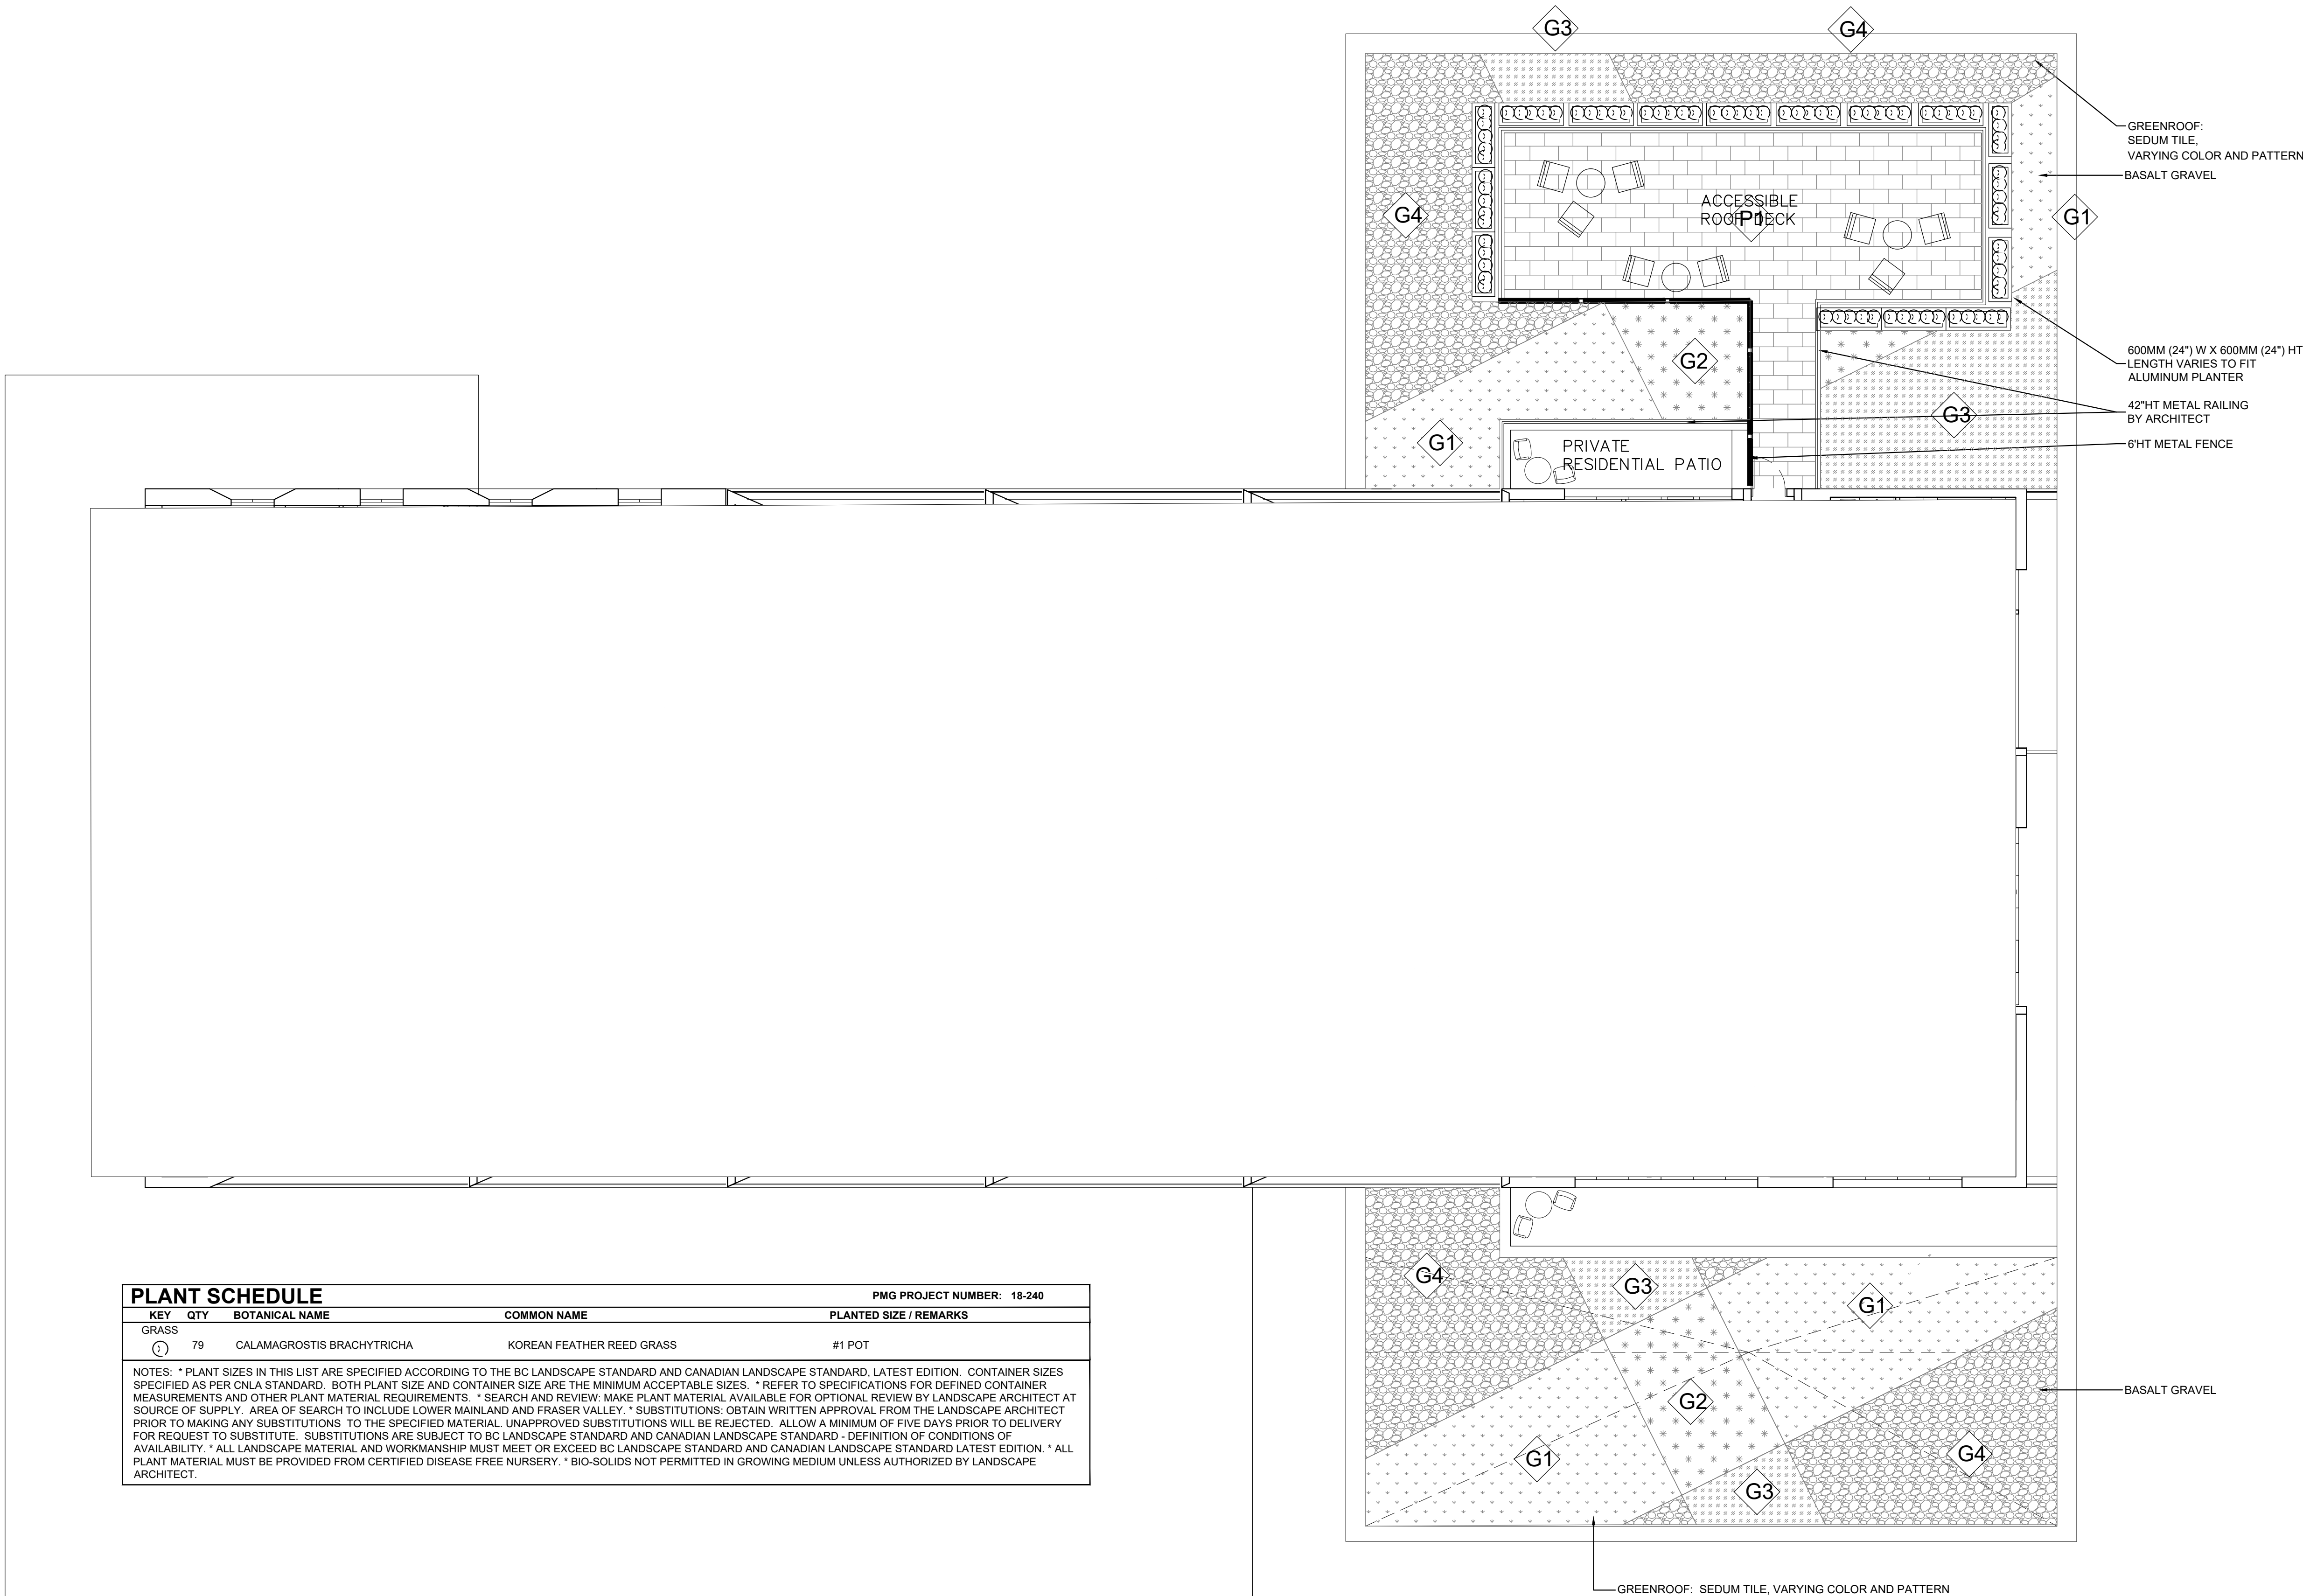

PLANT SCHEDULE					PMG PROJECT NUMBER: 18-240
KEY	QTY	BOTANICAL NAME	COMMON NAME	PLANTED SIZE / REMARKS	
GRASS					
(1)	79	CALAMAGROSIS BRACHYTRICHA	KOREAN FEATHER REED GRASS	#1 POT	
NOTES: * PLANT SIZES IN THIS LIST ARE SPECIFIED ACCORDING TO THE BC LANDSCAPE STANDARD AND CANADIAN LANDSCAPE STANDARD, LATEST EDITION. CONTAINER SIZES SPECIFIED AS PER CNLA STANDARD. BOTH PLANT SIZE AND CONTAINER SIZE ARE THE MINIMUM ACCEPTABLE SIZES. * REFER TO SPECIFICATIONS FOR DEFINED CONTAINER MEASUREMENTS AND OTHER PLANT MATERIAL REQUIREMENTS. * SEARCH AND REVIEW: MAKE PLANT MATERIAL AVAILABLE FOR OPTIONAL REVIEW BY LANDSCAPE ARCHITECT AT SOURCE OF SUPPLY. AREA OF SEARCH TO INCLUDE LOWER MAINLAND AND FRASER VALLEY. * SUBSTITUTIONS: OBTAIN WRITTEN APPROVAL FROM THE LANDSCAPE ARCHITECT PRIOR TO MAKING ANY SUBSTITUTIONS TO THE SPECIFIED MATERIAL. UNAPPROVED SUBSTITUTIONS WILL BE REJECTED. ALLOW A MINIMUM OF FIVE DAYS PRIOR TO DELIVERY FOR REQUEST TO SUBSTITUTE. SUBSTITUTIONS ARE SUBJECT TO BC LANDSCAPE STANDARD AND CANADIAN LANDSCAPE STANDARD - DEFINITION OF CONDITIONS OF AVAILABILITY. * ALL LANDSCAPE MATERIAL AND WORKMANSHIP MUST MEET OR EXCEED BC LANDSCAPE STANDARD AND CANADIAN LANDSCAPE STANDARD LATEST EDITION. * ALL PLANT MATERIAL MUST BE PROVIDED FROM CERTIFIED DISEASE FREE NURSERY. * BIO-SOLIDS NOT PERMITTED IN GROWING MEDIUM UNLESS AUTHORIZED BY LANDSCAPE ARCHITECT.					

18240-11.ZIP

SEAL:

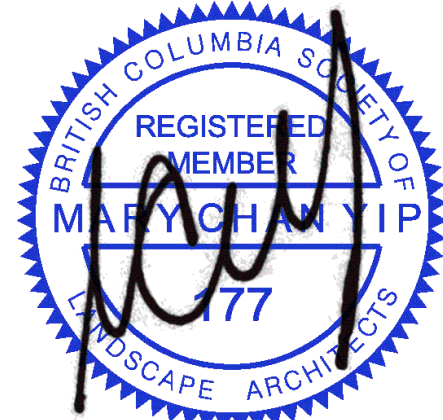

10	20.MAR.13	REV. PER COV COMMENTS	BA
9	19.NOV.28	100% BP SET	BA
8	19.NOV.04	90% CD SET	BA
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-	19.JUL.29	30% BP SUBMISSION	BA

NO. DATE REVISION DESCRIPTION DR.

CLIENT:

PROJECT:

**PARKWAY
MIXED USE DEVELOPMENT**


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VICTORIA, BC**

DRAWING TITLE:


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DETAILS AND SECTIONS**

DATE: 19.JUL.10 DRAWING NUMBER:
SCALE: AS SHOWN
DRAWN: BA
DESIGN: BA
CHK'D:
L6


OF 9

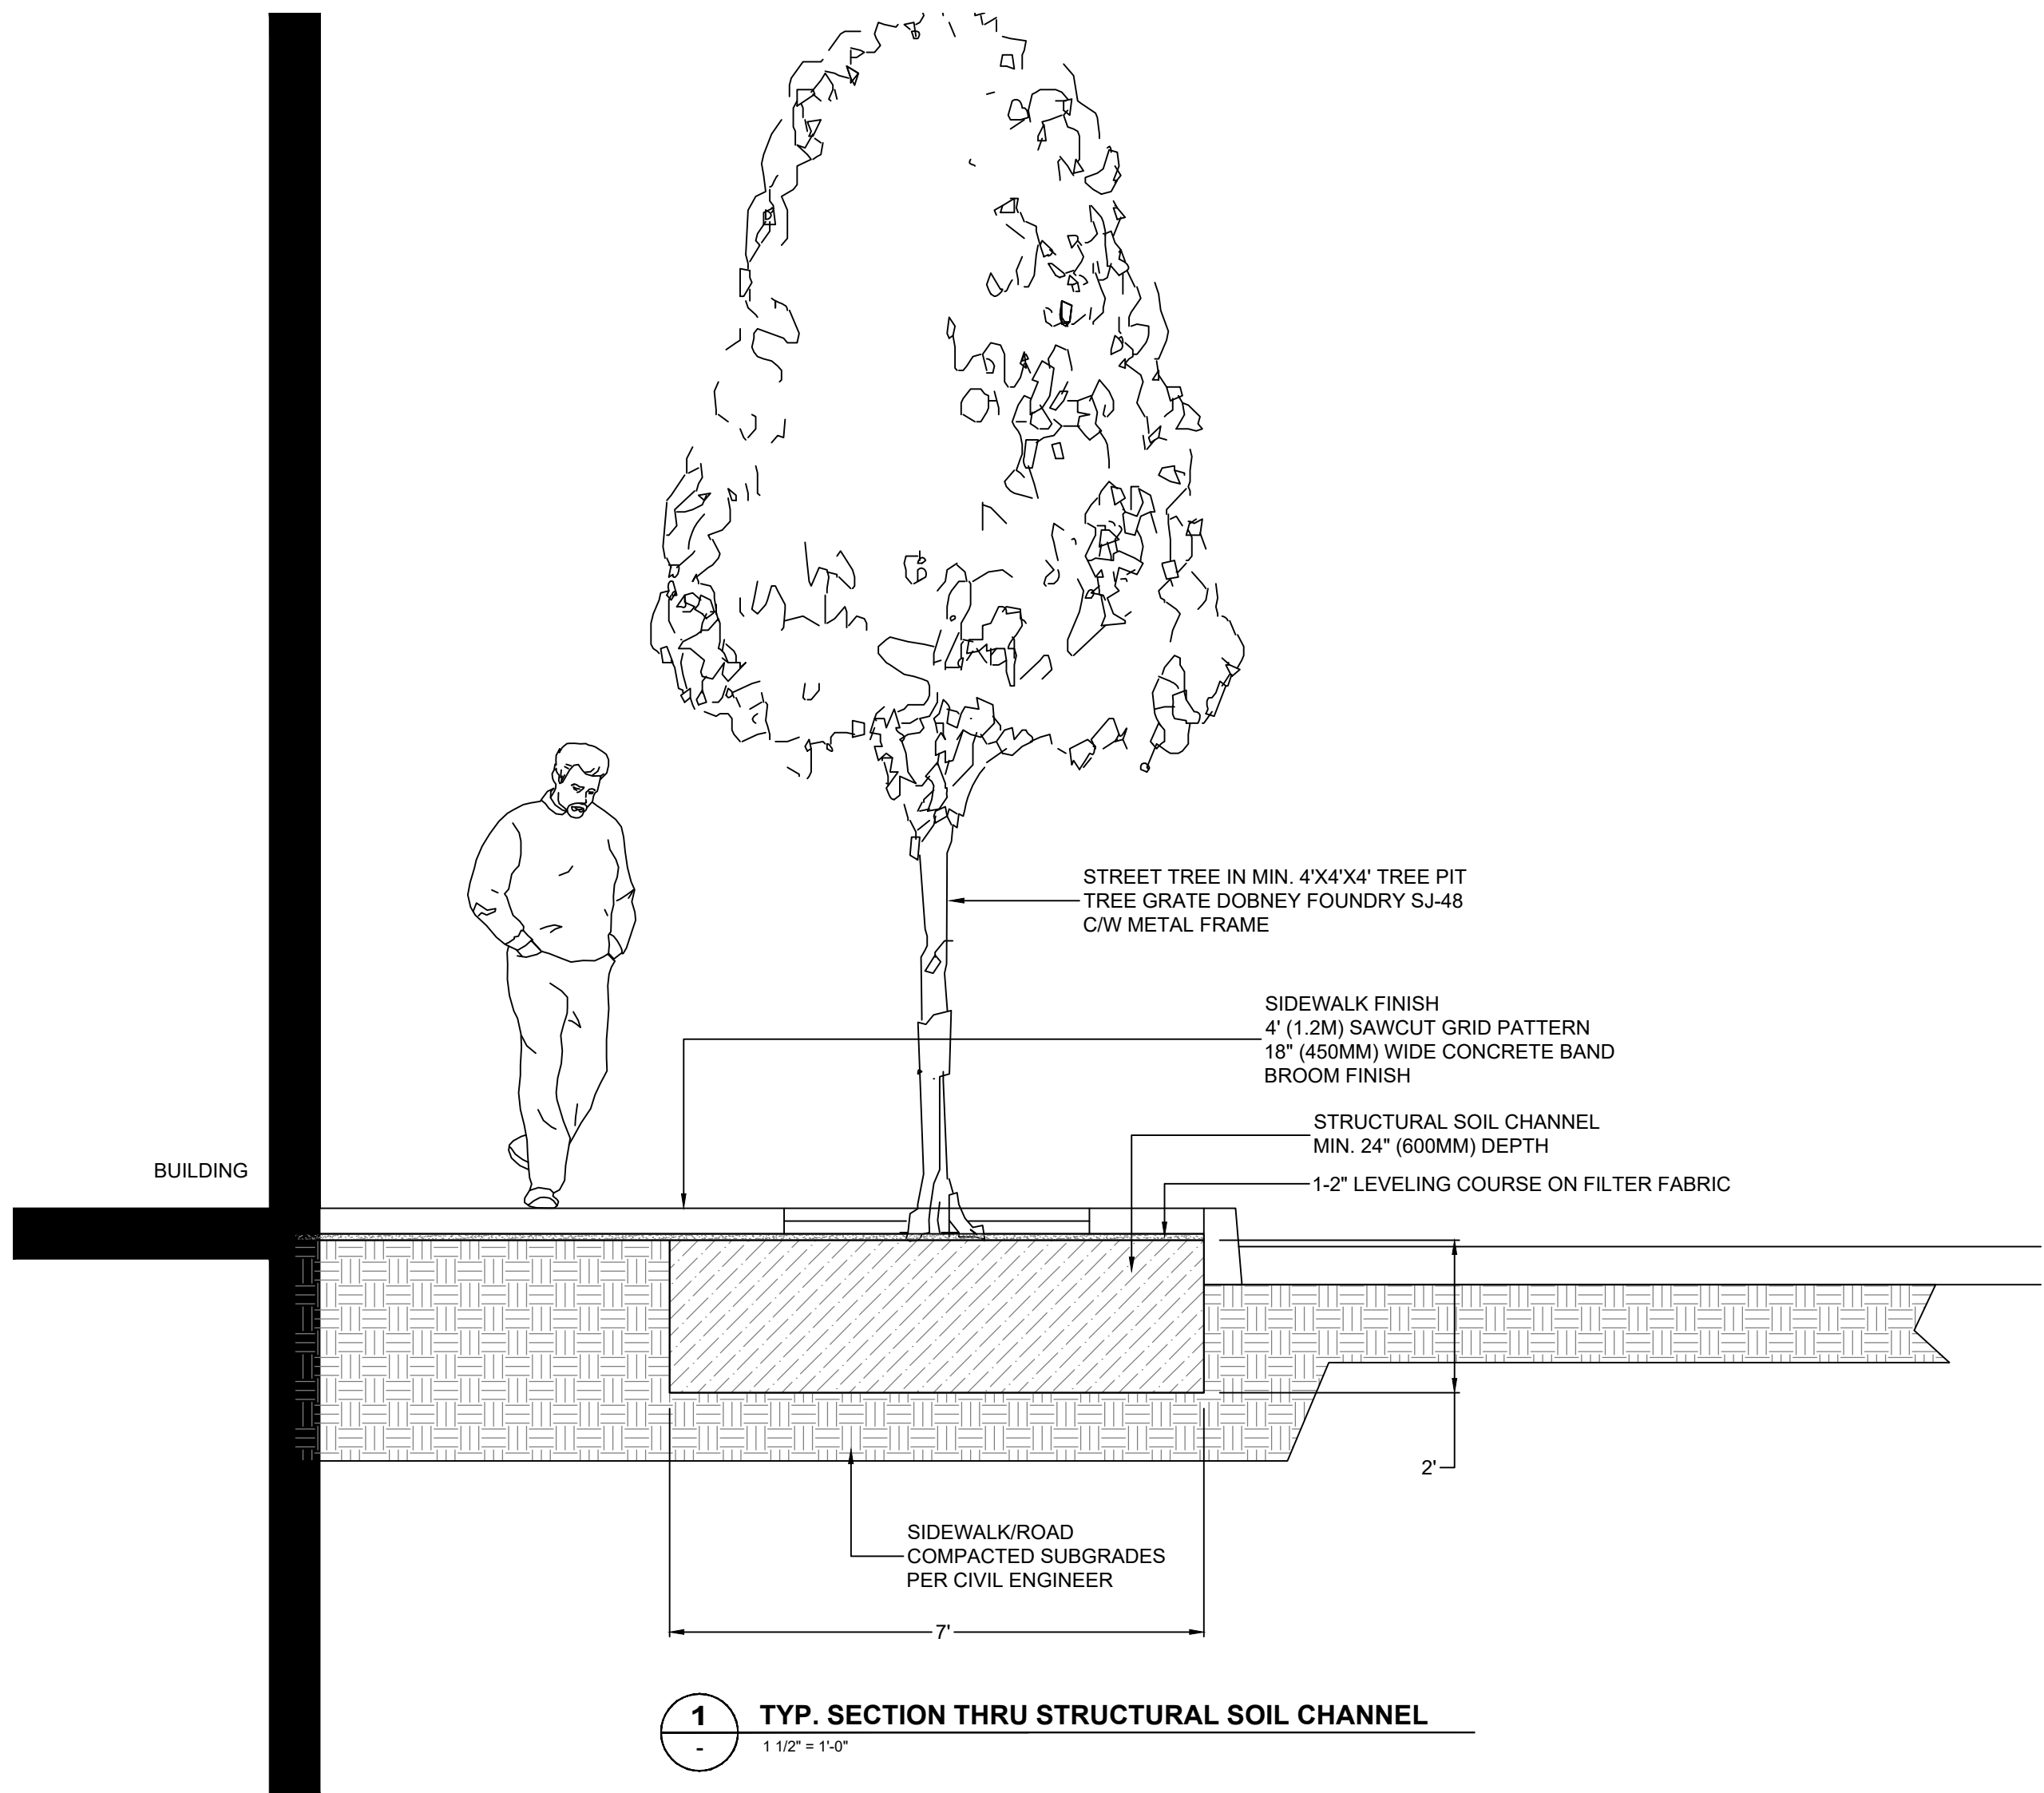

1 TYP. SECTION THRU STRUCTURAL SOIL CHANNEL
1 1/2\"/>

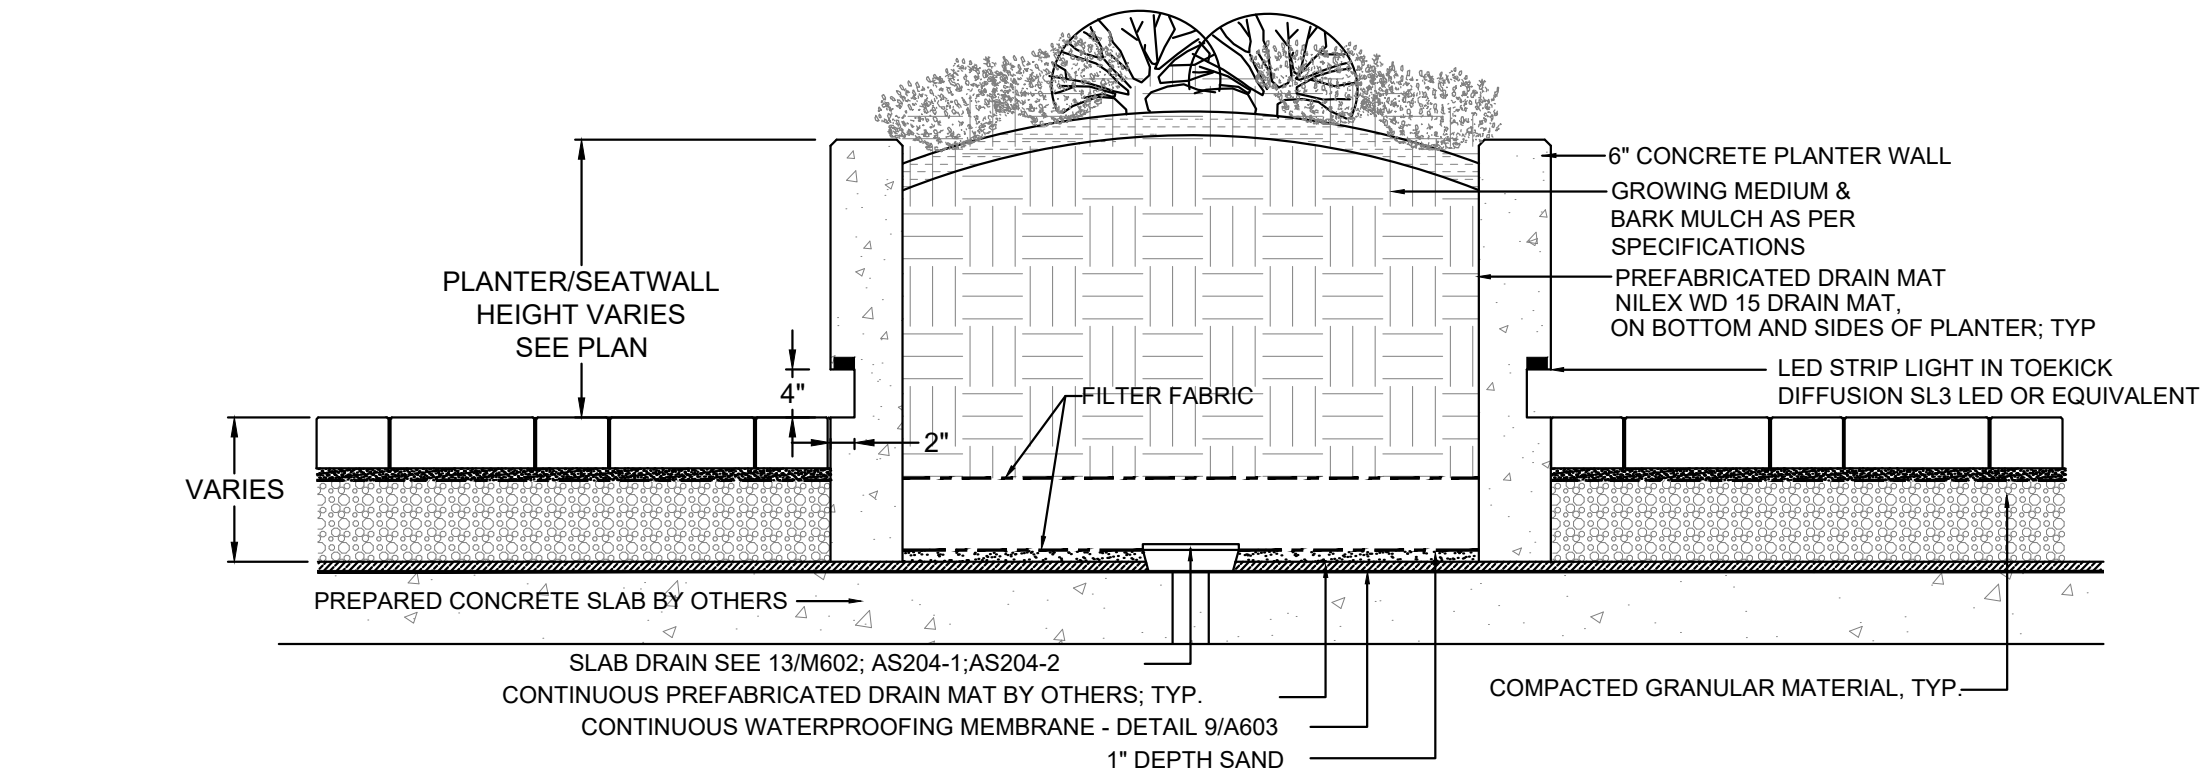


2 CONCRETE PLANTER ON SLAB; TYP
3/4\"/>

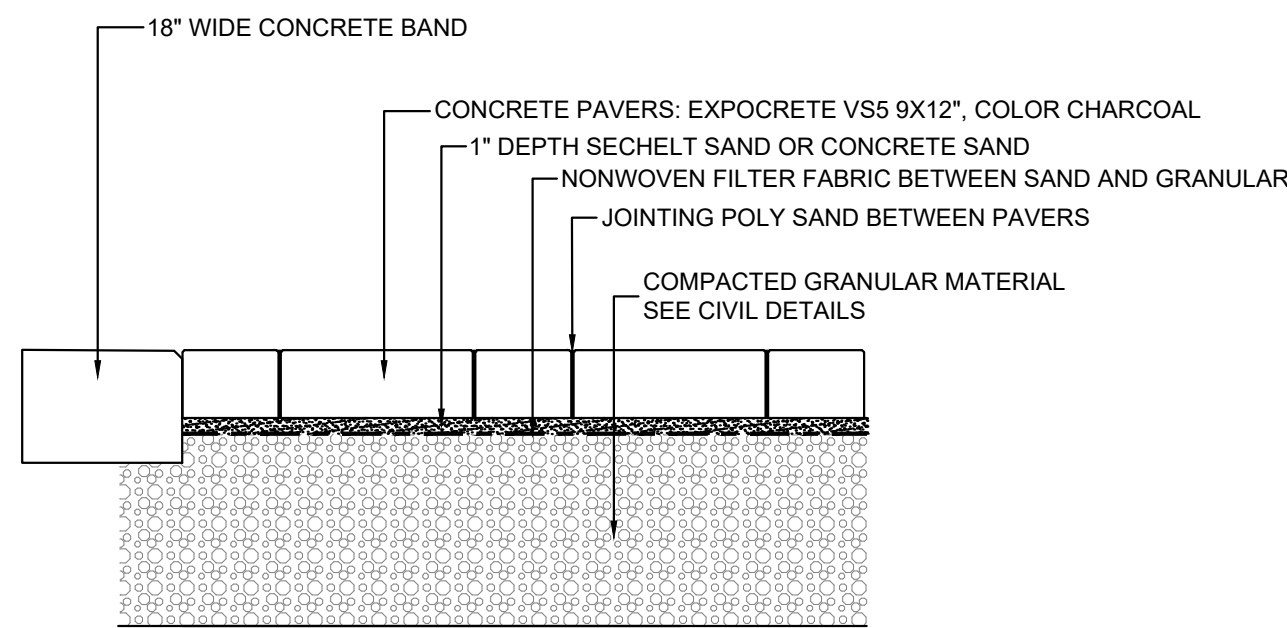


NOTE:
PAVERS TO BE INSTALLED
TO MANUFACTURERS SPECIFICATIONS

3 PAVERS ON GRADE - OFFSITE
1\"/>

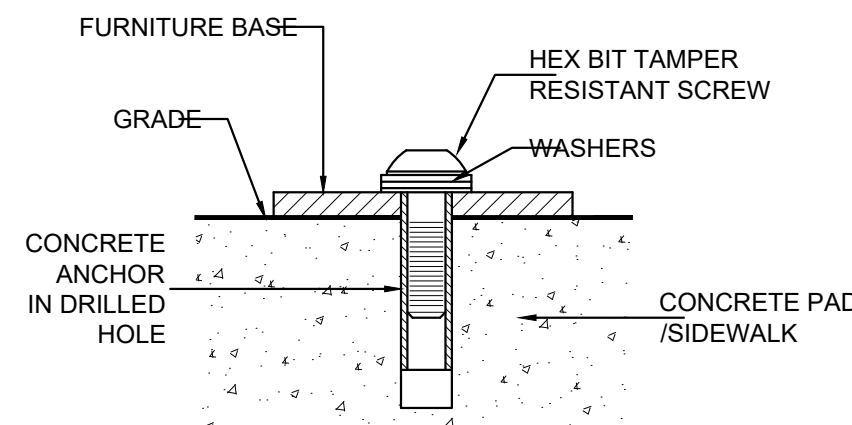


NOTE:
SITE FURNISHINGS TO BE INSTALLED TO
MANUFACTURERS SPECIFICATIONS

4 SITE FURNITURE MOUNTING
N.T.S.

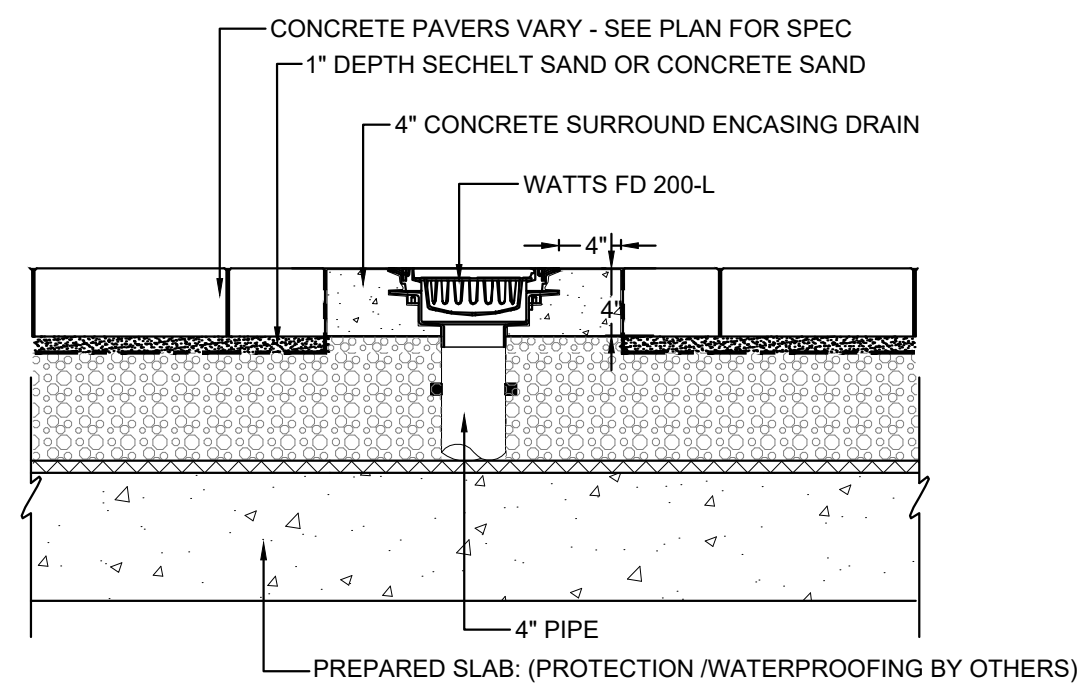


PAVER INSTALLATION PER MANUFACTURER SPECIFICATION

5 AREA DRAIN WITHIN PAVERS ON SLAB
1\"/>

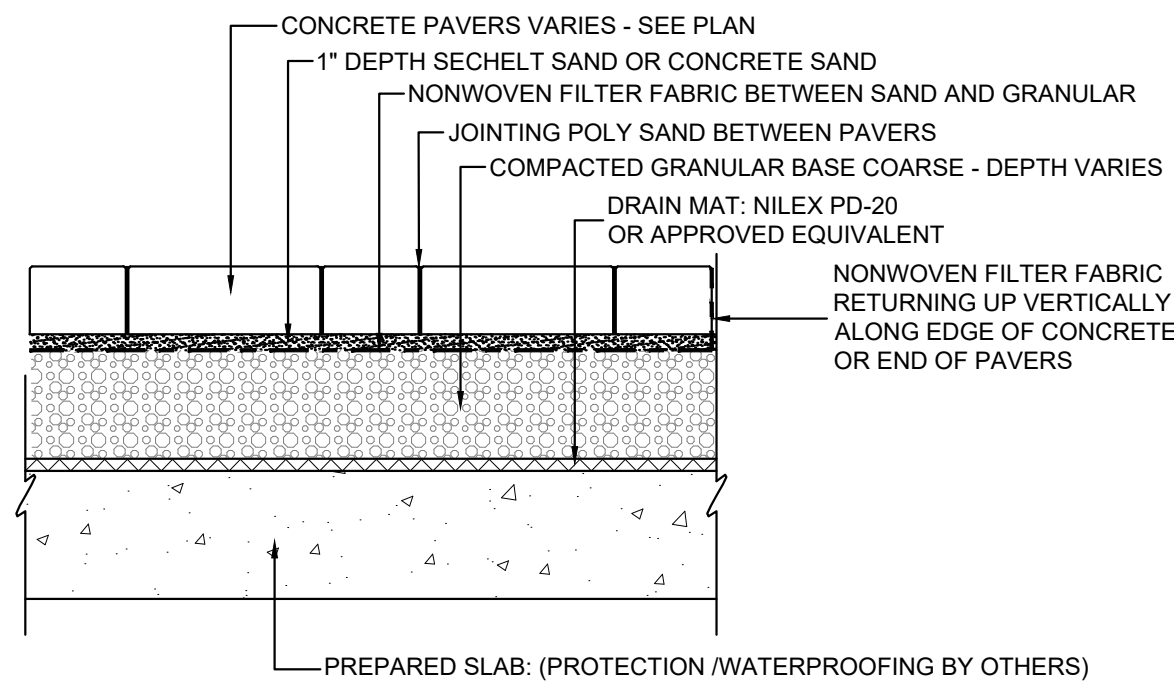

PAVER INSTALLATION PER MANUFACTURER'S SPECIFICATION

6 CONCRETE PAVERS ON SLAB
1\"/>

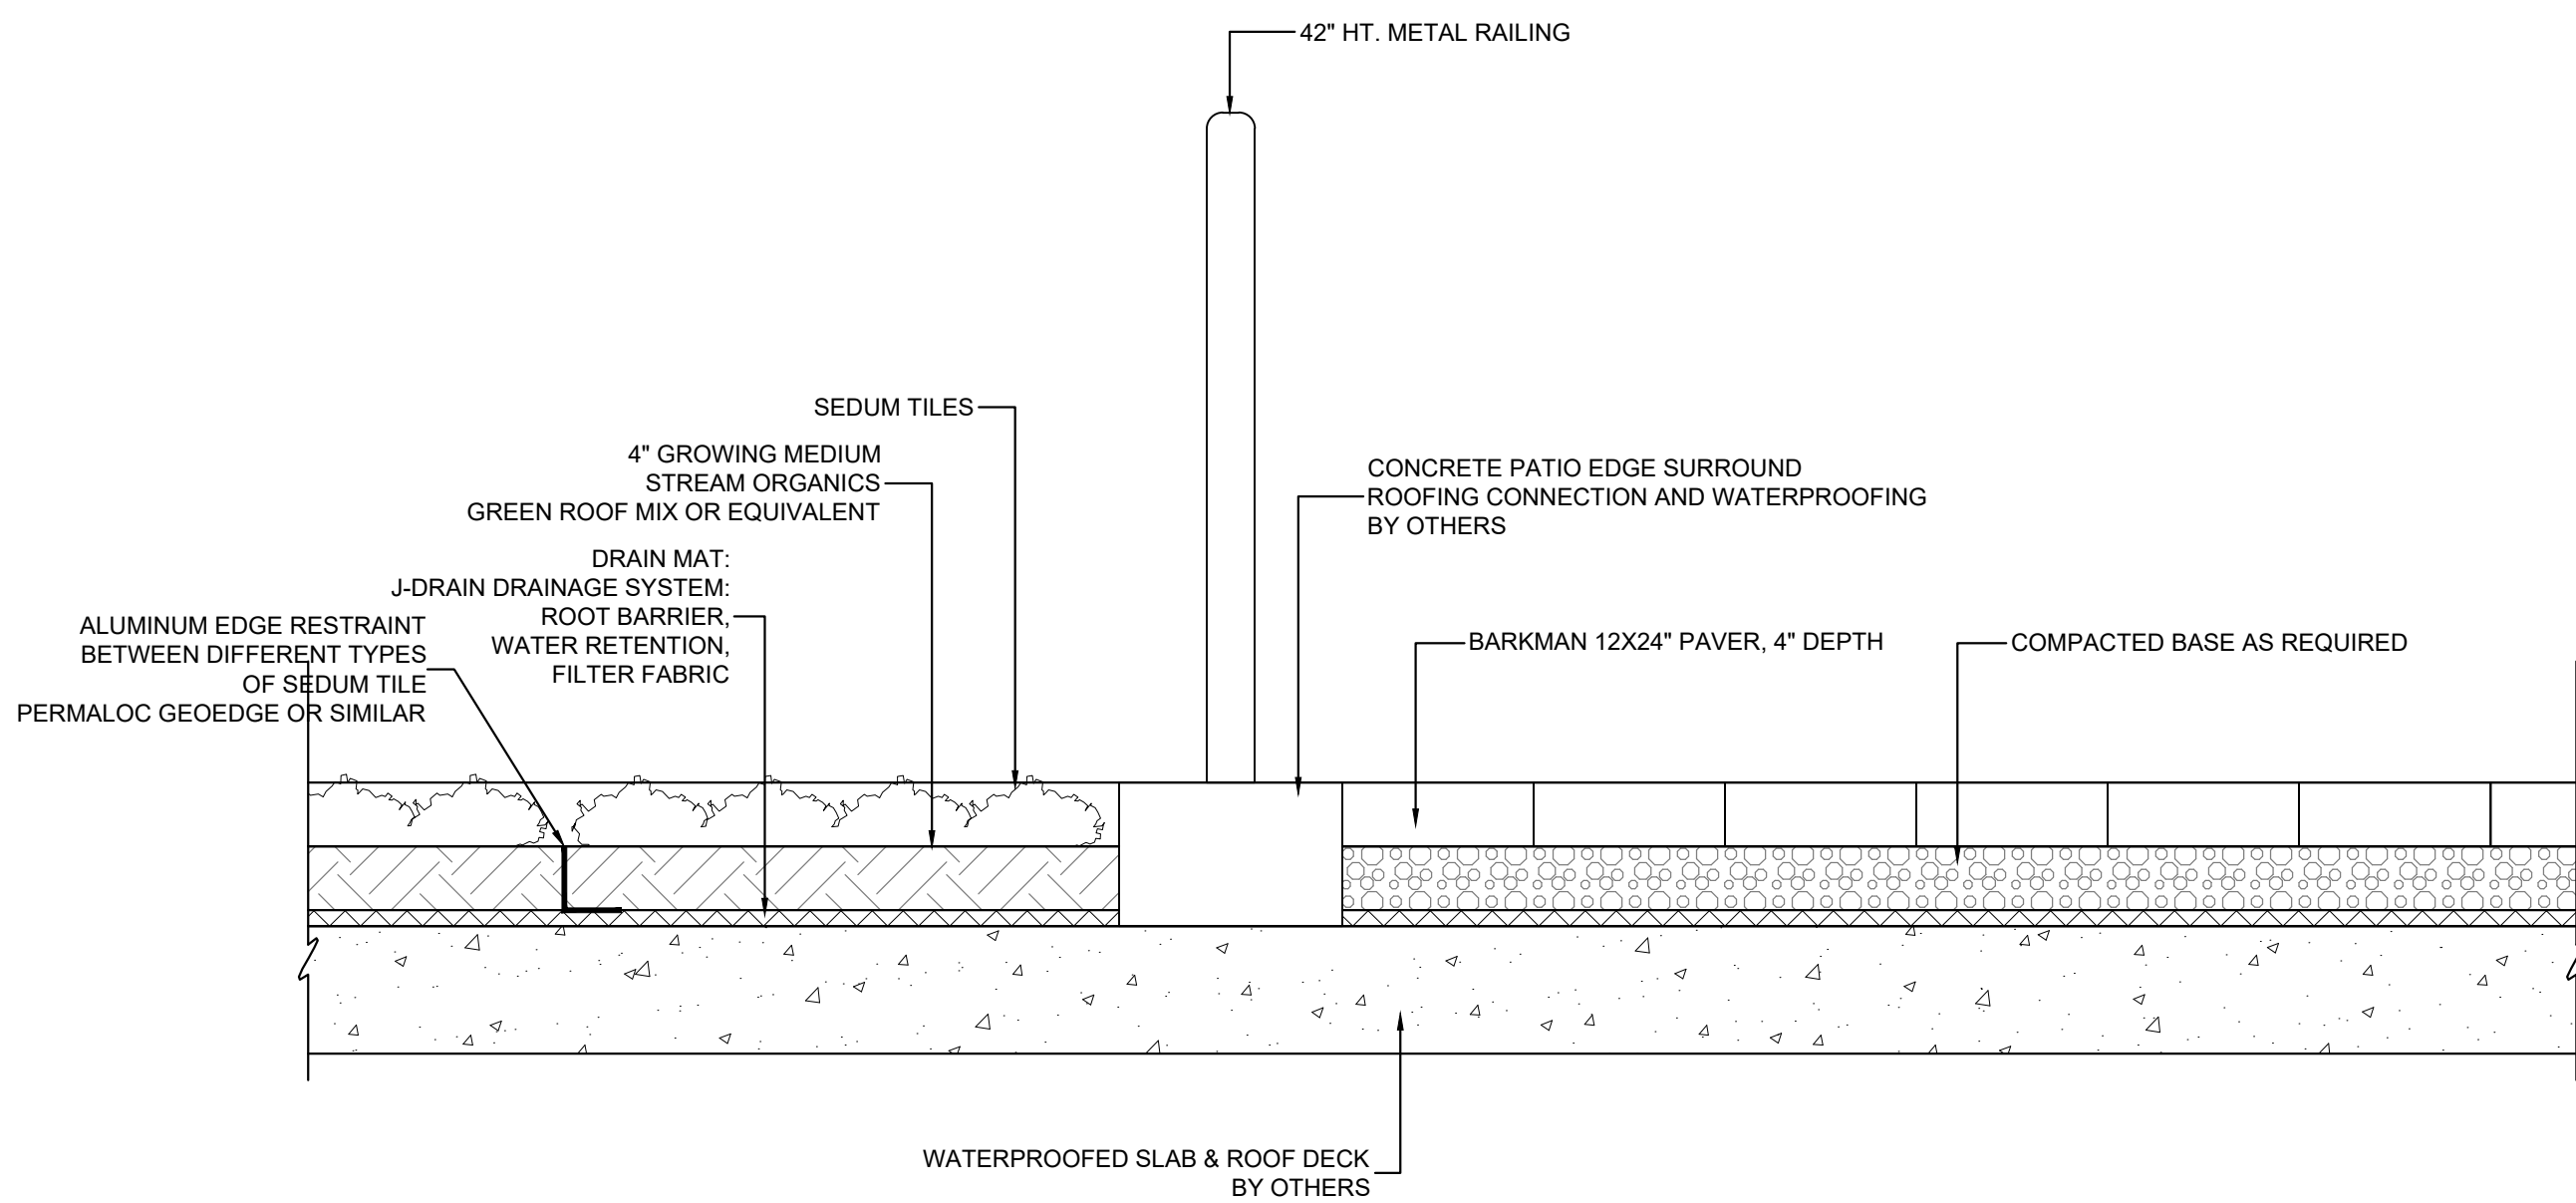

7 TYP. SEDUM ROOF LEVEL 3 AND 5, TYP. PATIO LEV 5
1\"/>

LIGHTING LEGEND

KEY DESCRIPTION


- ◆ SINGLE GLOBE PEDESTRIAN LIGHT
PHILLIPS MICENAS LED4 OR APPROVED EQUIVALENT
BDP791 LED43-4S/740 II DS50 GF BK 76
- ▲ SINGLE GLOBE PEDESTRIAN LIGHT
PHILLIPS MICENAS LED4 OR APPROVED EQUIVALENT
BDP791 LED43-4S/740 II DS50 GF BK 76
- SINGLE GLOBE PEDESTRIAN LIGHT
PHILLIPS MICENAS LED4 OR APPROVED EQUIVALENT
BDP791 LED43-4S/740 II DS50 GF BK 76



SINGLE GLOBE
PEDESTRIAN LIGHTING



TREE UPLIGHT

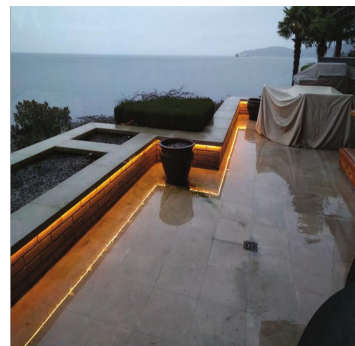


STRIP LIGHT UNDER
TOE KICK

TREE UPLIGHTS
DELTA STAR MR-16 LED
POWDERCOAT BLACK
(TYP. OF 5)

LED STRIP LIGHT UNDERMOUNT
IN RECESSED TOEKICK
DIFFUSION LIGHTING SL3

TREE UPLIGHTS
DELTA STAR MR-16 LED
POWDERCOAT BLACK
(TYP. OF 11)

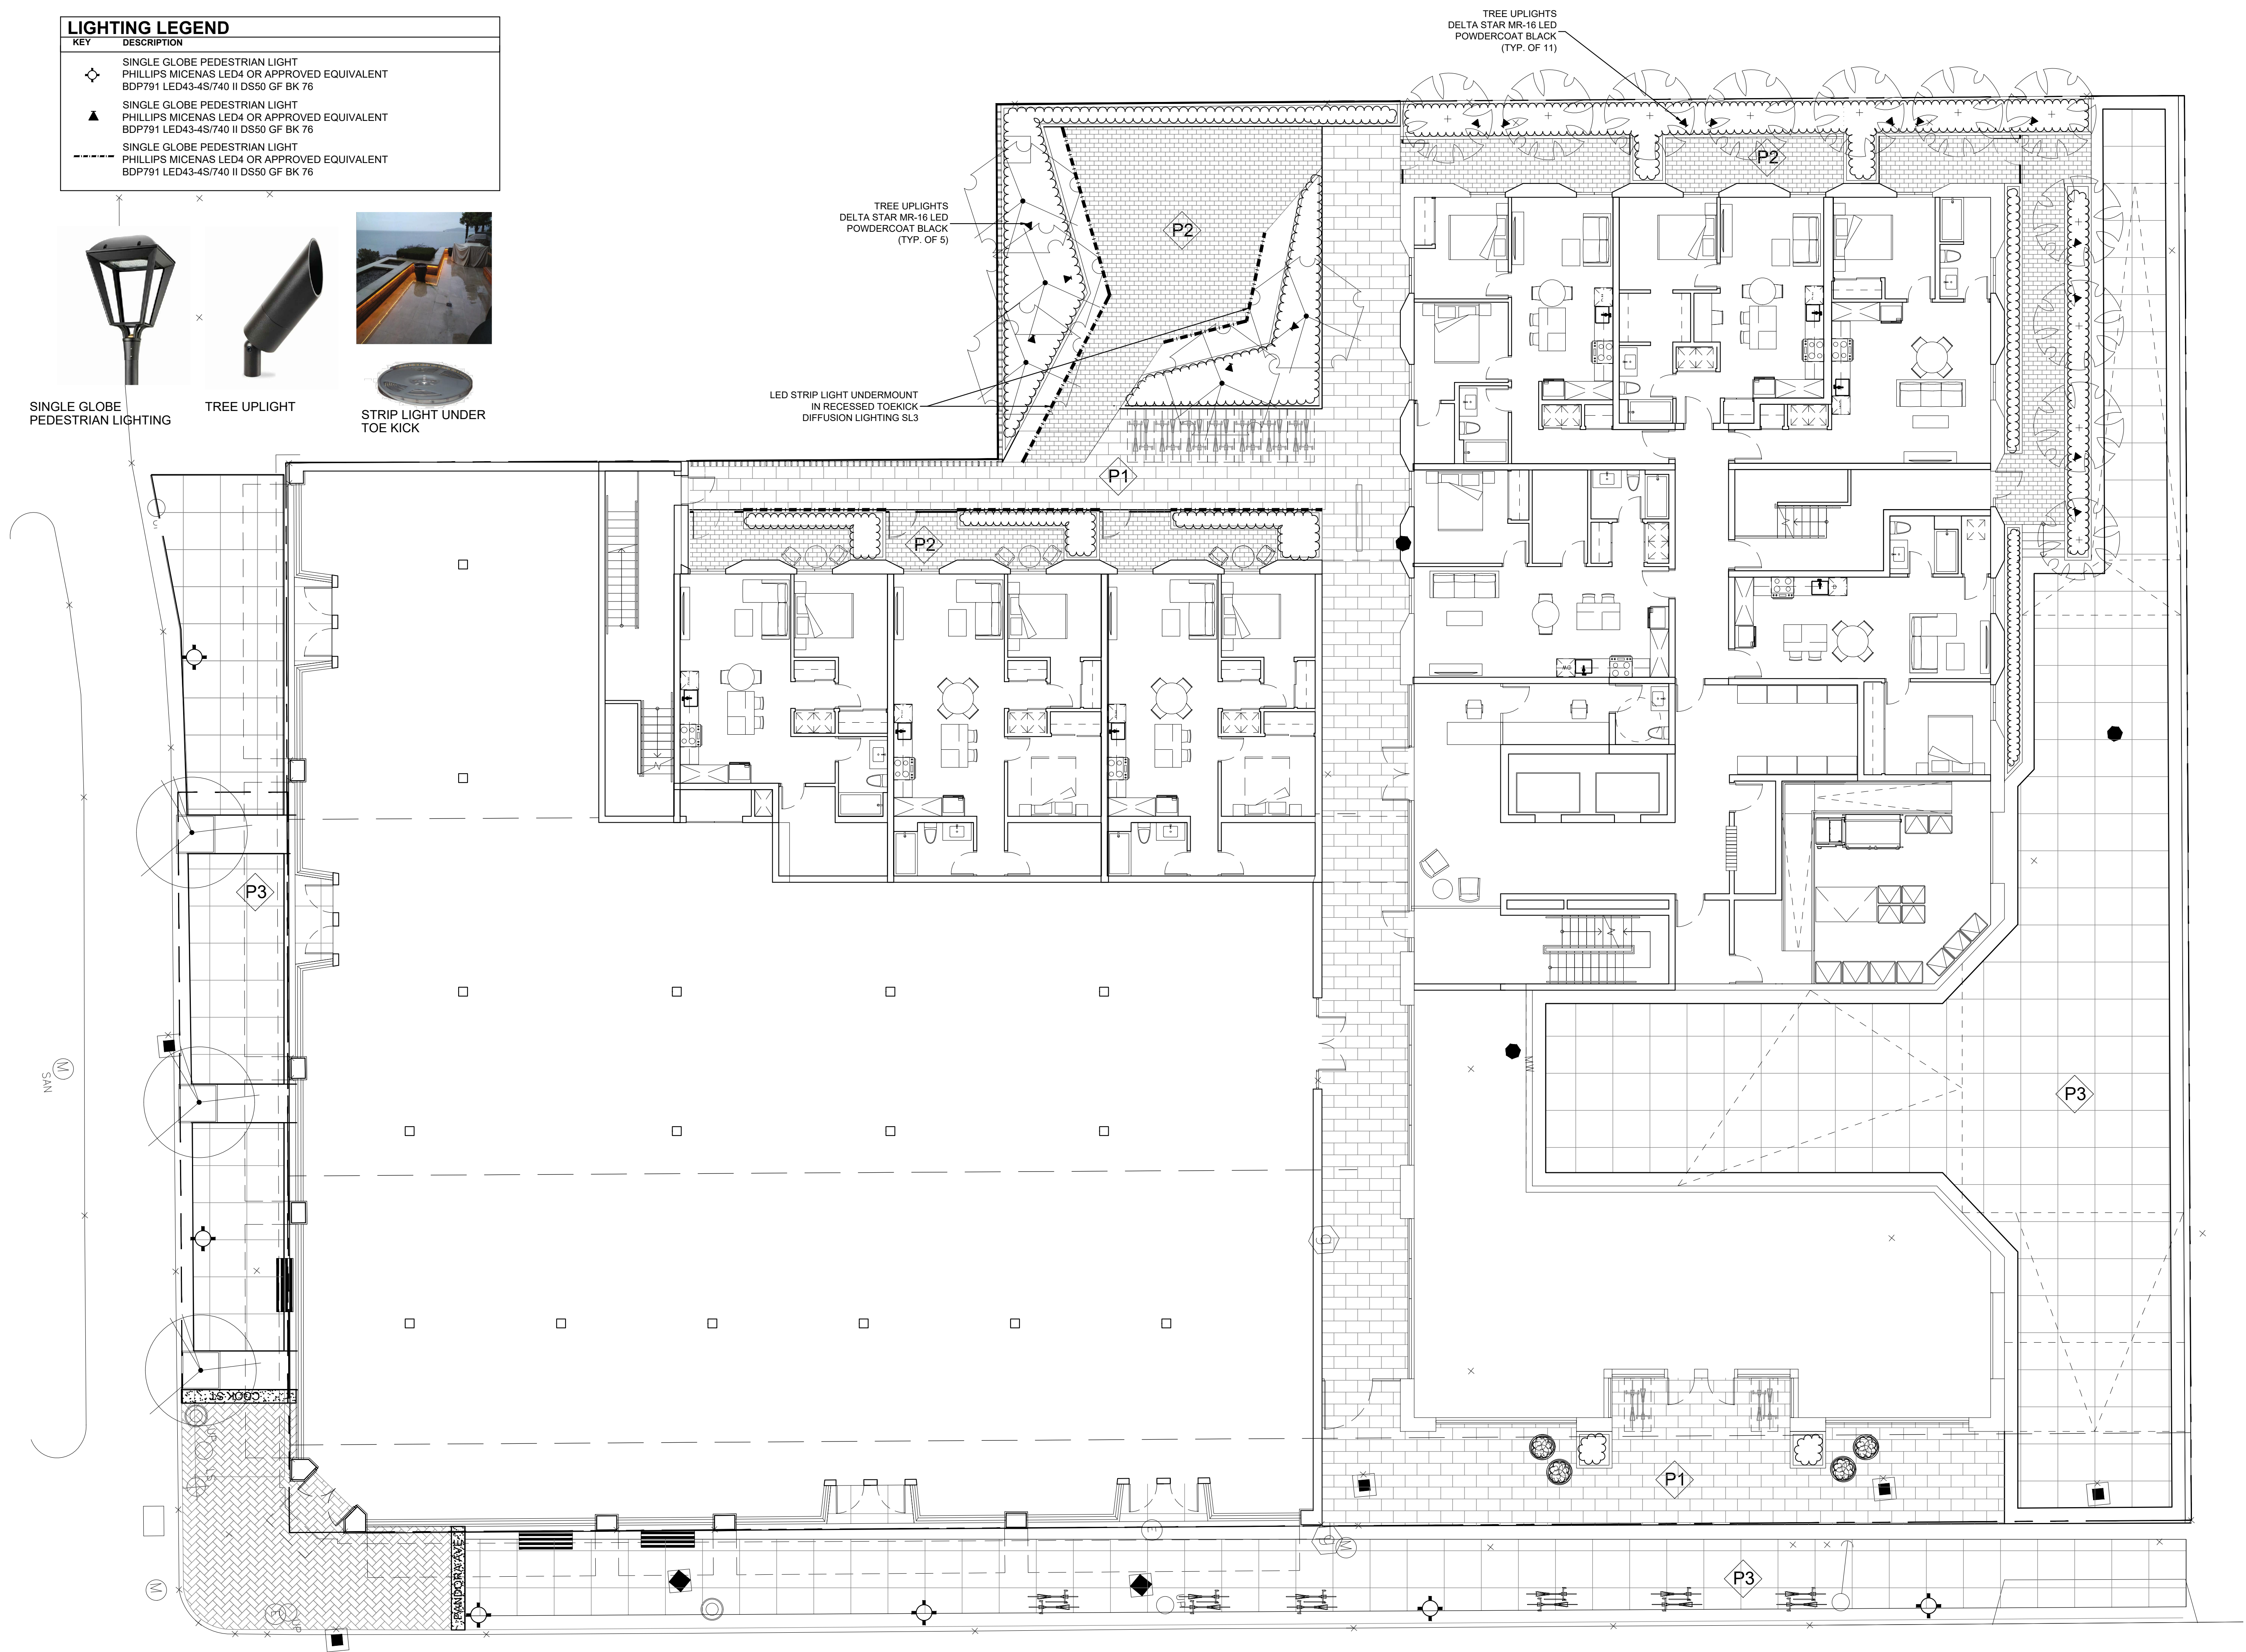

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pmg
LANDSCAPE
ARCHITECTS

Suite C100 - 4185 Still Creek Drive
Burnaby, British Columbia, V5C 6G9
p: 604 294-0011 ; f: 604 294-0022

SEAL:



10	20.MAR.13	REV. PER COV COMMENTS	BA
9	19.NOV.28	100% BP SET	BA
8	19.NOV.04	90% CO SET	BA
7	19.OCT.23	NEW GROUND FLOOR PLAN	DD
6	19.OCT.22	REVISION	DD
5	19.OCT.21	NEW SITE PLAN&CLIENT REQUEST	DD
3	19.OCT.03	60% CO SET	BA
2	19.SEP.27	REZONING	BA
1	21.AUG.19	REV. PER CITY/CLIENT COMMENTS	BA
-	19.JUL.29	30% BP SUBMISSION	BA

NO. DATE REVISION DESCRIPTION DR.

CLIENT:

PROJECT:

**PARKWAY
MIXED USE DEVELOPMENT**

**1050 PANDORA AVENUE
VICTORIA, BC**

DRAWING TITLE:

**LIGHTING
LAYOUT PLAN**

DATE: 19.JUL.10 DRAWING NUMBER:
SCALE: 1:100
DRAWN: BA
DESIGN: BA
CHK'D:

L7

OF 9

18240-11.ZIP

PMG PROJECT NUMBER:


18240



APLIN MARTIN

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SITE LOCATION PLAN

SCALE 1:2000

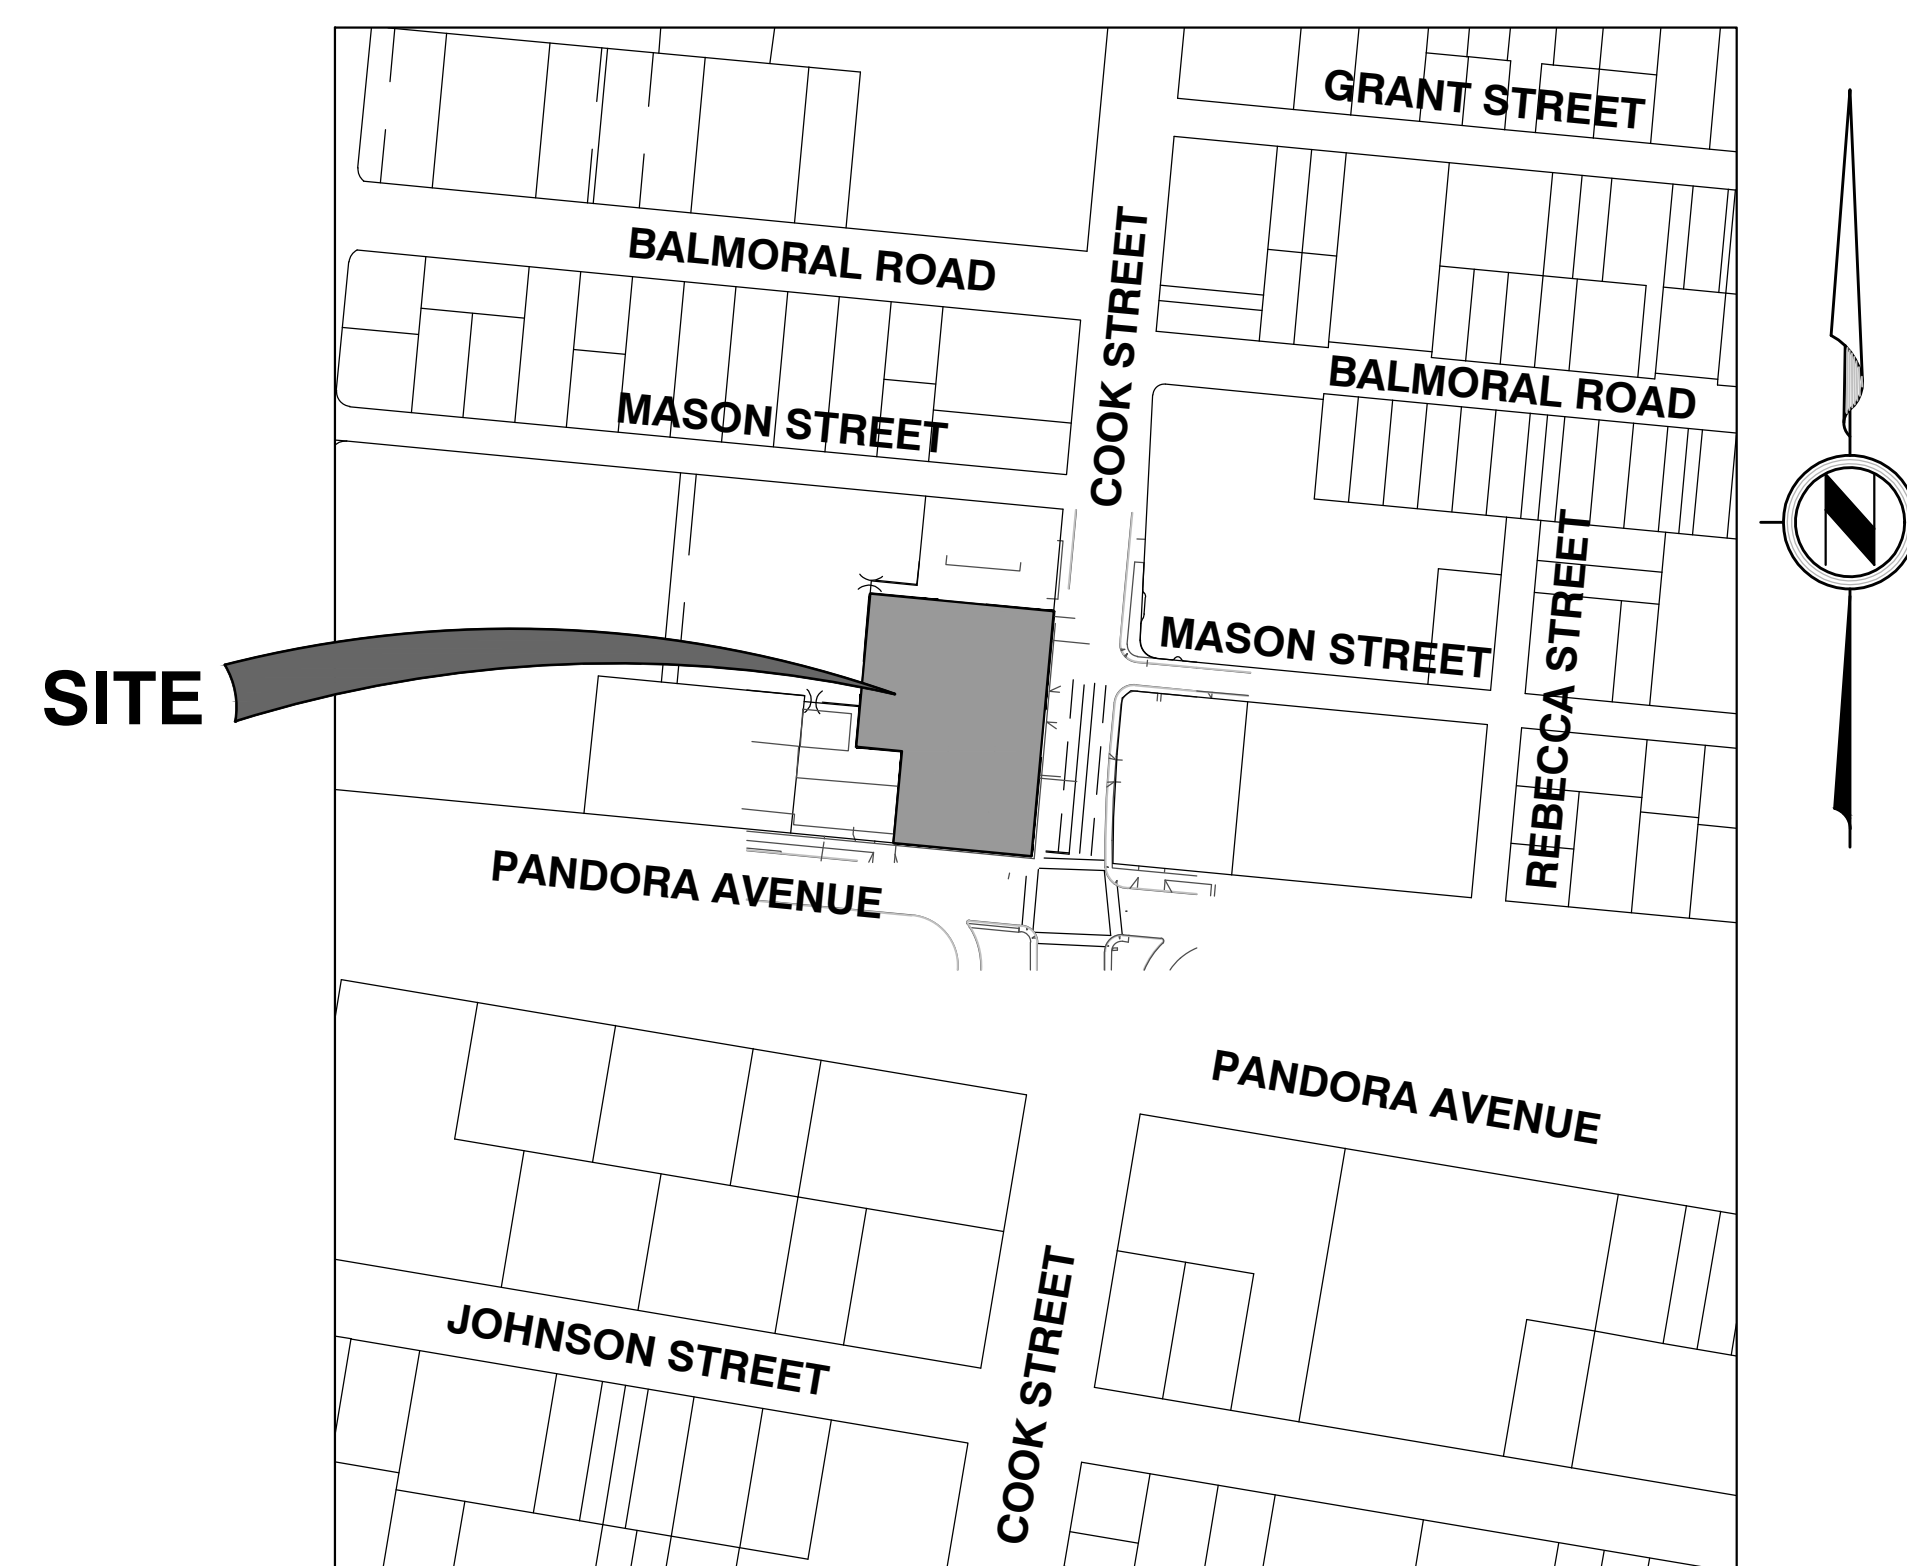DRAWING INDEX

18-010-01	COVER SHEET
18-010-02	KEY PLAN & GENERAL NOTES
18-010-03	SERVICING & GRADING PLAN
18-010-04	TRUCK TURNING PLAN

CLIENT:

DISTRICT GROUP

SUITE 200 - 8809 HEATHER STREET, VANCOUVER, BC V6P 3T1
PH. 604-322-5762

PROJECT:

PARKWAY - MIXED-USE DEVELOPMENT

1050 PANDORA AVENUE & 1518 COOK STREET, VICTORIA, BC

NOT FOR CONSTRUCTION

MUNICIPAL PROJECT No. XXX

APLIN & MARTIN PROJECT No. 18-010



NOT FOR CONSTRUCTION

GENERAL

1. ALL WORKS TO BE CONSTRUCTED IN ACCORDANCE WITH THE BRITISH COLUMBIA BUILDING CODE 2018.
2. ALL CONSTRUCTION AND MATERIALS SHALL BE IN ACCORDANCE WITH THE PLATINUM EDITION OF THE MASTER MUNICIPAL CONSTRUCTION DOCUMENTS (MMCD), AND CITY OF VICTORIA BYLAW STANDARDS, UNLESS OTHERWISE NOTED.
3. ANY REVISIONS TO THESE DRAWINGS SHALL BE APPROVED BY THE CITY'S REPRESENTATIVE. CONSTRUCTION SHALL NOT COMMENCE PRIOR TO THE APPROVAL OF THESE DRAWINGS BY THE CITY'S REPRESENTATIVE.
4. THE CONTRACTOR SHALL OBTAIN THE CITY'S PERMIT TO WORK WITHIN THE ROAD ALLOWANCE A MINIMUM OF 5 WORKING DAYS PRIOR TO THE START OF CONSTRUCTION.
5. THE CONTRACTOR SHALL SUBMIT PROOF OF CONTRACTOR LIABILITY INSURANCE TO THE CITY'S REPRESENTATIVE AS PER THE CITY'S SPECIFICATIONS.
6. ALL BUILDINGS & ROADS ARE TO BE LOCATED BY COORDINATES AS CALCULATED BY A B.C. LAND SURVEYOR.
7. THE CONTRACTOR MUST CONTACT THE ENGINEER PRIOR TO CONSTRUCTION TO SCHEDULE AN ONSITE PRE CONSTRUCTION MEETING DURING WHICH CONSTRUCTION METHODS, TIMING AND INSPECTION WILL BE DISCUSSED.
8. CONTRACTOR TO VERIFY THE LOCATION AND INVERTS OF EXISTING WATER, STORM AND SANITARY CONNECTIONS IN THE VICINITY OF THE SITE. REPORT TO THE ENGINEER ANY DISCREPANCIES PRIOR TO START OF CONSTRUCTION
9. ALL OR ANY EXISTING UNDERGROUND UTILITIES ARE NOT NECESSARILY SHOWN. EXISTING UNDERGROUND UTILITIES SHALL BE LOCATED AND ALL UTILITY COMPANIES CONTACTED PRIOR TO INSTALLING ANY NEW UNDERGROUND SERVICES.
10. THE CONTRACTOR'S SURVEYOR SHALL BE RESPONSIBLE FOR VERIFYING THAT ALL LEGAL SURVEY DIMENSIONS SHOWN ON THE DRAWINGS AGREE WITH THOSE ON THE REGISTERED LEGAL SURVEY PLAN. SHOULD THERE BE ANY DISCREPANCIES, THE CONSULTING ENGINEERING FIRM SHALL BE NOTIFIED IMMEDIATELY.
11. WORKSAFE BC SHALL BE NOTIFIED PRIOR TO THE START OF CONSTRUCTION. THE CONTRACTOR SHALL BE REGISTERED WITH WORKSAFE BC AND SHALL SUBMIT PROOF OF REGISTRATION TO THE TOWN'S REPRESENTATIVE. ALL WORK SHALL CONFORM TO ALL APPLICABLE REGULATIONS OF WORKSAFE BC.
12. ALL DIMENSIONS SHALL BE IN METRIC UNLESS OTHERWISE NOTED. METRES SHALL BE EXPRESSED IN DECIMALS, MILLIMETERS IN WHOLE NUMBERS. FIGURED DIMENSIONS SHALL GOVERN OVER SCALED DIMENSIONS.
13. THE CONTRACTOR SHALL PREPARE AND SUBMIT THE FOLLOWING PLANS TO THE CITY'S REPRESENTATIVE FOR REVIEW AND ACCEPTANCE PRIOR TO CONSTRUCTION COMMENCING.
 - * TRAFFIC MANAGEMENT PLAN.
 - * EROSION AND SEDIMENT CONTROL PLAN FOR CONSTRUCTION.
 - * TREE PRESERVATION PLAN.
14. LEGAL SURVEY MONUMENTS SHALL BE REPLACED BY A BC LAND SURVEYOR, TO CITY SPECIFICATIONS, AT THE CONTRACTOR'S EXPENSE IF DESTROYED OR DAMAGED DURING CONSTRUCTION. THIS ALSO PERTAINS TO MONUMENTS THAT REQUIRE RAISING OR RELOCATING. THE CONTRACTOR SHALL NOTIFY THE CITY'S REPRESENTATIVE THREE WORKING DAYS IN ADVANCE OF THE WORK AFFECTING SURVEY MONUMENTS.
15. WHERE A TRENCH IS UNDER OR WITHIN 1.0 METRES OF THE ROADWAY OR DRIVEWAY EDGE, FULL DEPTH GRANULAR BACKFILL SHALL BE USED.
16. AFTER CONSTRUCTION, WORK AREAS AND EXISTING FEATURES SHALL BE RESTORED TO THEIR ORIGINAL CONDITION OR BETTER.
17. ADJUST ALL PROPOSED AND EXISTING APPURTENANCES TO MEET FINAL DESIGN UPGRADES.
18. ALL SURPLUS MATERIAL SHALL BE REMOVED FROM THE SITE AND DISPOSED OF PROPERLY IN ACCORDANCE WITH ALL APPLICABLE GUIDELINES AND REGULATIONS.
19. THE ENGINEER OF RECORD SHALL SUBMIT AS-CONSTRUCTED DRAWINGS TO THE CITY'S REPRESENTATIVE.
20. THE CONTRACTOR SHALL EMPLOY APPROPRIATE EROSION & SEDIMENT CONTROL MEASURE, APPROVED BY THE CITY'S REPRESENTATIVE TO PREVENT SILT DISCHARGES TO THE STORM DRAINAGE SYSTEM AND WATERCOURSES. REGULAR, ONGOING INSPECTION OF SEDIMENT CONTROL SHALL BE CARRIED OUT TO ENSURE CONTINUOUS PROTECTION.

PROP. SANITARY SEWER	
PROP. STORM SEWER	
PROP. WATER MAIN	
EX. SANITARY SEWER	
EX. STORM SEWER	
EX. WATER MAIN	
EXISTING FENCE	

STORM SEWER

1. DO NOT PLUG OR ABANDON AN EXISTING STORM DRAINAGE CONNECTION WITHOUT WRITTEN APPROVAL FROM THE ENGINEER OF RECORD.
2. ALL STORM SEWER AND BEDDING MATERIALS TO BE IN ACCORDANCE WITH THE PLATINUM EDITION OF THE MASTER MUNICIPAL CONTRACT DOCUMENTS (MMCD) REQUIREMENTS.
3. ALL EXISTING CULVERTS AND STORM DRAIN SYSTEMS THAT ARE TO BE ABANDONED SHALL BE INSPECTED FOR EXISTING STORM SERVICE LEADS. ALL EXISTING LEADS ARE TO BE CONNECTED TO THE NEW STORM SEWER SYSTEM.
4. ALL PIPING AND RELATED APPURTENANCES TO BE INSPECTED AND APPROVED PRIOR TO BACKFILLING OF TRENCH.
5. ALL MANHOLES ARE TO BE A MINIMUM OF 1050mm DIAMETER UNLESS OTHERWISE NOTED.
6. ALL STORM PIPES TO BE PVC SDR35.
7. ALL TYPICAL TRENCH SECTION DETAILS TO FOLLOW MMCD SPECIFICATION DRAWING G4, UNLESS OTHERWISE NOTED BY THE CITY'S REPRESENTATIVE.
8. ALL PAVEMENT RESTORATION TO FOLLOW MMCD SPECIFICATION DWG. G5.
9. THE CONTRACTOR SHALL CONFIRM THE LOCATION AND INVERTS OF EXISTING STORM SEWER CONNECTIONS PRIOR TO CONSTRUCTION.
10. CATCHBASIN RIM ELEVATIONS GIVEN ARE THE ELEVATION OF THE SURFACE INLET.
11. TIE-INS OF PROPOSED MAINS TO EXISTING STORM SEWER MAINS SHALL BE INSPECTED BY CITY'S REPRESENTATIVE.
12. ALL STORM DRAIN SERVICE CONNECTIONS SHALL BE MINIMUM 100mm IN DIAMETER.
13. THE CONTRACTOR SHALL VIDEO INSPECT ALL COMPLETED STORM DRAIN LINES ON PUBLIC AND PRIVATE PROPERTY FOLLOWING COMPLETION OF INSTALLATION. VIDEO REPORTS SHALL BE SUBMITTED TO THE CITY'S REPRESENTATIVE. SHOULD THE VIDEO INDICATE APPARENT DEFICIENCIES, ADDITIONAL TESTING AND/OR REPLACEMENT SHALL BE REQUIRED AT THE DIRECTION OF THE CITY'S REPRESENTATIVE. AT THE CONTRACTOR'S EXPENSE. ALL STORM DRAIN LINES, CATCH BASINS, MANHOLES, ETC., SHALL BE CLEANED THOROUGHLY UPON COMPLETION OF CONSTRUCTION. AT THE END OF THE ONE-YEAR WARRANTY PERIOD, ALL LINES SHALL AGAIN BE VIDEO INSPECTED AND THE RESULTS SUBMITTED TO THE CITY'S REPRESENTATIVE.

SANITARY SEWER:

1. ALL SANITARY SEWER MATERIALS SHALL BE IN ACCORDANCE WITH THE PLATINUM EDITION OF THE MASTER MUNICIPAL CONSTRUCTION DOCUMENTS (MMCD), UNLESS OTHERWISE NOTED.
2. THE CONTRACTOR SHALL COMPLETE AND SUBMIT THE CITY'S APPLICATION FOR SANITARY SEWER CONNECTION DOCUMENT FOR ALL REQUIRED SANITARY SEWER CONNECTIONS TO THE CITY'S REPRESENTATIVE PRIOR TO COMMENCEMENT OF CONSTRUCTION.
3. THE CONTRACTOR SHALL CONFIRM THE LOCATION AND INVERTS OF EXISTING SANITARY SEWER CONNECTIONS PRIOR TO CONSTRUCTION.
4. NEW SEWER LINES TIED INTO EXISTING LINES SHALL BE PLUGGED UNTIL THEY ARE TESTED AND FLUSHED.
5. TIE-INS OF PROPOSED MAINS TO EXISTING SANITARY SEWER MAINS SHALL BE INSPECTED BY CITY'S REPRESENTATIVE.
6. FOR EXISTING PIPES OR SERVICE CONNECTIONS THAT ARE TO BE ABANDONED, THE CONTRACTOR SHALL CAP ENDS AND FILL WITH CDF OR APPROVED ALTERNATIVE, AS DIRECTED BY THE CITY'S REPRESENTATIVE. EVIDENCE OF THIS (SUCH AS WITH PHOTOGRAPHS), SHALL BE PROVIDED TO THE CITY'S REPRESENTATIVE PRIOR TO BACKFILL. THE ABANDONED PIPE SHALL BE NOTED ON THE AS-CONSTRUCTED DRAWING.
7. TESTING SHALL BE THE RESPONSIBILITY OF THE CONTRACTOR WITH INSPECTION AUTHORIZED BY THE CITY'S REPRESENTATIVE.
8. THE CONTRACTOR SHALL VIDEO INSPECT ALL COMPLETED SANITARY SEWER LINES ON PUBLIC AND PRIVATE PROPERTY FOLLOWING COMPLETION OF INSTALLATION. VIDEO REPORTS SHALL BE SUBMITTED TO THE CITY'S REPRESENTATIVE. SHOULD THE VIDEO INDICATE APPARENT DEFICIENCIES, ADDITIONAL TESTING AND/OR REPLACEMENT SHALL BE REQUIRED AT THE DIRECTION OF THE CITY'S REPRESENTATIVE, AT THE CONTRACTOR'S EXPENSE. ALL SANITARY SEWER LINES, MANHOLES, ETC, SHALL BE CLEANED THOROUGHLY UPON COMPLETION OF CONSTRUCTION. AT THE END OF THE ONE-YEAR WARRANTY PERIOD ALL LINES SHALL AGAIN BE VIDEO INSPECTED AND THE RESULTS SUBMITTED TO THE CITY'S REPRESENTATIVE.

WATER:

1. ALL WATER & BEDDING MATERIALS TO MEET MMCD & BC PLUMBING CODE 2018 REQUIREMENTS.

ROADWORKS AND SIDEWALKS:

1. LOOSE OR ORGANIC MATERIALS SHALL BE EXCAVATED FROM ROADWAY.
2. SUB-BASE AND GRANULAR BASE MATERIALS SHALL BE COMPACTED TO 95% MODIFIED PROCTOR DENSITY.
3. EXISTING APPURTENANCES SUCH AS VALVE BOXES, MANHOLES, ETC., SHALL BE ADJUSTED TO FINISHED GRADE.
4. THE CONDITIONS FOR PLACING ASPHALT PAVEMENT AND CONCRETE SHALL BE IN ACCORDANCE WITH MMCD SPECIFICATIONS AND STANDARD DETAIL DRAWINGS APPLICABLE AT THE TIME OF CONSTRUCTION. WEATHER CONDITIONS SHALL ALSO BE IN CONFORMANCE WITH MMCD SPECIFICATIONS. SHOULD DEVIANCES BE ALLOWED FROM THESE SPECIFICATIONS BY THE CITY'S REPRESENTATIVE, THE CONTRACTOR SHALL ASSUME ALL RESPONSIBILITY FOR THEIR WORKMANSHIP.

NOTICE TO CONTRACTOR

IT IS THE RESPONSIBILITY OF THE CONTRACTOR'S SURVEYOR TO VERIFY THAT ALL LEGAL SURVEY DIMENSIONS SHOWN ON THE ENGINEERS DRAWINGS AGREE WITH THOSE ON THE REGISTERED LEGAL SURVEY PLAN. SHOULD THERE BE ANY DISCREPANCIES, THEN IMMEDIATELY NOTIFY THE ENGINEER OF RECORD

LEGAL DESCRIPTION: SITE PLAN OF AMENDED LOT 14 (DD 106561 I), LOTS 15 & 16, LOT 2, PLAN VIP75915 OF SUBURBAN LOT 15				
B.M. MONUMENT NO. 16-64A ELEVATION: 27.355m				
LOCATED AT COOK STREET & PANDORA AVENUE				
REV. NO.	DESCRIPTION	DR	CH	DATE
03	DEVELOPMENT PERMIT COMMENTS ADDRESSED	CL	SL	11/09/19
04	ISSUED FOR 60% BP SUBMISSION	VG	SL	15/10/19
05	ISSUED FOR 90% BP SUBMISSION	VG	SL	06/11/19
06	ISSUED FOR 100% BP SUBMISSION	VG	SL	25/11/19
07	TREE REMOVED ON COOK STREET	CL	SL	20/03/20



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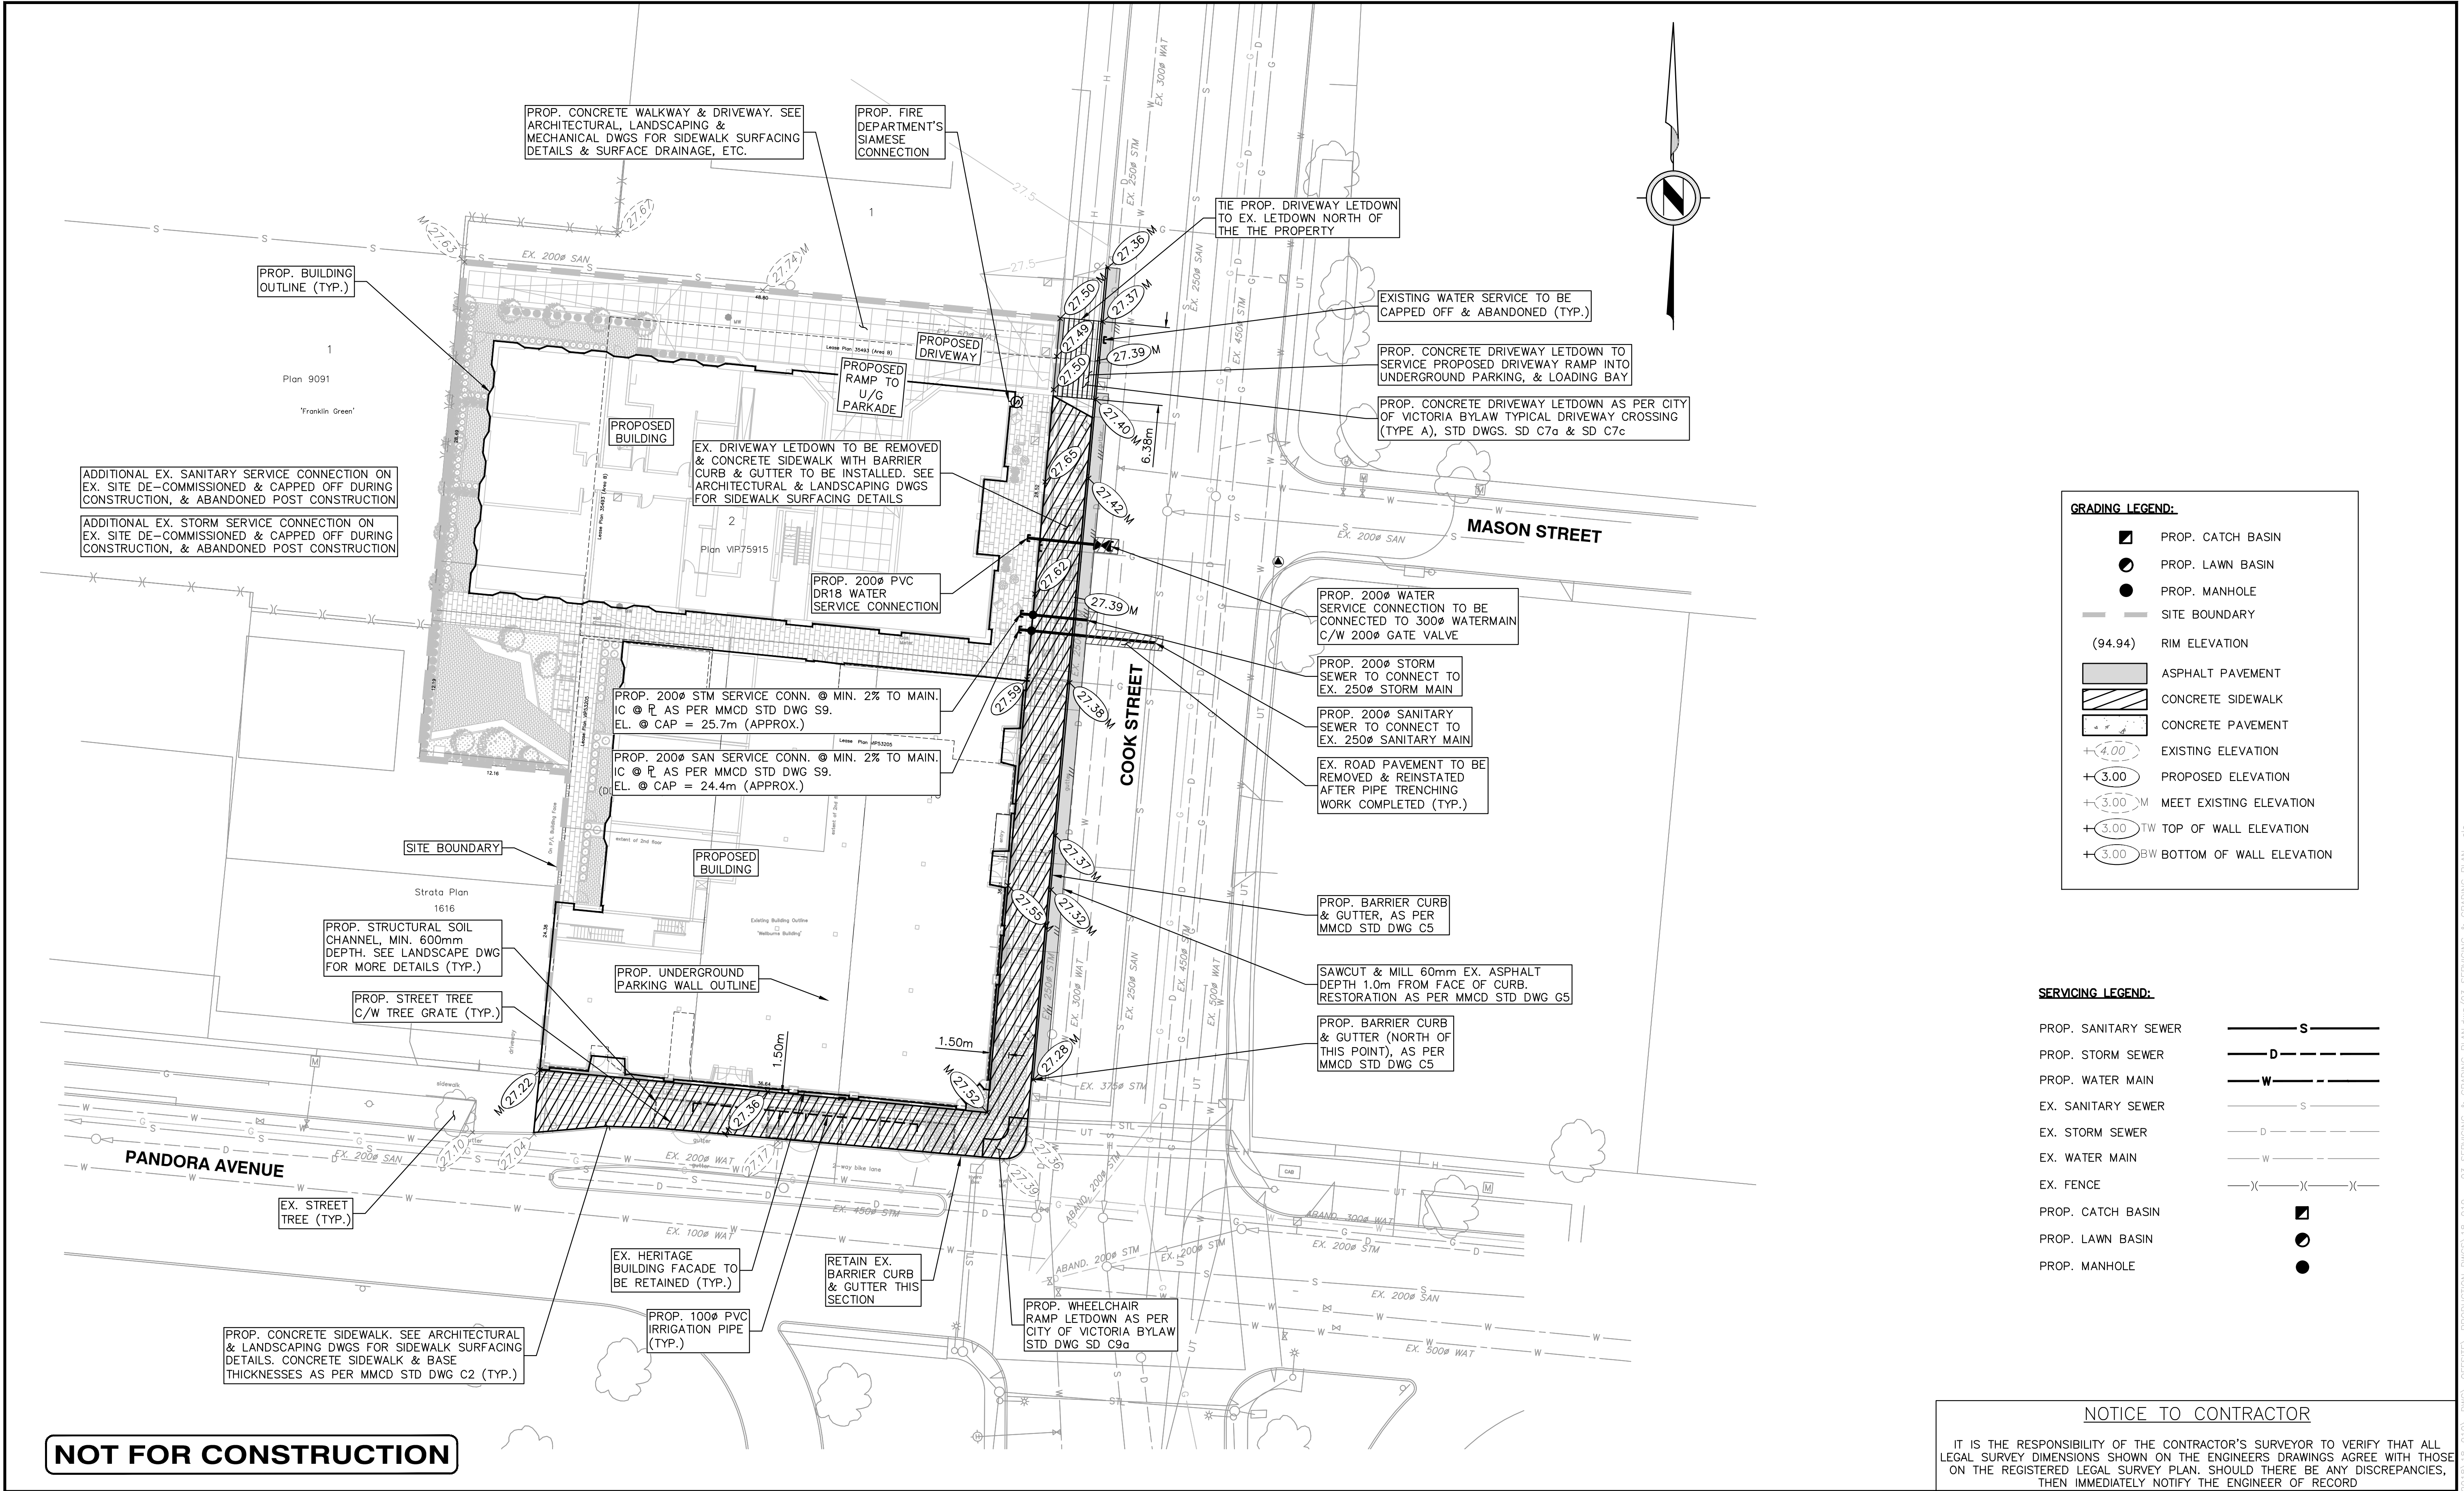
CLIENT:	DISTRICT GROUP SUITE 200 - 8809 HEATHER STREET, VANCOUVER, BC V6P 3T1 PH. 604-322-5762
PROJECT:	PARKWAY - MIXED USE DEVELOPMENT 1050 PANDORA AVENUE & 1518 COOK STREET, VICTORIA BC



The location of existing underground utilities are shown in an approximate way only & have not been independently verified by the owner or its representative. The contractor shall determine the exact location of all existing utilities before commencing work, and agree to be fully responsible for any and all damages which might be occasioned by the contractor's failure to exactly locate and preserve any and all underground utilities.

TITLE: KEY PLAN & GENERAL NOTES		DESIGN: VG DRAWN: VG/CL	CHECK: SL APPR: SL
PROJECT NO. .		A & M FILE: 18-010	
DRAWING NO. .		SCALE : HORZ. 1:500 VERT. N/A	DRAWING DATE: FEBRUARY 2019
		A & M DRAWING NO. 18-010 -02	SHEET NO. 02 OF 04
			REV. 07

0 5 1:500 25m



LEGAL DESCRIPTION: SITE PLAN OF AMENDED LOT 14 (DD 106561 I), LOTS 15 & 16, LOT 2, PLAN VIP75915 OF SUBURBAN LOT 15				
B.M. MONUMENT NO. 16-64A ELEVATION: 27.355m				
LOCATED AT COOK STREET & PANDORA AVENUE				
REV. NO.	DESCRIPTION	DR	CH	DATE
03	DEVELOPMENT PERMIT COMMENTS ADDRESSED	CL	SL	11/09/19
04	ISSUED FOR 60% BP SUBMISSION	VG	SL	15/10/19
05	ISSUED FOR 90% BP SUBMISSION	VG	SL	06/11/19
06	ISSUED FOR 100% BP SUBMISSION	VG	SL	25/11/19
07	TREE REMOVED ON COOK STREET	CL	SL	20/03/20



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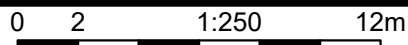
CLIENT:
DISTRICT GROUP
SUITE 200 - 8809 HEATHER STREET, VANCOUVER, BC V6P 3T1
PH. 604-322-5762


PROJECT:
PARKWAY - MIXED USE DEVELOPMENT
1050 PANDORA AVENUE & 1518 COOK STREET, VICTORIA BC




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TITLE: SERVICING & GRADING PLAN		DESIGN: VG	CHECK: SL
		DRAWN: VG/CL	APPR: SL
		A & M FILE: 18-010	
PROJECT NO. .		DRAWING DATE: FEBRUARY 2019	
DRAWING NO. .		SHEET NO. 03 OF 04	REV. 07




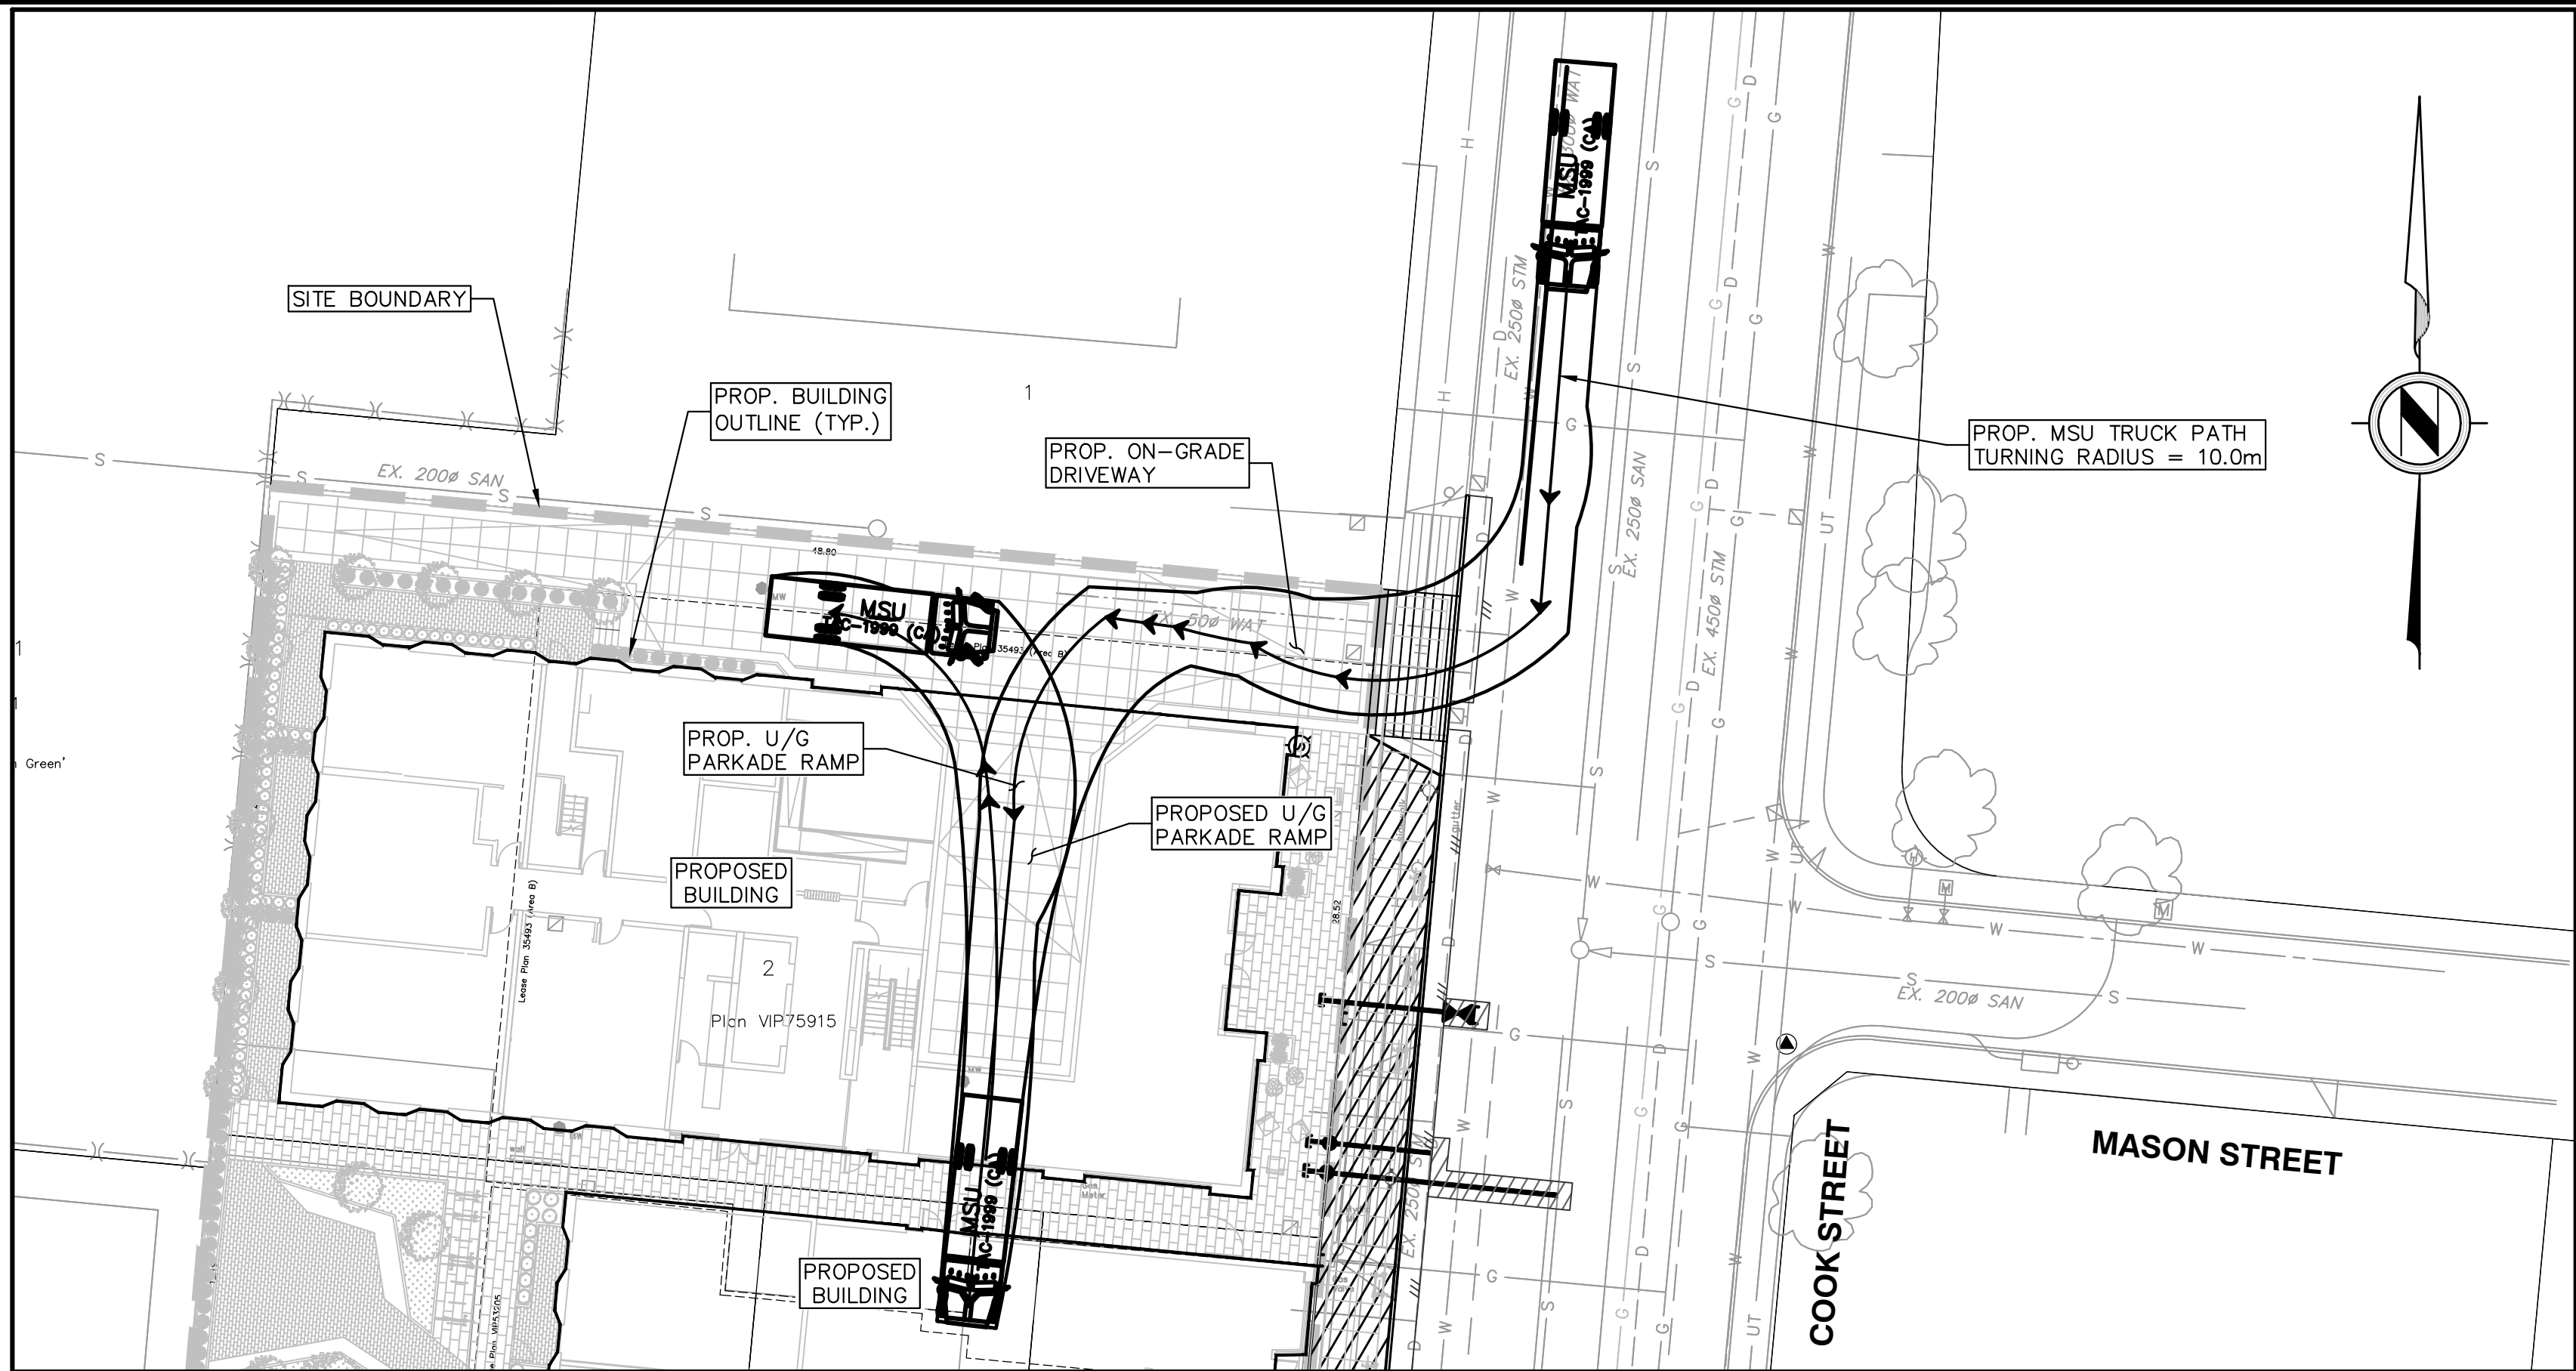

TURN ROUTE 1 – DIRECT ENTRY

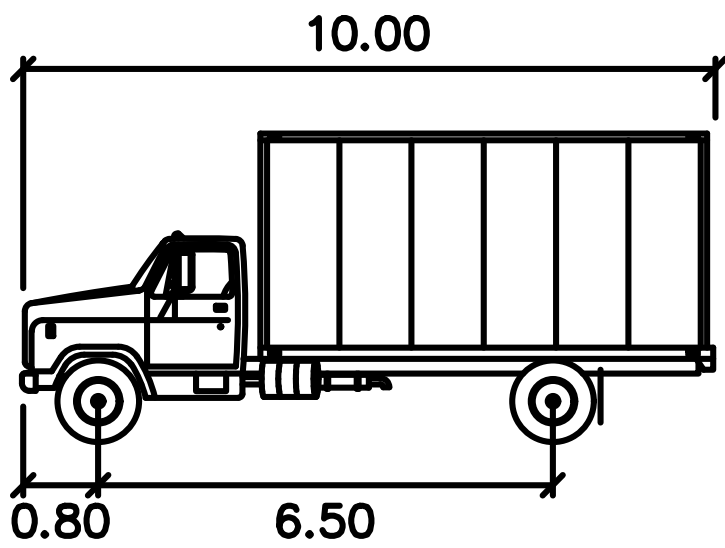

MSU	meters
Width	: 2.60
Track	: 2.60
Lock to Lock Time	: 6.0
Steering Angle	: 40.2

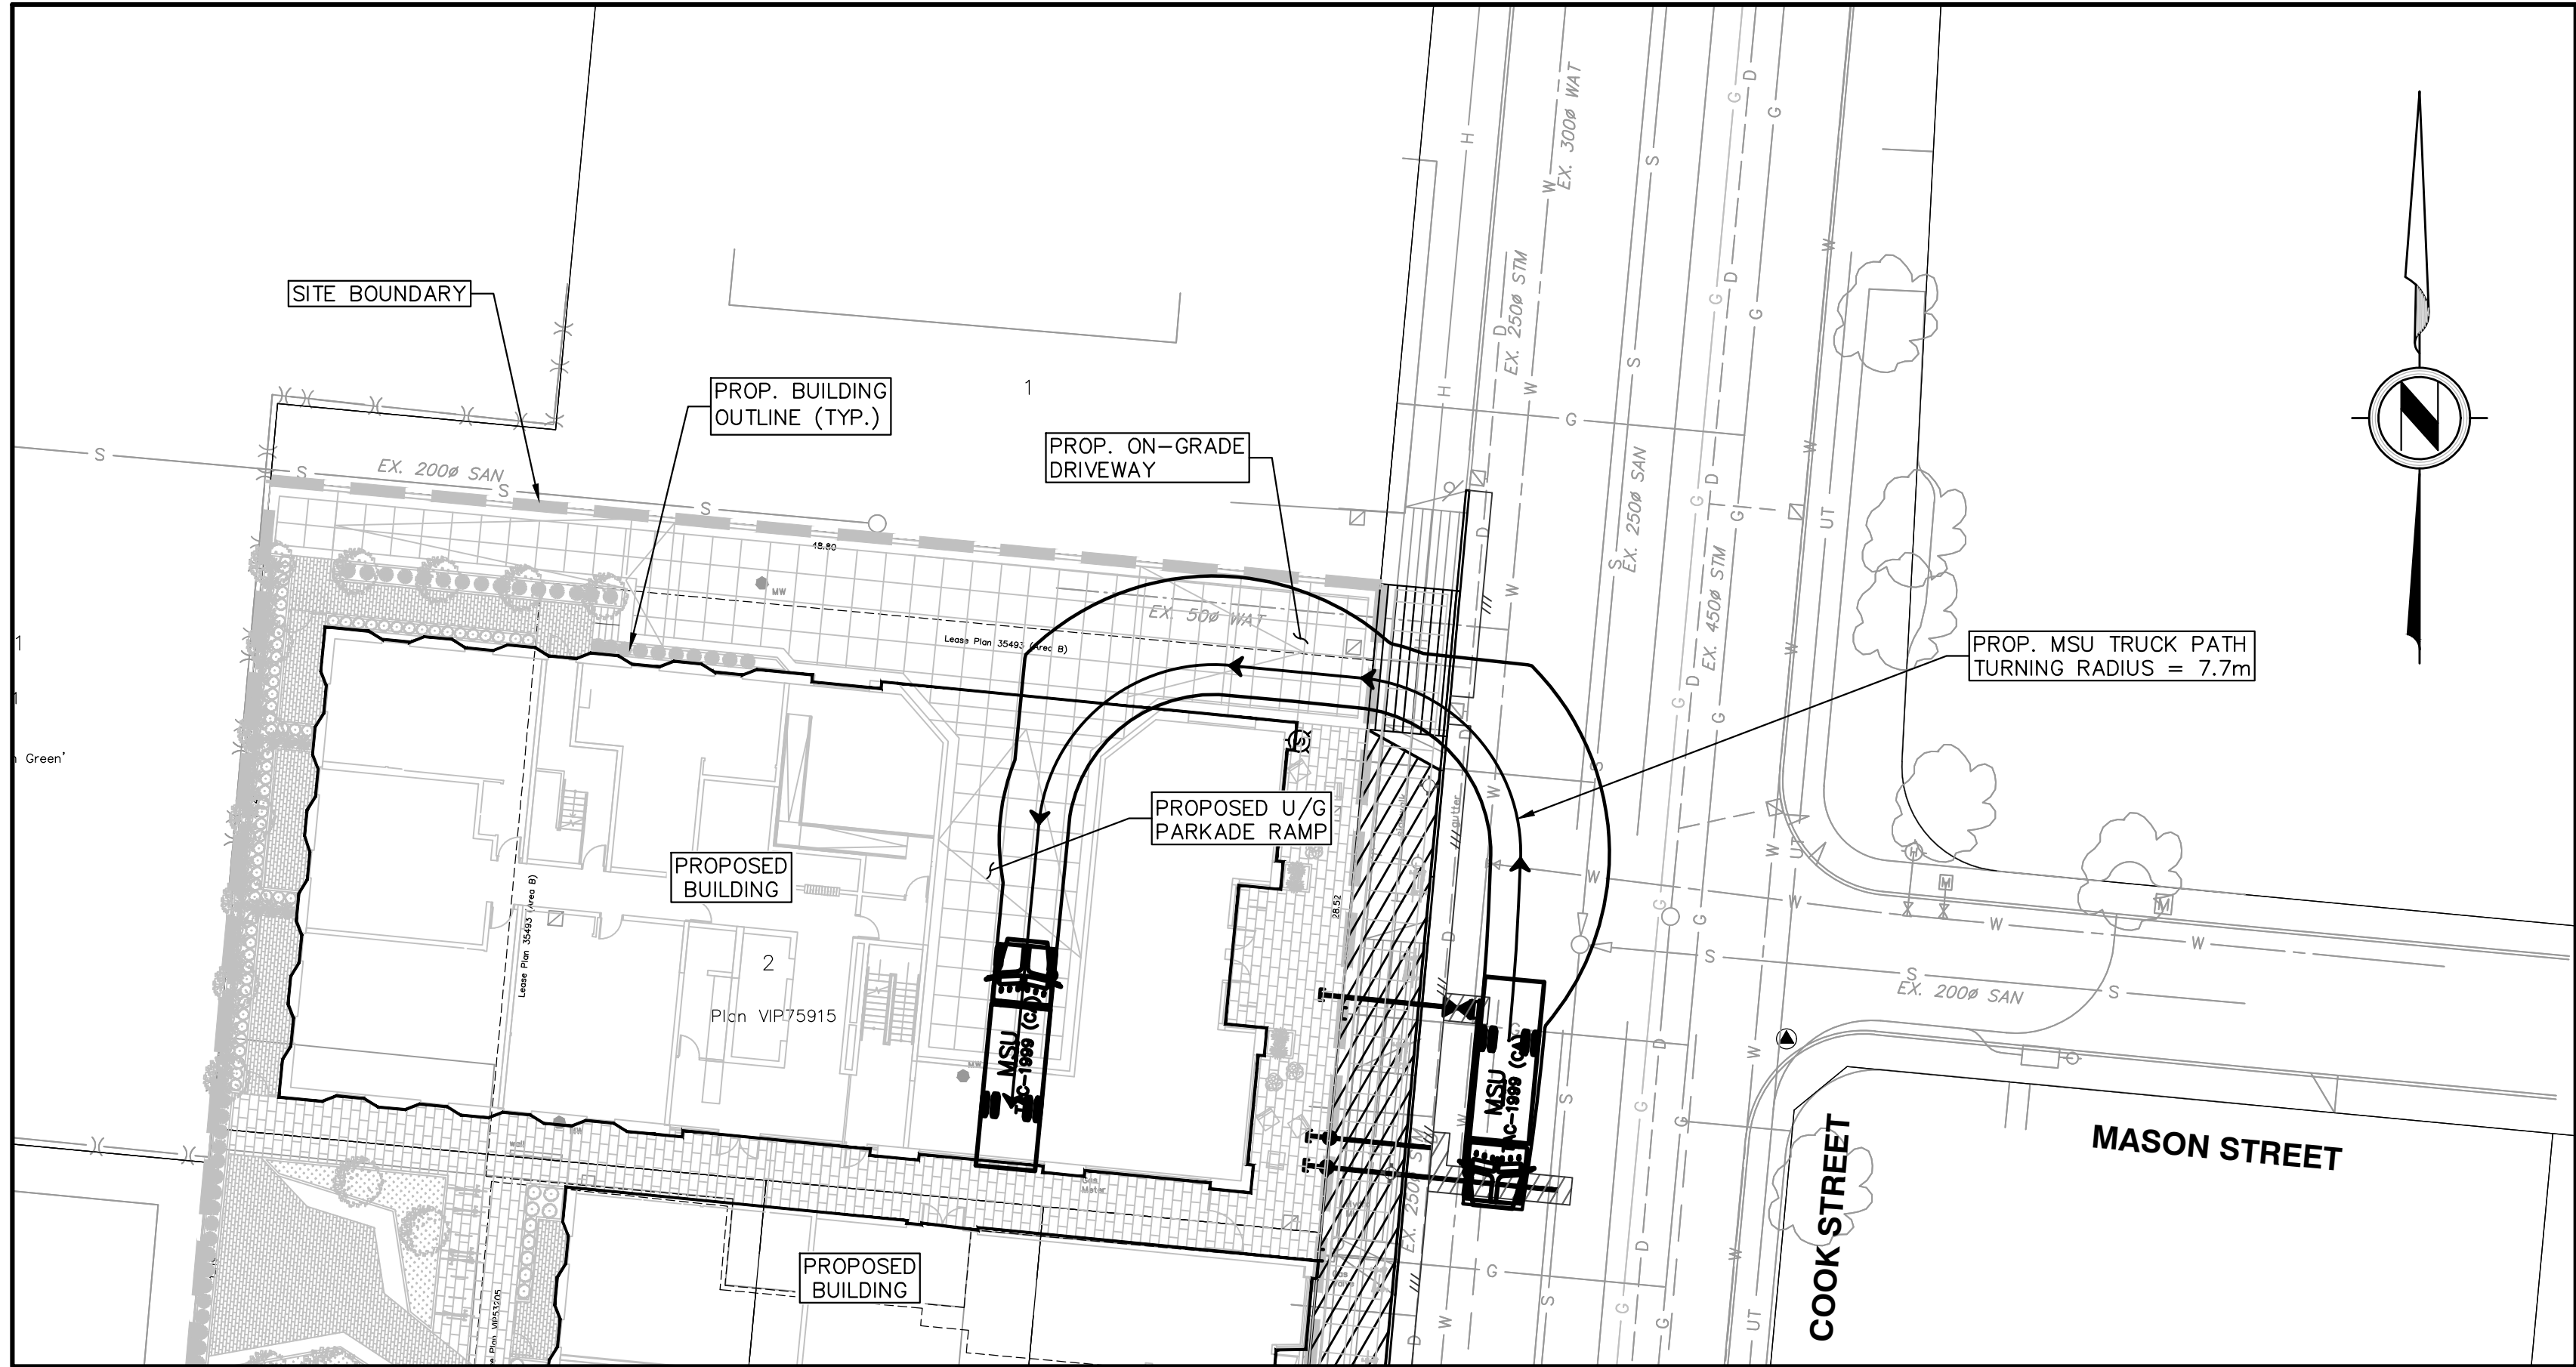

TURN ROUTE 1 – BACK-IN ENTRY

NOT FOR CONSTRUCTION

NOTICE TO CONTRACTOR

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LEGAL DESCRIPTION: SITE PLAN OF AMENDED LOT 14 (DD 106561.1), LOTS 15 & 16, LOT 2, PLAN VIP75915 OF SUBURBAN LOT 15					
B.M. MONUMENT NO. 16-64A ELEVATION: 27.355m					
LOCATED AT COOK STREET & PANDORA AVENUE					
REV. NO.	DESCRIPTION	DR	CH	DATE	APP
03	DEVELOPMENT PERMIT COMMENTS ADDRESSED	CL	SL	11/09/19	SL
04	ISSUED FOR 60% BP SUBMISSION	VG	SL	15/10/19	SL
05	ISSUED FOR 90% BP SUBMISSION	VG	SL	06/11/19	SL
06	ISSUED FOR 100% BP SUBMISSION	VG	SL	25/11/19	SL
07	TREE REMOVED ON COOK STREET	CL	SL	20/03/20	SL



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CLIENT:	DISTRICT GROUP SUITE 200 - 8809 HEATHER STREET, VANCOUVER, BC V6P 3T1 PH. 604-322-5762
PROJECT:	PARKWAY - MIXED USE DEVELOPMENT 1050 PANDORA AVENUE & 1518 COOK STREET, VICTORIA BC



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TITLE: TRUCK TURNING PLAN		DESIGN: VG	CHECK: SL
		DRAWN: VG/CL	APPR: SL
		A & M FILE: 18-010	
PROJECT NO. .		DRAWING DATE: FEBRUARY 2019	
DRAWING NO. .		SHEET NO. 04 OF 04	REV. 07

0 2 1:250 12m