

937 View Street

■LIST OF DRAWINGS

ARCHITECTURAL

LANDSCAPE

L1.01 Landscape Materials
L1.02 Stormwater Management
L3.01 Pranting Plan - Level 1
L3.02 Planting Plan - Levels 2 an

View Street

Residential 937 View Street

Cover July



Revisions Received Date August 17, 202

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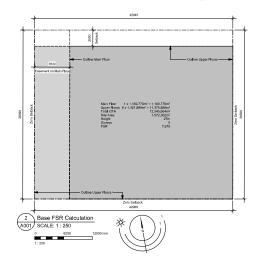
The following	ABBREVIATIONS g abbreviations are used on door, window drawings and details.	, and finish schedules	s as well as on			The followin	ATIONS LEGEND g annotations are used on
ACST ACF AFF AL AO AP BG CEM CORK CUL CT CT OW DO EB EL	Acordo Stucco Acoustical Tile Abore Finished Rocy Allorismos Annotation Finish Building Grade Annotation Finish Building Grade Concrete Concrete Block Concrete Concrete Block Concrete	HIG HM HP HSS HWY INSUL LAM LP MDFB MR MP OH OW PF LAM PLS PSF	Handidao Holan Malal Holan Malal Holan Malal Holan Sala Saction Insulated Lamrade Glass Lamrade Glass Marca Medium Denisy Pitroboard Base Marca Medium Denisy Pitroboard Base Marca Patricia Malal Medium Denisy Pitroboard Base Marca Patricia Canada Patricia Lamrade Patricia Lamra	SPC ST STL STN STNT STNT SS SVF TB TD TLAM TGL TGC TGC TGC TGC TGC TGC TGC	Sold Participhonal Core Structure St	architectural BEDROOM 201 4039 W-10	creamings and depails ROCAN NAME S ROCAN N
EPC EV EXP AGG EXT FD FEC FRE FG GBL	Epoxy Polymer Coating Electric Vehicle Parking Exposed Aggregate Esterior Floor Drain Fire Estinguisher Cabinet Finished Godd Grab Bar Glass Black	PT PTD PTDW PTW RA RB RES RD RD-P RWL	Paint Pager Towel Dispenser Pager Towel Dispenser / Waste Pager Towel Dispenser / Waste Roof Anchor Routber Base Rosilent Piporing Roof Orain - Planter Rain Waste Raine Pager Planter Raine Planter Raine Waste	TOW TP UNF UNO UIS VCT VII VIS VT	Top of Wall Total Paper Unfinitized Cov GWB means sloped and Had by not sanded to minimum U.C. Departments where applicable) Unfinitized Commentation Unformation of Why In Composition Tile Wiston Class Wing Impact Sheet	2440	ELEVATION DATUM CEILING HEIGHT
GWG GWB HC HCW	Glass Georgian Wire Glass Gypsum Walboard Hollow Core Hollow Core Wood	SAFI SCW SD SL SP	Spray Applied Fibrous Insulation Skild Core Wood Scap Dispenser Sealer Spandrel Glass	WC WC WD WPM WRC	Virgi Well Covering Water Cleant Wood Wood Waterproof Membrane Water Ropellant Coging	222	AREA OF DROP CEILING KEYNOTE SYMBOL
						12 1 (A901)	MATERIAL TAG INTERIOR ELEVATION REFERENCE
						W1C1F1B	ROOM FINISHES

PROJECT DESCRIPTION CIVIC ADDRESS: 937 VIEW STREET, VICTORIA, BC. LEGAL DESCRIPTION: LOT A, OF LOTS 785, 785, and 787, VICTORIA CITY, PLAN 36505 ZONING BYLAW SUMMARY USES: RESIDENTIAL EXISTING ZONE: R-48 HARRIS GREEN PROPOSED ZONE: R-48 DEVELOPMENT PERMIT AREA: DPA 713 (HC) SITE AREA: 1 572,3 m² (16 924 s.f.) TOTAL PROPOSED: 12 504 17 m² (134 595 s.f.) FLOOR SPACE RATIO: 7,95 FSR SITE COVERAGE: OPEN SITE SPACE: GRADE OF BUILDING: 17.7 m (GEODETIC AVG GRADE) See Site Plan for Grade Calculations HEIGHT OF BUILDING: 54.0 m NUMBER OF STOREYS: 18 STOREYS 267 SUITES RESIDENTIAL PARKING: N/A COMMERCIAL PARKING: N/A

PROJECT DIRECTORY Chris Nelson tel: 604.318.6877 FLOOR AREA: RESIDENTIAL Level 1: RESIDENTIAL Level 2: RESIDENTIAL Level 3: RESIDENTIAL Level 1: RESIDENTIAL Level Jamie Clarke tel: 250.384.4128 jclarke@avalonmechanical.com Shane Moore tel: 250.475,3131 fax: 250.475,3611 | BICYCLE PARKING: | Required Long Term: (S1 x 1.25) + (216) = 290 | 290 | 290 BUILDING CODE SUMMARY


REFERENCED DOCUMENTS: BRITISH COLUMBIA BUILDING CODE 2018 - PART 3 CANADIAN STANDARDS ASSOCIATION 8651-18 MAJOR OCCUPANCY CLASSIFICATION GROUP C - RESIDENTIAL BUILDING AREA: 12 504,17 m² (134 595 s.f.) BUILDING HEIGHT: 18 STOREYS NUMBER OF STREETS FACING: ACCESSIBLE FACILITIES
ACCESSIBLE ENTRANCE

ADDITIONAL REQUIREMENTS FOR HIGH BUILDINGS Ref. 3.2.8.1 (1)(d)






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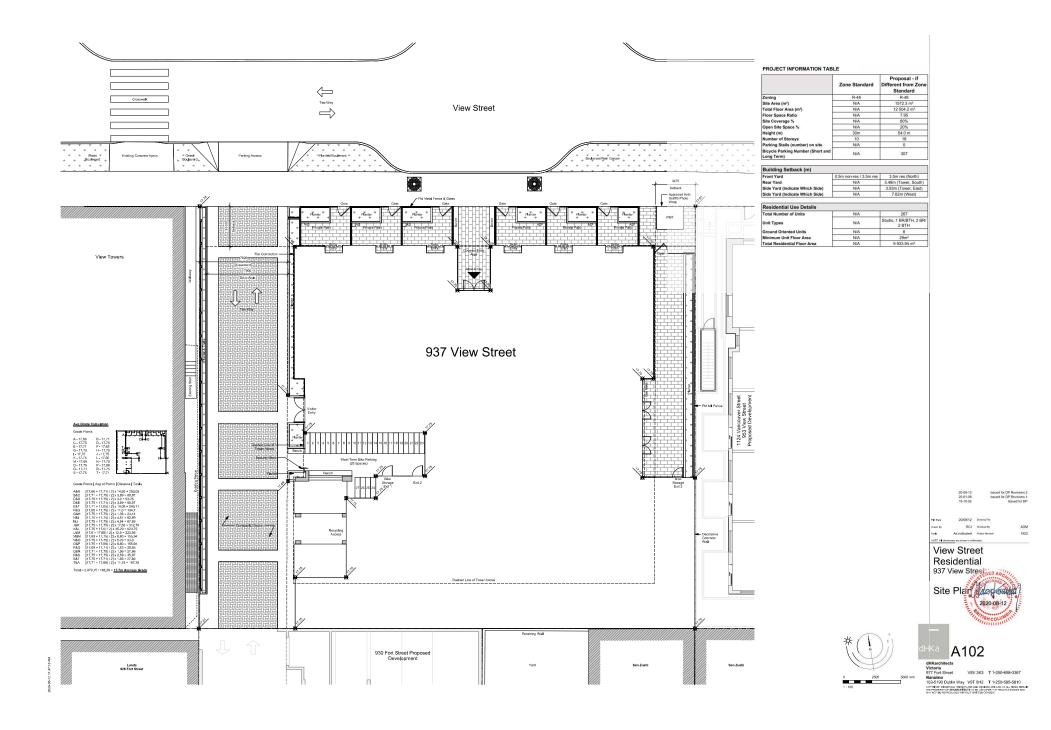


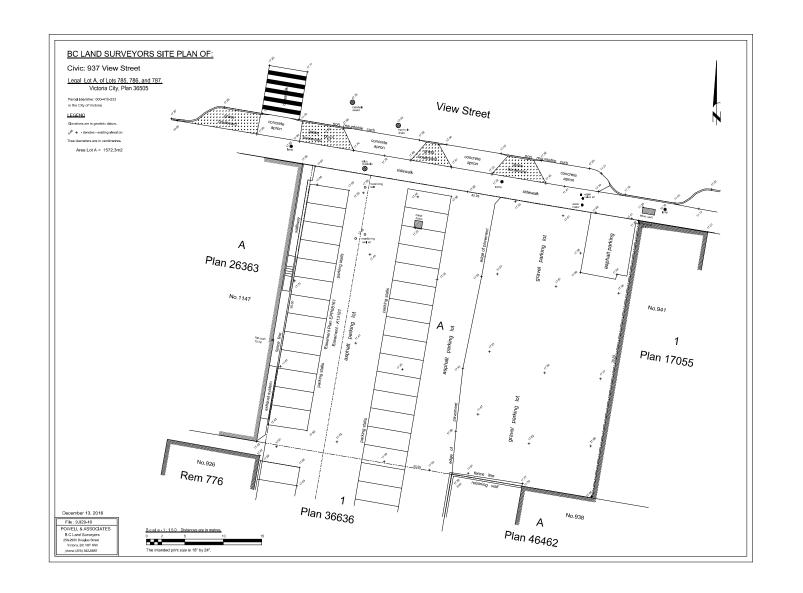
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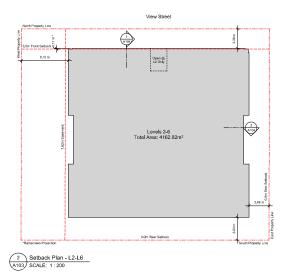



View Street Residential 937 View Street

A101

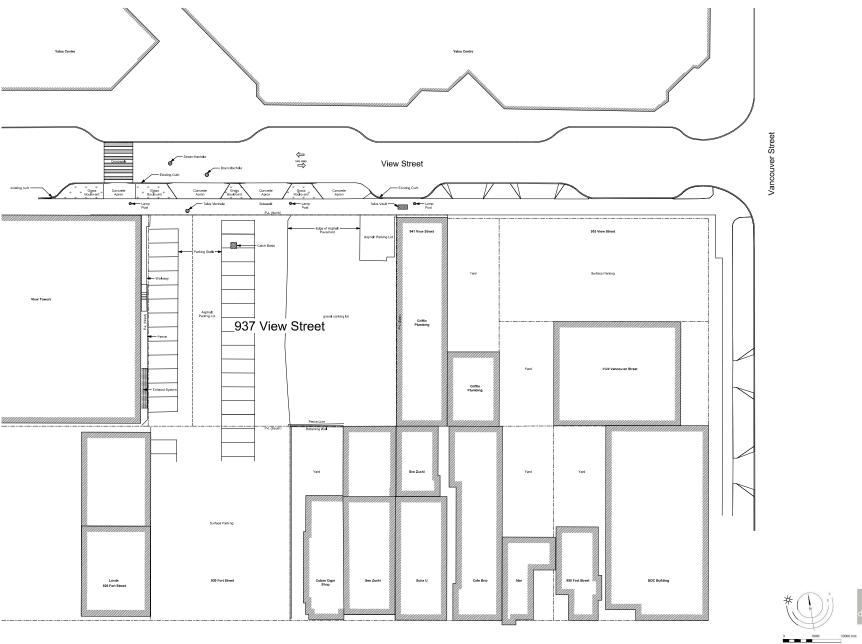





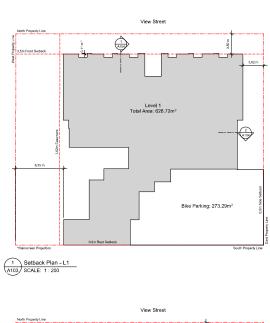

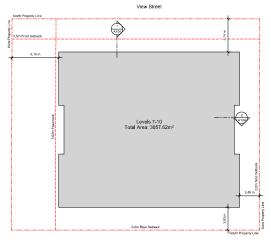

3 Setback Plan - L7-L10 A103 SCALE: 1:200

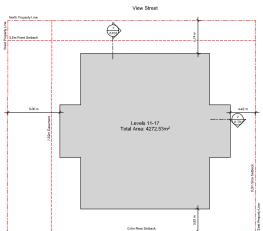

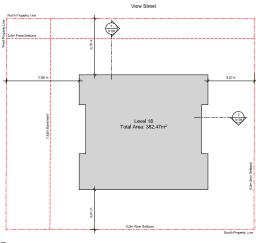


5 Setback Plan - L18 A103 SCALE: 1:200

View Street Residential 937 View Street Setback Flam


A103

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102-5190 Dubin Way V9T 0H2 T 1:250-585-5810
Control of the Control of

4 Setback Plan - L11-L17 A103 SCALE: 1:200

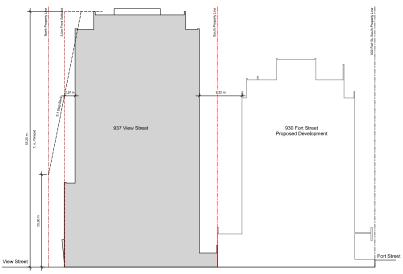

1 Building Separation Section - North/South SCALE: 1 : 250

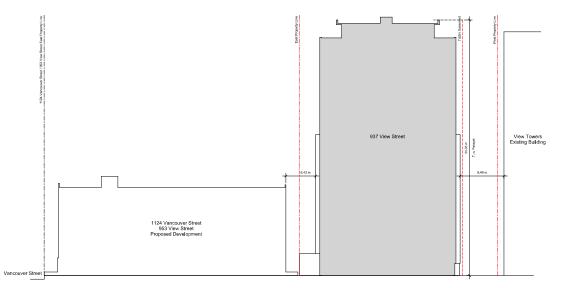

2 Building Separation Section - West/East A104 SCALE: 1 : 250

General Notes

- 930 Fort Street outline based on Development Permit 5th Resulpmission dated 2018 05-18.

RCI Checked by
As indicated Project Number


View Street


Residential 937 View Street AA Setback Alaticoup





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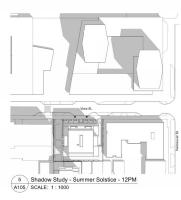
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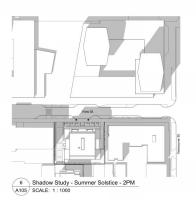





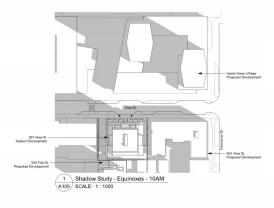


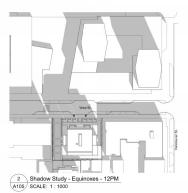


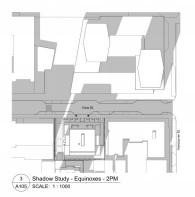

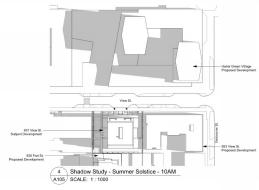

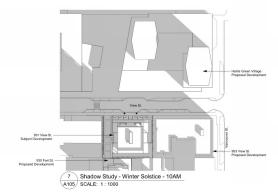

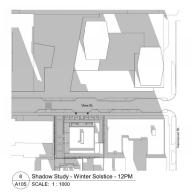

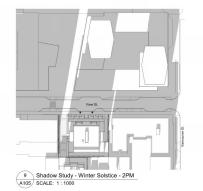





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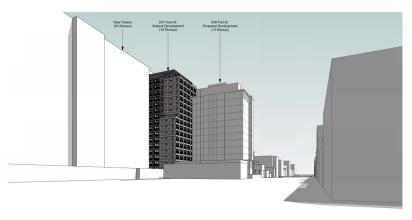
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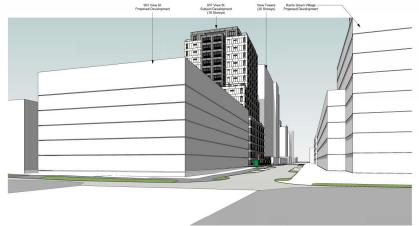


View Street Residential 937 View Street Site Contract Green mpagatos taudy


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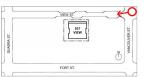






1 Street Perspective - Fort & Quadra - SW Corner A107 SCALE:




2 Street Perspective - View & Vancouver - NE Corner SCALE:

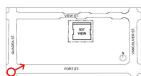

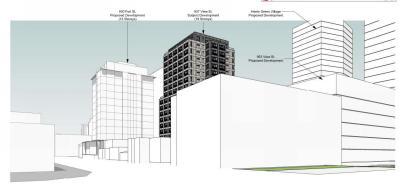


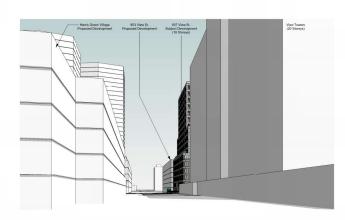

3 Street Perspective - Fort & Vancouver - SE Corner SCALE:

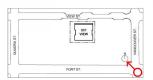

4 Street Perspective - View & Quadra - NW Corner SCALE:

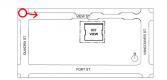

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NOTE: All dimensions are shown in millimeters.

View Street RCI Checked by 1:2000 Project Number Residential 937 View Street Site Continue Views 2020-08-12

A107

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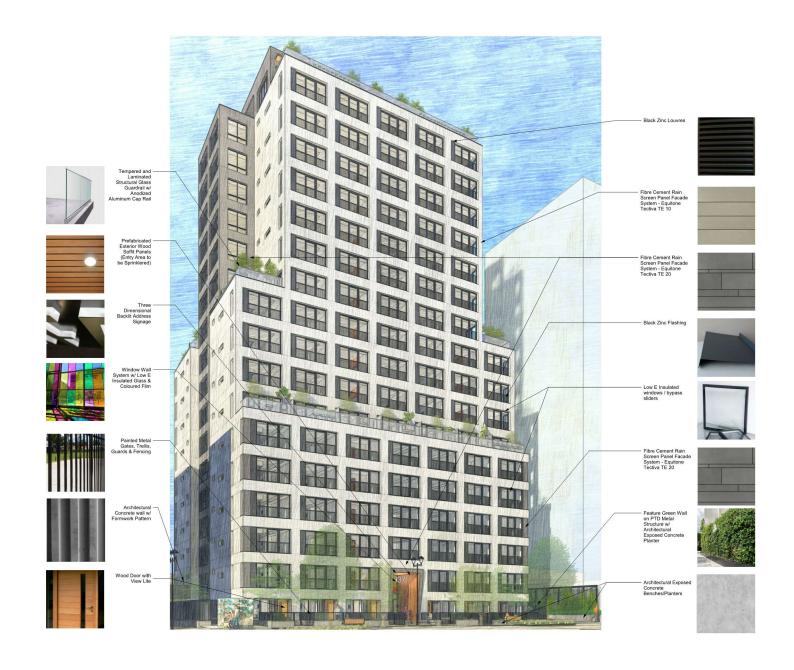


1 Street Elevation A108 SCALE: 1 : 300

RCI Checked By View Street Residential 937 View Street Site Contraction Site Contraction Site 2020-08-12

A108

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View Street Residential 937 View Street

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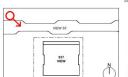
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102-5190 Dublin Way V9T 0H2 T 1-250-585-5810



1 Perspective Render - Looking Southeast SCALE: 1:1





Perspective Rendering - Crosswalk
A110 SCALE: 1:1





3 Perspective Rendering - Looking Southwest A110 SCALE: 1:1



View Street Residential 937 View Street

Site Contact Sociologic

A110

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Perspective Rendering - Main Entry
SCALE: 1:1




Perspective Rendering - Main Entry - Night

SCALE: 1:1





3 Perspective Rendering - Easement A1111 SCALE: 1:1

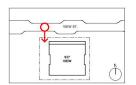



Perspective Rendering - Easement - Night
A111 SCALE: 1:1



View Street Residential 937 View Street Site Consideration

A111

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1036195 V9T 0H2 V9T 0H2 T 1:550-585-5810
1036195 V9T 0H2 V9T 0H



Perspective Rendering - Townhouses at Easement
A112 SCALE: 1:1





3 Perspective Rendering - Easement Looking at Bikes SCALE: 1:1





Perspective Rendering - Bikes and Garage
A112 SCALE: 1:1





4 Perspective Rendering - Parking from Garage
A112 SCALE: 1:1



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Perspective Rendering - L18 North Terrace
A113 SCALE: 1:1








Perspective Rendering - L18 Amenity
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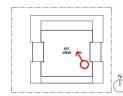


2 Perspective Rendering - L18 South Terrace SCALE: 1:1



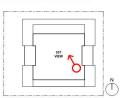

4 Perspective Rendering - L18 Fitness
SCALE: 1:1



View Street
Residential
937 View Street

A113

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Perspective Rendering - Overall - Night
A114 SCALE: 1:1




View Street Residential 937 View Street

Site Constitute Court
Rendered 2020:08-32

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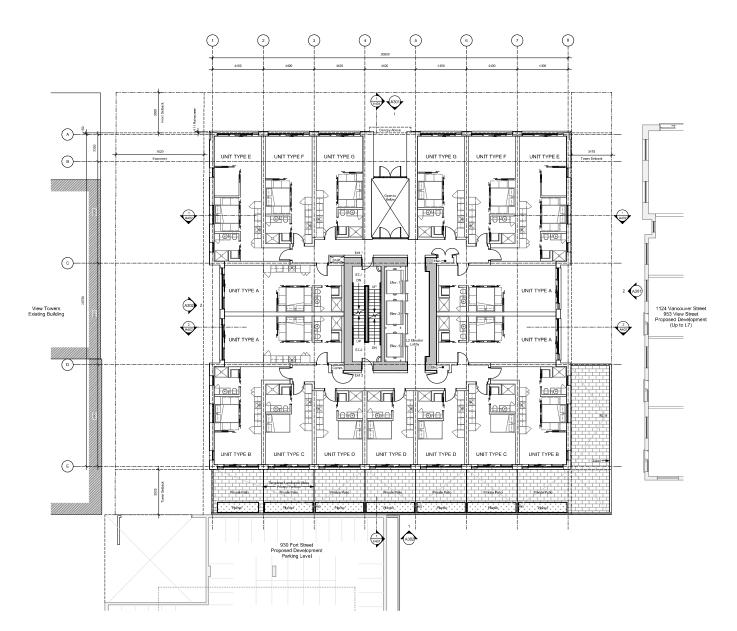
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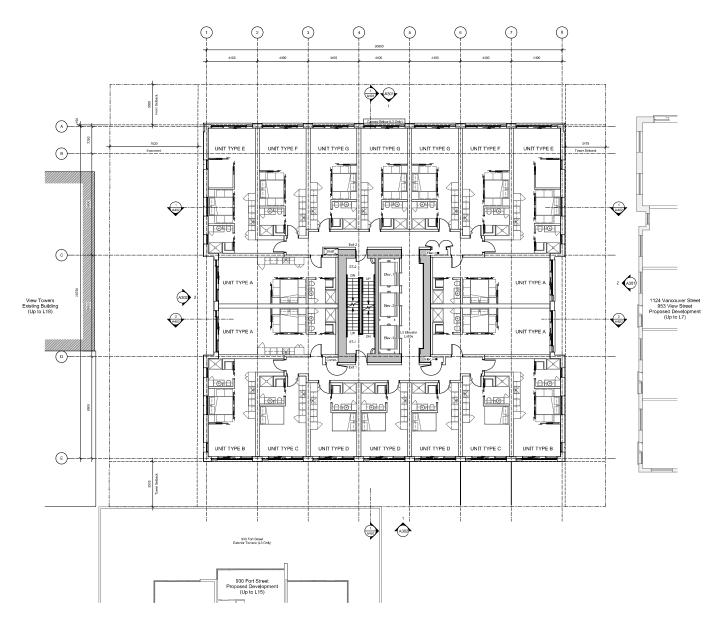
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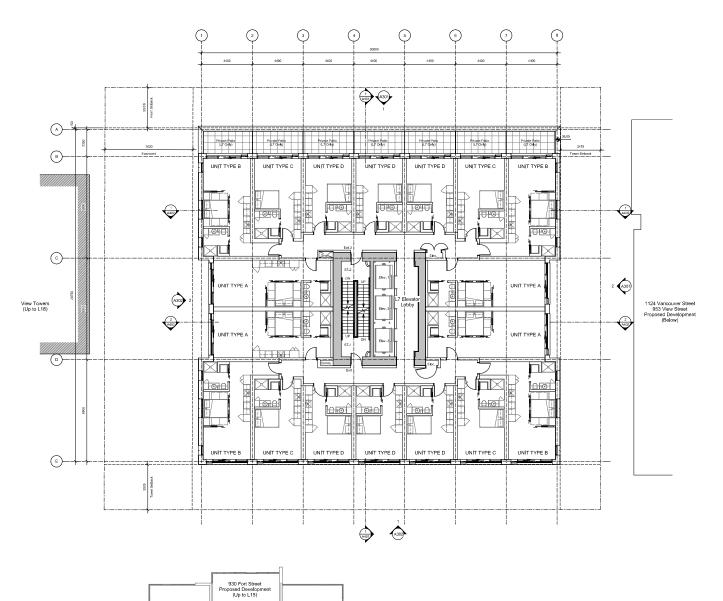


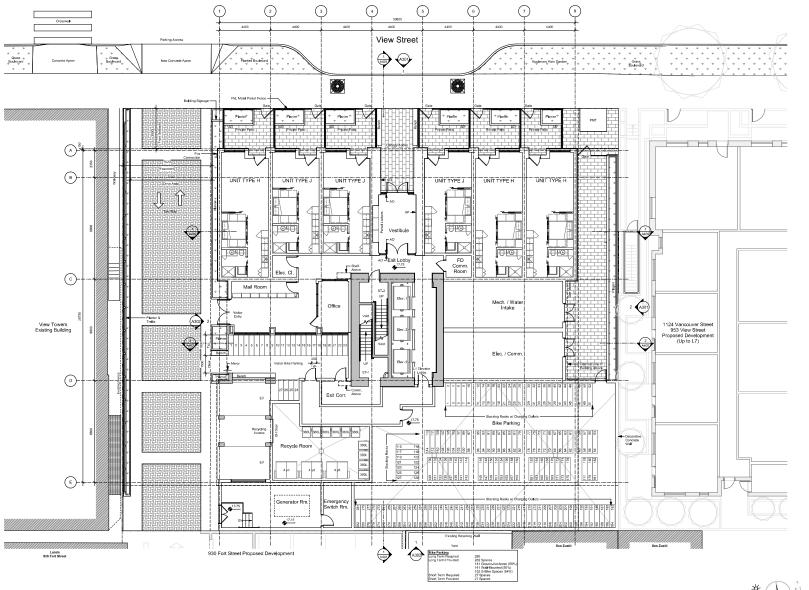

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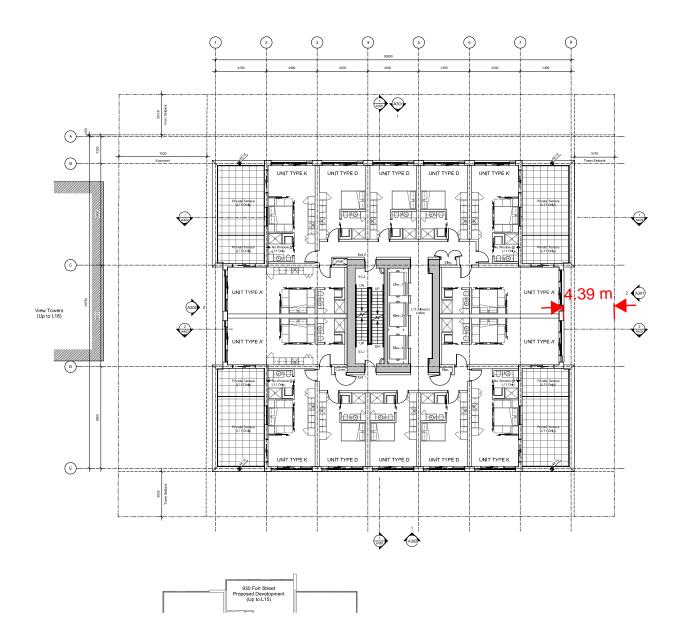
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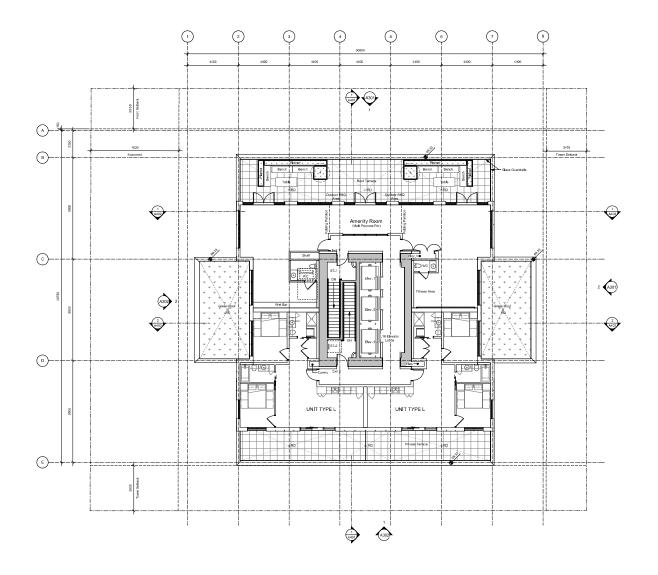








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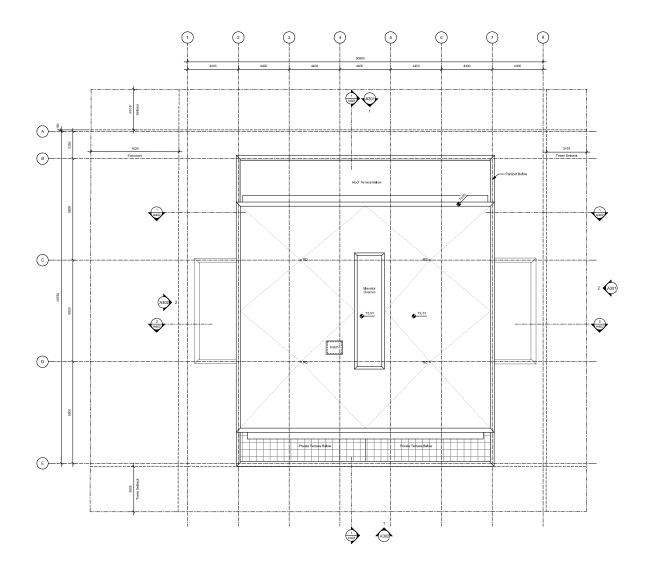








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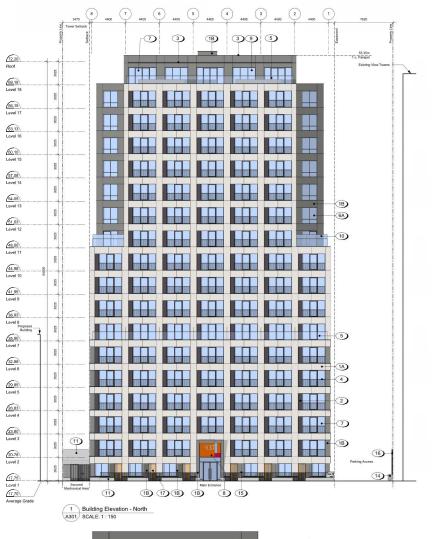



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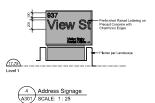
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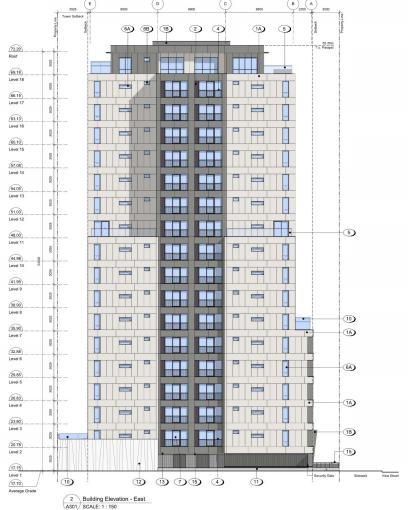
A 207

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Materials Schedule

1A) Fibre Cement Panel - Beige

1B) Fibre Cement Panel - Grey

2 Black Zinc Louvre

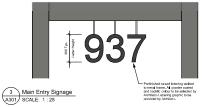11) Architectural Exposed Concrete

12 Decorative Concrete Wall

3 Smooth Face Concrete Masonry Units Stack Bond Painted Light Grey

14) Precast Concrete Planter

15) Painted Metal Fence

16) Metal Planting Support

17 Wood Door with View Lite

18 Sectional Aluminum Overhead Garage Door

RCI Checked By

View Street Residential

937 View Street SED 4 Building Hazakan

A301

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1A) Fibre Cement Panel - Beige

1B) Fibre Cement Panel - Grey

2 Black Zinc Louvre

11 Architectural Exposed Concret

12 Decorative Concrete Wall

13 Smooth Face Concrete Masonry Units Stack Bond Painted Light Grey

14) Precast Concrete Planter

15) Painted Metal Fence 16) Metal Planting Support

(17) Wood Door with View Lite

18 Sectional Aluminum Overhead Garage Door

RCI Checked By

View Street Residential

937 View Street AR Building Hazzation 2020-08-12




| HKarchitects | Victoria | 977 Fort Street | V8V 3K3 | T 1-250-658-3367 | V8namo | 102-5190 Dubin Way | V9T 0H2 | T 1-250-585-5810 |

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1 Building Section - North/South SCALE: 1: 150

General Notes

- 930 Fort Street outline based on Development Permit 5th Resulpmission dated 2018-05-16.

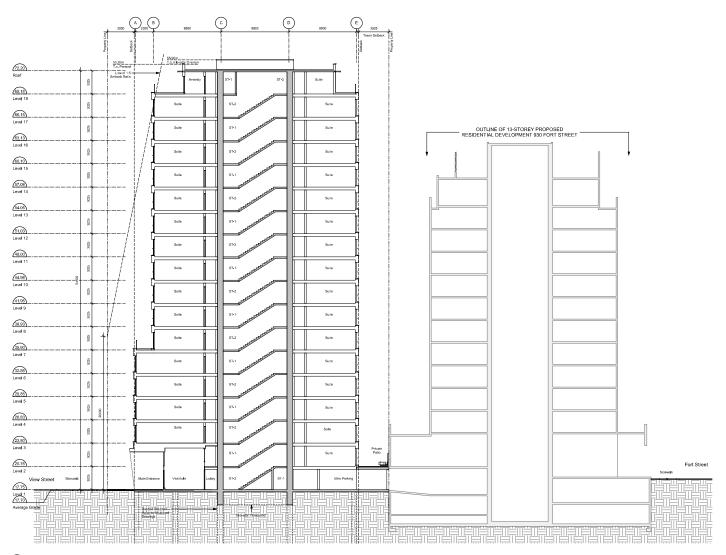RCI Checked by


View Street Residential


937 View Street Building Altrician



| HKarchitects | Victoria | 977 Fort Street | V8V 3K3 | T 1*250*658*3367 | Nanaimo | 102-5190 Dubin Way | V9T 0H2 | T 1*250*585*5810 |

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7 4400 6 4400 5 4400 4 4000 3 4400 2 4400

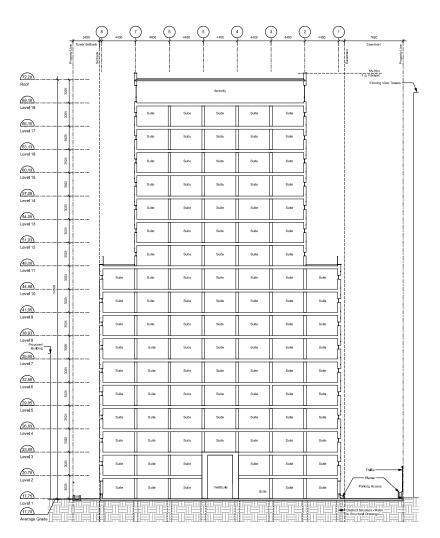Building Section - East/West 1 A402 SCALE: 1 : 150

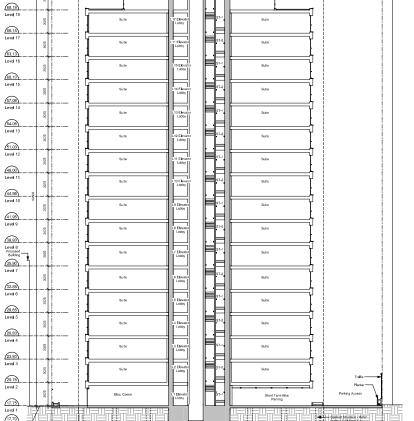Building Section - East/West 2

A402 SCALE: 1: 150

72.20

General Notes

55:35m T.o. Parapet

930 Fort Street outline based on Development Permit 5th Resulpmission dated 2018-05-16.

1124 Vancouver Street, 953 View Street, 94 View Street outline based on Development Permit Submission dated 2019-11-07.

RCI Checked by


View Street


Residential 937 View Street 46


Building Salatiscutt 2020-08-12

A402

| HKarchitects | Victoria | 977 Fort Street | V8V 3K3 | T 1-250-658-3367 | V8namo | 102-5190 Dubin Way | V9T 0H2 | T 1-250-585-5810 | COPYRIGHT PESSENIES, THESE PLANS AND DESIGNS ARE AND AT ALL TIMES REMAIN THE PROPERTY OF SHKARCHRISCES TO BE USED FOR THE PROJECT SHOWN AND MAY NOT SE RESPROQUEDOWN HOUT WHITTEN COMEST!

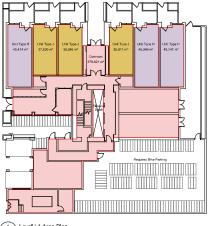

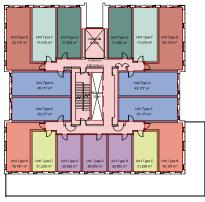

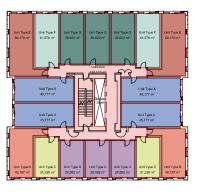


3 Level L3-L6 Area Plan A911 SCALE: 1:200

1 Level L1 Area Plan A911 SCALE: 1:200





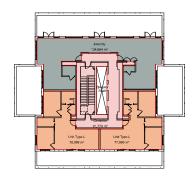

6 Level L18 A911 SCALE: 1:200

AREA SCHEDULE

Description	Zoning (m ²)	Zoning (SF)	No. Suites
Level 1			
City Zoning GFA	628.72 m ²	6768 SF	
Residential Strata	248.90 m²	2679 SF	6
Residential Common	379.82 m²	4088 SF	
Efficiency	39.59%	39.59%	1
Level 2			
City Zoning GFA	818.54 m ²	8811 SF	
Residential Strata	668.52 m²	7196 SF	17
Residential Common	150.03 m ²	1615 SF	
Efficiency	81.67%	81.67%	
Levels 3-6			
City Zoning GFA	836.07 m²	8999 SF	
Residential Strata	709.56 m ²	7638 SF	72
Residential Common	126.51 m ²	1362 SF	
Efficiency	84.87%	84.87%	1
Levels 7-10			
City Zoning GFA	764.41 m²	8228 SF	
Residential Strata	637.89 m²	6866 SF	72
Residential Common	126.51 m²	1362 SF	
Efficiency	83.45%	83.45%	
Levels 11-17			
City Zoning GFA	610.36 m²	6570 SF	
Residential Strata	495.81 m²	5337 SF	96
Residential Common	114.55 m²		
Efficiency	81.23%		
Level 18			
City Zoning GFA	382.47 m²	4117 SF	
Residential Strata	156.03 m ²	1679 SF	1
Residential Common	91.78 m ²		
Ammenity	134.66 m²		
Efficiency	76.00%	76.00%	
Totals			
Total GFA	12504.17 m²		
Site Area	1572.30 m ²		1
FSR	7.95	7.95	
Total Residential	9933.94 m²		267
Total Amenity	134.66 m²	1450 SF	
Total Commercial	0.00 m ²		
Total Common & Core	2435.57 m ²	26217 SF]
Efficiency	80.52%	80.52%	1

General Notes

Unit Schedule

Name	Area	Comments	Count
			:
UNIT TYPE A	41 m ^x	1 Bed / 1 Bath	38
UNIT TYPE A'	41 m*	1 Bed / 1 Bath	26
UNIT TYPE B	37 m²	1 Bed / 1 Bath	26
UNIT TYPE C	28 m²	Studio	26
UNIT TYPE D	26 m²	Studio	81
UNIT TYPE E	47 m²	1 Bed / 1 Bath	10
UNIT TYPE F	38 m²	1 Bed / 1 Bath	10
UNIT TYPE G	35 m²	1 Bed / 1 Bath	14
UNIT TYPE H	43 m²	1 Bed / 1 Bath	3
UNIT TYPE J	34 m²	1 Bed / 1 Bath	3
UNIT TYPE K	34 m²	1 Bed / 1 Beth	21
UNIT TYPE K	33 m²	1 Bed / 1 Beth	7
UNIT TYPE L	75 m²	2 Bod / 2 Bath	2
			267

RCI Checked By

View Street Residential 937 View Street


Area Plandarfaith

A911

| dHKarchitects | Victoria | 977 Fort Street | V8V 3K3 | T 1*250*658*3367 | Nanaimo | 102-5190 Dubin Way | V9T 0H2 | T 1*250*585*5810 | COPYRIGHT RESERVED. THESE PLANS AND DESIGNS ARE AND AT ALL TIMES REMAIN THE PROPERTY OF SHKARCHINGTS TO BE USED FOR THE PROJECT SHOWN AND MAY NOT BE REPRODUCED WITHOUT WRITTEN CONSENT.

Level L7-L10 Area Plan A911 SCALE: 1:200



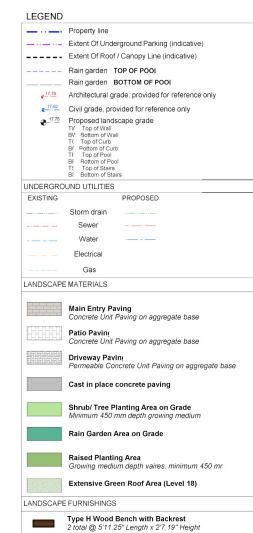



- ed work to meet the project specifications, and all standards or specification established in the lastest edition of the Canadian Landscape Standard and IIABC
- established in the lastest edition of the Caracater Lariascupe surround and many standards.

 2. Contractor to verify pressure and flow prior to installation of irrigation and notify owner representative in writing if such data adversely affects the operation of the system.

 3. Sleeves shall be installed at the necessary depths, prior to pavement construction. Sleeving shall extend 300 mm from edge of paving into planting area, and shall have ends marker above producings the submarker thanking them.
- shall extend 300 mm from eage or paying into planning deet, and shall nave ends market above grade unless otherwise shown.

 Utilities Contractor to verify location of all on-site utilities, prior to construction. Resoration of damaged utilities shall be made at the contractor's expense, to the satisfaction of the owner's representatives.

 Refer to mechanical drawings for irrigation point of connection.

 Refer to deectrical drawings for electrical service.

 Contractor to field fit irrigation system around existing trees, to limit disturbance to roccustems.

Type △: Modern Metal Bin

- systems.

 8. At various milestones during construction, inspection and testing of components will be required to ensure that the performance of irrigation system meets standards an specifications. Contractor to provide equipment and personnel necessary for performance of inspections and tests, Conduct all inspections and tests in the presence of the contract administrator. Keep work uncovered and accessible until successful completeition of the contractions and tests in the presence of the contractions are the contractions as the contraction of the contractions are the contractions as the contraction of the contractions are the contractions and tests are the contractions are the contractions and the contractions are the contractions are the contractions and the contractions are contracted as the contraction of the cont inspection or test.

 Trees within shrub or rain garden areas to be irrigated with spray heads.

- DRAWING NOTES
 1. DO NOT SCALE DRAWING: Verify all property lines and existing structures/vegetation to remain, prior to commencing verk.
 2. All plan dimensions in metres and all detail dimensions is
- millimetres.

 3. Plant quantities on Plans shall take precedence over plant lis

- quantities.
 Contractor to confirm location and elevation of all existing services and utilities prior to start of construction.

- services arta utilities prior to start of construction.

 5. Provide layout of all work for approval by Landscape Architec prior to proceeding with work.

 6. Contractor to provide irrigation system for all planters to currer IIABC Standards and Contract Specifications.

 7. Landscape installation to carry a 1 year warranty from date consequence.
- acceptance. 8. Plant material installation and maintenance to conform to the
- current edition of the Canadian Landscape Standard.

 9. General Contractor and/or sub-contractors are responsible for a
- costs related to production and submission to consultant of a landscape as-built information including irrigation.

 10. Tree protection fencing, for existing trees, to be installed prior to commencement of all site work



4	Dev Permit Revisions	20.08.11
3	Issued for DP revisions	20.01.08
2	DP REV	19.10.17
1	DEV PERMIT	17.07.07
rev no	description	date



2020-08-12

NELSON INVESTMENTS, INC.


VIEW STREET RESIDENTIAL 937 VIEW STREET VICTORIA, BC

Landscap Materials

	119.24
AS NOTED	@ 24"x36"
	ML
	AS NOTED

SM/PdG

L1.01 4

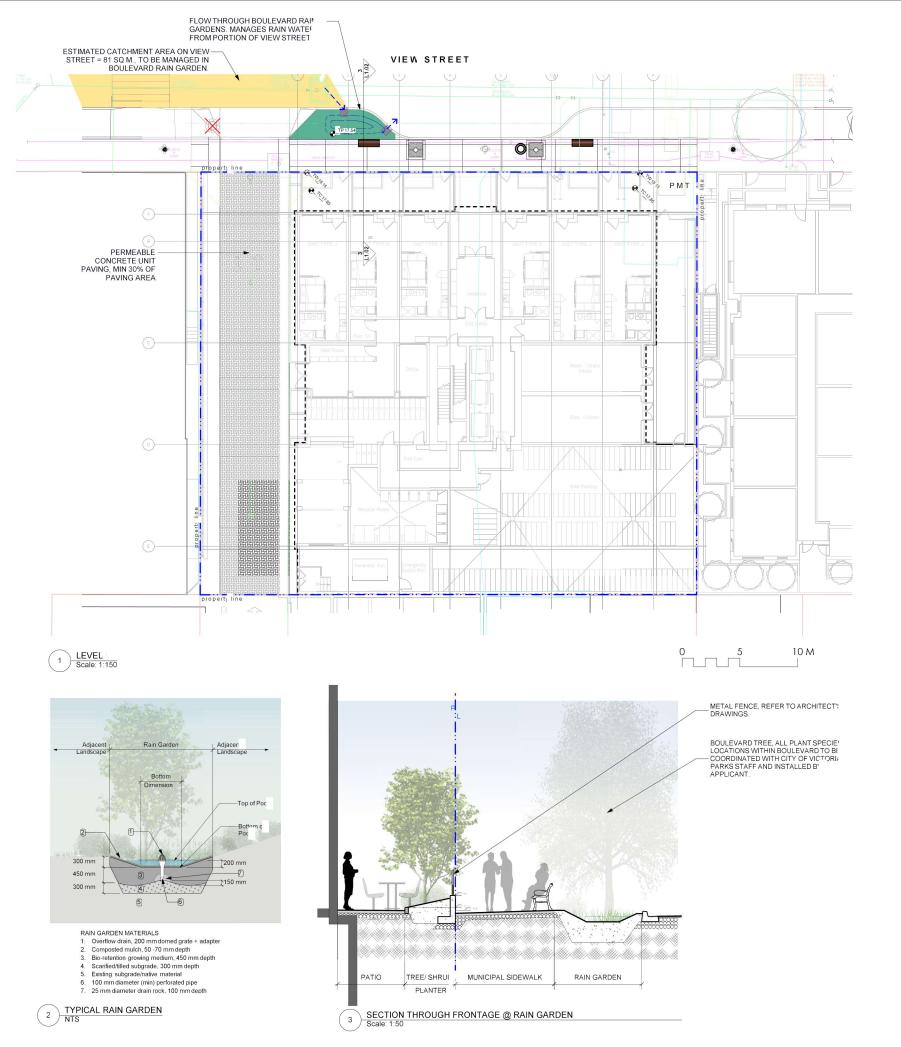

LEGEND

PROPERTY LINE EXTENT OF UNDERGROUND PARKING (INDICATIVE) EXTENT OF ROOF / CANOPY LINE (INDICATIVE) RAIN GARDEN - TOP OF POOI RAIN GARDEN - BOTTOM OF POOI ARCHITECTURAL GRADE, PROVIDED FOR REFERENCE ONLY CIVIL GRADE, PROVIDED FOR REFERENCI ONLY PROPOSED LANDSCAPE GRADE

PROPOSED LANDSC.
IV TOPO F WALL
IV TOPO F CURB
IF TOPO F CURB
IF TOPO F POOL
IF TOPO F STAIRS
IN TOM OF STAIRS
IN TOM OF STAIRS
IN TOM OF STAIRS
IN TOM OF STAIRS

DIRECTION OF FLOW RAIN GARDEN

PERMEABLE UNIT PAVING

RAIN WATER MANAGEMENT NOTES Water collected from roads flow into boulevard rain gardens. Boulevard rain gardens will be designed to be flow through planters, an will overflow to the municipal stormdrain system. The rain gardens are sized such that the bottom of the rain planter is minimum of 5% of the impervious area.

IMPERVIOUS AREAS

PROPOSED ROAD SURFACE DRAINS TO BOULEVARD RAIN GARDEN

- DRAWING NOTES

 1. DO NOT SCALE DRAWING: Verify all property lines and existing structures/vegetation to remain, prior to commencing verk.

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 9. General Contractor and/or sub-contractors are responsible for a costs related to production and submission to consultant of a
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 10. Tree protection fencing, for existing trees, to be installed prior to commencement of all site work



4 Dev Permit Revisions 20.08.11 3 Issued for DP revisions 20.01.08 DP REV 19.10.17 17.07.07 DEV PERMIT



date

rev no

NELSON INVESTMENTS, INC.

VIEW STREET RESIDENTIAL 937 VIEW STREET VICTORIA. BC

sheet title

Stormwate Management


project no.		119.24
scale	AS NOTED	@ 24"x36"
drawn by		ML

checker by

4

L1.02

SM/PdG

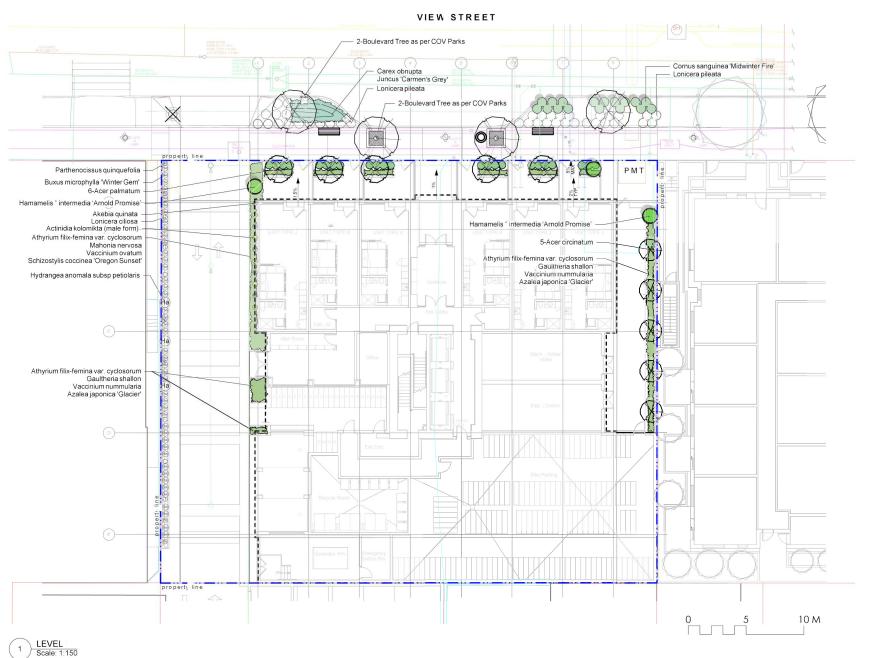

DO NOT SCALE DRAWING: Verify all property lines and existing

structures/vegetation to remain, prior to commencing work.

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acceptance.

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General Confractor and/or sub-confractors are responsible for a costs related to production and submission to consultant of a landscape as-built information including irrigation.

Tree protection fencing, for existing trees, to be installed prior to commencement of all site work

acceptance.

Tree Notes

Tree planting inspection requirements

Its Inspection – Tree pits, structural soil and root barrier 2nd Inspection – Prior to planting, tree are inspected for pests disease and structural defect

2. Two new tree guards will need to be purchased from the City c

Victoria at \$500 each.
3. The applicant will be required to pay the appraised value of the

smallboulevard tree proposed for removal. When the tree fer has been paid, the City will post the tree for [10] working days after which it can be removed at the expense of the applican

3rd Inspection – Completed planting, mulch, staking, tree grate

tes:
Trees shall be of quality prescribed in crowl observations and root observations details and utservations — and toot observations details ain specifications


2. Trunk caliper shall meet Canadian Landscapy Standard, current edition, for root ball size.

3. Max. depth of planting pit = rootball depth 150 mm.

4. Place stakes parallel to prevailing wind direction.

5. Follow supply nursery's instructions on remove of rope, burlap, and wire baskets. PLAN VIEW Central leader. (Refer to Lands Non - abrasive tree ties. Arbour Tree Tie, or approved equivalent Two (2) tree stakes, min 50 mm diameter stakes, Install approximately 50 mm away from the edge of the rootball. Stake location shall not interfere with Top of root ball shall be flush withfinished grade. Mulch, 50 mm thickness. No more than-25 mm of mulch on top of root ball. (Refer to Landscape Specifications for mulch). Round-topped soil berm 4" high x 8"-wide above root ball surface shall be Finished grade constructed around the root ball. Berm shall begin at root ball periphery Imported growing medium depth and type varies. Refer to Landscape Materials Plan. Loosened soil. Dig and turn the soil to reduce compaction to the area and depth -Scarify subsoil to a depth of growing medium. Bottom of root ball rests on recompactedsoil. Tamp growing medium below root ball to prevent settling. -Existing soil

TREE PLANTING DETAIL 2 Scale: 1:25

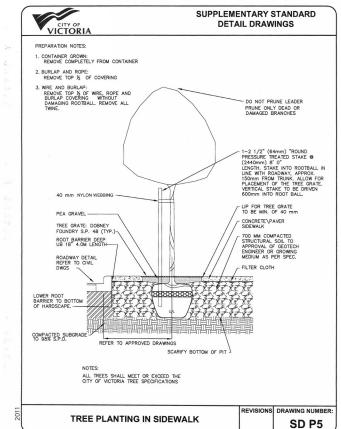

\$60	REMOVE TOP % OF COVERING
Ser Ser Service	3. WRE AND BURLAP: REMOVE TOP ½ OF WRE, ROPE AND BURLAP COVERING WITHOUT DAMAGING ROOTBALL. REMOVE ALL TWINE. DAMAGING ROOTBALL. REMOVE ALL DAMAGING ROOTBALL REMOVE ALL DAMAGING BRANCHES DAMAGING BRANCHES
5 (4) (4) (4) (4) (4) (4) (4) (4) (4) (4)	1-2 1/2" (64mm) "ROUND PRESSURE TREATED STAKE 6 (2440mm) 8" 0" (2440mm) 8"
10 20 20 10 10	LOWER ROOT BARRIER TO BOTTOM OF HARDSCAPE COMPACTED SUBGRADE REFER TO APPROVED DRAWINGS SCARIFY BOTTOM OF PIT
	NOTES:

3 STRUCTURAL SOIL



4	Dev Permit Revisions	20.08.11
3	Issued for DP revisions	20.01.08
2	DP REV	19.10.17
1	DEV PERMIT	17.07.07
ev no	description	date
	-	



NELSON INVESTMENTS, INC.

sheet title

VIEW STREET RESIDENTIAL 937 VIEW STREET VICTORIA, BC

Planting Plan Level 1

project no.		119.24
scale	AS NOTED	@ 24"x36"
drawn by		ML
checke t	ру	SM/PdG

L3.01

LEVEL 1 PLANT LIST Sym Qty Botanical Name Common Name Schd. Size / Plant Spacing TREES: Acer circinatum Vine Manle 2.4 m ht. multi-stem (3 trunk) Acer palmatum 1.8 m height, specimen quality Japanese Maple Boulevard Tree as per COV Parks Boulevard Tree as per COV Parl 6 cm cal, b+b SHRUBS: Ack Actinidia kolomikta (male form) Variegated Kiwi Vine #2 not Akebia quinata Chocolate vine #2 pot Athyrium filix-femina var. cyclos Ag Bw Azalea japonica 'Glacier' Glacier Azalea #1 pot Buxus microphylla 'Winter Gem Littleleaf Boxwood #1 pot Co Csm Carex obnupta Slough Sedge #1 pot Cornus sanguinea 'Midwinter Fire' Midwinter Fire Dogwood #1 pot Gaultheria shallon Ha Hydrangea anomala subsp petiolari Climbing Hydrangea #2 pot Jcg Loc Lp Juncus 'Carmen's Grey' Soft Common Rush Lonicera ciliosa Western Trumpet Honeysuckle #1 pot Lonicera pileata Privet Honeysuckle #2 pot Oregon Grape Holly #1 pot

PLANTING NOTES

23

Parthenocissus quinquefolia

Schizostylis coccinea 'Oregon Sunset'

Pittosporum tobira 'Nana'

Taxus x media 'Hilii'

Vaccinium ovatum

Pq Ptn

Sco Tmh

Vo

Plant quantities and species may change between issuance of DP and Construction due to plant availabilit and design changes.
 Boulevard/Street Tree and planting locations and species to be coordinated with City of Victoria Parks Staf

Virginia Creeper

Crimson Flag

Hilii Yew

Dwarf Pittosporum

Coin Whortleberry

Evergreen Huckleberry

#2 pot


#1 pot

#1 pot


#3 pot, 2' max ht. male only

#3 pot

and installed by applicant.

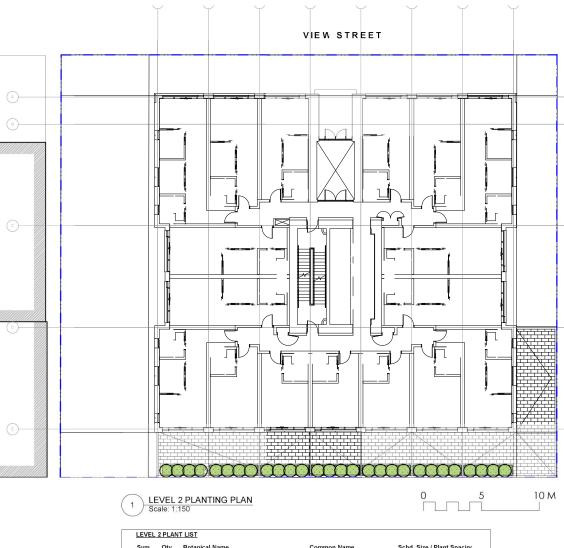

LEVEL	2 PLAN	NT_LIST		
Sym	Qty	Botanical Name	Common Name	Schd. Size / Plant Spacing
SHRUE	SS/VINE	<u>:S:</u>		
Plu	28	Prunus Iusitanica	Portugal Laurel	#3 pot

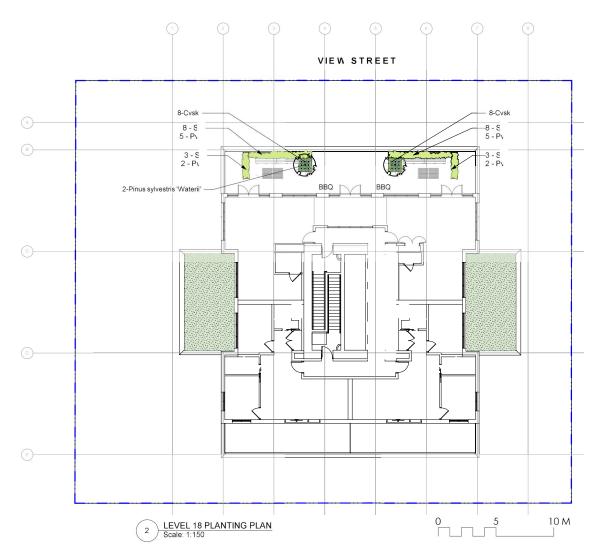

Sym	Qty	Botanical Name	Common Name	Schd. Size / Plant Spacing
TREES	<u>i:</u>			
	2	Pinus sylvestris 'Waterii'	Bonsai Pine	nen, cloud pruned, min 2 m hrune
SHRUE	BS/VINE	<u>S:</u>		
Cvsk	16	Calluna vulgaris 'Silver Knight'	Silver Knight Scotch Heather	#1 pot
Pvi	17	Pennisetum villosum	Feathertop Grass	#1 pot
St	22	Stipa tenuissima	Mexican Feathergrass	#1 pot
GREEN	N ROOF	AREA - SUN	Area (sq m):	72.9
	20%	Sedum acre		
	20%	Sedum album 'Coral Carpet'		
	20%	Sedum kamtschaticum		
	2070			
	20%	Sedum rupestre		

- DRAWING NOTES

 1. DO NOT SCALE DRAWING: Verify all property lines and existing structures/vegetation to remain, prior to commencing verk.

 2. All plan dimensions in metres and all detail dimensions is

- 2. All plan dimensions in metres and all detail dimensions in millimetres.
 3. Plant quantities on Plans shall take precedence over plant lis quantities.
 4. Contractor to confirm location and elevation of all existing services and utilities prior to start of construction.
 5. Provide layout of all work for approval by Landscape Architec prior to proceeding with work.
 6. Contractor to provide irrigation system for all planters to currer IIABC Standards and Contract Specifications.
 7. Landscape installation to carry a 1 year warranty from date a acceptance.
 8. Plant material, installation and maintenance to conform to the current edition of the Canadian Landscape Standard.
 9. General Contractor and/or sub-contractors are responsible for a costs related to production and submission to consultant of a landscape as-built information including irrigation.
 10. Tree protection fencing, for existing trees, to be installed prior to commencement of all site work.

PLANTING NOTES

1. Plant quantities and species may change between issuance of Df and Construction due to plant availability and design changes.

2. Boulevard/Street Tree and planting locations and species to be coordinated with City of Victoria Parks Staff, and installed be applied. applicant.



4	Dev Permit Revisions	20.08.11
3	Issued for DP revisions	20.01.08
2	DP REV	19.10.17
1	DEV PERMIT	17.07.07
rev no	description	date
	3 2 1	3 Issued for DP revisions 2 DP REV 1 DEV PERMIT



2020-08-12

NELSON INVESTMENTS, INC.

VIEW STREET RESIDENTIAL 937 VIEW STREET VICTORIA, BC

sheet title

Planting Plan Levels 2 and 18

project no.		119.24
scale	AS NOTED	@ 24"x36"
drawn by		ML
checker by		SM/PdG

4



LEGEND

LLOLIND					
EXISTING	PROPOSED	DESCRIPTION	EXISTING	PROPOSED	DESCRIPTION
		EDGE OF PAVENENT		+	REDUCER
CURB		CURB AND GUTTER		-x -x -x -	FENCE
		EDGE OF GRAVEL	\ \ \ \ \ \ \	~ ~ ~	DITCH/SWALE
TB/BB		TOP/BOTTON OF BANK	w	w	WATERMAN (SIZE AND MATERIAL NOTED)
		CATCH BASIN	ss — · · · — · · —	ss — · · — · · —	SANITARY SEWER (SIZE AND MATERIAL NOTED)
		WATER VALVE	so — · · · · — · · · · —	SD = · · · =	STORM DRAIN (SIZE AND MATERIAL NOTED)
-⊘PH		FIRE HYDRANT	UT	UT ———	UNDERGROUND TELEPHONE
		CAPPED END	UH	UH	UNDERGROUND HYDRO
0		UTILITY POLE AND STREET LIGHT (LABELLED PP.TP.PP/LS ETC.)		IRR	IRRIGATION SLEEVES
— · · · —⊙MH · · · —		MANHOLE	0		NONUMENT
— · · · —⊗ ^{co}		CLEANOUT			PROPERTY LINE
ossic/spic	ssic/spic	SANITARY/STORM INSPECTION CHAMBER (2009 RISER)		5+100 5+110	CENTERLINE AND STATIONING
		JUNCTION BOX			SANITARY SEWER SERVICE CONNECTION AT MAIN
		AIR VALVE	+32.75	43.170 +	ELEVATIONS
— → _{MM}		WATER METER			PAVEMENT REMOVAL
					NEW ASPHALT





LIST OF DRAWINGS

DWG No. DESCRIPTION

GENERAL NOTES, LOCATION PLAN, KEY PLAN, DRAWINGS LIST & LEGEND SITE SERVICING PLAN GRADING PLAN BC HYDRO INFORMATION PLAN C100

ISSUES

> ISSUED FOR DEVELOPMENT PERMIT

CMIC ADDRESS:
LEGAL:
ZONING:
LAND USE:
PROPOSED:
SITE AREA:
MAIN FLOOR ELEVATION:

937 VIEW STREET LO-AB, 1975 795, 786 AND 787, VICTORIA CITY, PLAN 36505. RESIDENTIAL RESIDENTIAL 253 UNIT 15 STOREY RESIDENTIAL BUILDING 1572m²

PLAN TO ACCOMPANY DEVELOPMENT PERMIT APPLICATION

GENERAL NOTES:

- ALL WORK AND MATERIALS ARE TO BE IN ACCORDANCE WITH THE CITY OF VICTORIA (CDV) STEPPICHED THE WASHINGTON TO BE AND A CONTROL OF A CONTR

- A FROMERON O DEPINION PRIOR TO COMMENSION WORK. PERMISS MUST BE ON SITE FOR REVIEW AS REQUIRED.

 5. CONFIRM LOCATION AND EXEMITION OF ALL DISTING UTILITIES AT ALL CROSSINGS AND CONNECTIONS REQUIRED.

 6. CONFIRM THAT ELEVATION, LOCATION AND GRADENT OF ASPHALT MATCH EXISTING PRIOR TO PLACEMENT OF ASPHALT OR CONCRETE.

 7. PASPHALT OR CONCRETE.

 8. ADJUST ALL MANNOLES, WATER WALVES, IMPRO VAULTS, ETC. TO MATCH INSTEAD CONSTRUCTION.

 8. ADJUST ALL MANNOLES, WATER WALVES, IMPRO VAULTS, ETC. TO MATCH INST CONSTRUCTION.

 9. ALL LOCATIONS AND ELEVATIONS OF DISTING UTILITIES SHOPM ARE PHPROMANT ON SHOULD BE RECEIVED.

 10. ALL LOCATIONS AND ELEVATION OF DISTING UTILITIES SHOPM ARE PHPROMANT OF SHOULD BE RECEIVED.

 10. ALL DECONATED TRENCH AND SUBEDICAVATION MATERIALS TO BE EXPOSED OF OTHER SHOPM.

 10. ALL SCIENCES THE OFFICE OF THE PROPERTY OF T

ROAD NOTES:

- CONSTRUCT ALL SIDEWALK AND DRIVEWAY CROSSINGS IN ACCORDANCE WITH COV AND MMCD STANDARDS AS NOTED ON DRAWNINGS.
 MARTIAN VENULAR AND PEDESTRUM ACCESS ALONG VIEW STREET DURING CONSTRUCTION.
 ROOM RESTORATION FOR VIEW STREET TO COV SUPPLEMENTAL DNG. No. SD GSS AND GSS.
 HIE PROVISION OF APPROVED SIGNS AND CERTIFICED TRAFTIC CONTROL PERSONNEL IS THE

- THE PROVISION OF APPROVED SIGNS AND CERTIFIED TRAFFIC CONTROL PERSONNEL IS THE CONTROLOR'S SOLD RESPONSIBILITY SWOOTH ALL PRAFFICE TOWNS TO BE SWOOTH ALL PRAFFICE TOWN THE SWOOTH SWOOTH ALL PRAFFICE TOWN THE SPECIFICATIONS SWOED ON CIVIL, LANDSCAPE AND ARCHITECTURAL DRAWINGS AS FEET CON'NEW TOWN SPECIFICATIONS.

 PEDESTRAIN WALKING AREA TO BE DELINEATED DURING THE CONSTRUCTION TO THE WORKS AND MUST BE EASILY RECONTROL TOWN THE PUBLIC AND CONTRAIN NO GESTRICTIONS TO MOBILITY SCOTTERS OR WIEELCHARDS AND NO HAZAROUS CONDITIONS. THE PUBLIC USING THESE AREAS MUST BE ACCURATED.

WATER NOTES:

WATER SERVICE CONNECTION TO BE PER CoV STD. DWG. No. W24 SS.
 CONTRACTION TO CONTRIM THAT DISTRING WATER SERVICES MANE BEST CAPPED BY CONTRACTORY/DEVELOPER AND INSTECTED BY GOT PLUMBING DEPARTMENT AT DEVELOPER'S EXPENSE.

STORM DRAIN AND SANITARY SEWER NOTES:

- CONTRACTOR TO COMPINE THAT DUSTING SHATERY AND STORM DRAIN SERVICES LIVE BEEN CAPPED BY CONTACTOR/DEVELOPER AND INSPECTED BY CONTACTOR/DEVELOPER AND INSPECTED BY CONTRACTORY OF THE AND INSPECT BY CONTRACTORY TO BE AS PER COV STD. DWG. No. 5. 3. STORM DRAIN AND SANITARY SEWER CONNECTIONS TO BE AS PER COV STD. DWG. No. 5. STORM DRAIN CONNECTION TO BE 2000 PVC SERVER AT A MINIMUM GRADE OF 2.00% UNLESS.

- STUDIAL EVANUA CONTROLLION TO BE 2009 PRO SURZA RI A MINIMUM GRADE OF 2.00% UNLESS OTHERWISE STREET CONTROLLION TO BE 2509 PRO SDR28 AT A MINIMUM GRADE OF 2.00% UNLESS OTHERWISE TO SUB-CONTROLLION SUB-

SHALLOW UTILITY AND STREET LIGHT NOTES:

- EXISTING BC HYDRO, TELUS, SHAW CABLE AND FORTIS BC INFRASTRUCTURE INFORMATION SHOWN ON DRAWINGS IS SCHEMATIC AND FOR INFORMATION ONLY.
 REFER TO LITHLY COMPANY DESIGN DRAWINGS FOR CONSTRUCTION DETAILS. CONSTRUCT UNDERGROUND UTILITIES AS SPECIFICA AND IN ACCORDANCE WITH BC HYDRO, TELUS, SHAW CABLE SPECIFICATIONS AND DRAWINGS.

 DRAWINGS.
- DRAWNISS.

 OMFIRM AND COORDINATE WITH COV FORCES REINSTATEMENT OF LAMP STANDARDS AS PER COV SUPPLEMENTARY STANDARD ETAIL DRAWNISS, INCLUDING BASES, CONDUIT AND JUNCTION BOX.

 CONTACT BO I CALL AT 1-80-474-6886 A HAMMAN OF 48 HOURS PROR TO CONSTRICTION.

 CONTACT BO I CALL AT 1-80-474-6886 A HAMMAN OF 67 HOURS PROR TO CONSTRICTION.
- EXCAVATION.

 6. BC HYDRO TO COORDINATE AND PROVIDE LIAISON WITH CoV PRIOR TO AND DURING CONSTRUCTION.

/ STREET RENTAL I NELSON BC 937 VIEW 8 MARKET R CHRIS HEROLD

INVESTMENTS

RESIDENCE

ENGINEERING

GENERAL NOTES. LOCATION PLAN, KEY PLAN. DRAWINGS LIST

DESIGNED TDL	ENGINEER'S SEAL		
AJH			
LAM .	Shirting V		
SAC REVIEW	2020-08-11		
PROJECT No. 5094-001	CLIENT DRAWING No.		
SCALE H: AS NOTED V: -	PERMIT No.		
HEL DRAWING No.	REVISIO		

KEY PLAN



DESTROY ALL DRAWINGS SHOWING PREVIOUS REVISIO

