
9 Unit Multi-Family Development Rezoning & Development Permit Application 600 Dallas Rd.

Nov 12th., 2025

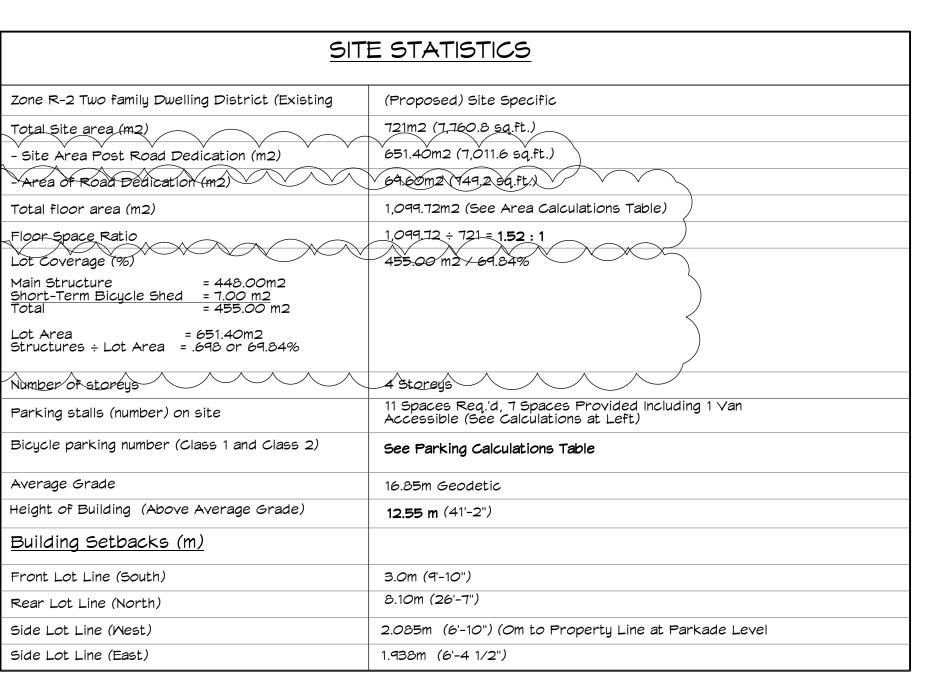






4.2 Z.b

apartment (Rental Dwelling Units Se	cured in Pei	rpetuit	y) in "Other" Area	
- Unit	@ .75 Per Unit	= .75	or	1	
3 - Units	@ 1.30 Per Unit	= 10.4	or	10	
5ub-Total S	paces			11	
1 Space R	Required To Be Access	sible)			
/isitor Par 1 × .1 = 1	king Req.'d .1 OR			1	
	ng Required			 12 Spaces	
ncluding 1 \ ' <u>3 Space D</u> All Spaces	ovided over 1 Level Of Van Accessible and 1 V eficit) To Have Electric Char King Required:	'isit <i>o</i> r		ed Parking	
_ong Term:					
l per dwelli	ng unit < 45m2	= 1			
1.25 per du	velling unit > 45m2 (8 u	nits) <u>= 10</u>	_		
Total Bike	Spaces Required	= 11			
	aces Provided Includir	g 4 Cargo	Bike	Areas & Bike Wash S	tation
2 Bike Sp					
12 Bike Sp Short Term	<u>:</u>				

(No	Unix Mix Dte: Area for uni to <i>inside</i> of f	ts below r	neasured
Floor Level	Unit Type	Unit #	Area
Main (Parkade)	1 Bedroom (Including Office)	101	93.23m2 (1003.52s.f.) (including Office area of 38.46m2)
Second	2 Bedroom	201	95.31m2 (1,025.91s.f.)
	2 Bedroom	202	103.13 (1,110.08s.f.)
	1 Bedroom	103	76.39m2 (822.25s.f.)
Third	2 Bedroom	301	95.31m2 (1,025.91s.f.)
	2 Bedroom	302	103.13 (1,110.08s.f.)
	1 Bedroom	303	76.39m2 (822.25s.f.)
Fourth (Penthouse)	3 Bedroom	401	108.66m2 (1,169.60s.f.)
	2 Bedroom	402	66.69m2 (717.84s.f.)
SUBTOTAL UNITS	1 Bedroom 2 Bedroom 3 Bedroom	3 5 1	33.33% 55.56%66.67% 11.11%
TOTAL # OF SUITES		9	
TOTAL SUITE			818.24m2 (8,807.46s.f.)



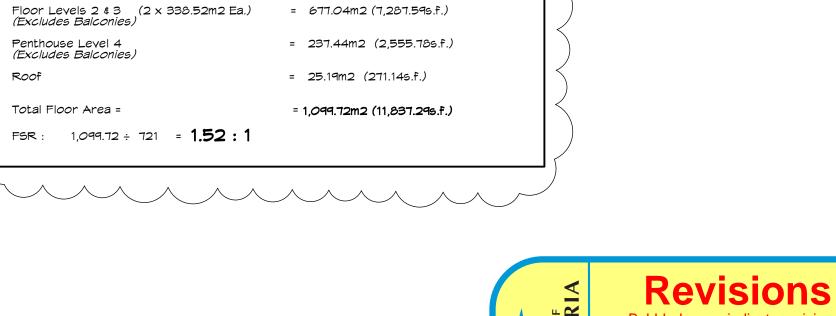

= 160.05m2 (1,722.76s.f.)


Area Calculations:


Parkade Level (Excludes Parking & Bicycle)


Site Area = 721 m2




Received Date

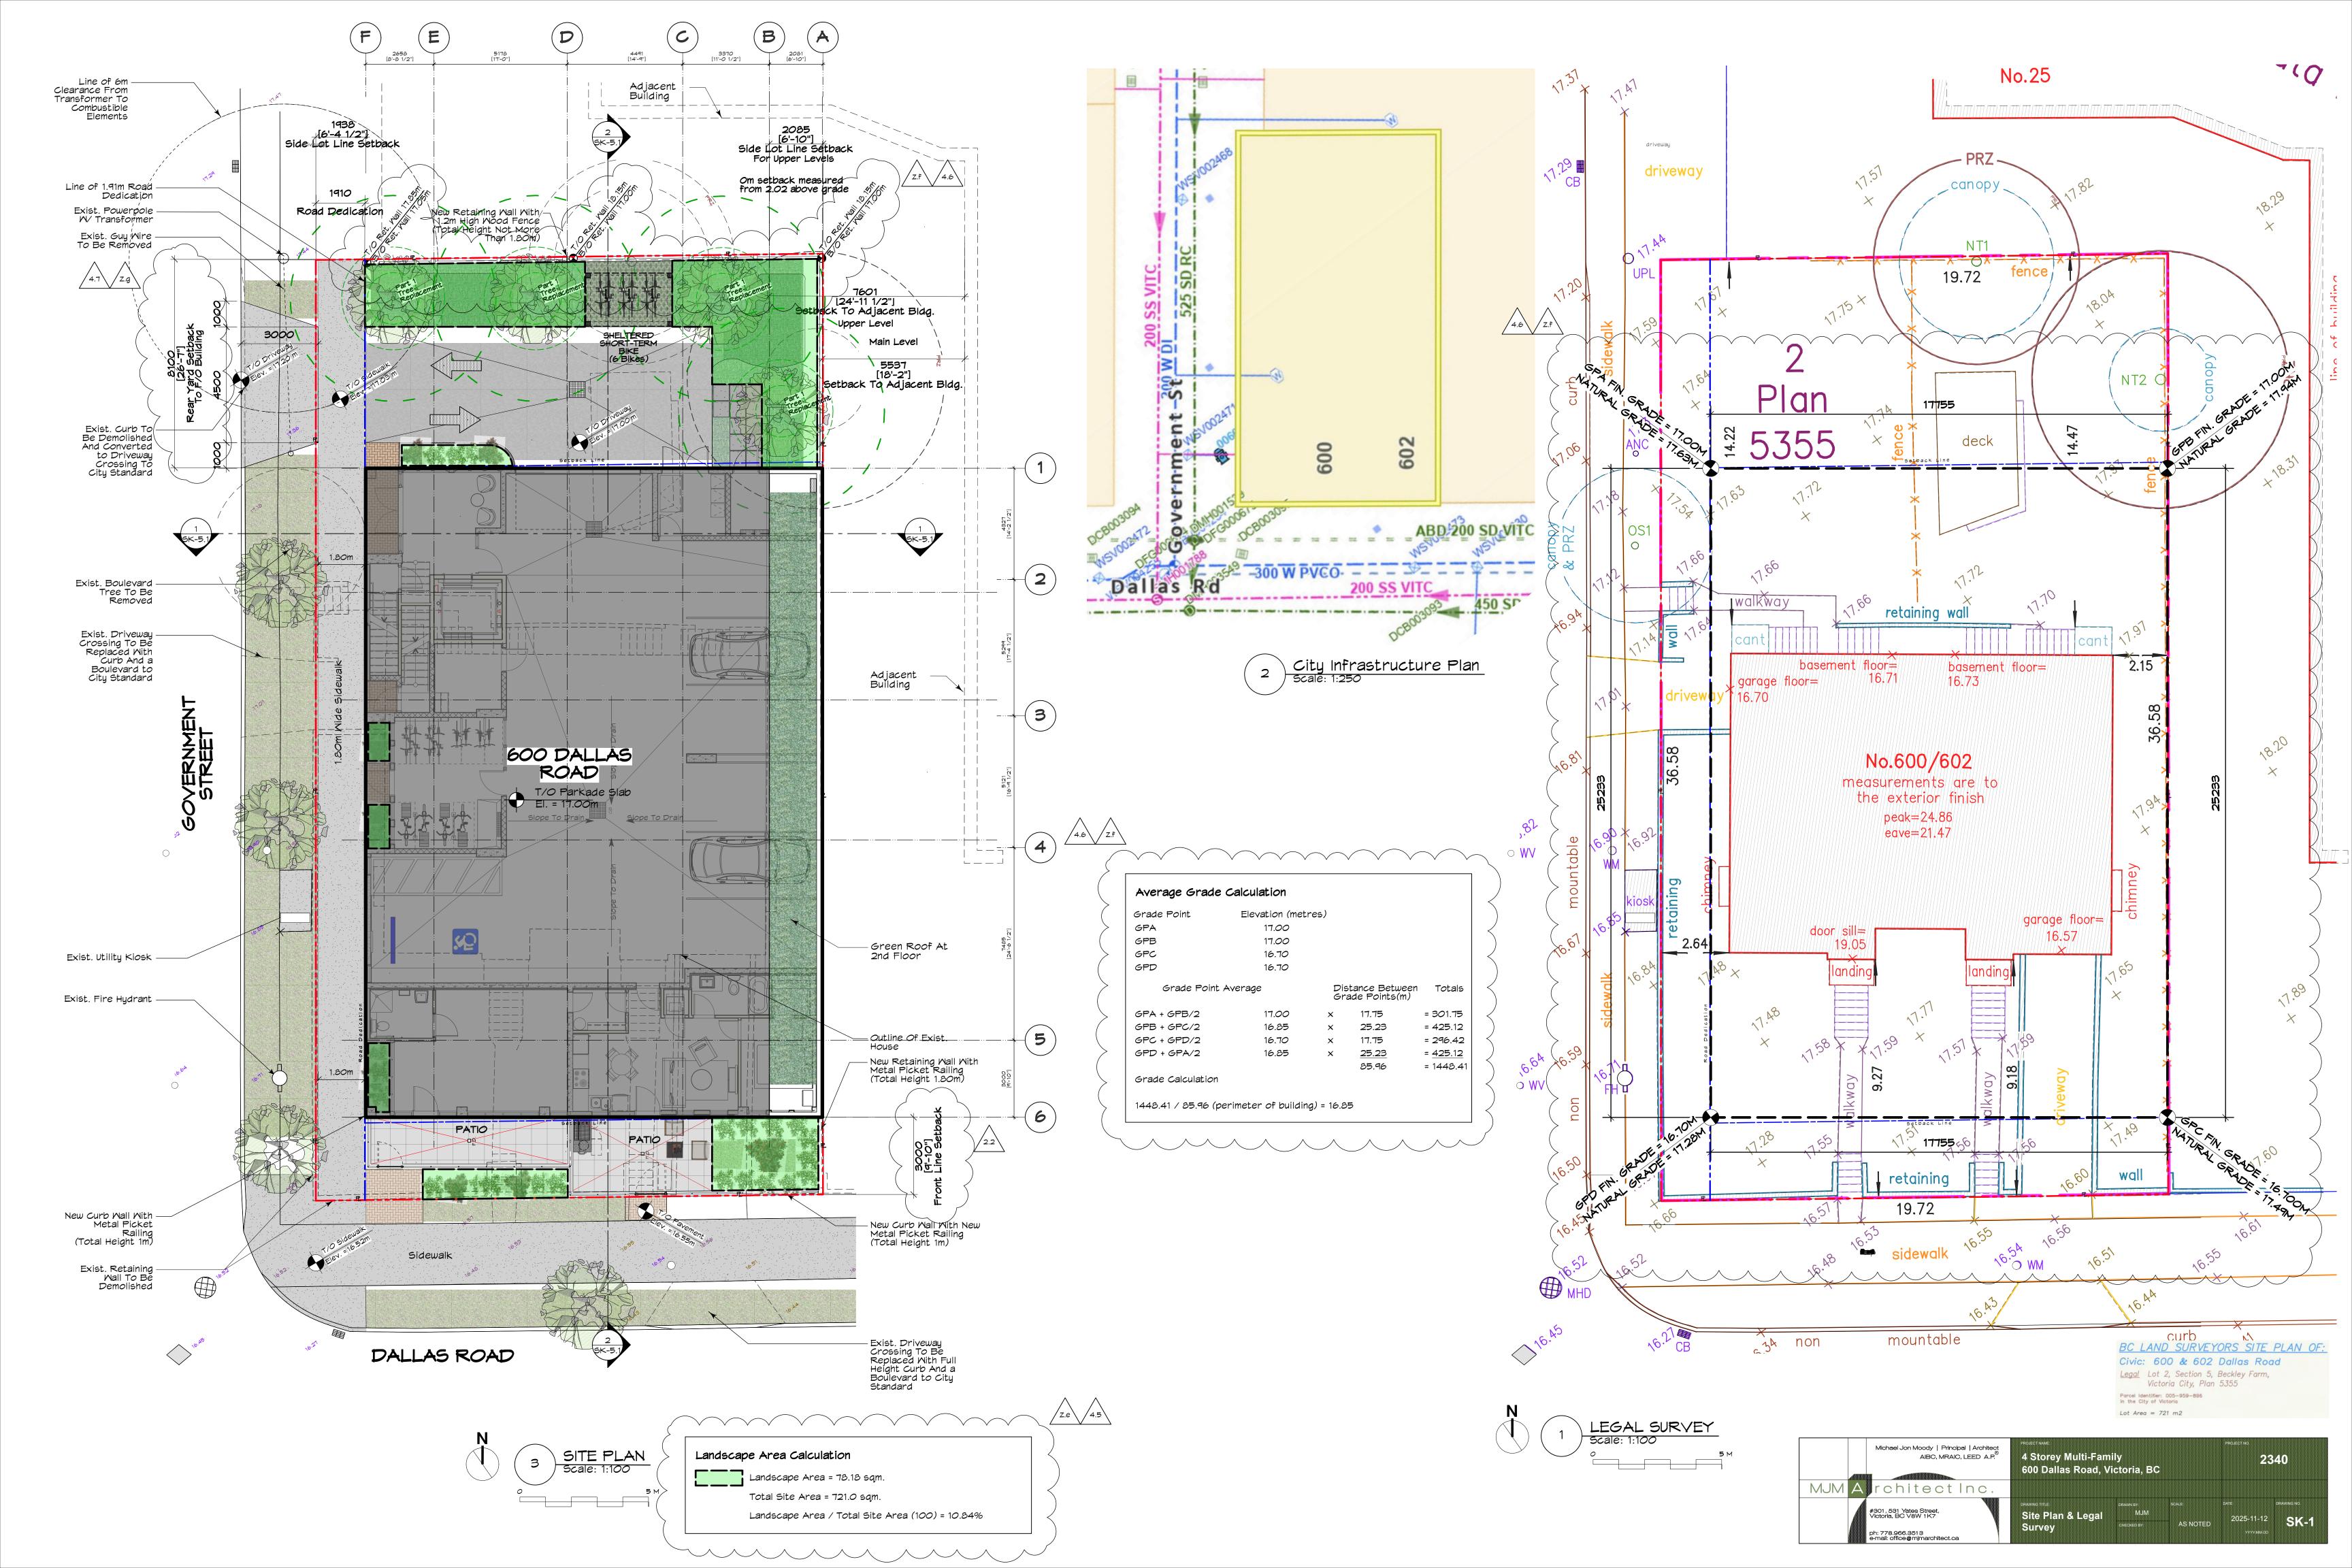


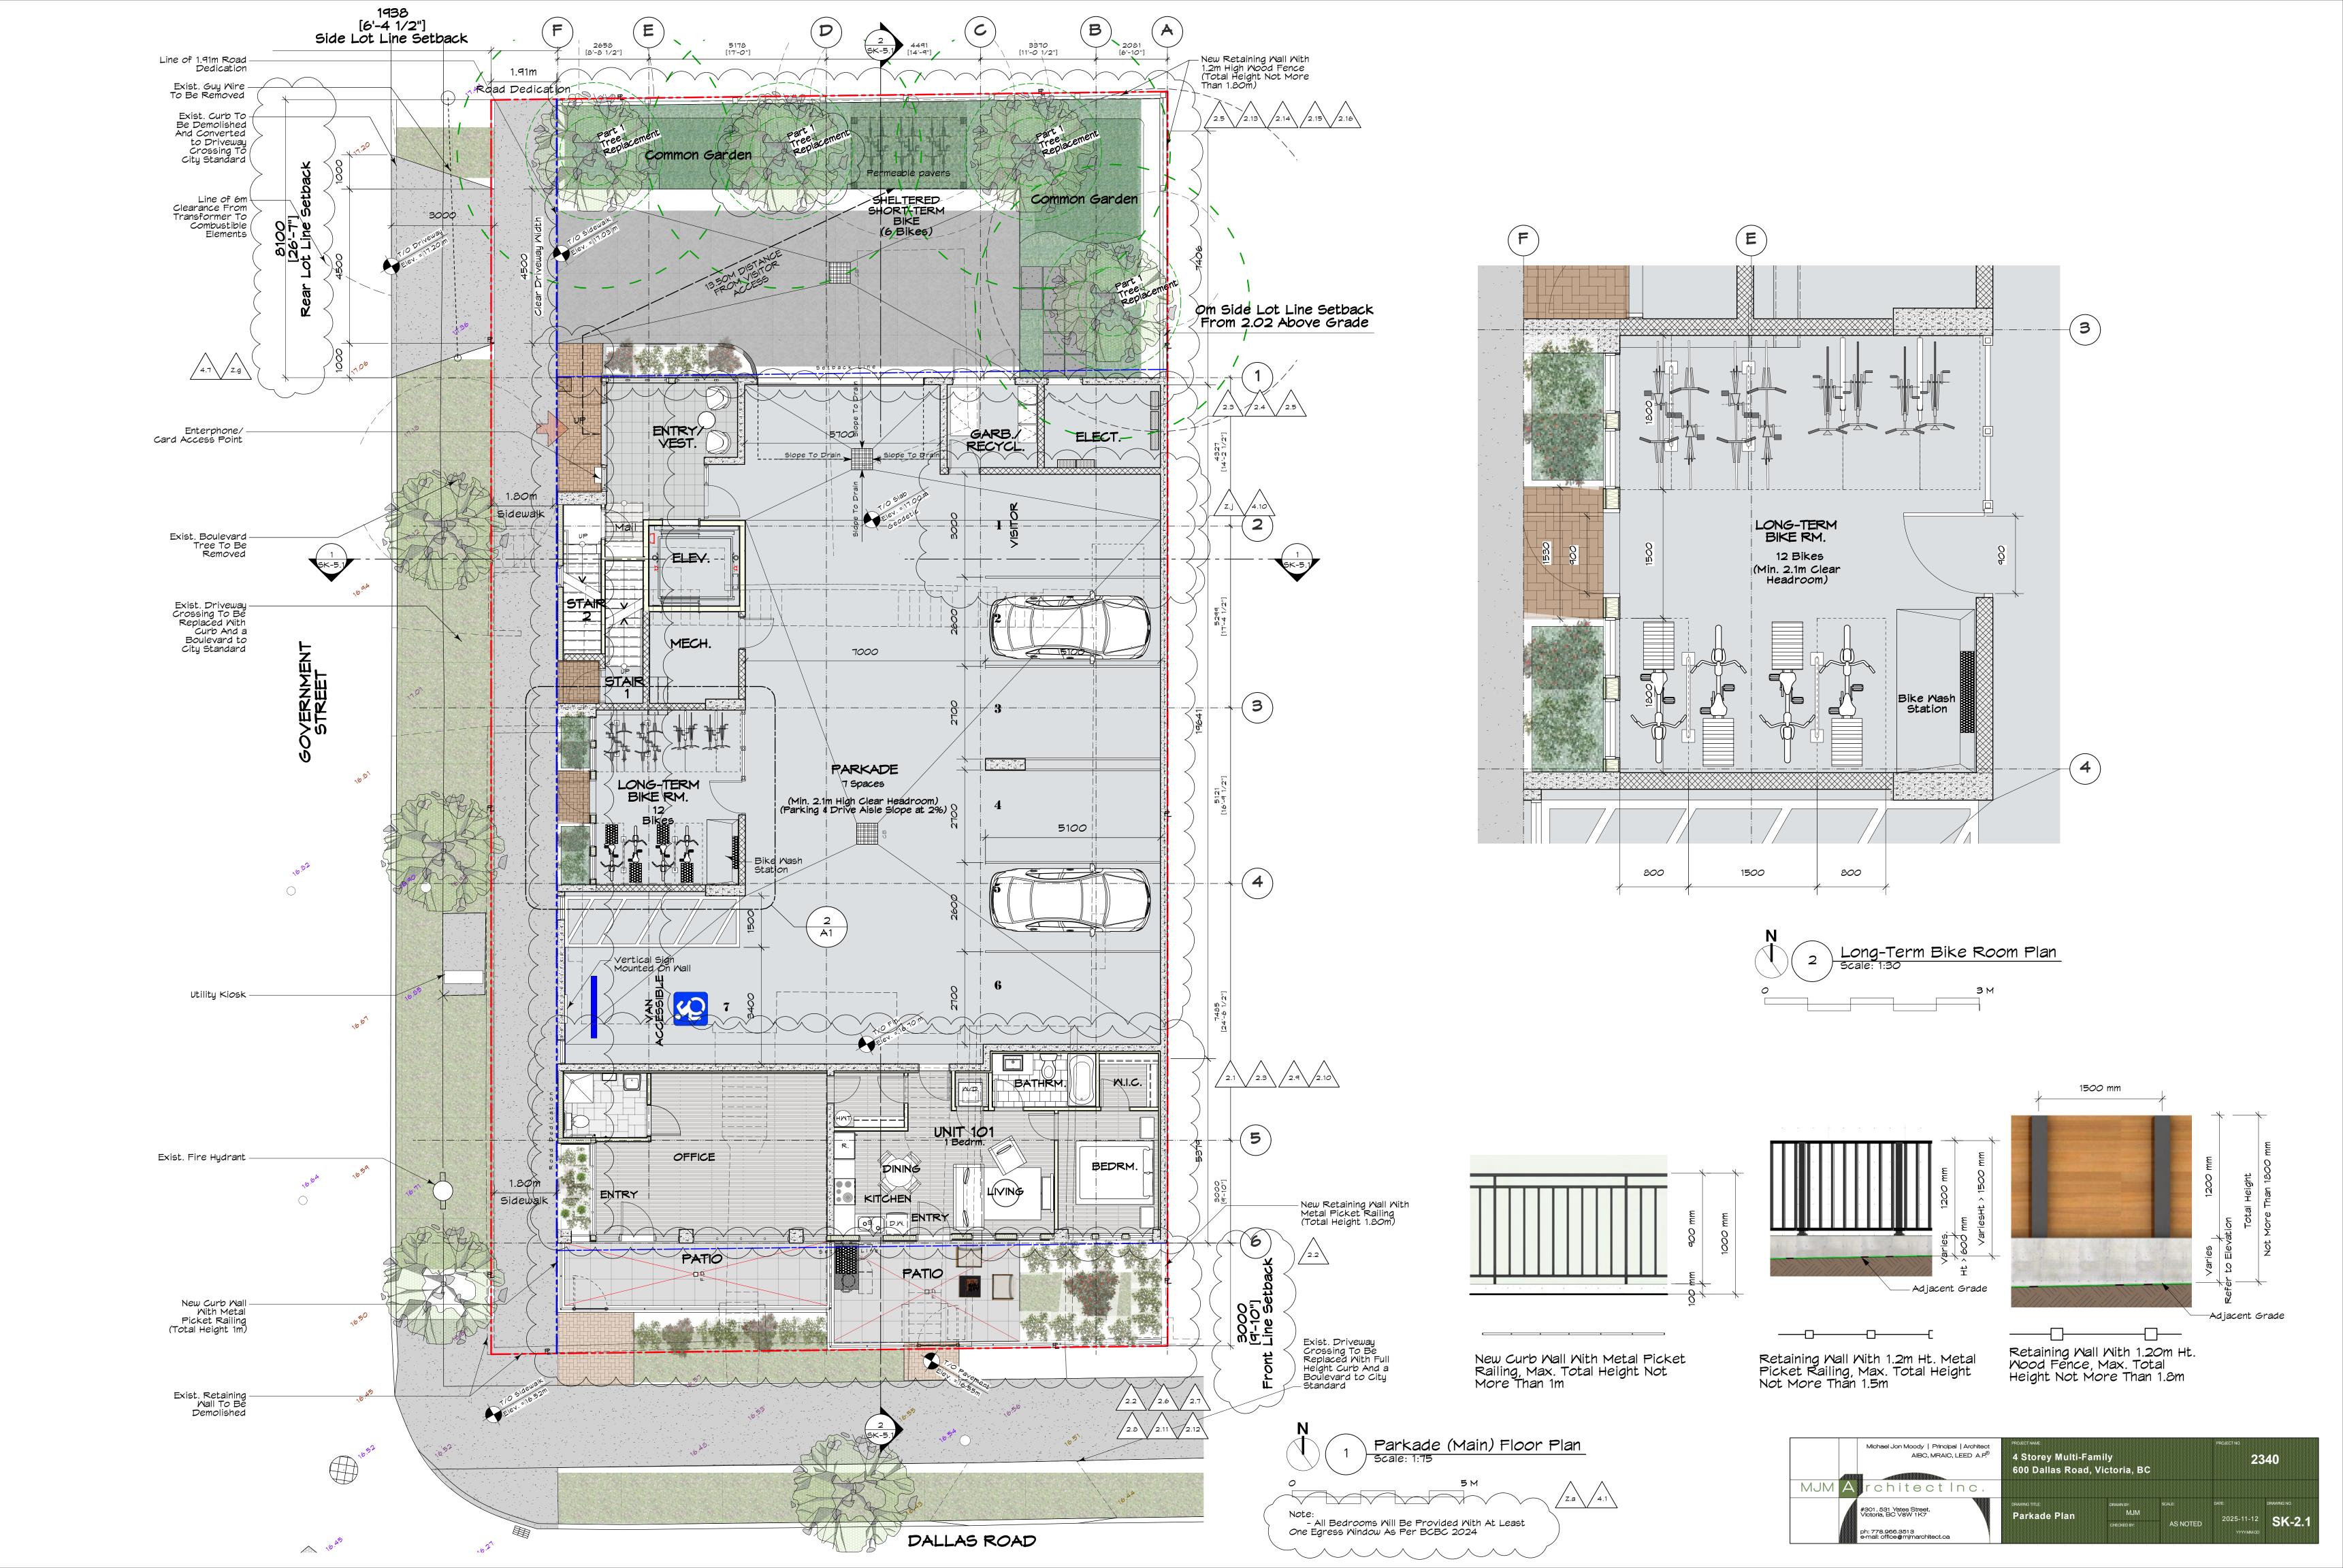


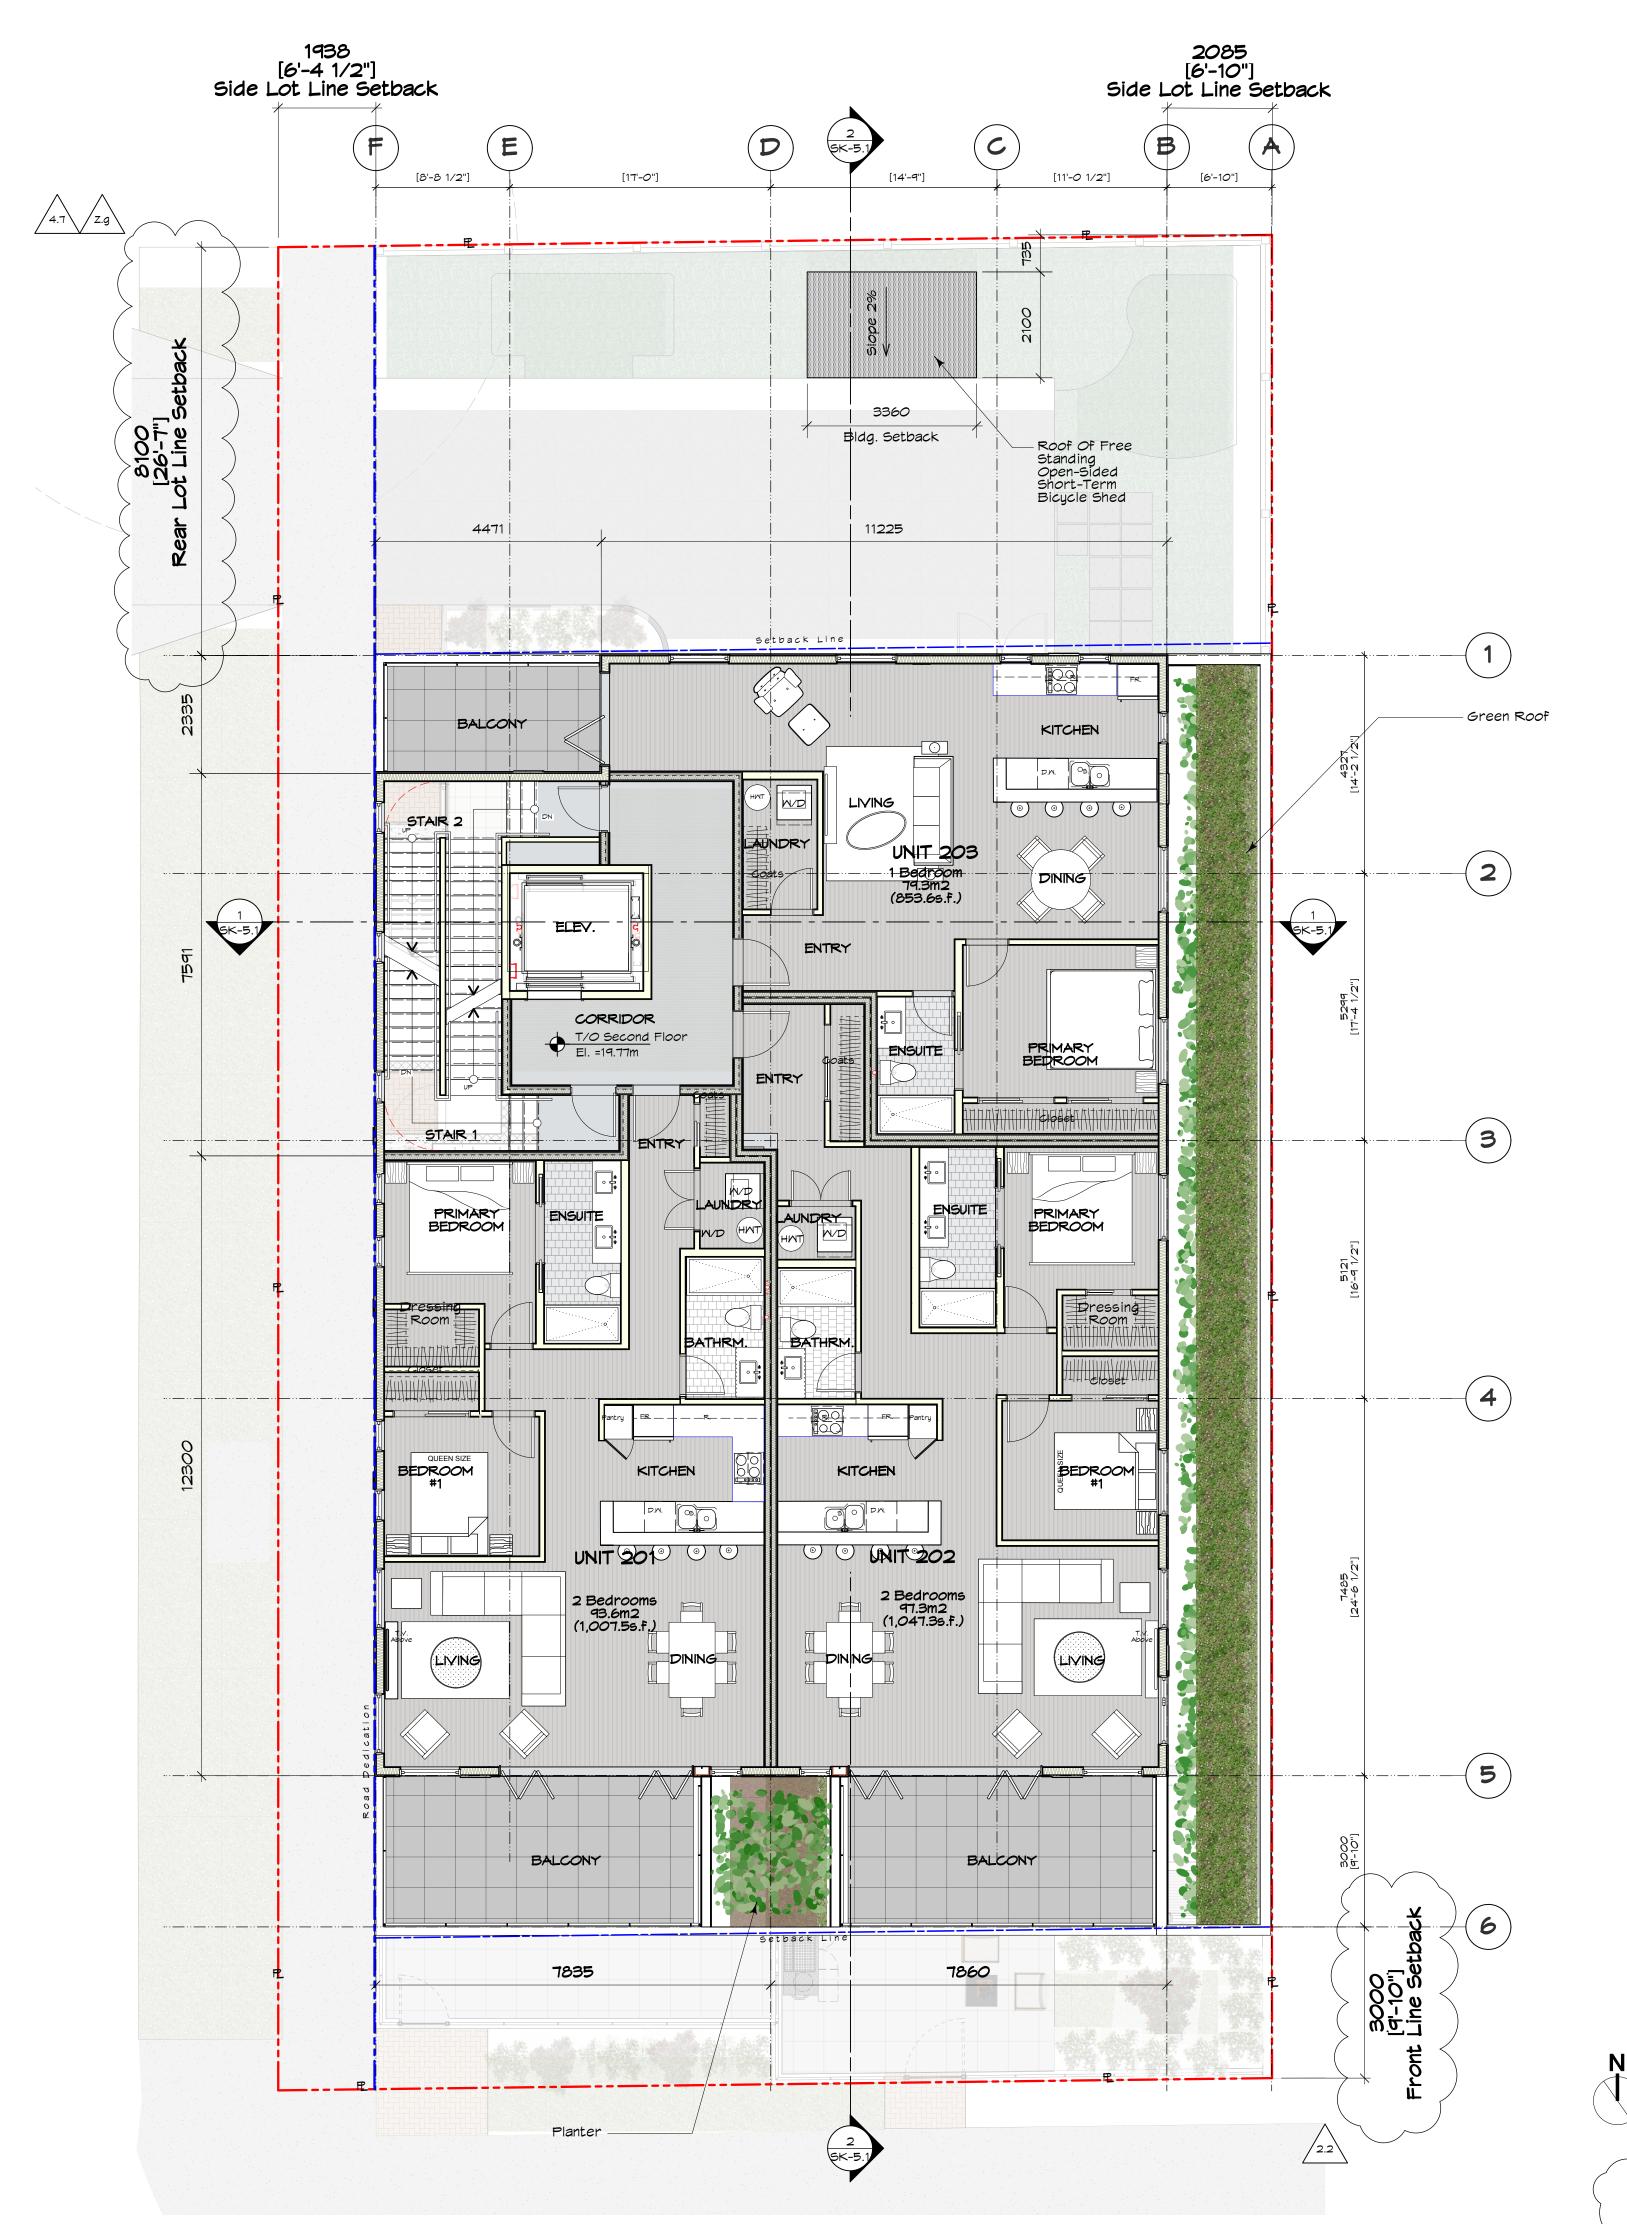

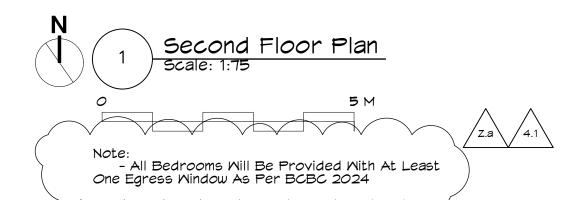



		PROJECT NAME			PROJECT NO.	
	Michael Jon Moody Principal Architect AIBC, MRAIC, LEED A.P.	4 Storey Multi-Fami 600 Dallas Road, Vi			23	340
MJM A	rchitect Inc.					
	#301, 531 Yates Street, Victoria, BC V8W 1K7 ph: 778.966.3513 e-mall: office@mjmarchitect.ca	Second Floor Plan	DRAWN BY MJM CHECKED BY	SCALE AS NOTED	DATE: 2025-11-12	3N-2.2

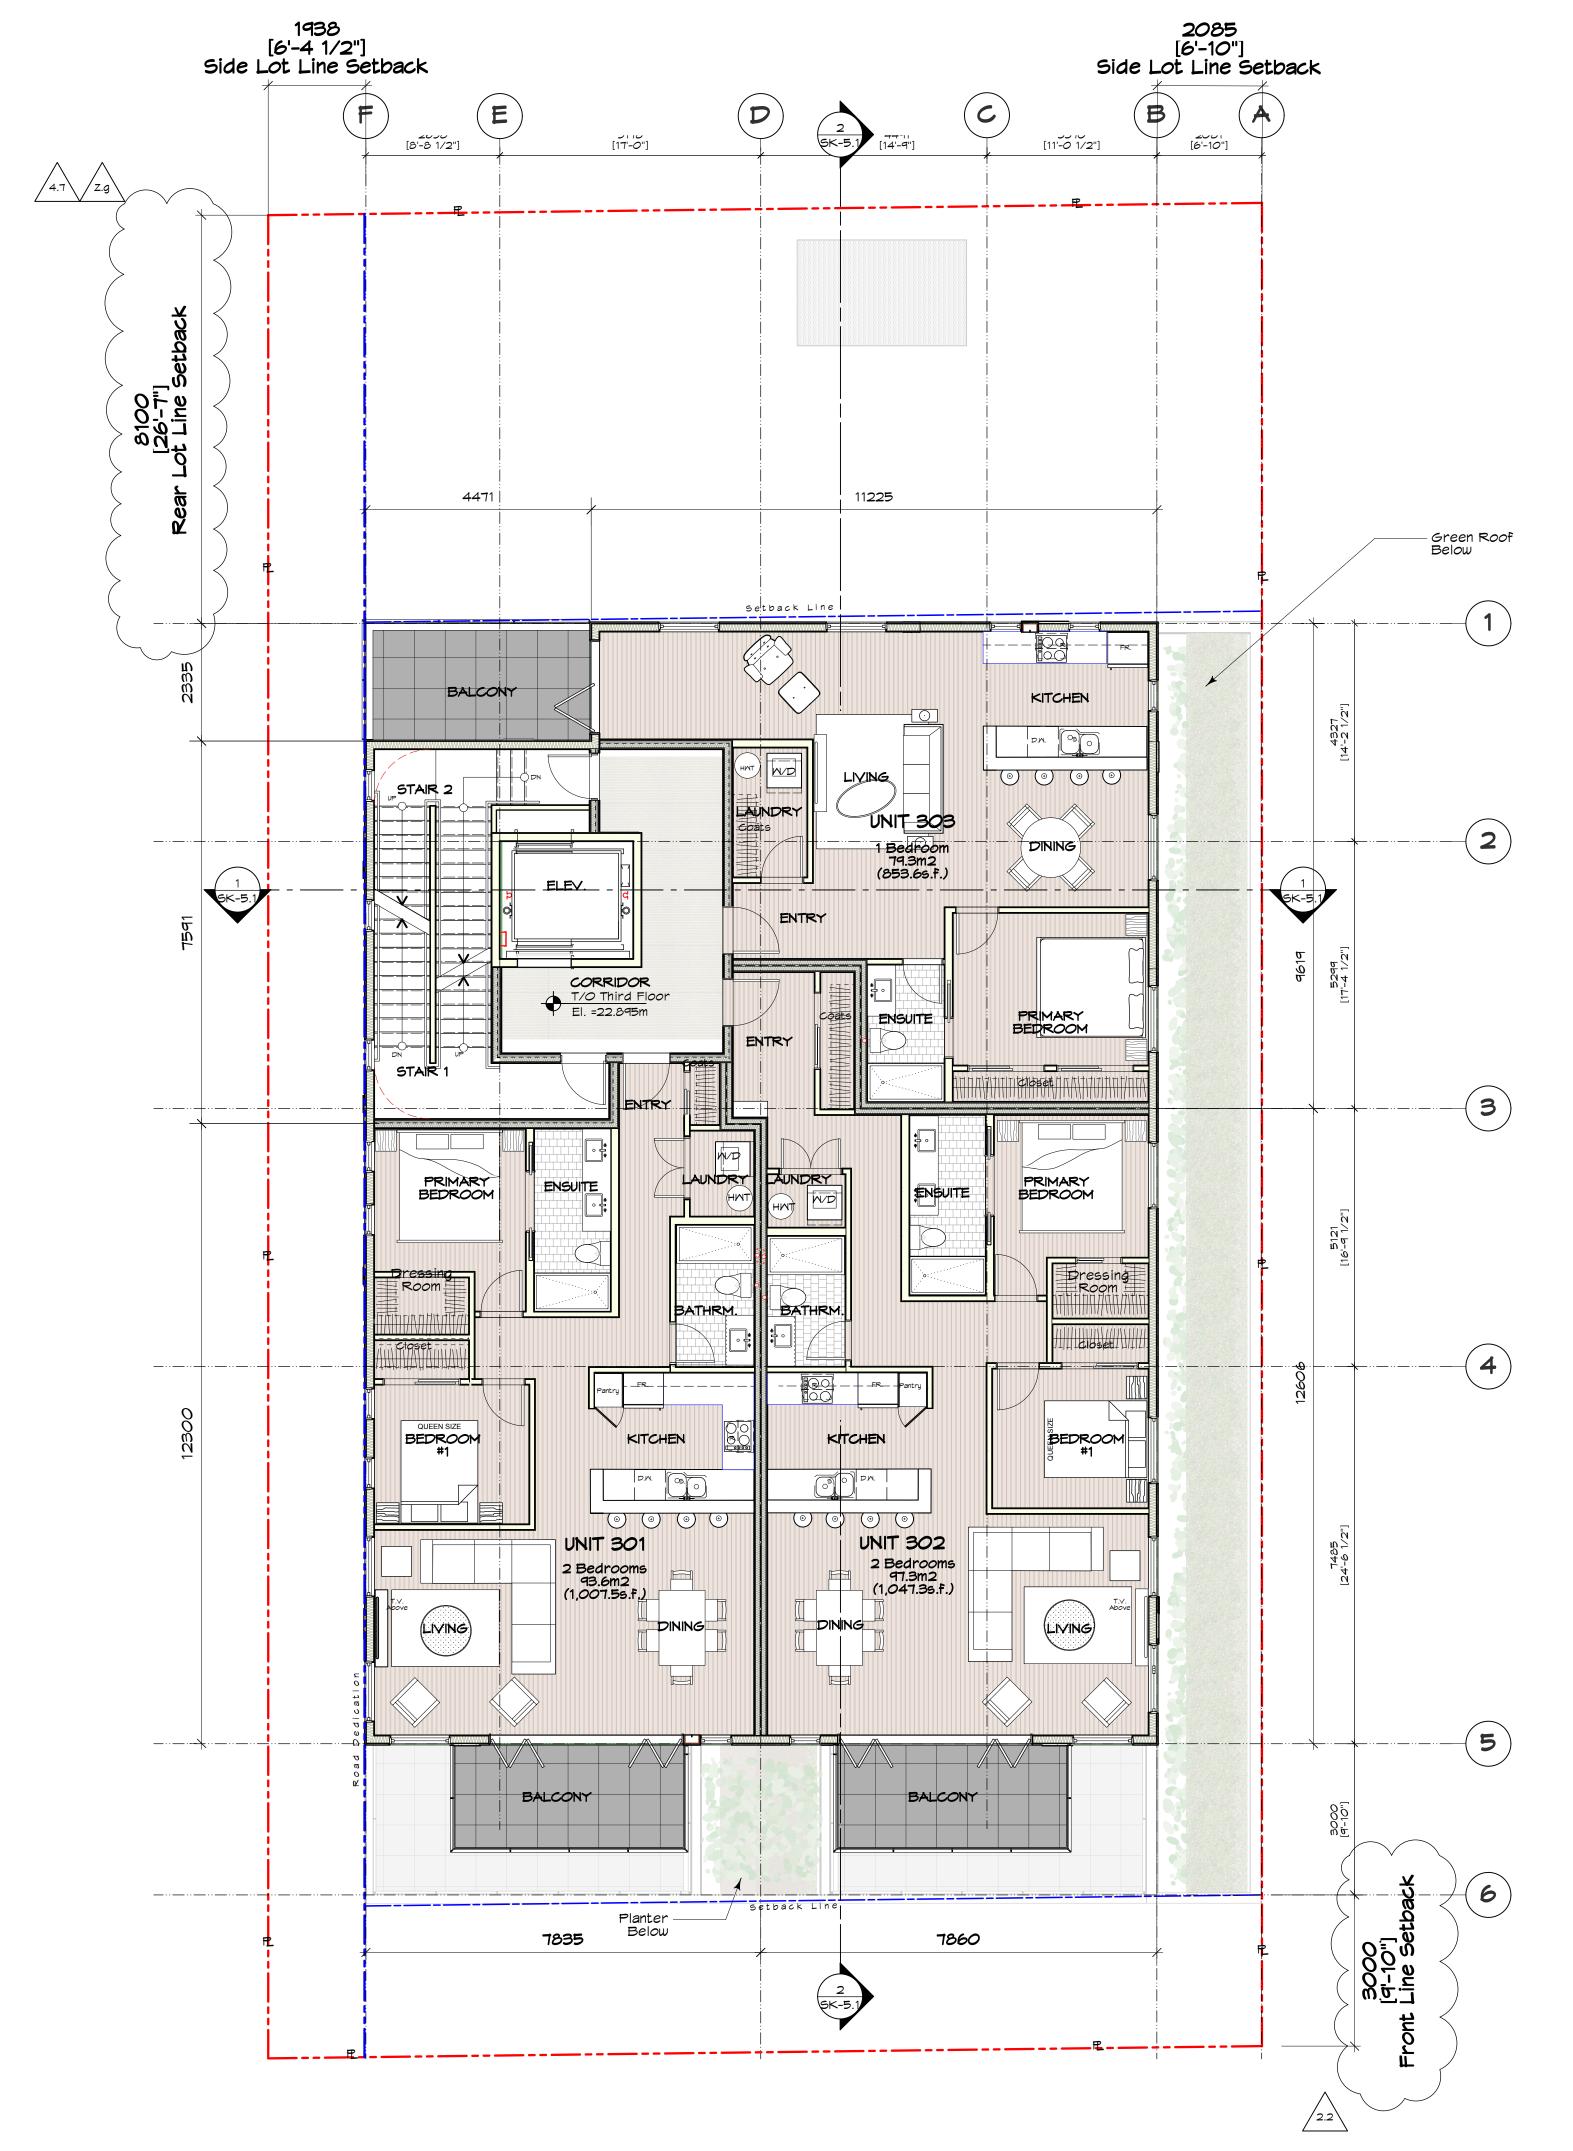

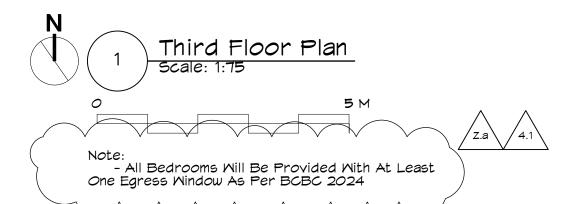



	Michael Jon Moody Principal Architect AIBC, MRAIC, LEED A.P.®	4 Storey Multi-Fam 600 Dallas Road, V			PROJECT NO.	40
MJM /	Architect Inc.	<u> </u>				
	#301, 531 Yates Street, Victoria, BC V8W 1K7 ph: 778.966.3513 e-mall: office@mjmarchitect.ca	Third Floor Plan	MJM CHECKED BY:	AS NOTED	2025-11-12 YYYY-MM-DD	SK-2.3

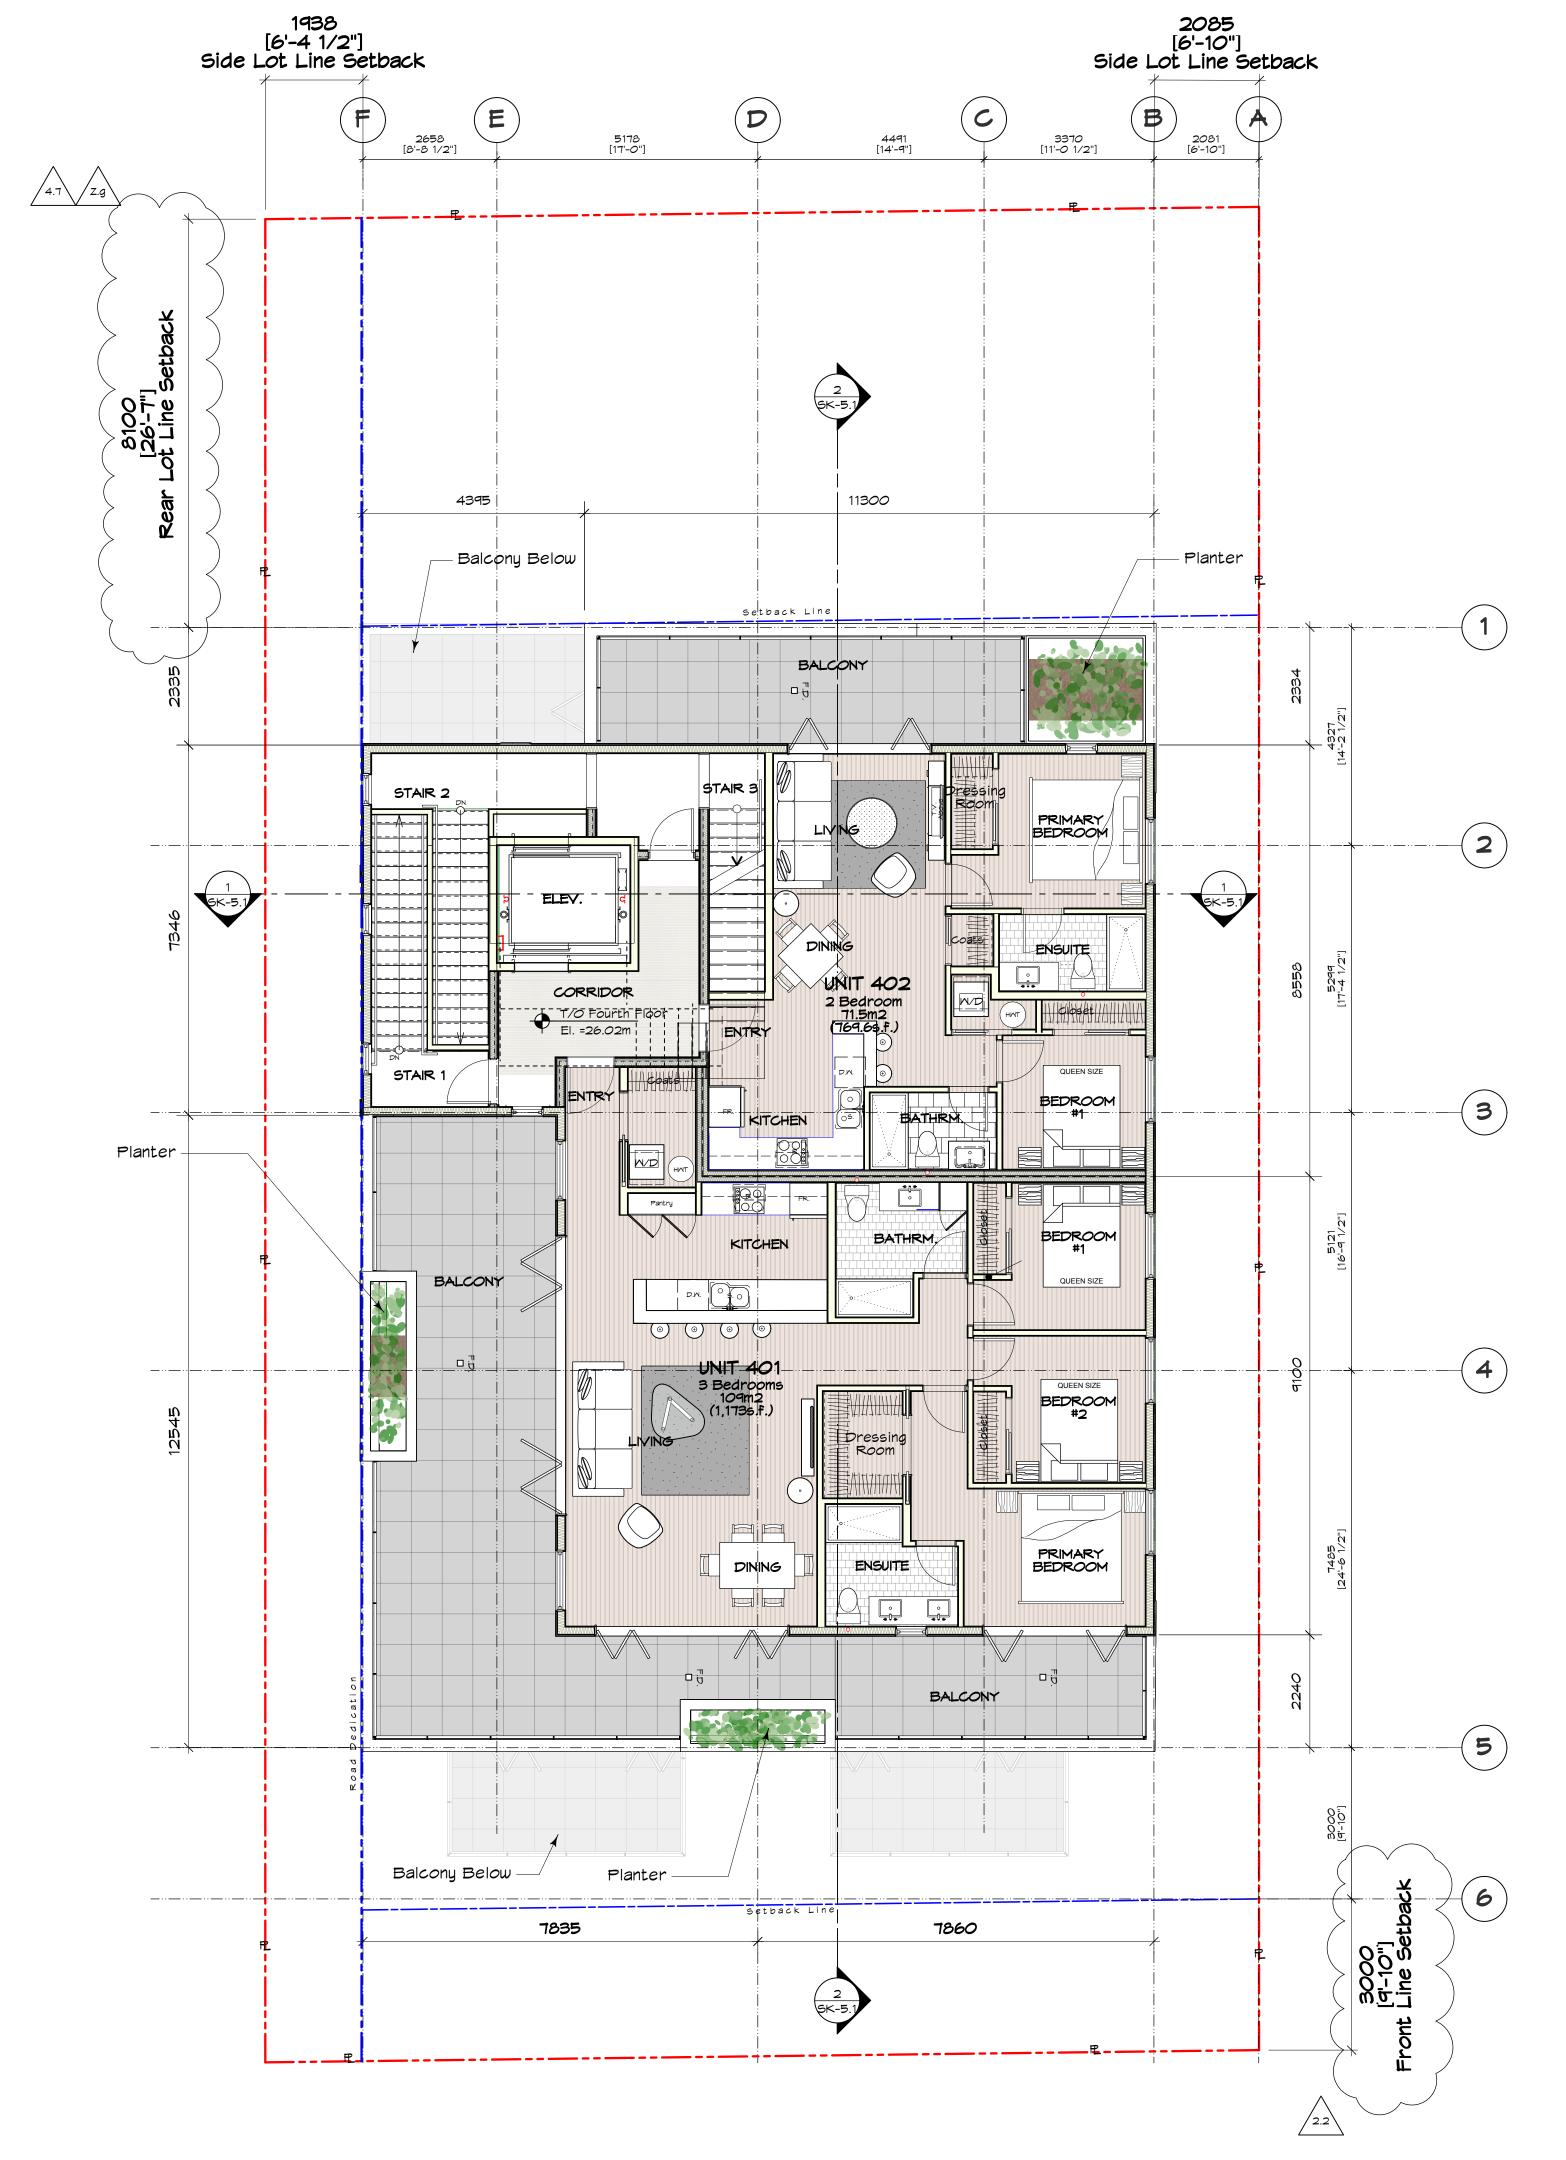


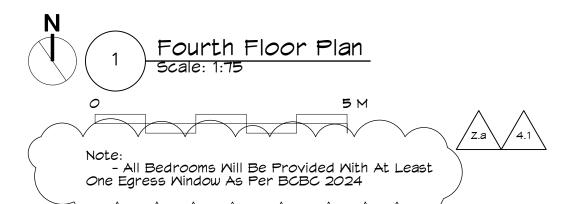


		PROJECT NAME			PROJECT NO.	
	Michael Jon Moody Principal Architect AIBC, MRAIC, LEED A.P.	4 Storey Multi-Fam 600 Dallas Road, V			23	40
MJM	Architect Inc.		· ·			
	#301, 531 Yates Street, Victoria, BC V8W 1K7	DRAWING TITLE Fourth Floor Plan	DRAWN BY:	SCALE AS NOTED	DATE: 2025-11-12	DRAWING NO.
	ph: 778.966.3513 e-mail: office@mjmarchitect.ca		CHECKED BY:	ASNOTED	YYYY-MM-DD	OIV ZI

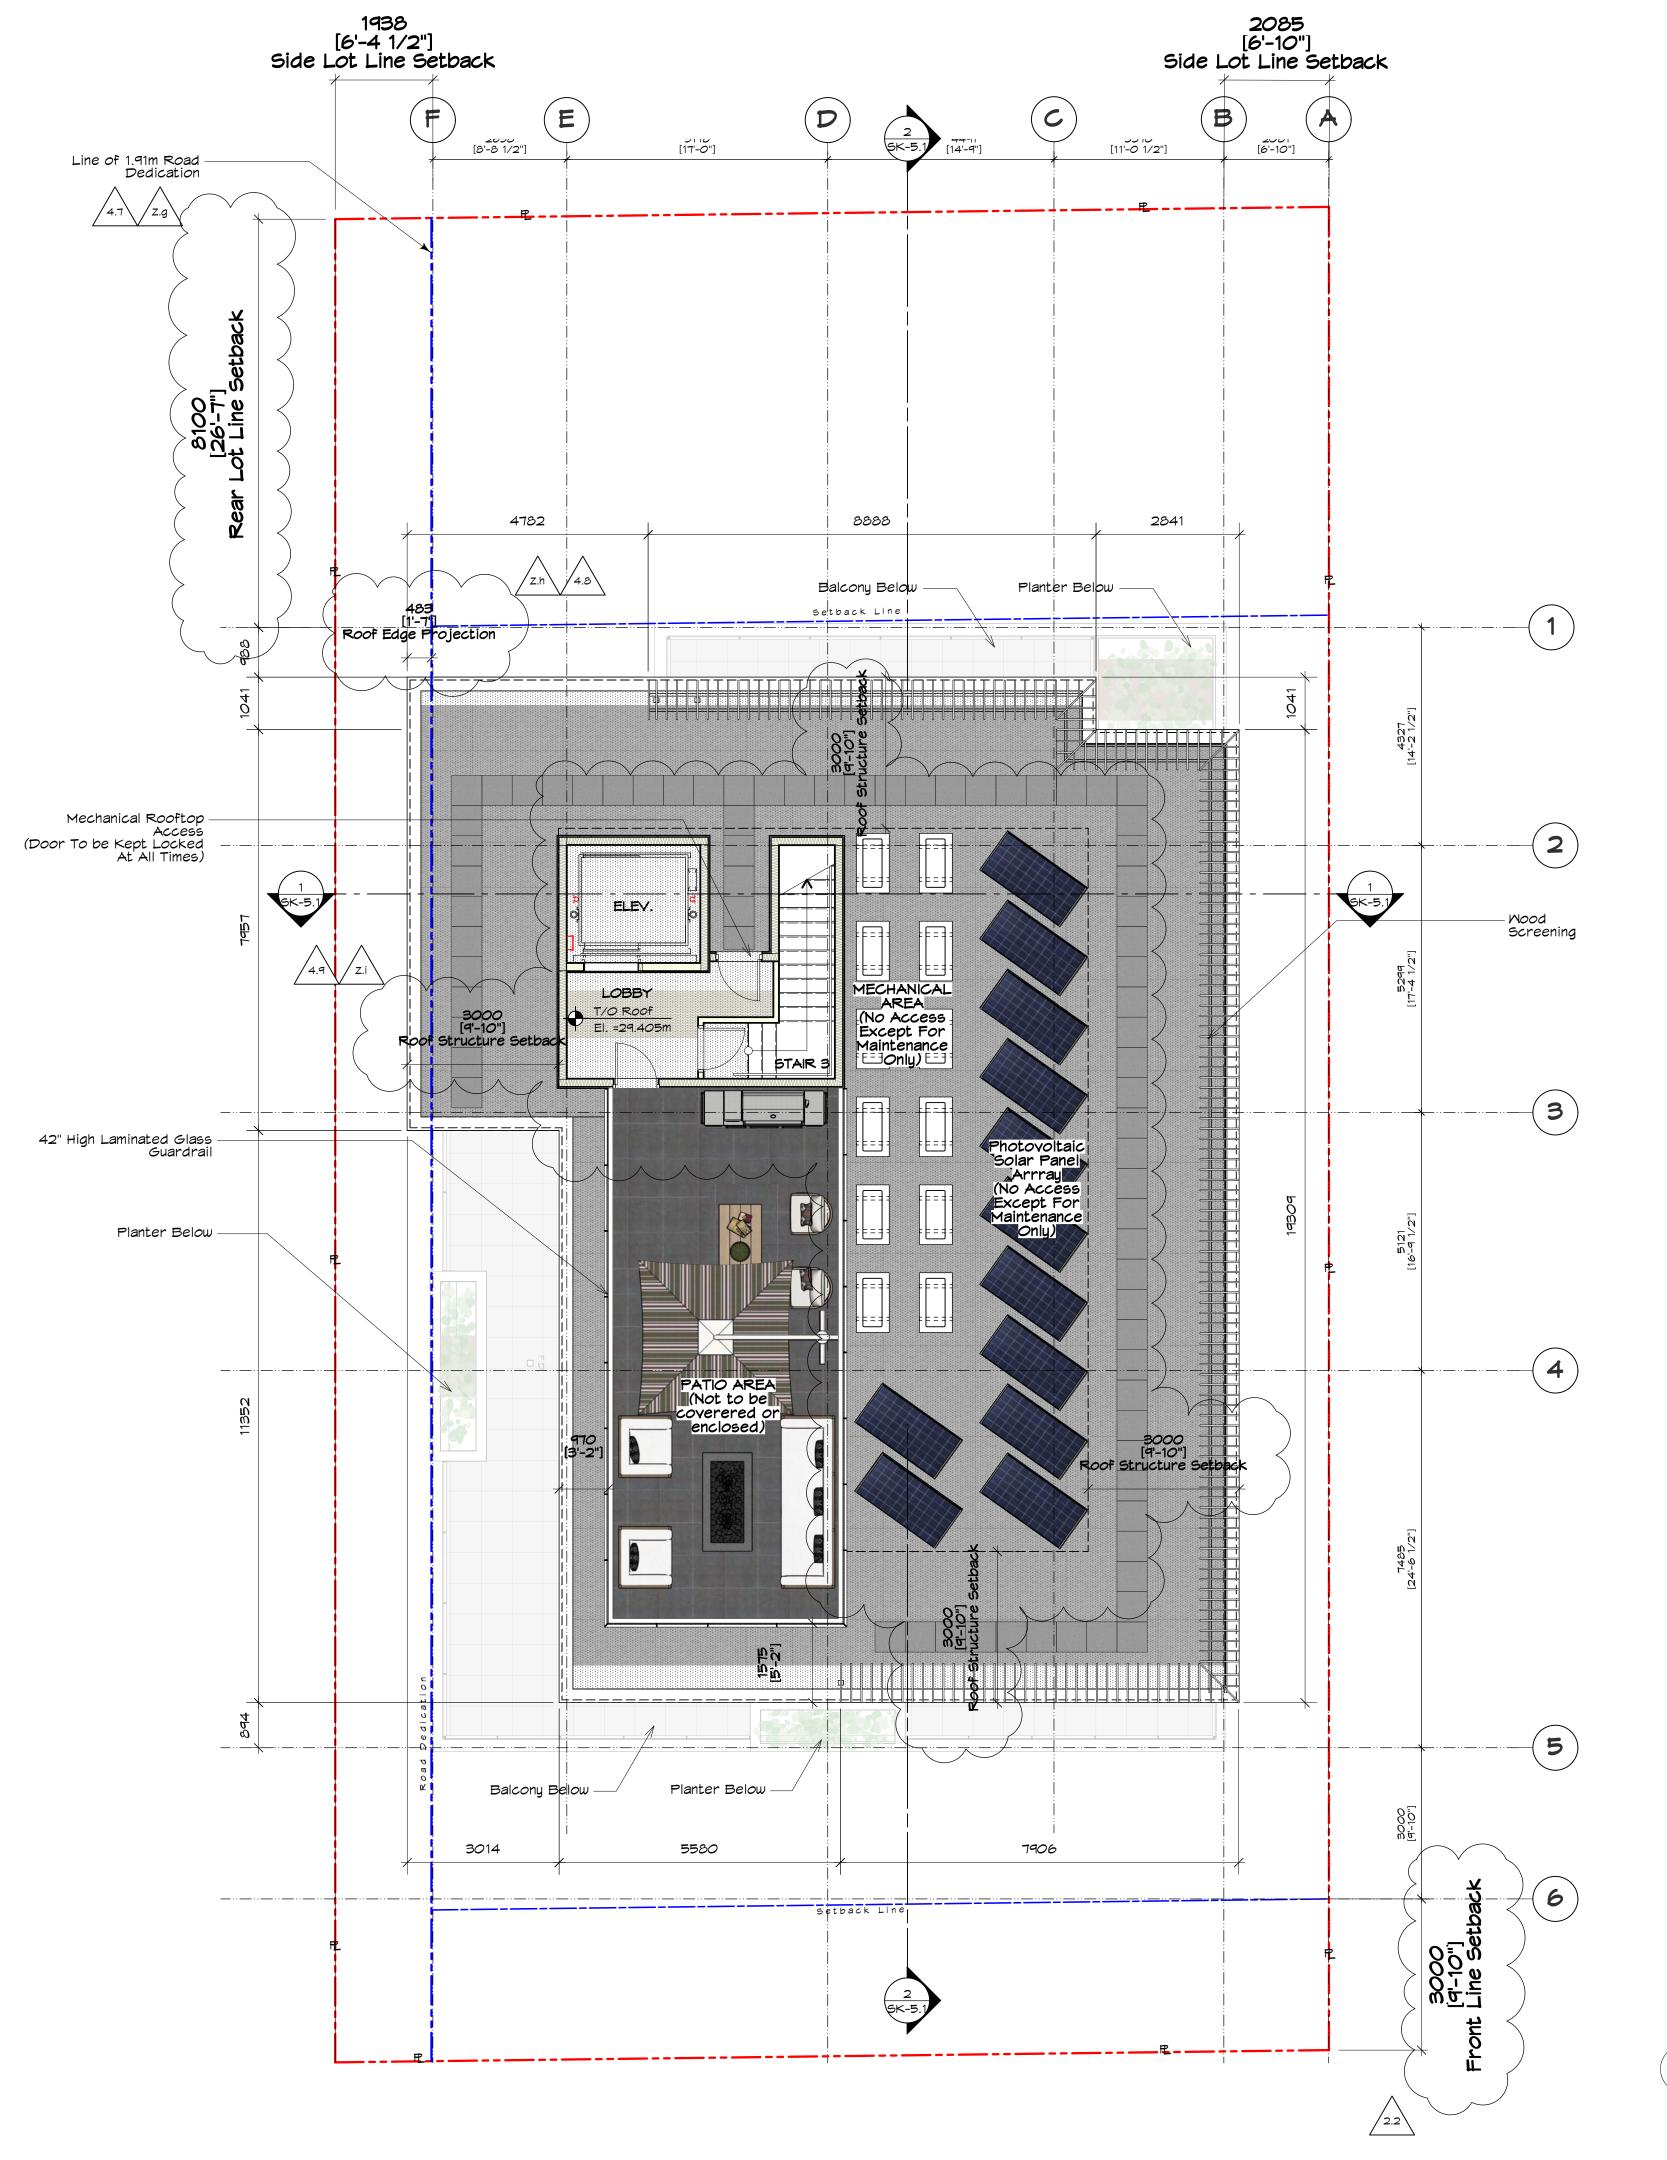

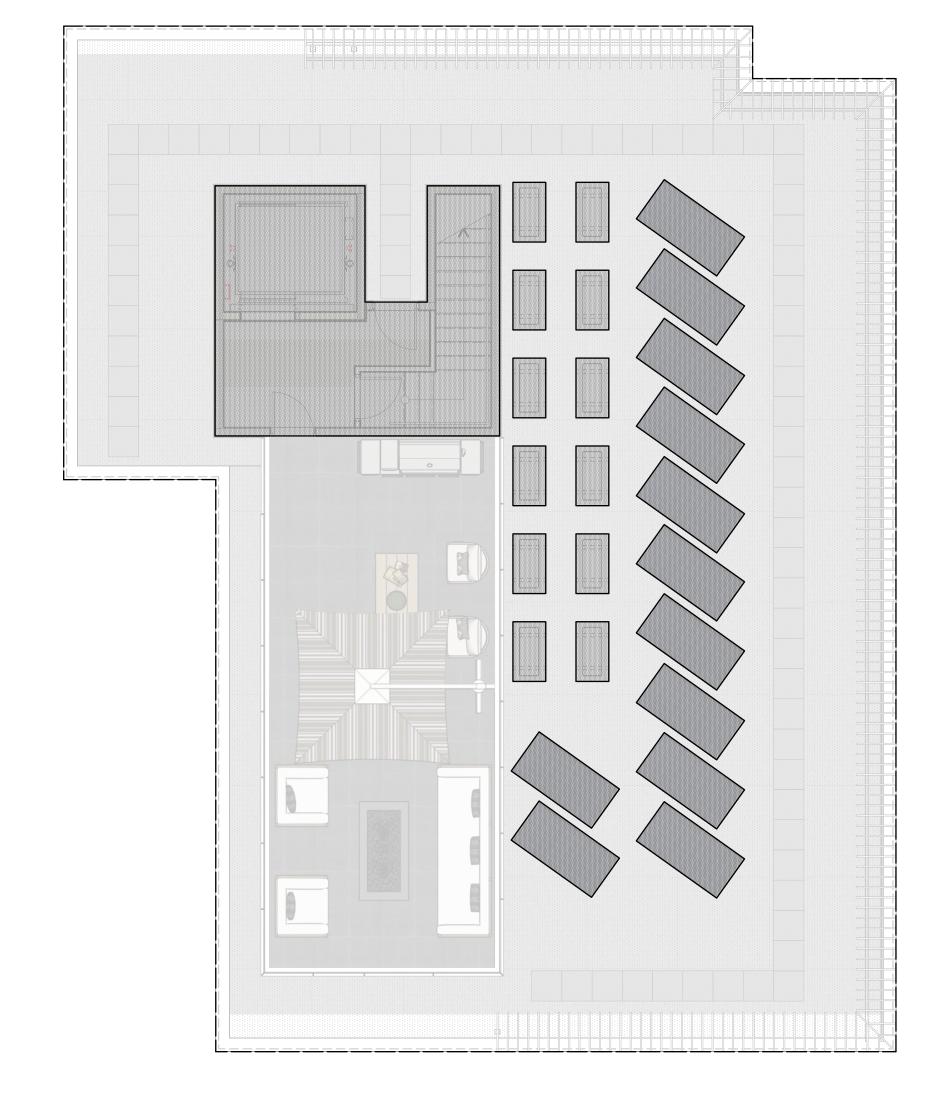

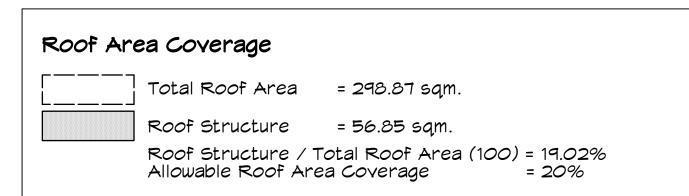

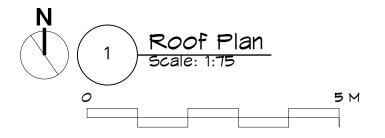

Michael Jon Moody Principal Architect AIBC, MRAIC, LEED A.P.		4 Storey Multi-Family 600 Dallas Road, Victoria, BC			PROJECT NO. 2340	
MJM A	A rchitect Inc.					
	#301, 531 Yates Street, Victoria, BC V8W 1K7	Roof Plan	DRAWN BY: MJM	scale. AS NOTED	DATE: 2025-11-12	DRAWING NO. SK-2.5
	ph: 778.966.3513				YYYY-MM-DD	










VIEW OF PROJECT FROM DALLAS ROAD



VIEW OF PROJECT FROM GOVERNMENT STREET



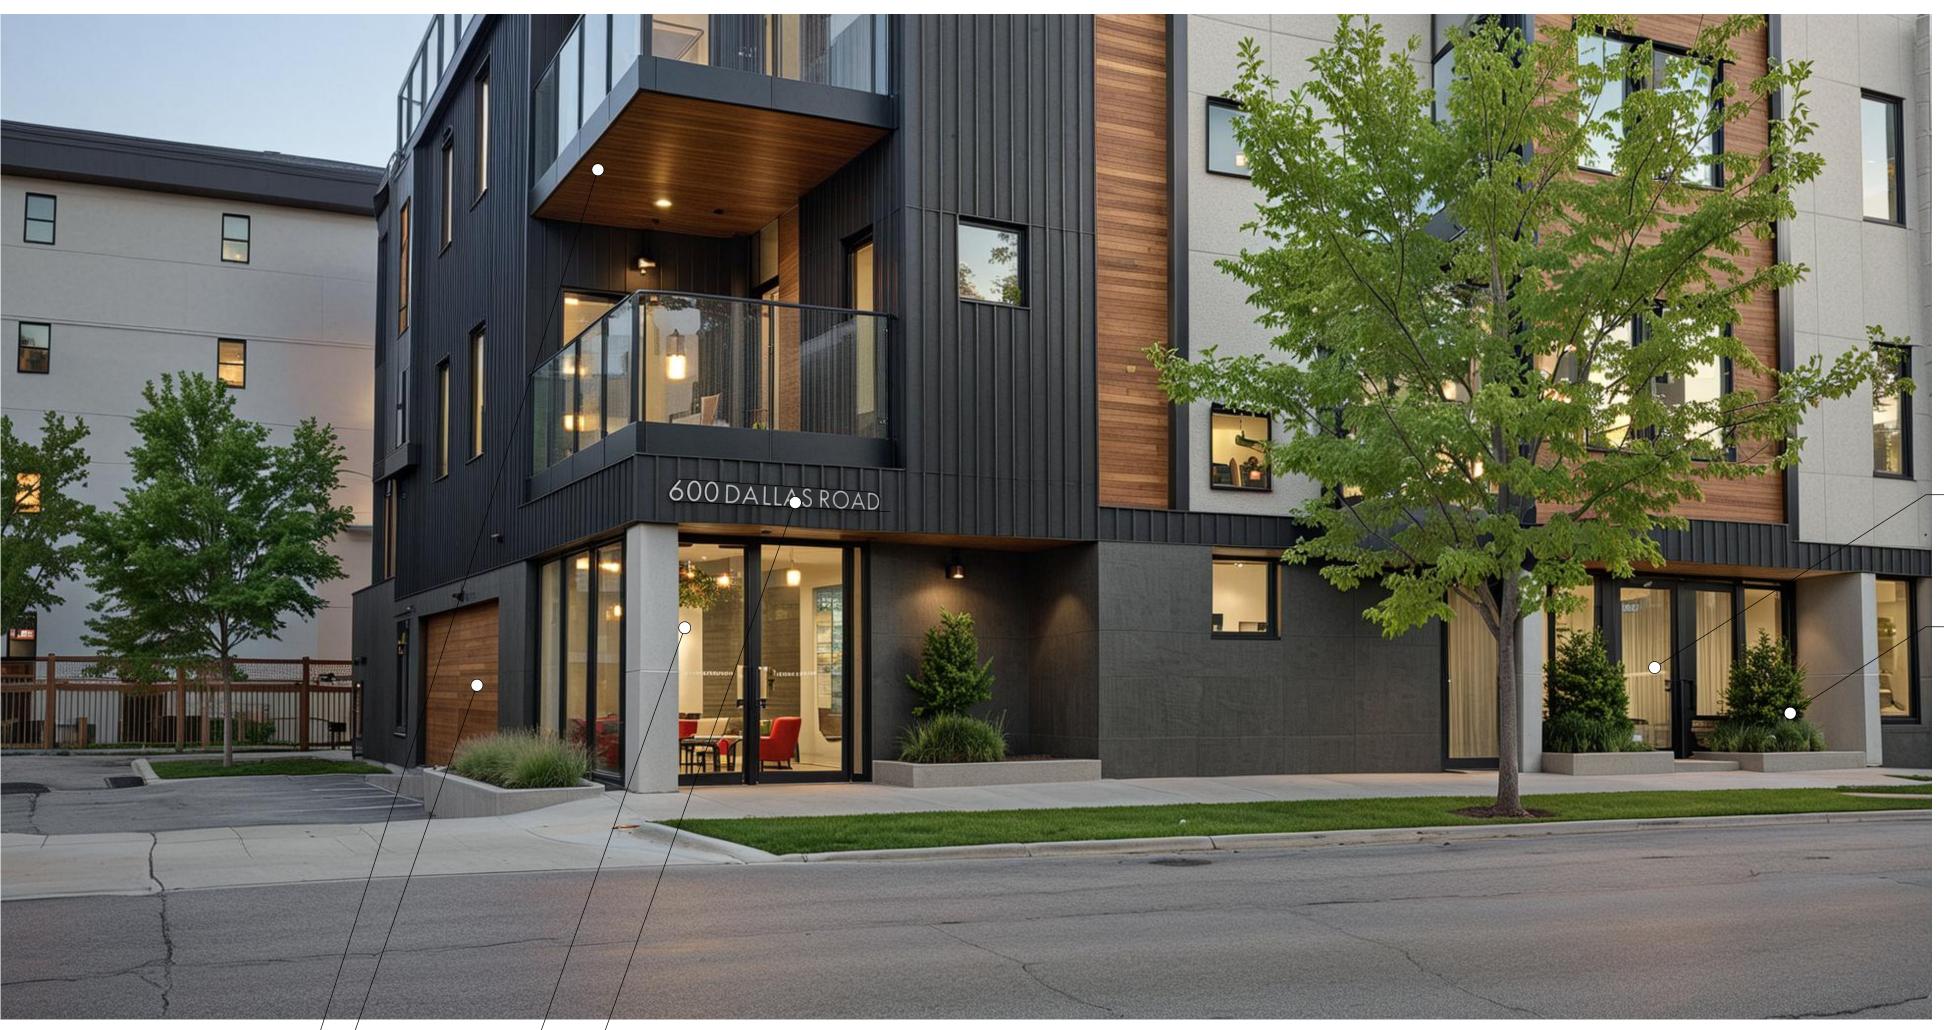

-Bicycle Room Entry Door

Planters

Metal Soffit in Faux -Mood Finish

Sectional Overhead -Mood Garage Door

> Recessed Entry Doors To-Main Lobby In Aluminum Storefront System

> > "600 DALLAS ROAD" -Signage

VIEW OF ENTRY FROM GOVERNMENT STREET


> Light Tan STucco-Claddding W/ Control Joints

> > Office & One — Bedroom Suite

Concrete Column &-Malls

New Sidewalk

New Grassed Boulevard

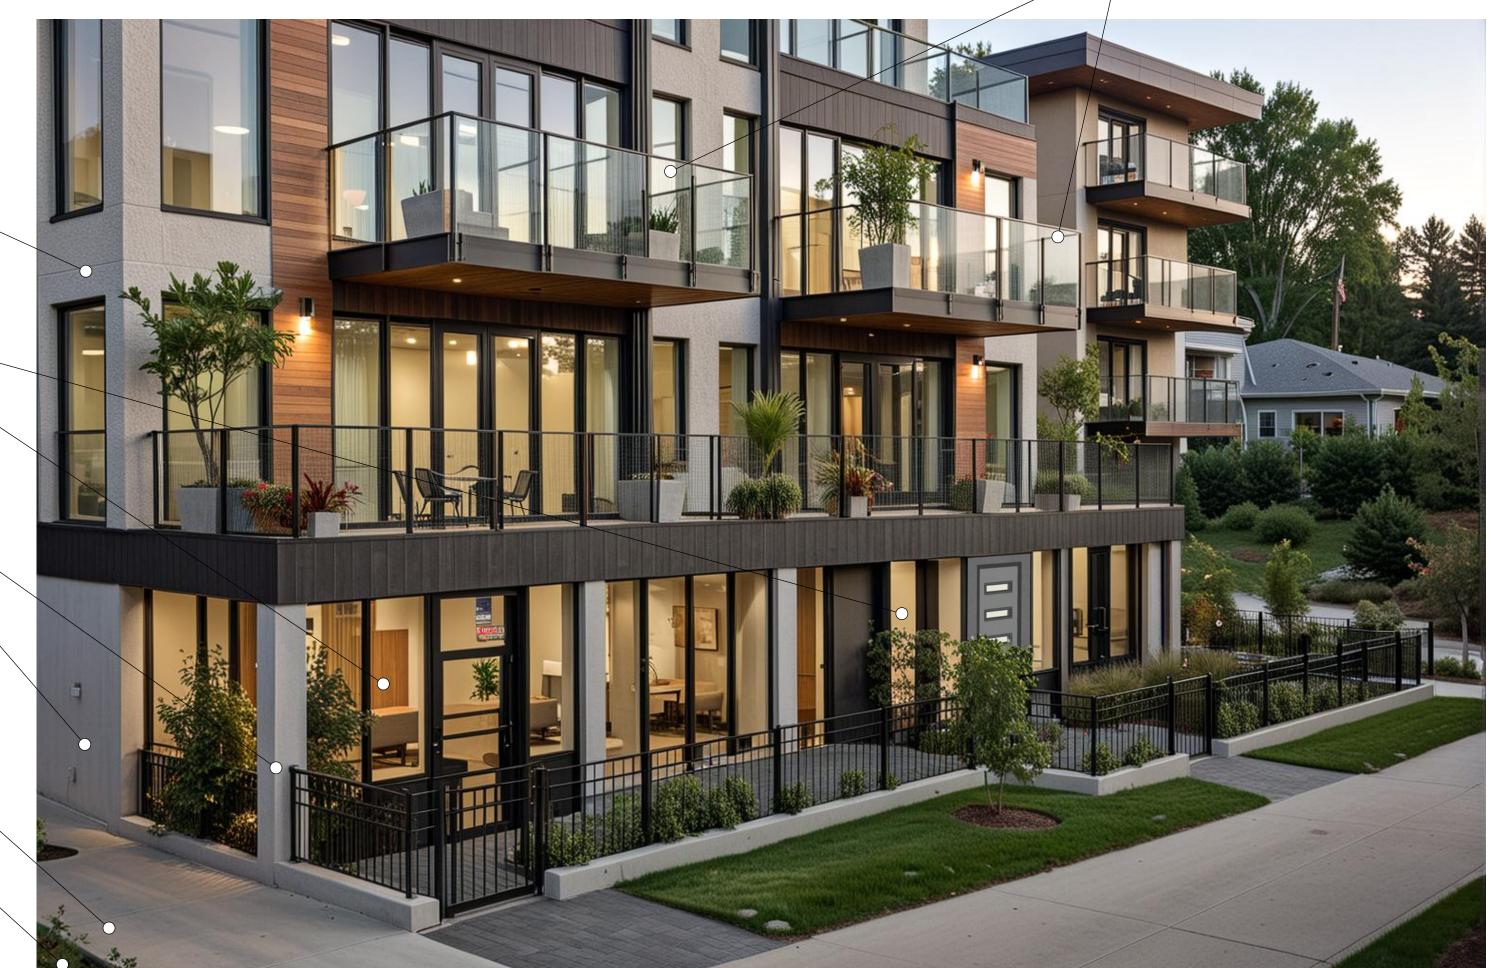

VIEW OF FRONT YARD FROM DALLAS ROAD

Conceptual Illustrations Only,
Please refer to Elevations.

	Michael Jon Moody Principal Architect AIBC, MRAIC, LEED A.P.	4 Storey Multi-Far	nily	PROJECT NO.	2340
		600 Dallas Road, \	Victoria, BC		
MJM A	rchitect Inc.				
	#301, 531 Yates Street, Victoria, BC V8W 1K7	DRAWING TITLE: Exterior Views	DRAWN BY: SCALI	e DATE: 2025-11	DRAWING NO.
	ph: 778.966.3513 e-mail: office@mjmarchitect.ca		CHECKED BY:	AS NOTED	SN-0.2

– Glass Balcony Guards









				Looking	East	on Go	vernment	Street
	5K-6.3	Scale	: 1:128					
(0							20 M

	Michael Jon Moody Principal Architect AIBC, MRAIC, LEED A.P.®	4 Storey Multi-Fai 600 Dallas Road,	Victoria, BC		23	340
MJM A	rchitect Inc.					
	#301, 531 Yates Street, Victoria, BC V8W 1K7	Streetscapes	DRAWN BY: MJM	SCALE	DATE: 2025_11_12	DRAWING NO.
	ph: 778.966.3513 e-mall: office@mjmarchitect.ca			, , , , , , , , , , , , , , , , , , , ,	YYYY-MM-DD	

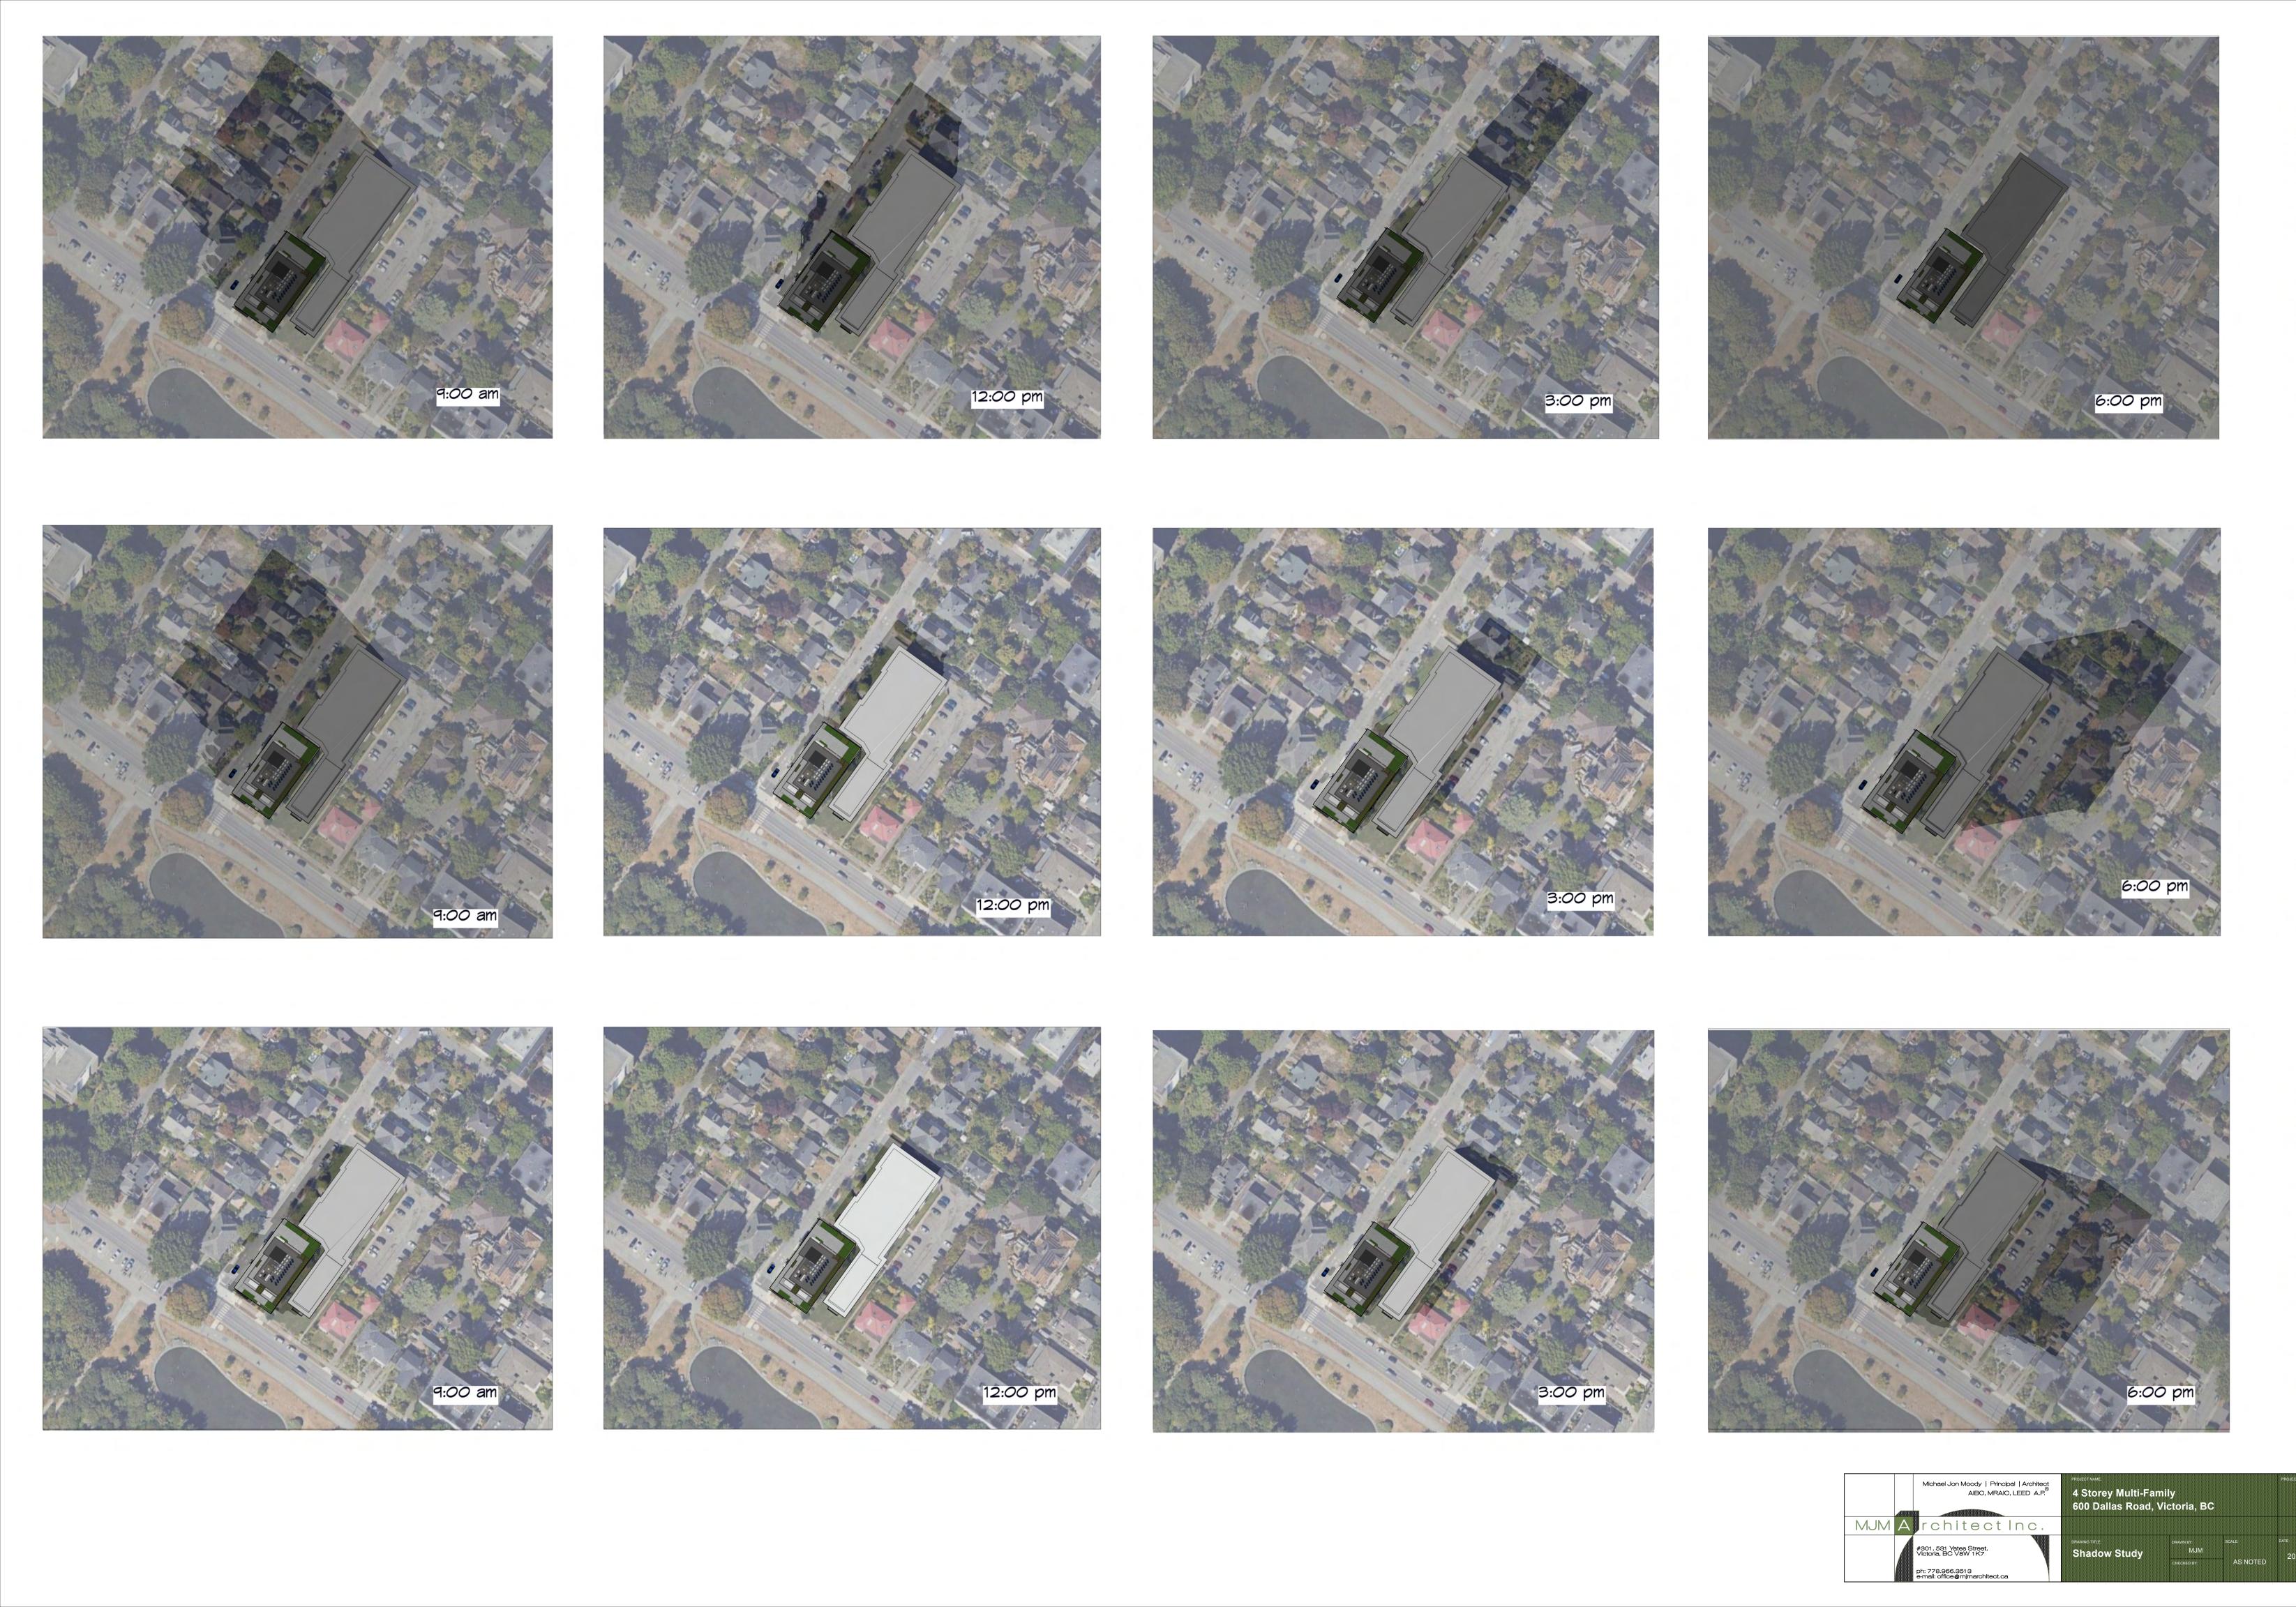

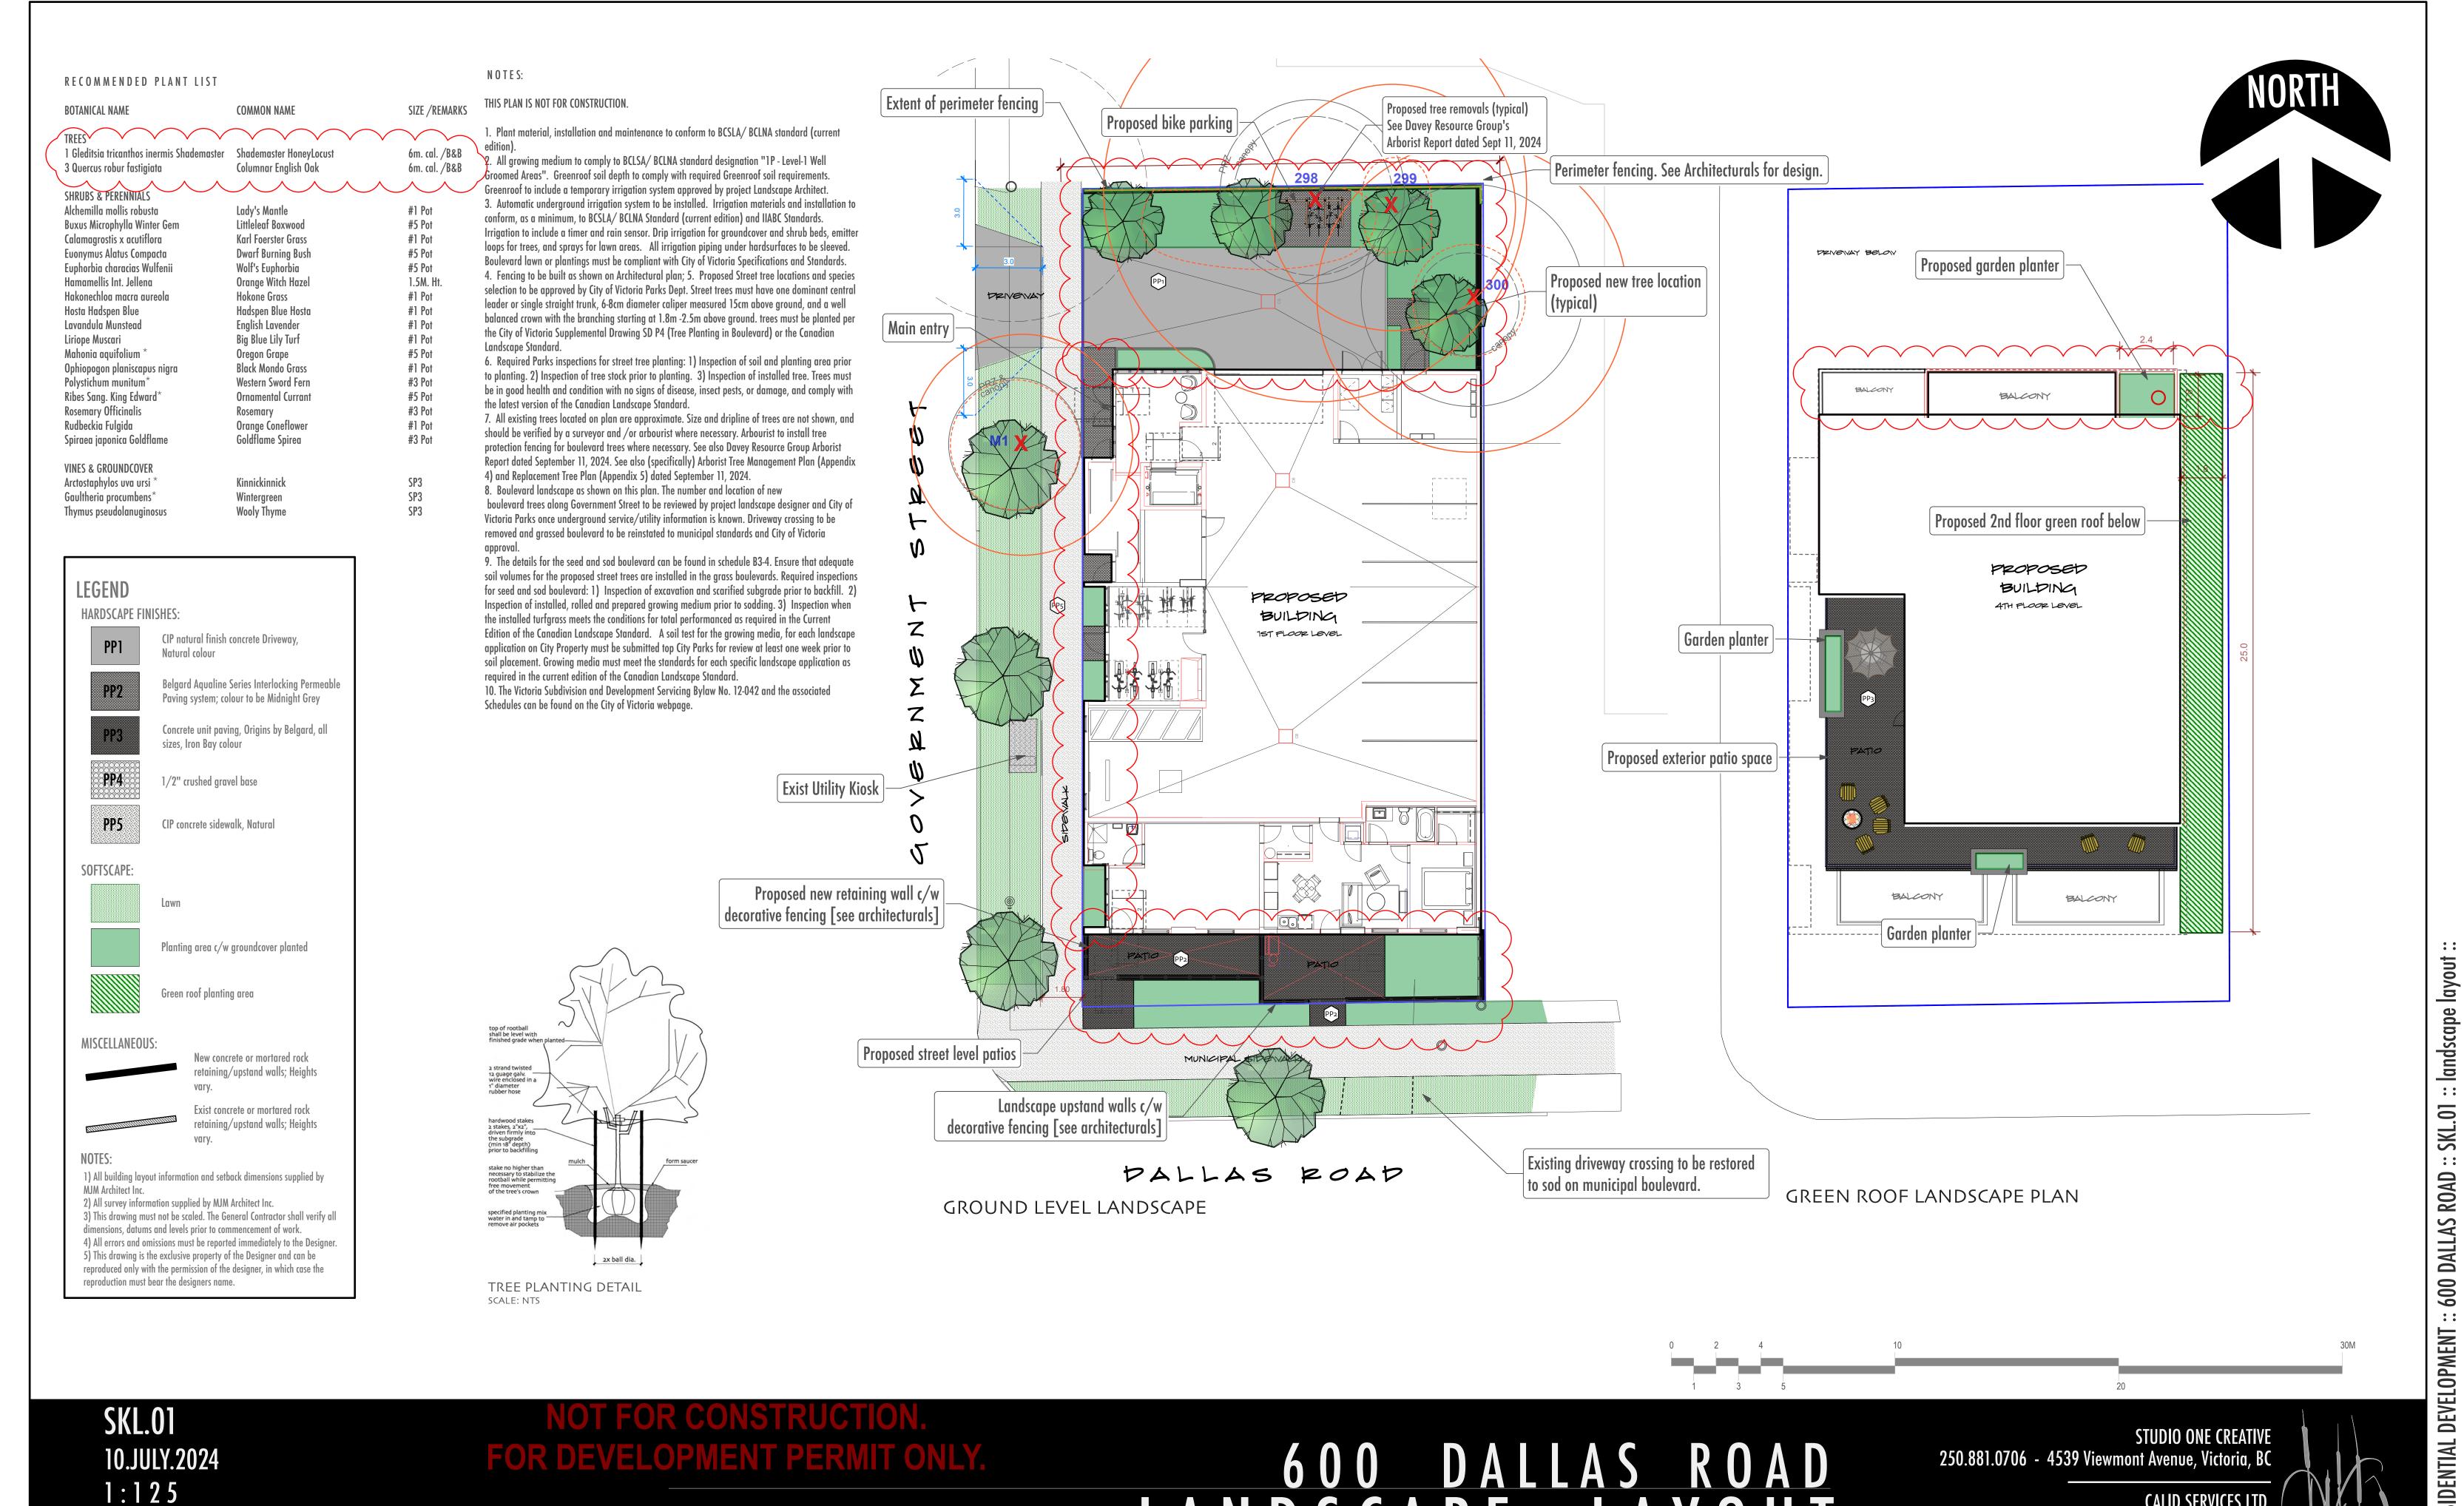

LATEST REVISION: 04.NOVEMBER.2025


600 DALLAS ROAD RESIDENTIAL DEVELOPMENT

::

• •

250.388.6919 - 2750 Quadra St, Victoria, BC

CALID SERVICES LTD

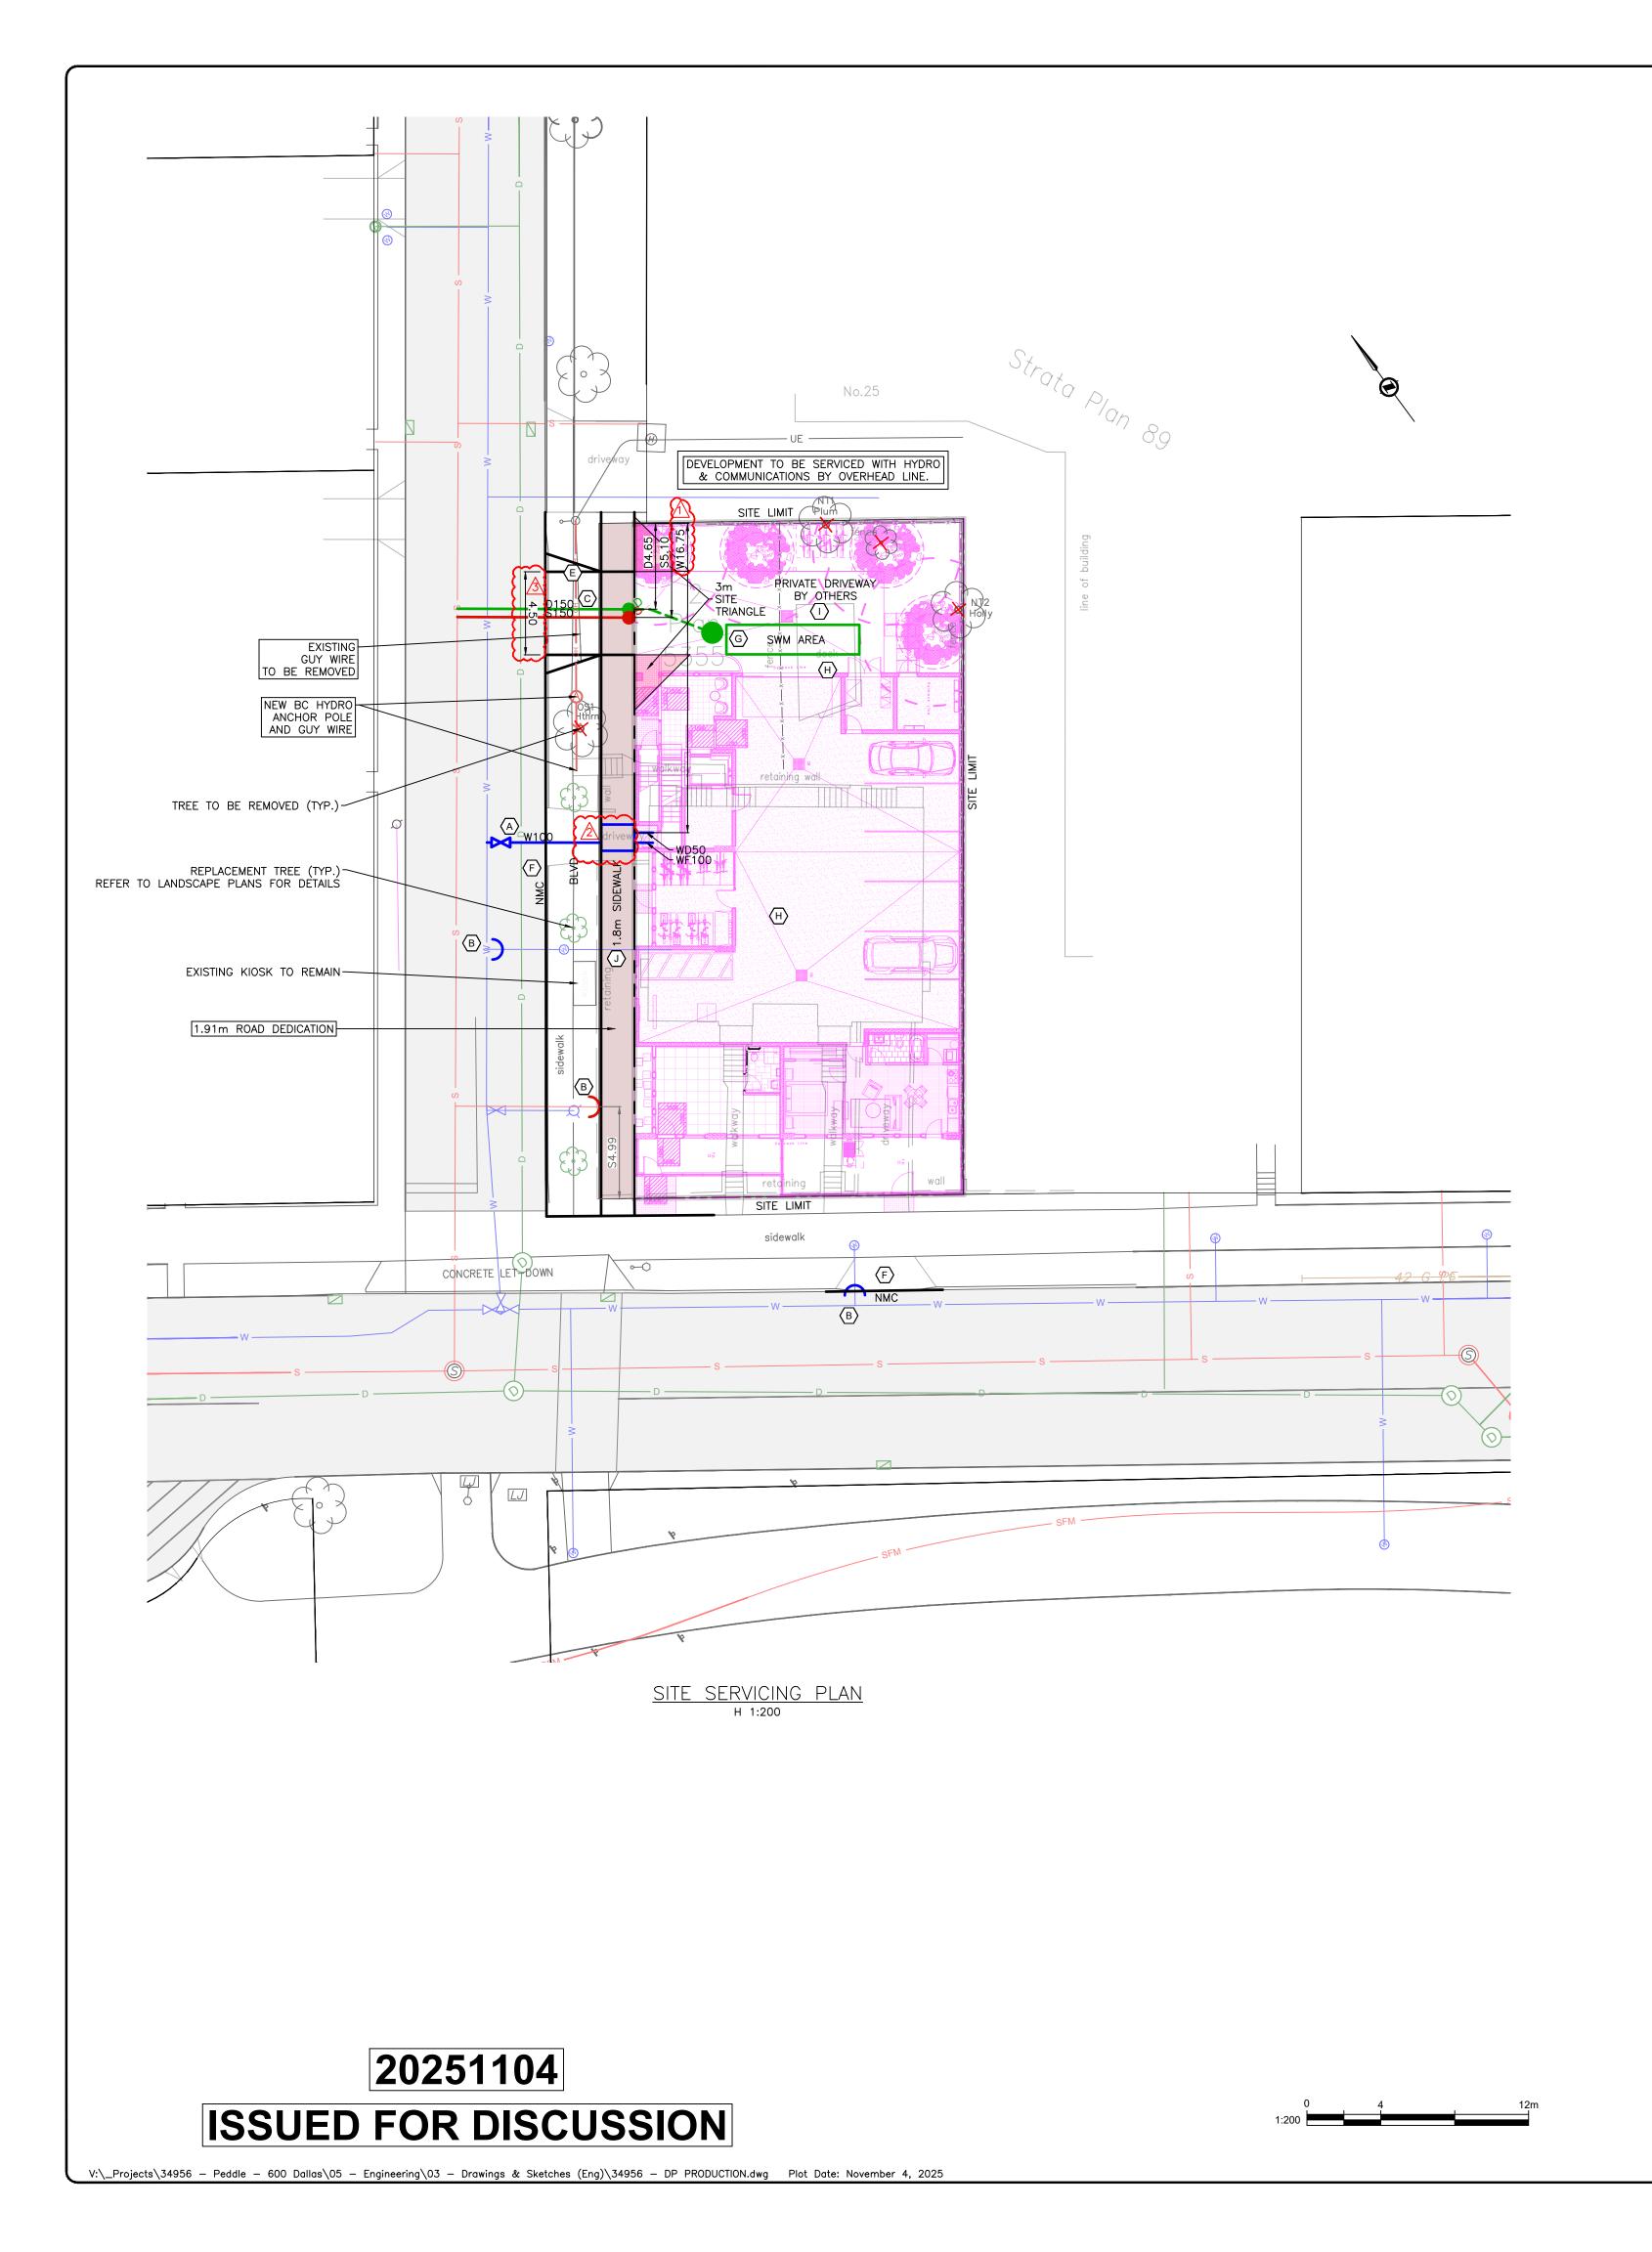

PRELIMINARY SERVICING NOTES:

- (A) NEW 100mm FIRE WATER SERVICE AND 50mm DOMESTIC WATER SERVICE C/W METER AT DEVELOPERS EXPENSE. DETAILS TO BE CONFIRMED AT BUILDING PERMIT.
- (B) SERVICES TO BE CAPPED AT DEVELOPERS EXPENSE.
- © CITY OF VICTORIA TO INSTALL NEW 150mm DRAIN SERVICE AND 150mm SEWER SERVICE IN COMMON TRENCH COMPLETE WITH IC'S AT DEVELOPERS EXPENSE.
- (E) CONTRACTOR TO INSTALL NEW 4.5m WIDE CONCRETE DRIVEWAY APRON AS PER CITY OF VICTORIA SD C7a.
- F CONTRACTOR TO REMOVE EXISTING DRIVEWAY AND SIDEWALK AND REINSTATE BOULEVARD AND INSTALL NEW NON-MOUNTABLE CURB. DETAILS TO BE CONFIRMED AT BUILDING PERMIT.
- © ONSITE STORMWATER MANAGEMENT AREA COMPLETE WITH CISTERN AND FLOW CONTROL MANHOLE AS PER CoV RAINWATER MANAGEMENT STANDARDS PROFESSIONAL EDITION. DETAILS TO BE CONFIRMED AT BUILDING PERMIT.
- (H) EXISTING STRUCTURES TO BE REMOVED. OWNER TO APPLY FOR SEPARATE DEMO PERMIT.
- (I) ONSITE GRADING FOR 6m AS PER CoV HIGHWAY ACCESS BYLAW.
- (J) CONTRACTOR TO INSTALL NEW 1.80m CONCRETE SIDEWALK PER CITY OF VICTORIA SD C15a.

PRELIMINARY RAINWATER MANAGEMENT CALCULATIONS

- PROPOSED BELOW GRADE CISTERN COMPLETE WITH FLOW CONTROL MANHOLE TO BE USED AS GREEN
- STORMWATER INFRASTRUCTURE.
 SIZING AS PER CITY OF VICTORIA RAINWATER MANAGEMENT STANDARDS SIZING APPROACH FOR CISTERNS. DESIGN MUST MEET CITY OF VICTORIA'S RAINWATER MANAGEMENT STANDARD OF MANAGING 32mm / 24hrs. FLOW CONTROL MANHOLE ORIFICE TO BE SIZED TO REDUCE POST DEVELOPMENT FLOW RATE TO PRE DEVELOPMENT RATE.

REQUIRED VOLUME OF CISTERN = 0.032m x IMPERVIOUS CONTRIBUTORY AREA IMPERVIOUS CONTRIBUTORY AREA = 340m² (ROOFS ONLY - HARDSCAPE AREAS TO DRAIN TO LANDSCAPE) REQUIRED VOLUME OF CISTERN = 0.032m x 420m²
= 13.4m³

PROPOSED CISTERN DIMENSIONS = 1.6m WIDE x 7.2m LONG x 1.2m DEEP = 13.8m³

ALL PERIMETER DRAINS TO BYPASS FLOW CONTROL DEVICES.

ALL ROOF LEADERS AND HARD SURFACE RUN-OFF TO BE DIRECTED TO ONSITE STORMWATER MANAGEMENT AREAS OR LANDSCAPED AREAS FOR TREATMENT.

DETAILED STORMWATER MANAGEMENT DESIGN AND CALCULATIONS TO BE CONFIRMED AT BUILDING PERMIT.



<u>KEY PLAN</u>

LEGAL DESCRIPTION: LOT 2, SECTION 5, BECKLEY FARM, VICTORIA CITY, PLAN 5355

BENCHMARK: MONUMENT ____ ELEV. ____

600 DALLAS PRELIMINARY SITE SERVICING

Eng. Project No. 34922 KHG



SURVEYORS - ENGINEERS

VICTORIA NANAIMO PARKSVILLE CAMPBELL RIVER PHONE: 250-727-2214 info@jeanderson.com