1701 & 1705 RICHARDSON STREET

PROJECT NUMBER: 2407

ARCHITECT

STRUCTURAL

REISSUED FOR DEVELOPMENT PERMIT - JULY 25, 2025

MCGILL & ASSOCIATES ENGINEERING

CONTACTS	DRAWING LIST

PPLICANT	GILLESPIE LAND MANAGEMENT
	CONT: GREG GILLESPIE

COVER A000 TEL: 250-858-6940 A002 CODE COMPLIANCE EMAIL: ggillespie@gillespielandmanagement.com A003 AREA CALCULATIONS

SPATIAL SEPARATION A004 COLIN HARPER ARCHITECT A005 CONTEXT PLAN AND STREETSCAPE 1839 FAIRFIELD ROAD,

ARCHITECTURAL

A101 EXISTING SITE PLAN VICTORIA, BC, V8S 1G9 A102 PROPOSED SITE PLAN CONT: COLIN HARPER A201 LEVEL 1 PLAN TEL: 778-584-0582 A202 LEVEL 2 PLAN EMAIL: charper@charch.ca A203 LEVEL 3 PLAN A204 LEVEL 4 PLAN

A205 **ROOF PLAN** 4610 ELIZABETH STREET, A301 **ELEVATIONS** PORT ALBERNI, BC, V9Y 6L7 A302 **ELEVATIONS CONT: BRANDON PAXTON** TEL: 778-679-1746 A303 MATERIAL BOARD EMAIL: bpaxton@mcgilleng.com A304 MASSING DIAGRAMS

A305 RENDERINGS **AVALON MECHANICAL MECHANICAL** A401 SECTIONS 300-1245 ESQUIMALT ROAD,

> VICTORIA, BC, V9A 3P2 CIVIL CONT: KEVIN JACKSON C01 CONCEPTUAL SITE SERVICING PLAN

> > **LANDSCAPE**

LANDSCAPE NOTES

EMAIL: kjackson@avalonmechanical.com

CONCEPT PLAN E2 ENGINEERING ELECTRICAL TREE PLAN 503 HERALD STREET, SITE PLAN VICTORIA, BC, V8W 1S6 PLANTING PLAN

> TEL: 778-433-9391 EMAIL: timothy.dalan@e2eng.ca

TEL: 250-384-4128

CONT: TIM DALAN

CIVIL ISLANDER ENGINEERING

623 DISCOVERY STREET, VICTORIA, BC, V8T 5G4 **CONT: JUSTIN EAGLE** TEL: 250-590-1200

EMAIL: justin@islanderengineering.com

GREENSPACE DESIGNS **LANDSCAPE**

> VICTORIA, BC **CONT: ERIN RENWICK** TEL: 250-893-9496

EMAIL: erin@greenspacedesigns.com

ARBORIST TALMACK URBAN FORESTRY

> 3575 DOUGLAS STREET, VICTORIA, BC, V8Z 7H6 CONT: ROBERT MCRAE TEL: 250-479-8733 EMAIL: robbie@talmack.ca

> > Revisions compared to the previously submitted plans **Received Date August 6, 2025**








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APPLICANT: GREG GILLESPIE

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1701 & 1705 **RICHARDSON** VICTORIA, BC
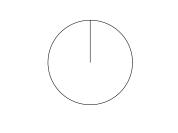
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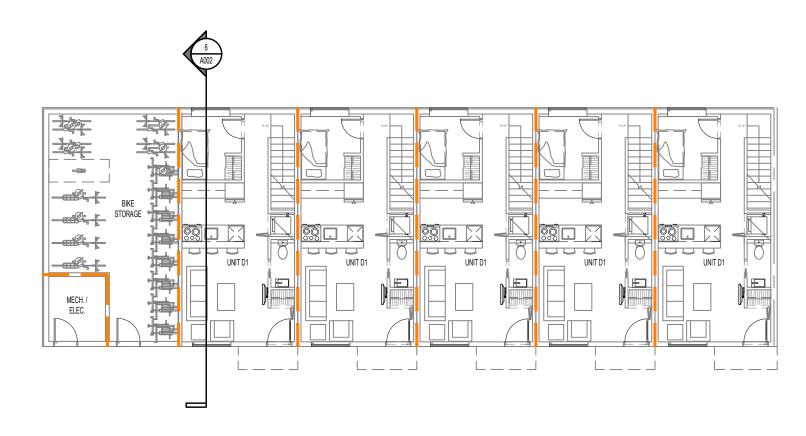
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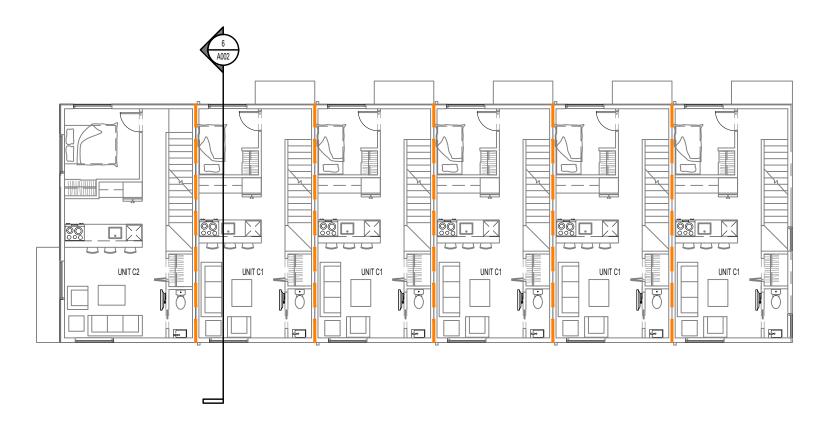
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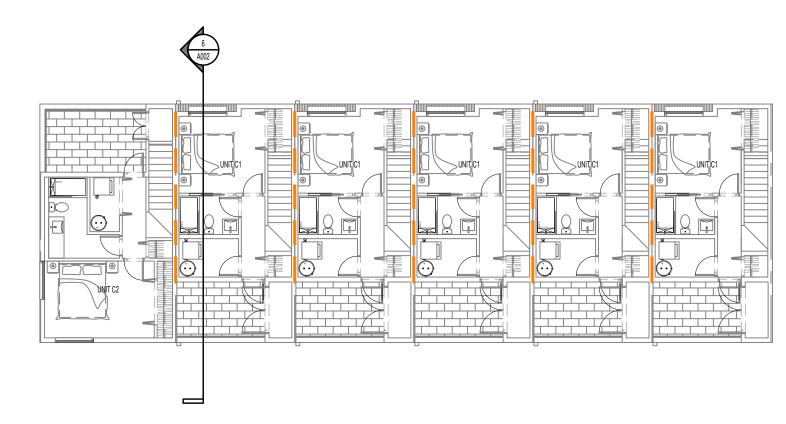


LEVEL 1 CODE PLAN


LEVEL 2 CODE PLAN



LEVEL 3 CODE PLAN



LEVEL 4 CODE PLAN

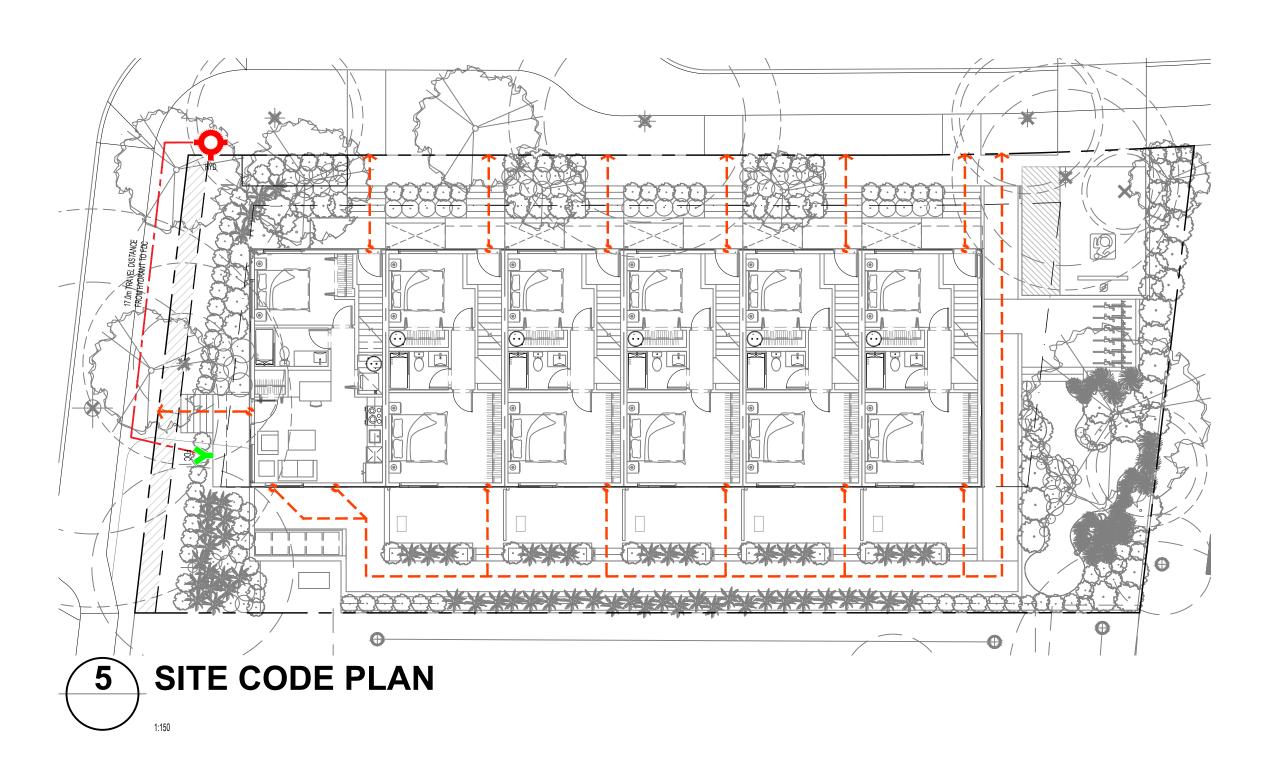



6 CODE SECTION A



TRAVEL DISTANCE LEGEND PATH OF TRAVEL **─**----<u>~----</u> EXIT DISCHARGE

CODE ANALYSIS BC BUILDING CODE 2024

DATE: 15-Apr-25

PR. #: 2407

PROJECT DESCRIPTION

4-STOREY BUILDING WITH WOOD FRAME COMBUSTIBLE CONSTRUCTION

TYPE OF WORK NEW CONSTRUCTION BASIS FOR CODE ANALYSIS PART 3 PER 1.3.3.3.(1)(c)(i)

BUILDING SIZE AND CONSTRUCTION

GOVERNING ARTICLE 3.2.2.52 PER 3.2.2.52.(1) GROUP C (RESIDENTIAL) MAJOR OCCUPANCIES OCCUPANT LOAD PER 3.1.17.1.(1)(b) 275.0 **BUILDING AREA** BUILDING HEIGHT (STOREYS) YES NFPA 13 - PER 3.2.2.52.(1)(a) & 3.2.5.12.(1) SPRINKLERED PER 3.2.4.1.(1) FIRE ALARM AND DETECTION SYSTEM YES

OTHER SAFETY REQUIREMENTS

(REQUIRED PER 3.2.5.8.(1)(a). ALTERNATE SOLUTION PENDING) STANDPIPE & HOSE SYSTEM LIMITING DISTANCE UNPROTECTED OPENINGS ARE IN COMPLIANCE. SEE SHEET A002 17.0m TRAVEL DISTANCE FROM HYDRANT TO FDC (45M ALLOWED) FIREFIGHTING ACCESS ROUTES STORAGE ROOM SPRINKLERS PER 3.3.4.3.(1)

COMBUSTIBLE OR NONCOMBUSTIBLE

PER 3.2.7.

PER 3.8.2.1.(1)(b)

PER CITY OF VICTORIA REQUIREMENTS

REQUIRED FIRE SEPARATION / FIRE-RESISTANCE RATINGS

LIGHTING AND EMERGENCY POWER SYSTEMS

TYPE OF CONSTRUCTION PERMITTED

FRR OF FLOOR ASSEMBLIES PER 3.2.2.52.(2)(a) FRR OF ROOF ASSEMBLIES PER 3.2.2.13 FRR OF LOADBEARING WALLS, COLUMNS, AND ARCHES PER 3.2.2.52.(2)(c) FRR BETWEEN SUITES PER 3.3.4.2.(1) FRR BTW ELECTRICAL ROOM AND BIKE ROOM PER 3.6.2.1.(6) FRR BTW BIKE ROOM AND RESIDENTIAL PER 3.3.4.2.(1) FIRE SEPARATION OF FLOOR ENTIRELY CONTAINED WITHIN DWELLING N/A PER 3.2.2.52.(3) UNITS HAVING MORE THAN ONE STOREY

ACCESSIBILITY REQUIREMENTS TOWNHOUSE DWELLING UNITS

ENERGY EFFICIENCY

STEP CODE 3


REQUIRED ALTERNATE SOLUTIONS

ARTICLE MITIGATING FEATURE


EGRESS FROM DWELLING UNITS - PER 3.3.4.4.(3) EXIT EXPOSURE - PER 3.2.3.13.

STANDPIPE SYSTEM - PER 3.2.5.8. *ALTERNATE SOLUTION REPORT TO BE PROVIDED BY BUILDING CODE CONSULTANTS AT BUILDING PERMIT SUBMISSION

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MAX. TRAVEL DISTANCE IS 45m. SEE BCBC 3.4.2.5. THE MINIMUM DISTANCE BETWEEN EXITS SHOULD BE 9m. SEE BCBC 3.4.2.3.

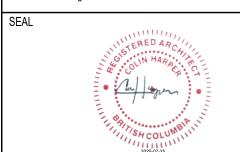APPLICANT: GREG GILLESPIE

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PROJECT NAME
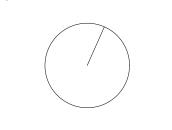
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PROJECT ADDRESS:


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CODE COMPLIANCE

PROJECT NO: 2407 DRAWN BY: KG AS NOTED REVIEW BY: CH




STECOVERAGE 314.7m² (3.87.5sf)

OPEN STIES SPACE 384 Ont (4, 133.38)

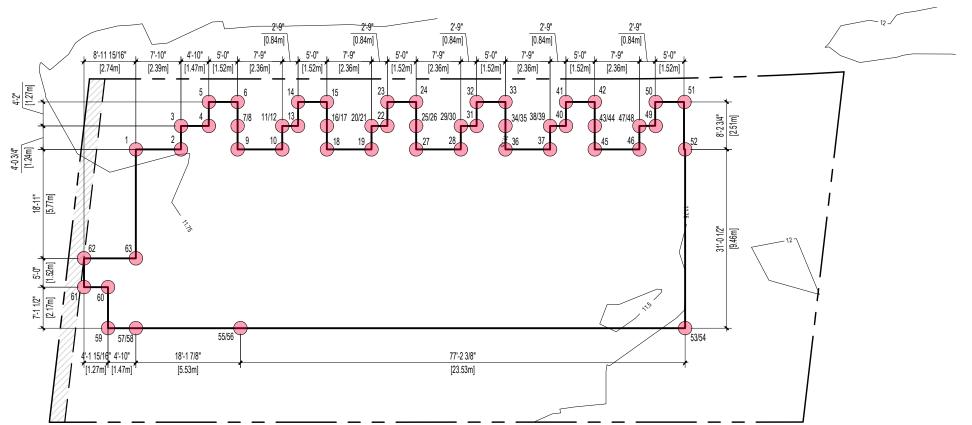


ZONING (GRADE C	ALCULATION	ON		GRADES			
RADE POINT	S (m)	LENGTH (m)	GRADE CALCS	_	Grade Points	Existing	Proposed	Grad
11.79	2 11.76	2.39	(11.79 + 11.76) ÷ 2 x 2.39m =	28.14	1	11.79	11.79	11.7
11.76	3 11.81	1.24	(11.76 + 11.81) ÷ 2 x 1.24m =	14.61	2	11.76	11.76	11.7
11.81	4 11.80	1.47	(11.81 + 11.8) ÷ 2 x 1.47m =	17.35	3	11.81	11.81	11.8
11.80	5 11.89	1.27	(11.8 + 11.89) ÷ 2 x 1.27m =	15.04	4	11.80	11.80	11.8
11.89	6 11.79	1.52	(11.89 + 11.79) ÷ 2 x 1.52m =	18.00	5	11.89	11.89	11.8
11.79	7 11.78	1.27	(11.79 + 11.78) ÷ 2 x 1.27m =	14.97	6	11.79	11.79	11.7
11.46	9 11.46	1.24	(11.46 + 11.46) ÷ 2 x 1.24m =	14.21	7	11.78	11.78	11.7
11.46	10 11.46	2.36	(11.46 + 11.46) ÷ 2 x 2.36m =	27.05	8	11.78	11.46	11.4
0 11.46	11 11.46	1.24	(11.46 + 11.46) ÷ 2 x 1.24m =	14.21	9	11.77	11.46	11.4
2 11.78	13 11.77	0.84	(11.78 + 11.77) ÷ 2 x 0.84m =	9.89	10	11.77	11.46	11.4
3 11.77	14 11.77	1.27	(11.77 + 11.77) ÷ 2 x 1.27m =	14.95	11	11.78	11.46	11.4
11.77	15 11.76	1.52	(11.77 + 11.76) ÷ 2 x 1.52m =	17.88	12	11.78	11.78	11.7
5 11.76	16 11.75	1.27	(11.76 + 11.75) ÷ 2 x 1.27m =	14.93	13	11.77	11.77	11.7
7 11.46	18 11.46	1.24	(11.46 + 11.46) ÷ 2 x 1.24m =	14.21	14	11.77	11.77	11.7
3 11.46	19 11.46	2.36	(11.46 + 11.46) ÷ 2 x 2.36m =	27.05	15	11.76	11.76	11.7
11.46	20 11.46	1.24	$(11.46 + 11.46) \div 2 \times 1.24m =$	14.21	16 17	11.75	11.75 11.46	11.7 11.4
11.72	22 11.71	0.84	$(11.72 + 11.71) \div 2 \times 0.84m =$	9.84	18	11.75 11.75	11.46	11.4
2 11.71 3 11.73	23 11.73 24 11.73	1.27	(11.71 + 11.73) ÷ 2 x 1.27m = (11.73 + 11.73) ÷ 2 x 1.52m =	14.88	19	11.70	11.46	11.4
3 11.73 1 11.73	25 11.72	1.52 1.27	$(11.73 + 11.73) \div 2 \times 1.32m =$ $(11.73 + 11.72) \div 2 \times 1.27m =$	17.83 14.89	20	11.70	11.46	11.4
5 11.46	27 11.46	1.24	$(11.75 + 11.72) \div 2 \times 1.27m =$ $(11.46 + 11.46) \div 2 \times 1.24m =$	14.21	21	11.72	11.72	11.
7 11. 4 6 7 11.46	28 11.46	2.36	$(11.46 + 11.46) \div 2 \times 2.36m =$	27.05	22	11.72	11.72	11.
3 11.46	29 11.46	1.24	$(11.46 + 11.46) \div 2 \times 1.24m =$	14.21	23	11.73	11.73	11.
) 11.72	31 11.72	0.84	$(11.72 + 11.72) \div 2 \times 0.84m =$	9.84	24	11.73	11.73	11.
11.72	32 11.73	1.27	$(11.72 + 11.72) \div 2 \times 0.04m =$	14.89	25	11.72	11.72	11.
11.73	33 11.74	1.52	$(11.73 + 11.74) \div 2 \times 1.52m =$	17.84	26	11.72	11.46	11.
3 11.74	34 11.74	1.27	(11.74 + 11.74) ÷ 2 x 1.27m =	14.91	27	11.71	11.46	11.4
11.46	36 11.46	1.24	(11.46 + 11.46) ÷ 2 x 1.24m =	14.21	28	11.71	11.46	11
5 11.46	37 11.46	2.36	(11.46 + 11.46) ÷ 2 x 2.36m =	27.05	29	11.72	11.46	11.
11.46	38 11.46	1.24	(11.46 + 11.46) ÷ 2 x 1.24m =	14.21	30	11.72	11.72	11.
11.82	40 11.84	0.84	(11.82 + 11.84) ÷ 2 x 0.84m =	9.94	31	11.72	11.72	11.
) 11.84	41 11.85	1.27	(11.84 + 11.85) ÷ 2 x 1.27m =	15.04	32	11.73	11.73	11.3
11.85	42 11.88	1.52	(11.85 + 11.88) ÷ 2 x 1.52m =	18.03	33	11.74	11.74	11.7
11.88	43 11.86	1.27	(11.88 + 11.86) ÷ 2 x 1.27m =	15.07	34	11.74	11.74	11.3
11.46	45 11.46	1.24	(11.46 + 11.46) ÷ 2 x 1.24m =	14.21	35	11.74	11.46	11.4
11.46	46 11.46	2.36	(11.46 + 11.46) ÷ 2 x 2.36m =	27.05	36	11.75	11.46	11.
11.46	47 11.46	1.24	(11.46 + 11.46) ÷ 2 x 1.24m =	14.21	37	11.81	11.46	11.
3 11.82	49 11.80	0.84	(11.82 + 11.8) ÷ 2 x 0.84m =	9.92	38	11.82	11.46	11.4
11.80	50 11.85	1.27	(11.8 + 11.85) ÷ 2 x 1.27m =	15.02	39	11.82	11.82	11.8
11.85	51 11.83	1.52	(11.85 + 11.83) ÷ 2 x 1.52m =	18.00	40	11.84	11.84	11.
11.83	52 11.73	2.51	(11.83 + 11.73) ÷ 2 x 2.51m =	29.57	41	11.85	11.85	11.8
11.73	53 10.67	9.46	(11.73 + 10.67) ÷ 2 x 9.46m =	105.95	42	11.88	11.88	11.8
9.98	55 9.98	23.53	(9.98 + 9.98) ÷ 2 x 23.53m =	234.83	43	11.86	11.86	11.8
10.43	57 10.43	5.53	(10.43 + 10.43) ÷ 2 x 5.53m =	57.68	44	11.86	11.46	11.4
3 11.57	59 11.56	1.47	(11.57 + 11.56) ÷ 2 x 1.47m =	17.00	45	11.84	11.46	11.4
11.56	60 11.61	2.17	(11.56 + 11.61) ÷ 2 x 2.17m =	25.14	46	11.79	11.46	11.4
11.61	61 11.68	1.27	(11.61 + 11.68) ÷ 2 x 1.27m =	14.79	47	11.82	11.46	11.4
11.68	62 11.71	1.52	(11.68 + 11.71) ÷ 2 x 1.52m =	17.78	48	11.82	11.82	11.
2 11.71	63 11.73	2.74	(11.71 + 11.73) ÷ 2 x 2.74m =	32.11	49	11.80	11.80	11.8
3 11.73	1 11.79	5.77	(11.73 + 11.79) ÷ 2 x 5.77m =	67.86	50	11.85	11.85	11.8
TALS		112.56		1261.75	51	11.83	11.83	11.8
/ERAGE GRA	ADE			11.21	52	11.77	11.73	11.
					53	11.86	10.67	10.6
					54	11.86	9.98	9.9
					55	11.67	9.98	9.9
					56	11.67	10.43	10.4
					57	11.57	10.43	10.4
					58	11.57	11.57	11.5
					59	11.56	11.56	11.5
					60	11.61	11.61	11.0
					61	11.68	11.68	11.6



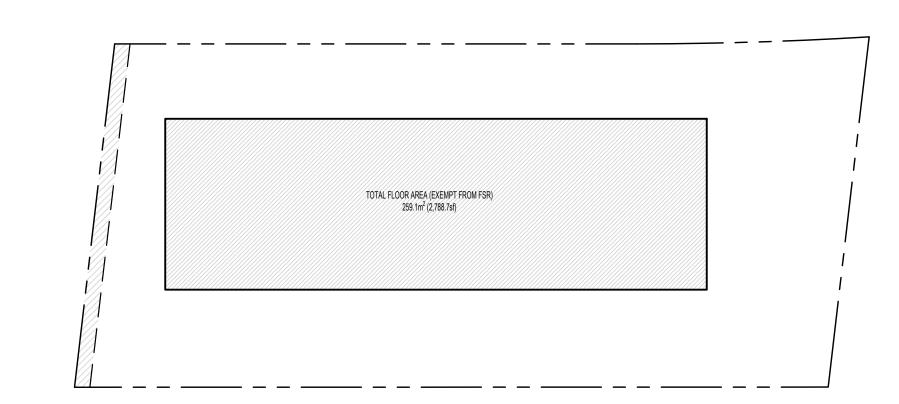




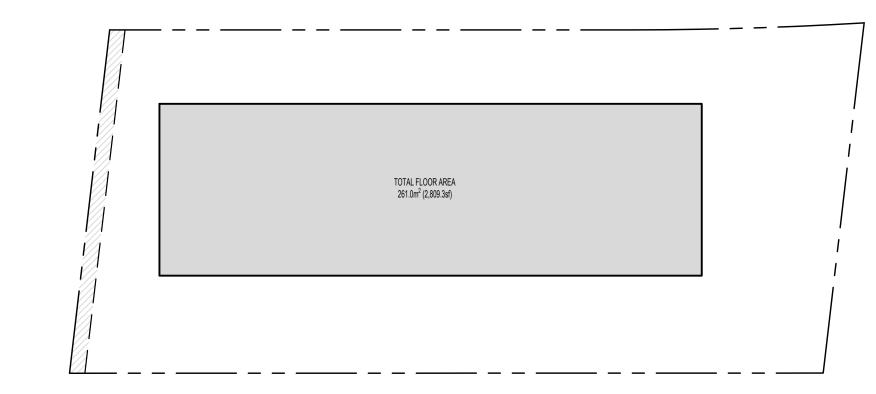


6 LEVEL 3 FLOOR AREA CALC



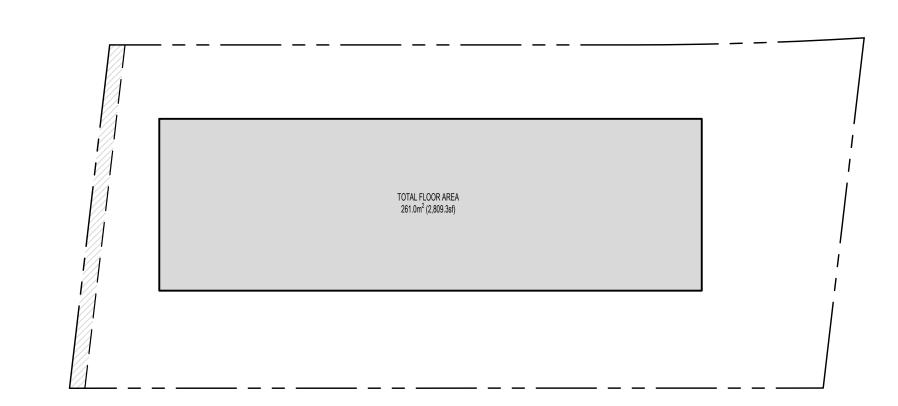

5 LEVEL 2 FLOOR AREA CALC

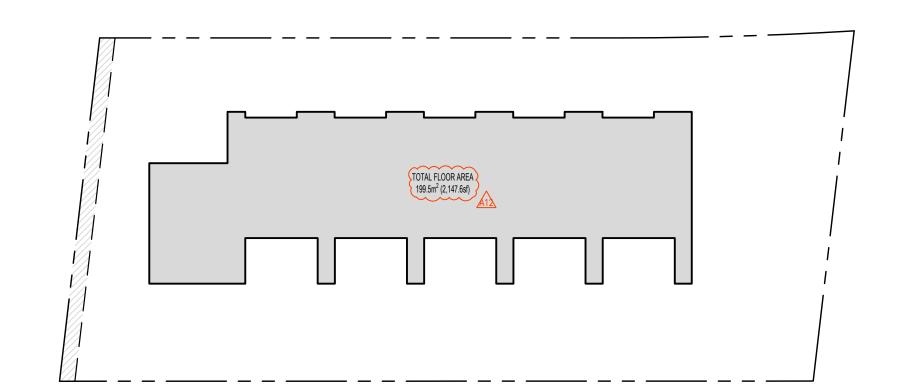


7 LEVEL 4 FLOOR AREA CALC

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REISSUED FOR DEVELOPMENT PERMIT	07/25/202
ISSUED FOR DEVELOPMENT PERMIT	04/22/202
REVISION	M/D/Y

APPLICANT: GREG GILLESPIE 250-858 6940

> 1701 & 1705 RICHARDSON VICTORIA, BC

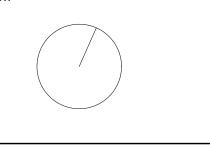PROJECT ADDRESS:

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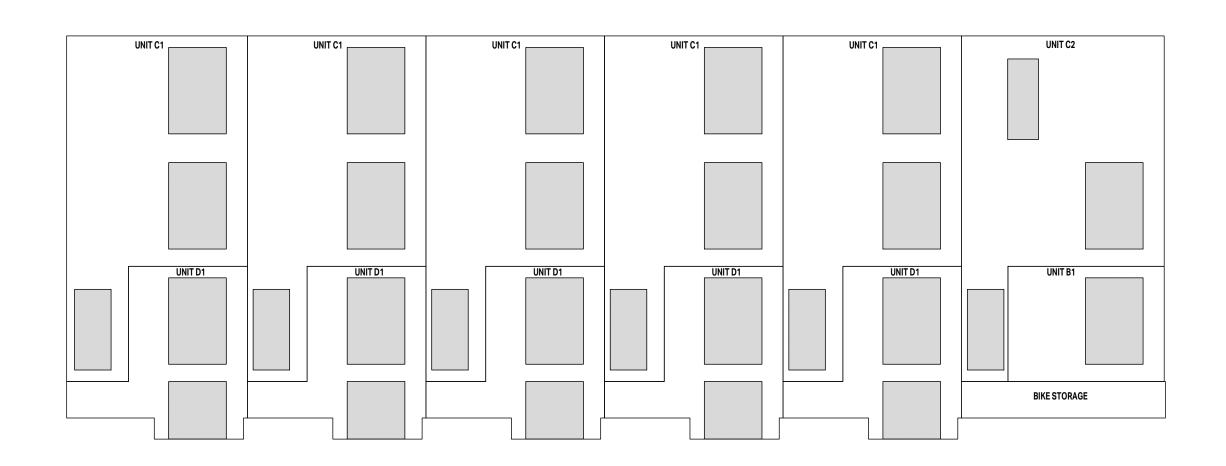


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AREA & AVERAGE
GRADE CALCULATIONS

 PROJECT NO:
 2407
 DRAWN BY:
 KG

 SCALE:
 1:200
 REVIEW BY:
 CH



NORTH ELEVATION - UNIT B1 SPATIAL SEPARATION CALCULATION BCBC 2018 PART 3 TABLE 3.2.3.1.-D AREA OF EXPOSED BUILDING FACE: 12.60m² (135.63sq.ft) LIMITING DISTANCE: 12.88m (42.26ft) ALLOWABLE OPENINGS: 100% [12.60m² (135.63sq.ft)] PROPOSED OPENINGS: 27.6% [3.48m² (37.5sq.ft)]

NORTH ELEVATION - UNIT C1 SPATIAL SEPARATION CALCULATION BCBC 2018 PART 3 TABLE 3.2.3.1.-D AREA OF EXPOSED BUILDING FACE: 33.62m² (361.88sq.ft) LIMITING DISTANCE: 12.88m (42.26ft) ALLOWABLE OPENINGS: 100% [33.62m² (361.88sq.ft)] PROPOSED OPENINGS: 26.9% [9.03m² (97.17sq.ft)]

FIRE RESISTANCE RATING PER 3.2.3.7.

CLADDING PER 3.2.3.7.


CONSTRUCTION PER 3.2.3.7.

NORTH ELEVATION - UNIT C2 SPATIAL SEPARATION CALCULATION BCBC 2018 PART 3 TABLE 3.2.3.1.-D LIMITING DISTANCE: ALLOWABLE OPENINGS:

AREA OF EXPOSED BUILDING FACE: 36.41m² (391.88sq.ft) 12.88m (42.26ft) 100% [36.41m² (391.88sq.ft)] PROPOSED OPENINGS: 20.0% [7.28m² (78.33sq.ft)] FIRE RESISTANCE RATING PER 3.2.3.7. CLADDING PER 3.2.3.7. CONSTRUCTION PER 3.2.3.7.

BCBC 2018 PART 3 TABLE 3.2.3.1.-D LIMITING DISTANCE: ALLOWABLE OPENINGS: PROPOSED OPENINGS: FIRE RESISTANCE RATING PER 3.2.3.7. CLADDING PER 3.2.3.7. CONSTRUCTION PER 3.2.3.7.


NORTH ELEVATION - UNIT D1 SPATIAL SEPARATION CALCULATION AREA OF EXPOSED BUILDING FACE: 15.46m² (166.42sq.ft) 12.88m (42.26ft) 100% [15.46m² (166.42sq.ft)] 47.1% [7.28m² (78.33sq.ft)]

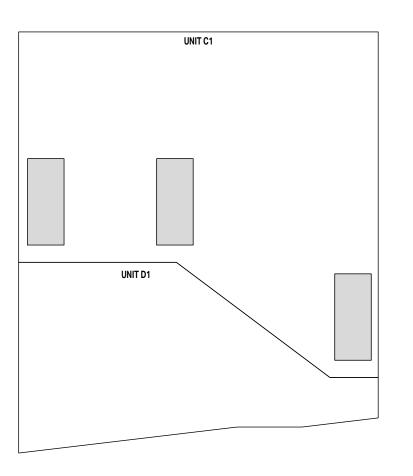

EAST ELEVATION - UNIT C1 SPATIAL SEPARATION CALCULATION BCBC 2018 PART 3 TABLE 3.2.3.1.-D

EAST ELEVATION

AREA OF EXPOSED BUILDING FACE: 68.07m² (732.74sq.ft) LIMITING DISTANCE: 98.0% [66.7m² (717.8sq.ft)] ALLOWABLE OPENINGS: PROPOSED OPENINGS: 9.7% [6.62m² (71.25sq.ft)] FIRE RESISTANCE RATING PER 3.2.3.7. CLADDING PER 3.2.3.7. CONSTRUCTION PER 3.2.3.7.

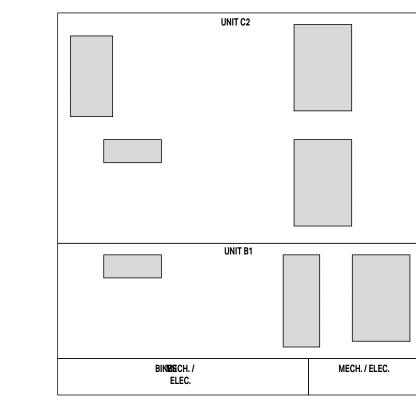

WEST ELEVATION - UNIT B1 SPATIAL SEPARATION CALCULATION BCBC 2018 PART 3 TABLE 3.2.3.1.-D

CONSTRUCTION PER 3.2.3.7.

AREA OF EXPOSED BUILDING FACE: 28.99m² (312.08sq.ft) LIMITING DISTANCE: 11.97m (39.27ft) 100% [28.99m² (312.08sq.ft)] ALLOWABLE OPENINGS: PROPOSED OPENINGS: 23.3% [6.77m² (72.83sq.ft)] FIRE RESISTANCE RATING PER 3.2.3.7. CLADDING PER 3.2.3.7.

WEST ELEVATION - UNIT C2 SPATIAL SEPARATION CALCULATION BCBC 2018 PART 3 TABLE 3.2.3.1.-D AREA OF EXPOSED BUILDING FACE: 57.99m² (62 LIMITING DISTANCE: 100% [57.99m² (62 ALLOWABLE OPENINGS: PROPOSED OPENINGS: 17.7% [10.28m² (11

FIRE RESISTANCE RATING PER 3.2.3.7. CLADDING PER 3.2.3.7. CONSTRUCTION PER 3.2.3.7.


WEST ELEVATION




FIRE RESISTANCE RATING PER 3.2.3.7.

CLADDING PER 3.2.3.7.

CONSTRUCTION PER 3.2.3.7.

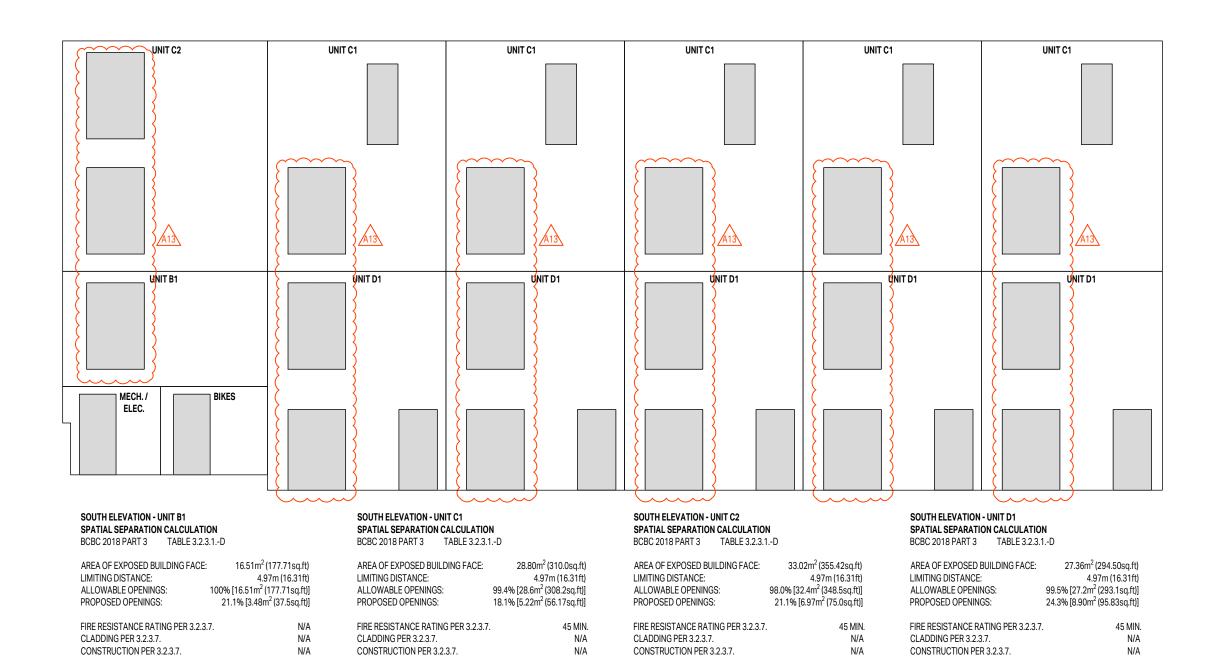




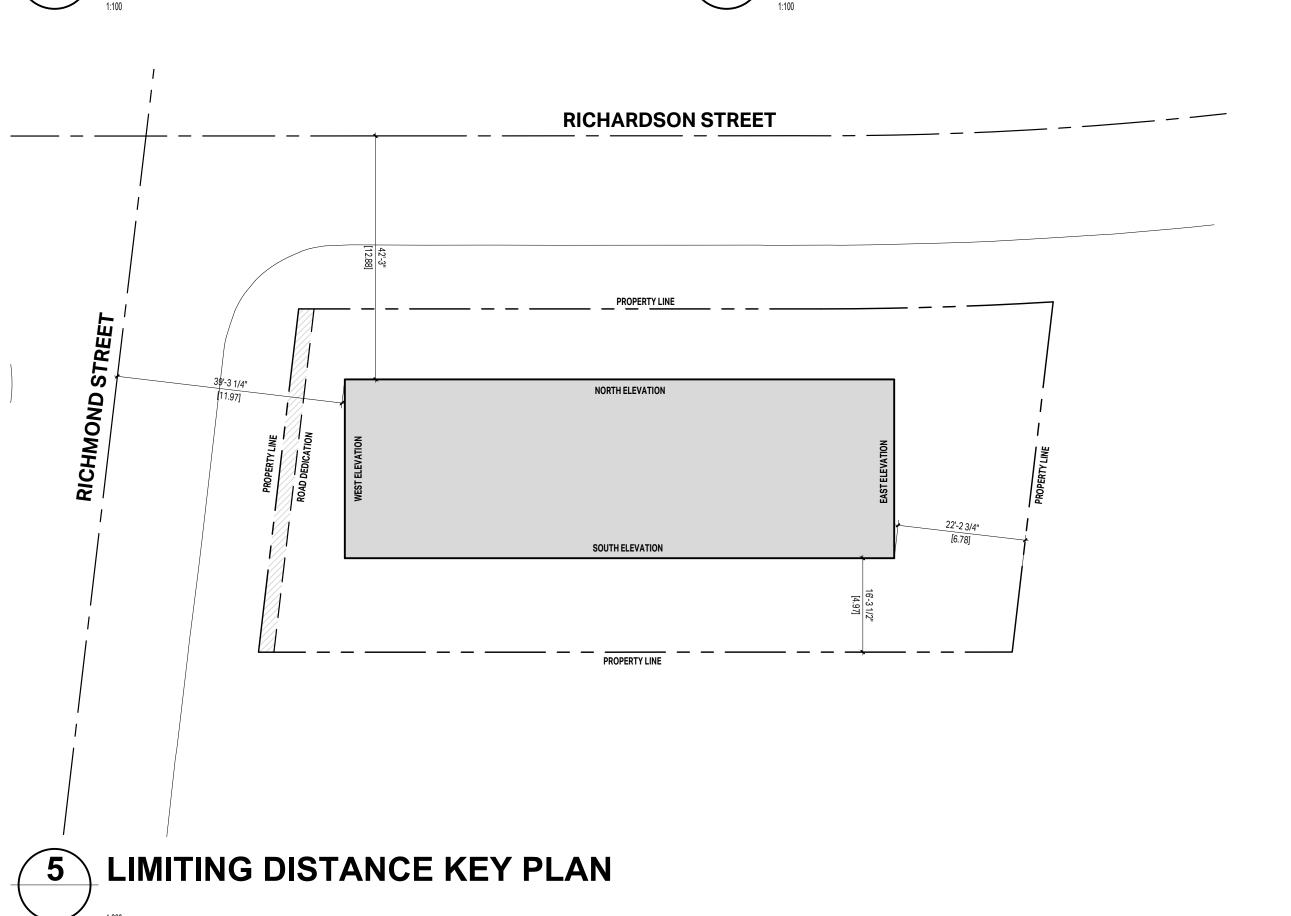

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APPLICANT: GREG GILLESPIE 250-858 6940

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PROJECT ADDRESS:


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SPATIAL SEPARATION

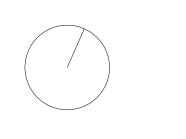PROJECT NO: 2407 DRAWN BY: KG SCALE: AS NOTED REVIEW BY: CH





1 - SAINT MATTHIAS ANGLICAN CHURCH

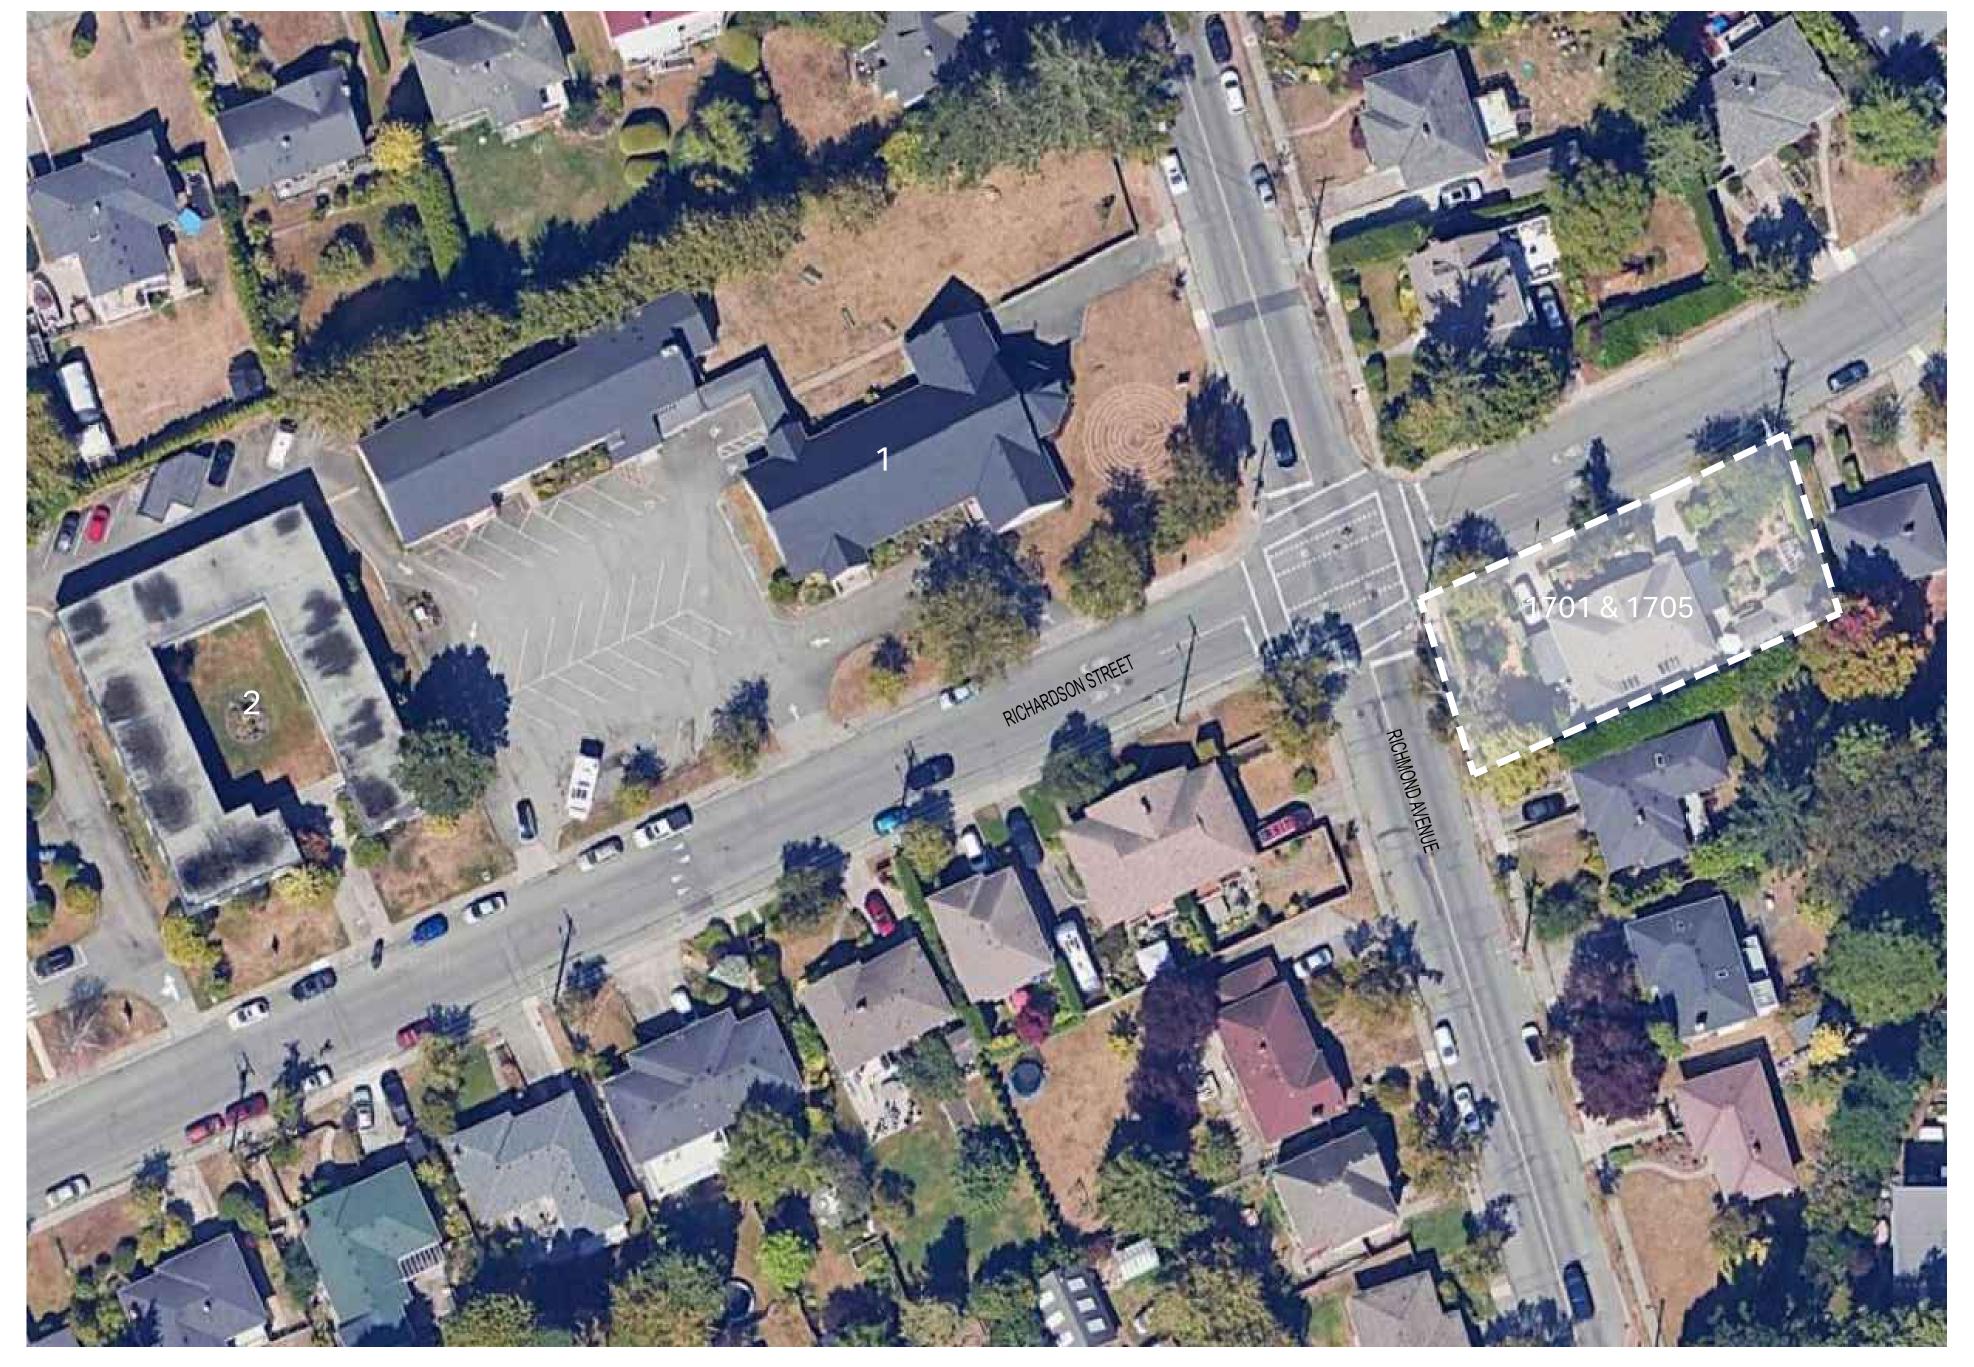

2 - CANNON ROGERS COURT





STREETSCAPE


CONTEXT PLAN

REVIEW BY: CH AS NOTED

DRAWING NO: A005

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VICTORIA, BC


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PROJECT NAME
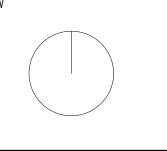
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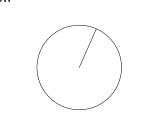


CONTEXT PLAN & STREETSCAPE



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APPLICANT: GREG GILLESPIE 250-858 6940
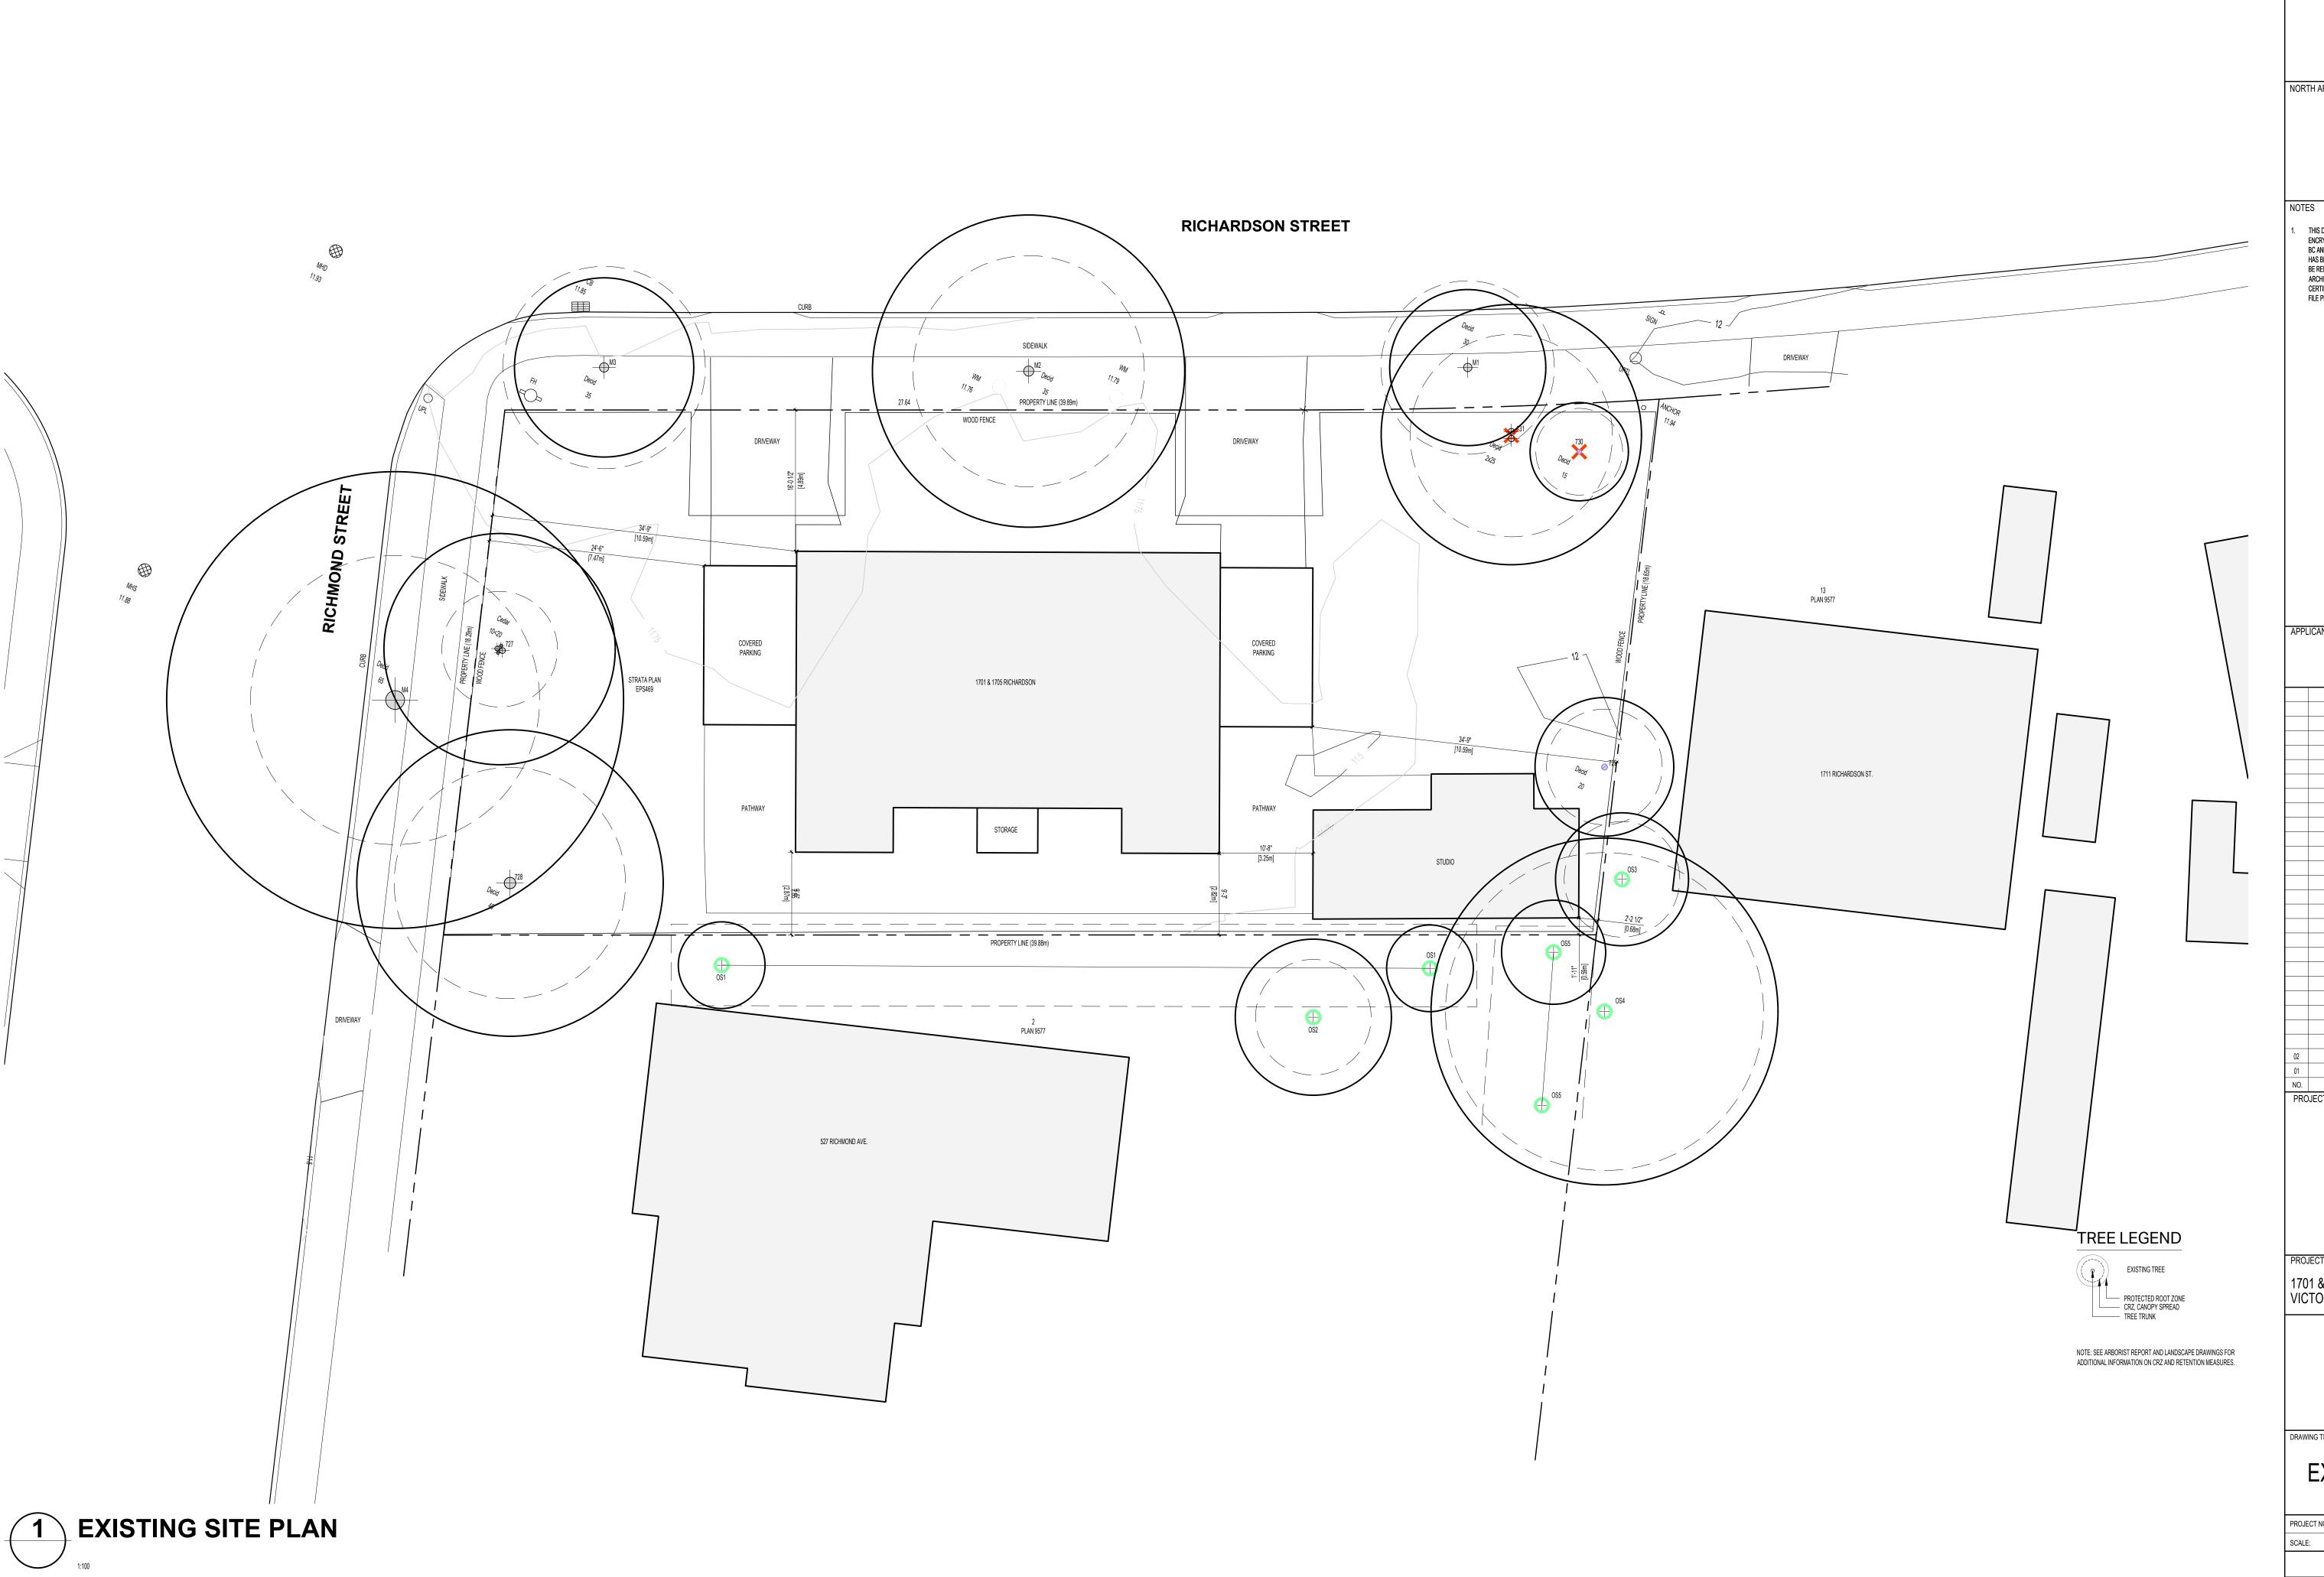
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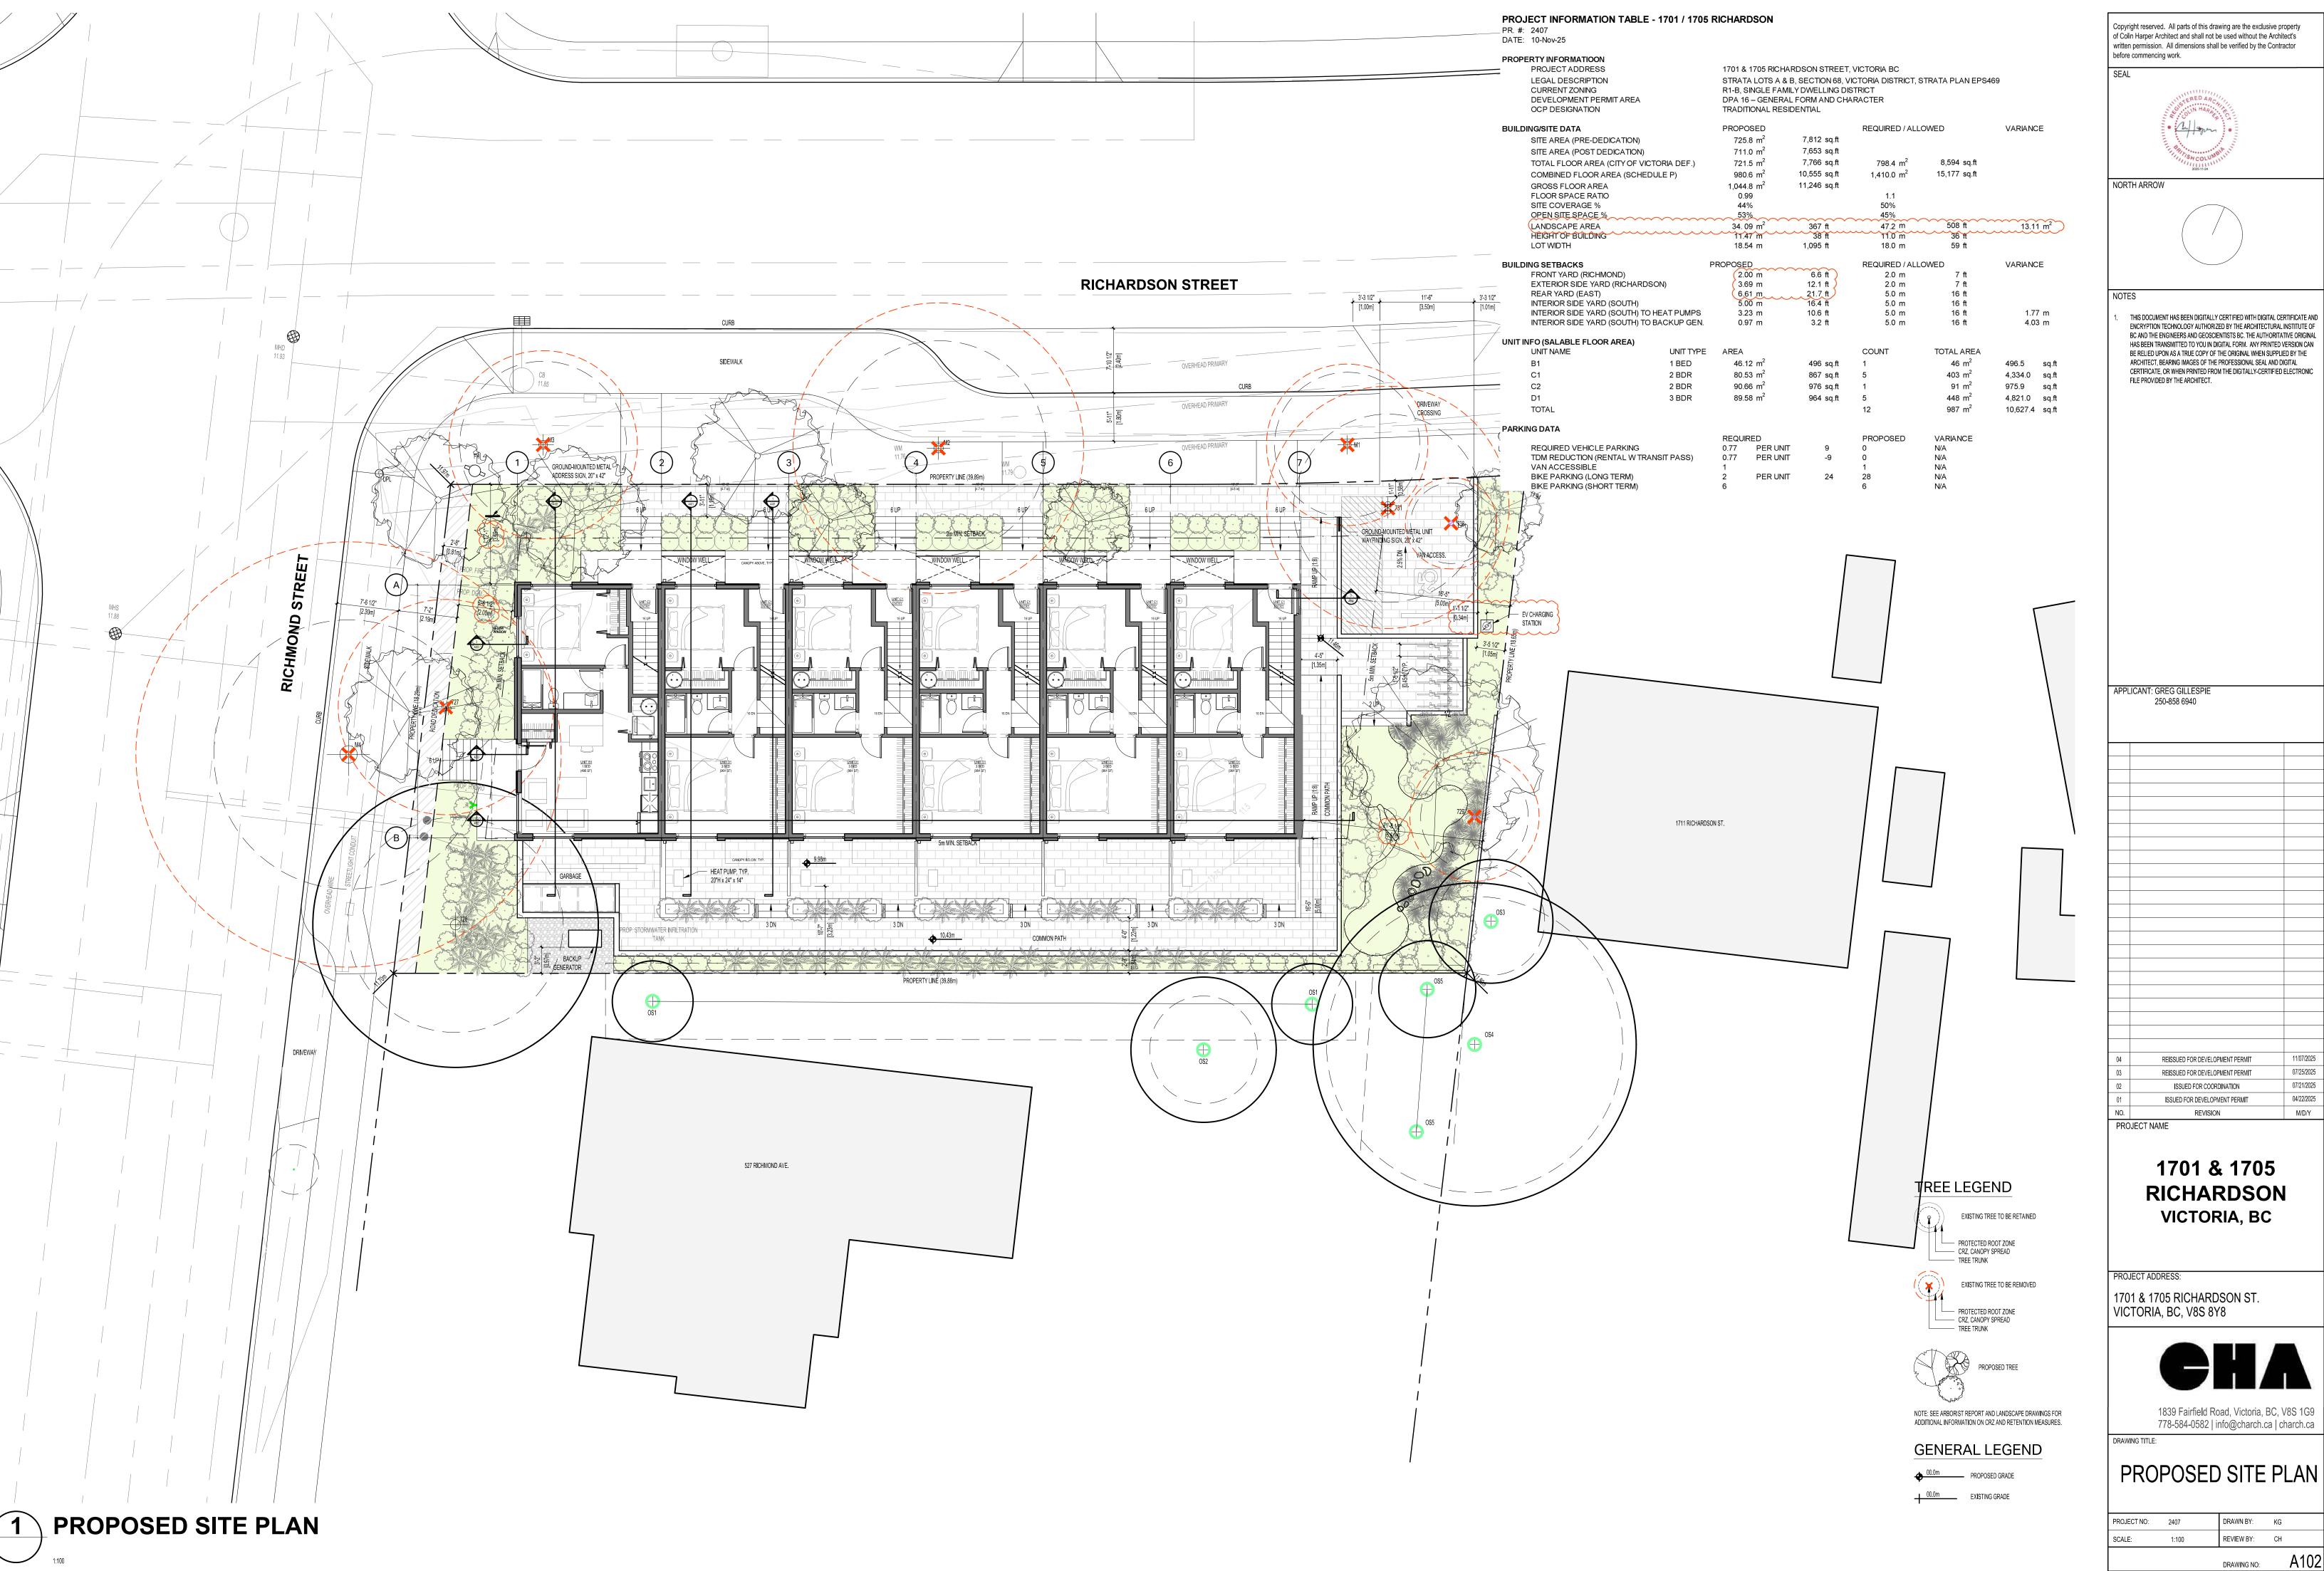
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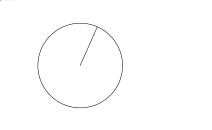
EXISTING SITE PLAN

DRAWN BY: KG REVIEW BY: CH SCALE: 1:100



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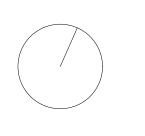




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APPLICANT: GREG GILLESPIE

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LEVEL 1 PLAN

DRAWN BY: KG REVIEW BY: CH 1:50




1 LEVEL 2 PLAN


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APPLICANT: GREG GILLESPIE 250-858 6940

02 REISSUED FOR DEVELOPMENT PERMIT 07/25/2025
01 ISSUED FOR DEVELOPMENT PERMIT 04/22/2025
NO. REVISION M/D/Y
PROJECT NAME

1701 & 1705 RICHARDSON VICTORIA, BC

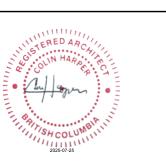PROJECT ADDRESS:

1701 & 1705 RICHARDSON ST. VICTORIA, BC, V8S 8Y8

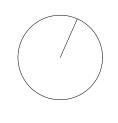


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G TITLE:

LEVEL 2 PLAN

 PROJECT NO:
 2407
 DRAWN BY:
 KG


 SCALE:
 1:50
 REVIEW BY:
 CH



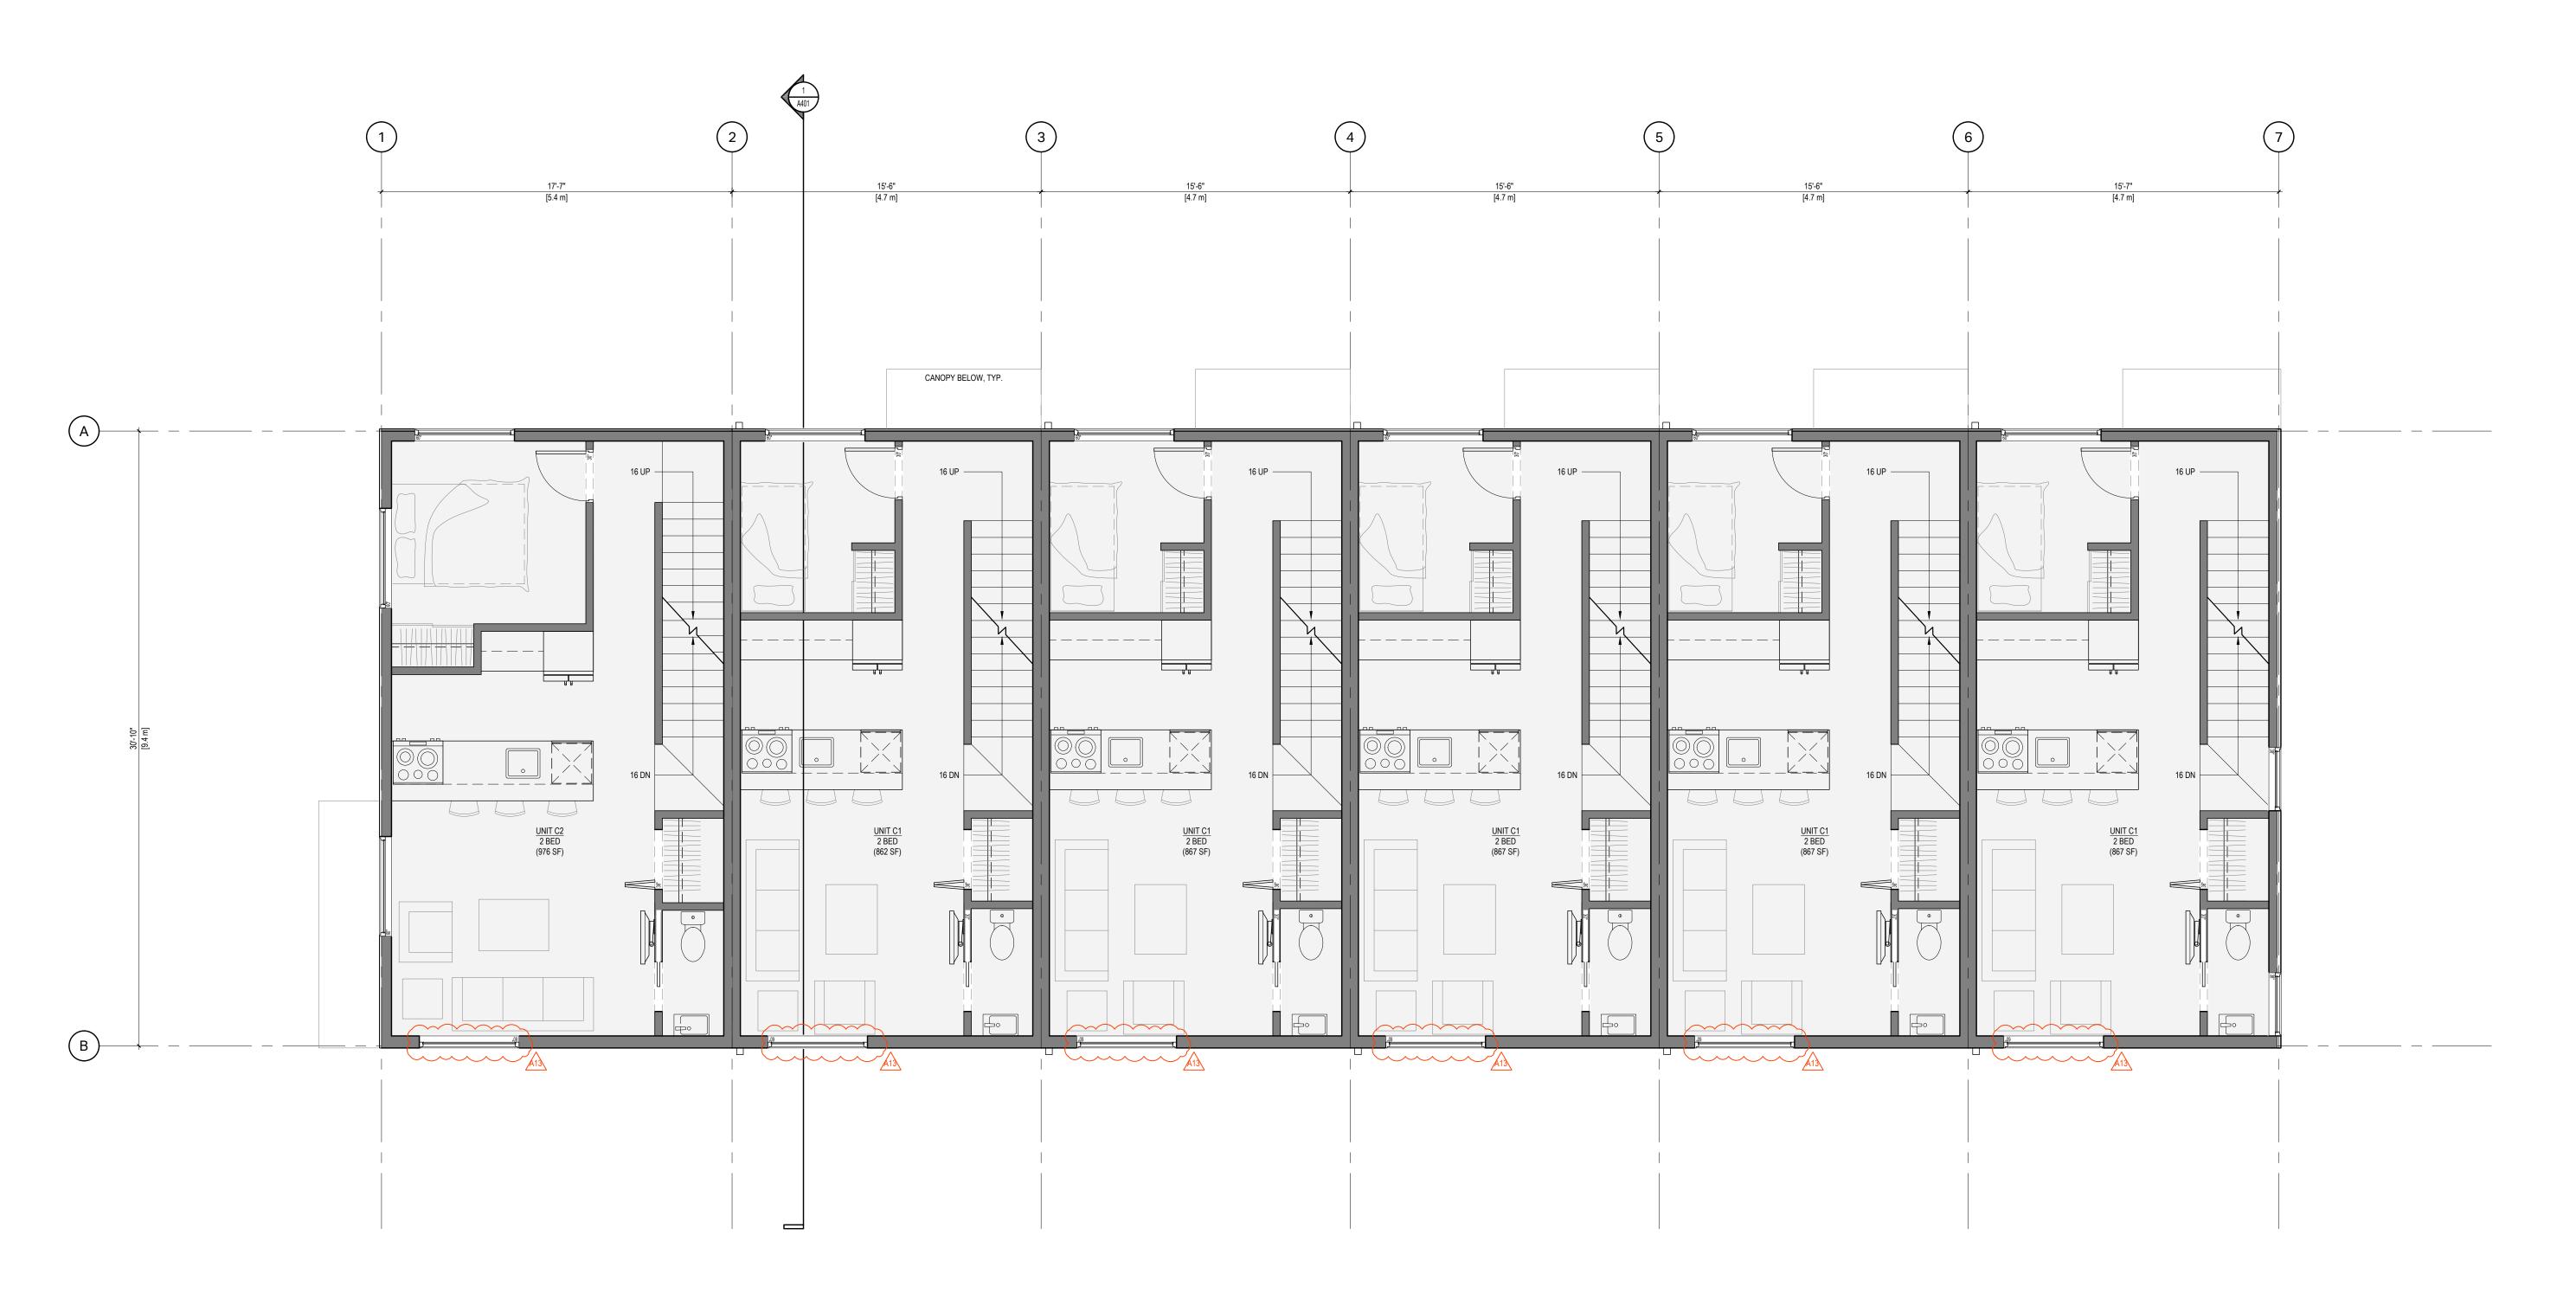


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1701 & 1705 RICHARDSON

VICTORIA, BC

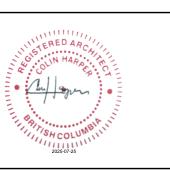PROJECT ADDRESS:

1701 & 1705 RICHARDS

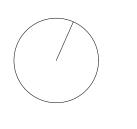PROJECT NAME

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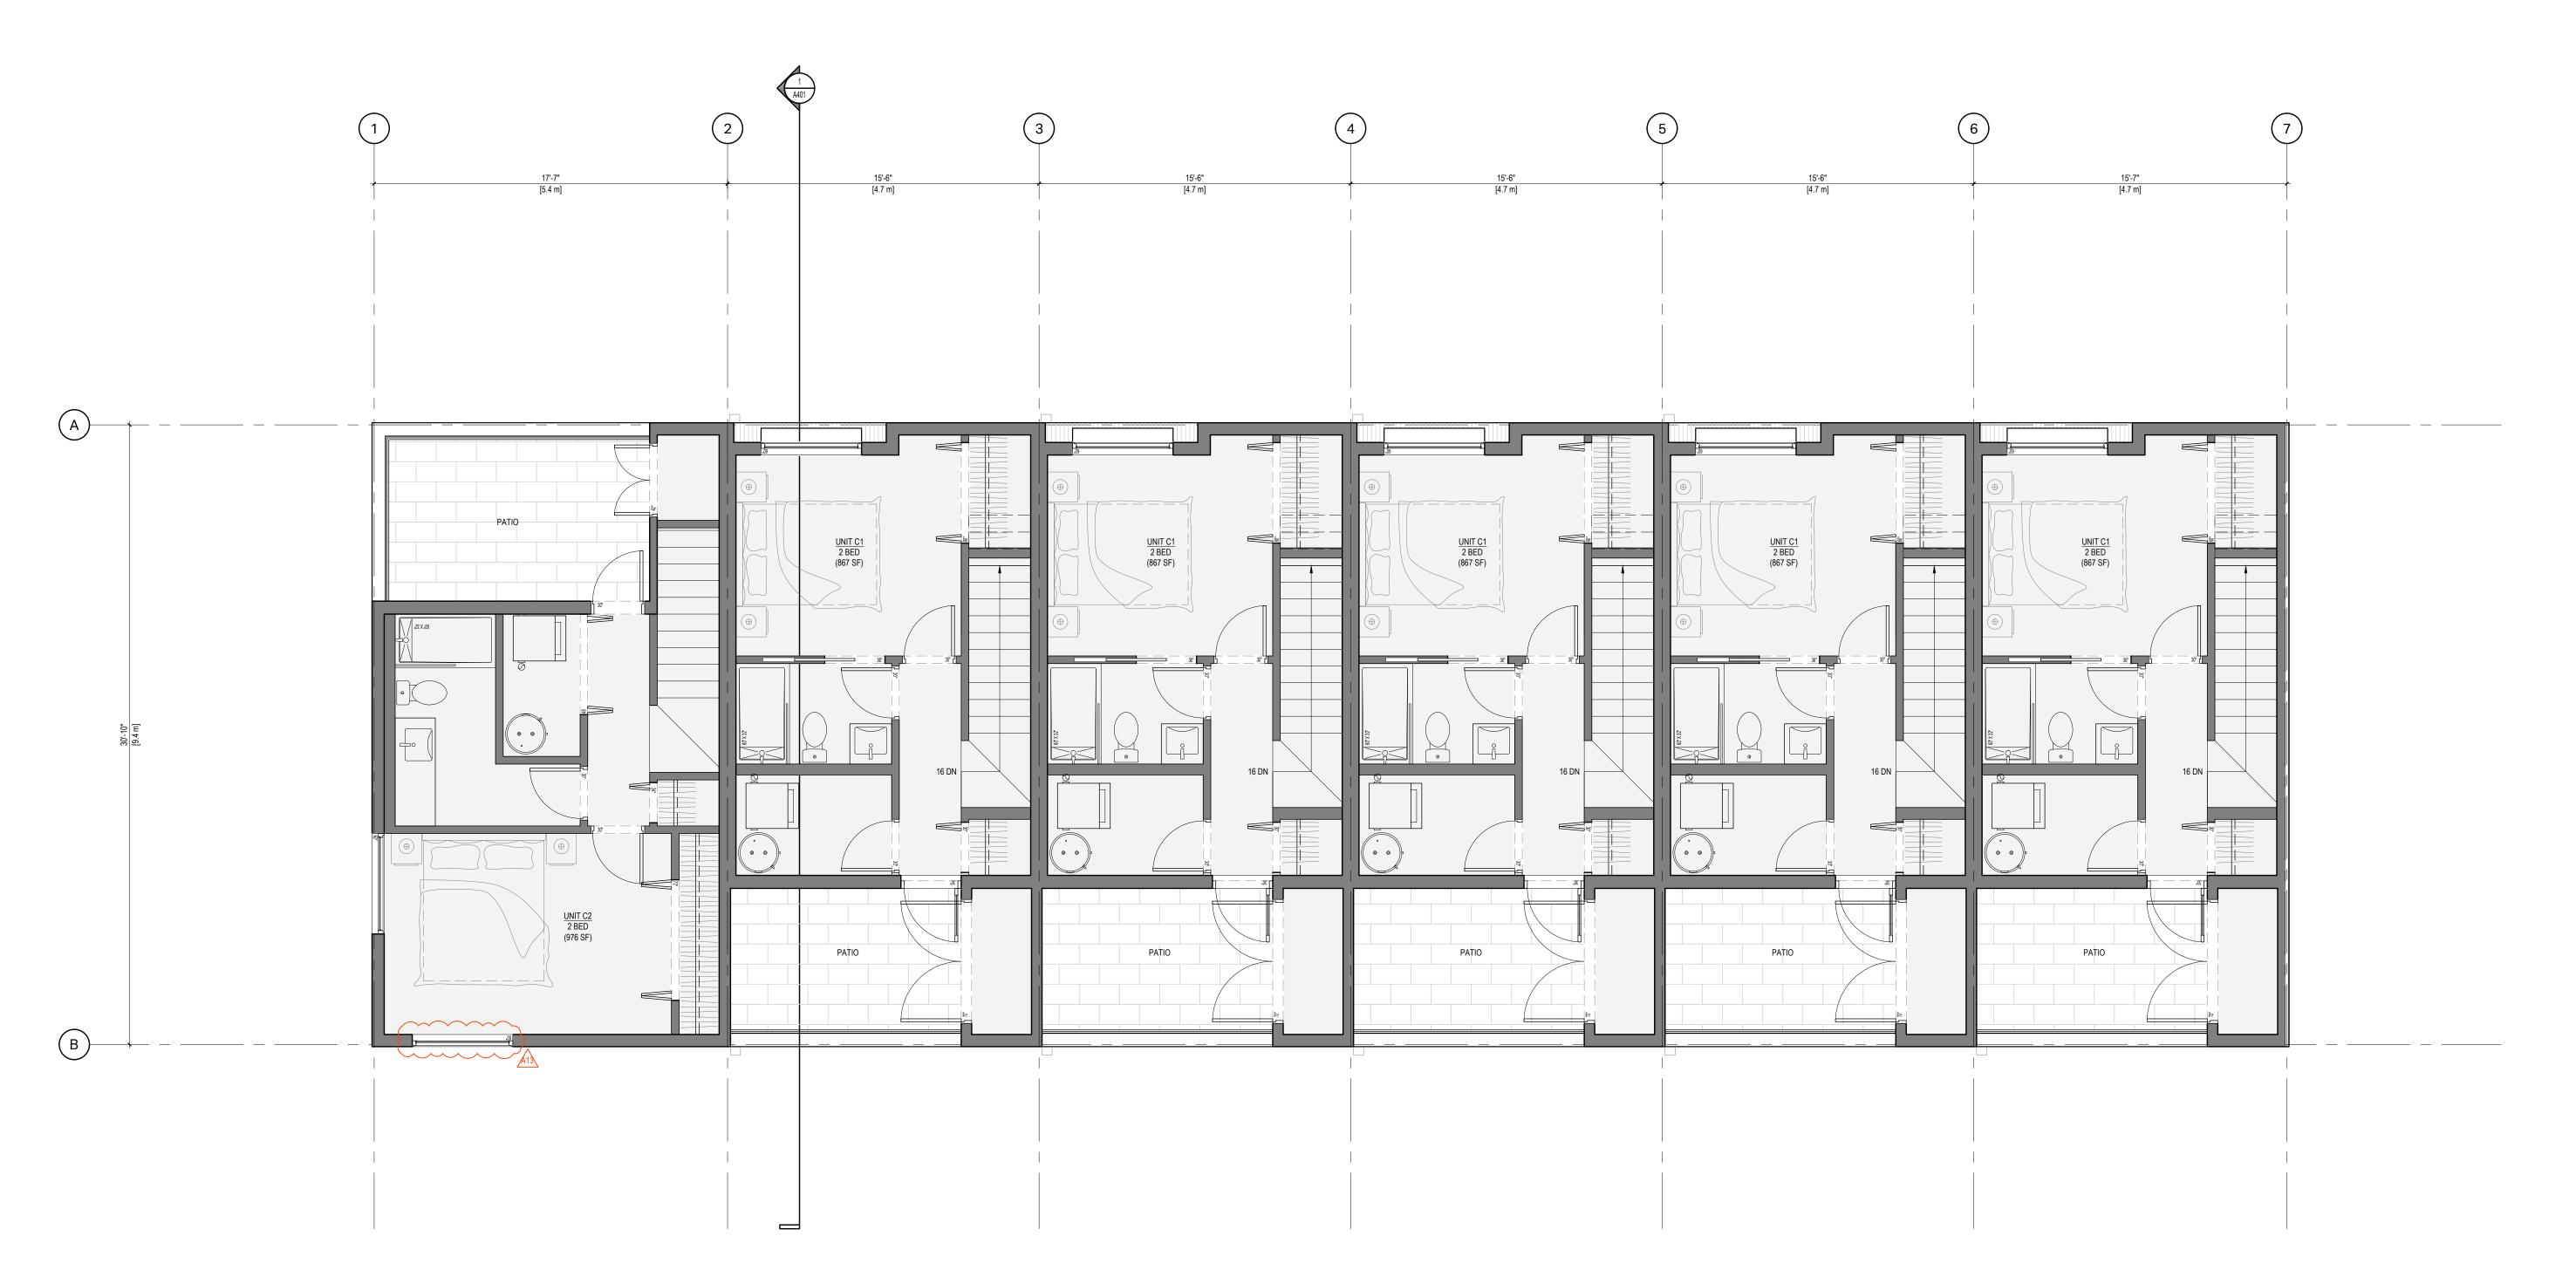
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NG TITLE:

LEVEL 3 PLAN

 PROJECT NO:
 2407
 DRAWN BY:
 KG

 SCALE:
 1:50
 REVIEW BY:
 CH




1 LEVEL 4 PLAN


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01	ISSUED FOR DEVELOPMENT PERMIT	04/22/20
NO.	REVISION	M/D/Y
PRO	JECT NAME	

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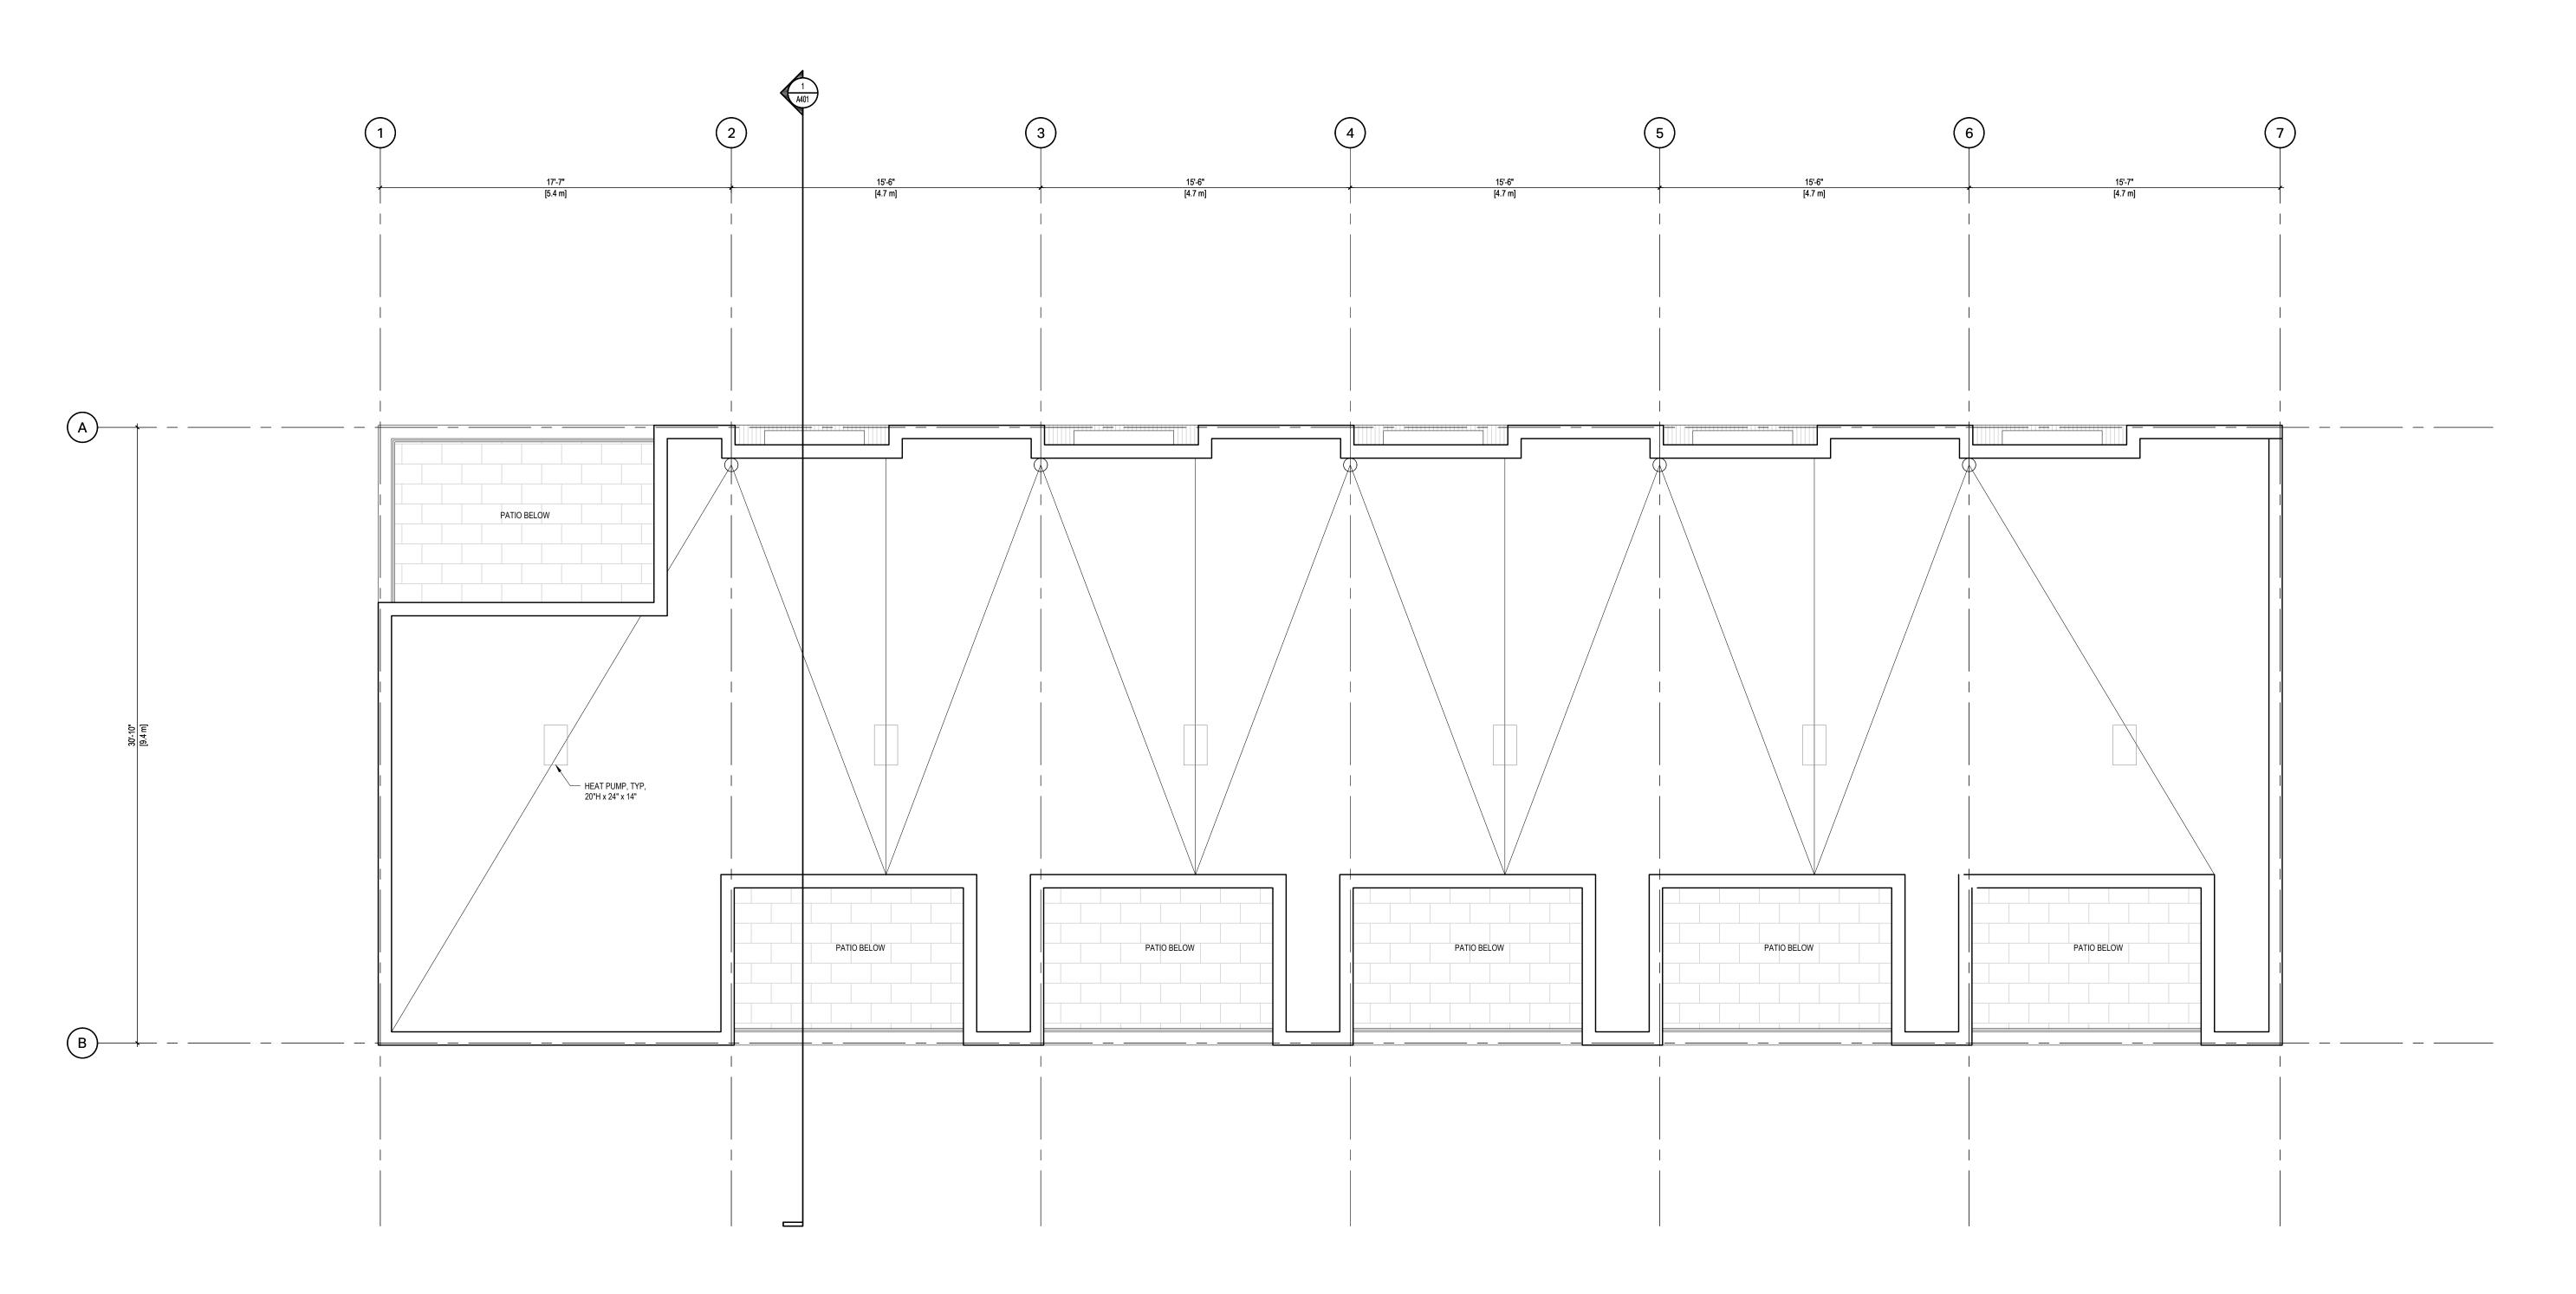


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LEVEL 4 PLAN

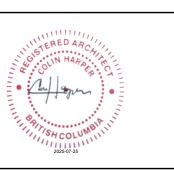PROJECT NO: 2407 DRAWN BY: KG

SCALE: 1:50 REVIEW BY: CH

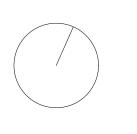


1 ROOF PLAN
1:50

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APPLICANT: GREG GILLESPIE 250-858 6940

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01	ISSUED FOR DEVELOPMENT PERMIT	04/2
NO.	REVISION	M/

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ROOF PLAN

VOOI I LAIN

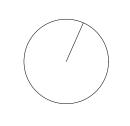 PROJECT NO:
 2407
 DRAWN BY:
 KG

 SCALE:
 1:50
 REVIEW BY:
 CH



NORTH ELEVATION



SOUTH ELEVATION

COLOUR / FINISH THIN STONE STANDING SEAM METAL ROOFING VERTICAL WOOD SIDING

15. VERTICAL METAL LOUVERS

GROUND-MOUNTED WAYFINDING SIGN

STEEL PLATE CANOPY

17. GLASS GUARDRAIL

WARM GREY / FACTORY FINISH CLEAR SEAL METAL PANEL LIGHT GREY / FACTORY FINISH ARCHITECTURAL CONCRETE CLEAR SEAL BRAKE METAL FLASHING VINYL WINDOW / DOOR METAL DOWNSPOUT AND GUTTER
 OPAQUE GLASS PRIVACY SCREEN SCONCE LIGHTING METAL ADDRESSING 12. SOLID WOOD DOOR STEEL UTILITY DOOR

LIGHT GREY / FACTORY FINISH
LIGHT GREY / FACTORY FINISH LIGHT GREY / PRE-PAINTED LIGHT GREY / PRE-PAINTED 14. CUSTOM METAL PICKET GUARDRAIL LIGHT GREY / PRE-PAINTED LIGHT GREY / PRE-PAINTED LIGHT GREY / POWDER COATED

20"x42" METAL UNIT

LIGHT GREY / FACTORY FINISH

NORTH ARROW

before commencing work.

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ALL BEDROOMS TO INCLUDE AT LEAST ONE OPERABLE WINDOW TO THE OUTSIDE, PROVIDING OCCUPANT CONTROLLED ACCESS TO DAYLIGHT AND AIR.

APPLICANT: GREG GILLESPIE

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PROJECT NAME

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PROJECT ADDRESS:


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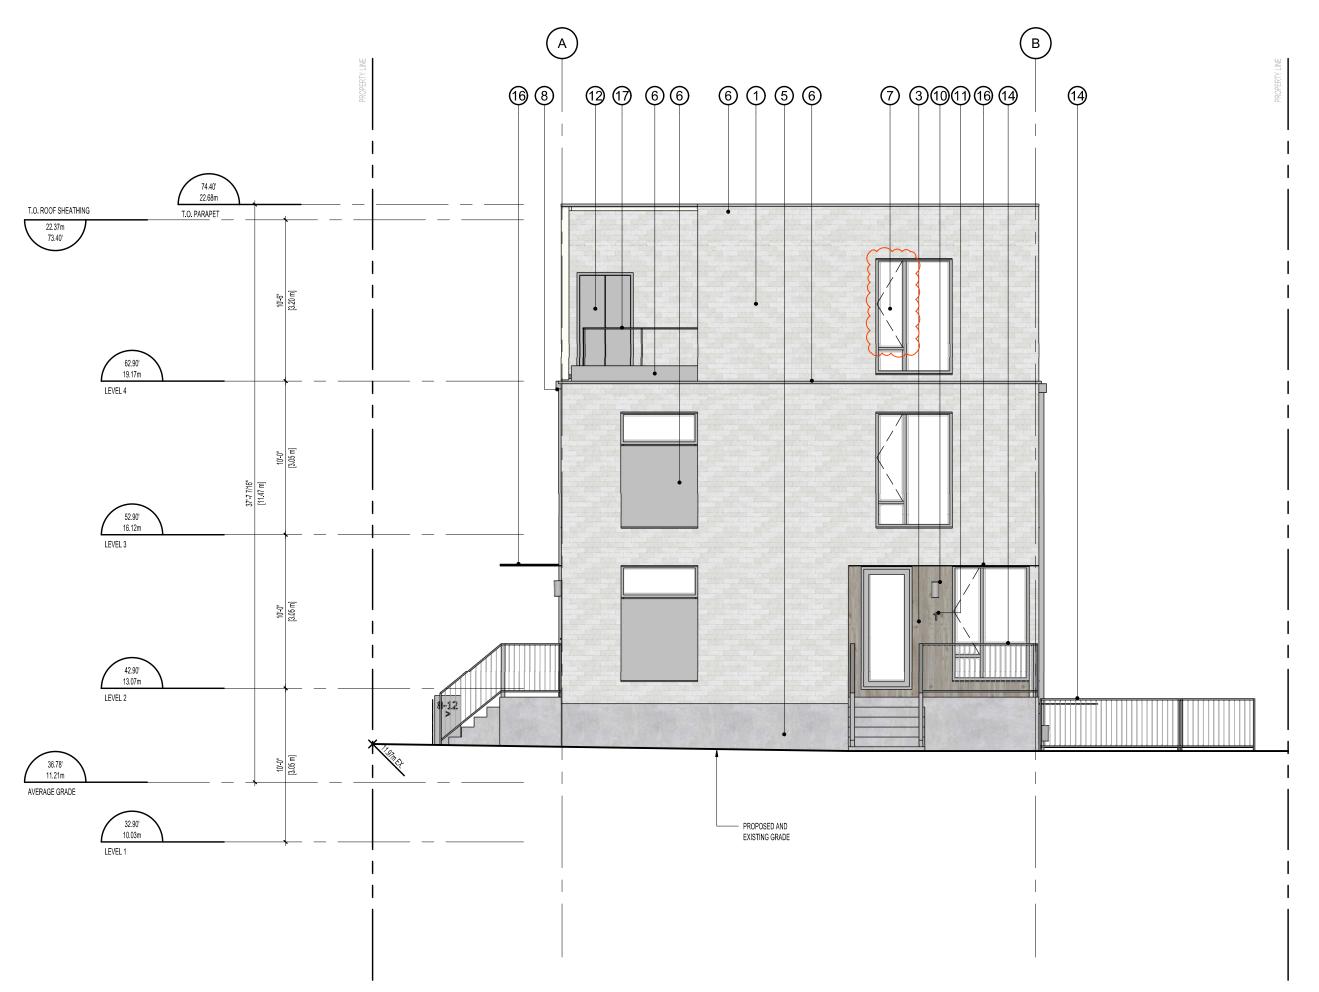
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ELEVATIONS

REVIEW BY: CH



1 EAST ELEVATION

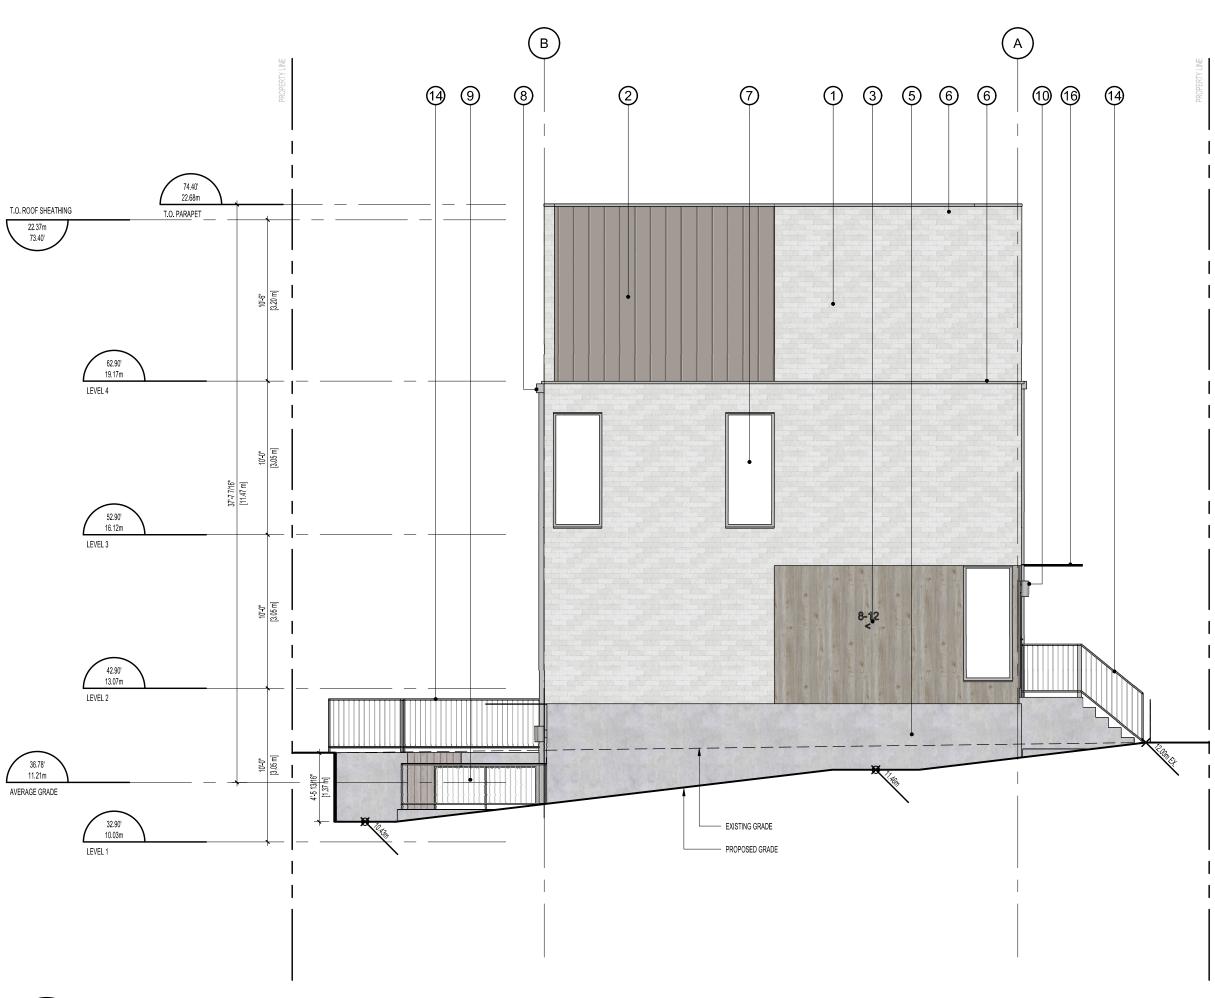

2 WEST ELEVATION

COLOUR / FINISH THIN STONE STANDING SEAM METAL ROOFING WARM GREY / FACTORY FINISH VERTICAL WOOD SIDING CLEAR SEAL METAL PANEL LIGHT GREY / FACTORY FINISH 5. ARCHITECTURAL CONCRETE CLEAR SEAL 6. BRAKE METAL FLASHING LIGHT GREY / FACTORY FINISH VINYL WINDOW / DOOR LIGHT GREY / FACTORY FINISH METAL DOWNSPOUT AND GUTTER
 OPAQUE GLASS PRIVACY SCREEN LIGHT GREY / FACTORY FINISH 10. SCONCE LIGHTING METAL ADDRESSING 12. SOLID WOOD DOOR13. STEEL UTILITY DOOR LIGHT GREY / PRE-PAINTED LIGHT GREY / PRE-PAINTED 14. CUSTOM METAL PICKET GUARDRAIL LIGHT GREY / PRE-PAINTED VERTICAL METAL LOUVERS LIGHT GREY / PRE-PAINTED STEEL PLATE CANOPY LIGHT GREY / POWDER COATED 17. GLASS GUARDRAIL

20"x42" METAL UNIT

18. GROUND-MOUNTED WAYFINDING SIGN

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IOTES

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ALL BEDROOMS TO INCLUDE AT LEAST ONE OPERABLE WINDOW TO THE OUTSIDE, PROVIDING OCCUPANT CONTROLLED ACCESS TO DAYLIGHT AND AIR. SEE ELEVATIONS.

APPLICANT: GREG GILLESPIE

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PROJECT NAME

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REVISION

PROJECT ADDRESS:

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// 10-304-0302 | 1

ELEVATIONS

 PROJECT NO:
 2407
 DRAWN BY:
 KG

 SCALE:
 1:75
 REVIEW BY:
 CH



MATERIAL KEY



COLOUR / FINISH 1. THIN STONE WARM GREY / FACTORY FINISH STANDING SEAM METAL ROOFING VERTICAL WOOD SIDING METAL PANEL LIGHT GREY / FACTORY FINISH ARCHITECTURAL CONCRETE BRAKE METAL FLASHING LIGHT GREY / FACTORY FINISH VINYL WINDOW / DOOR LIGHT GREY / FACTORY FINISH METAL DOWNSPOUT AND GUTTER LIGHT GREY / FACTORY FINISH OPAQUE GLASS PRIVACY SCREEN LIGHT GREY / FACTORY FINISH SCONCE LIGHTING LIGHT GREY / FACTORY FINISH 11. METAL ADDRESSING 12. SOLID WOOD DOOR LIGHT GREY / FACTORY FINISH LIGHT GREY / PRE-PAINTED 13. STEEL UTILITY DOOR LIGHT GREY / PRE-PAINTED 14. CUSTOM METAL PICKET GUARDRAIL LIGHT GREY / PRE-PAINTED

LIGHT GREY / PRE-PAINTED

LIGHT GREY / POWDER COATED CLEAR / N/A

VERTICAL METAL LOUVERS

16. STEEL PLATE CANOPY
17. GLASS GUARDRAIL

MATERIAL BOARD

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APPLICANT: GREG GILLESPIE

REISSUED FOR DEVELOPMENT PERMIT

PROJECT NAME

1701 & 1705 **RICHARDSON VICTORIA, BC**

ISSUED FOR DEVELOPMENT PERMIT REVISION

PROJECT ADDRESS:

1701 & 1705 RICHARDSON ST. VICTORIA, BC, V8S 8Y8




1839 Fairfield Road, Victoria, BC, V8S 1G9 778-584-0582 | info@charch.ca | charch.ca

MATERIAL BOARD

PROJECT NO: 2407 DRAWN BY: KG REVIEW BY: CH


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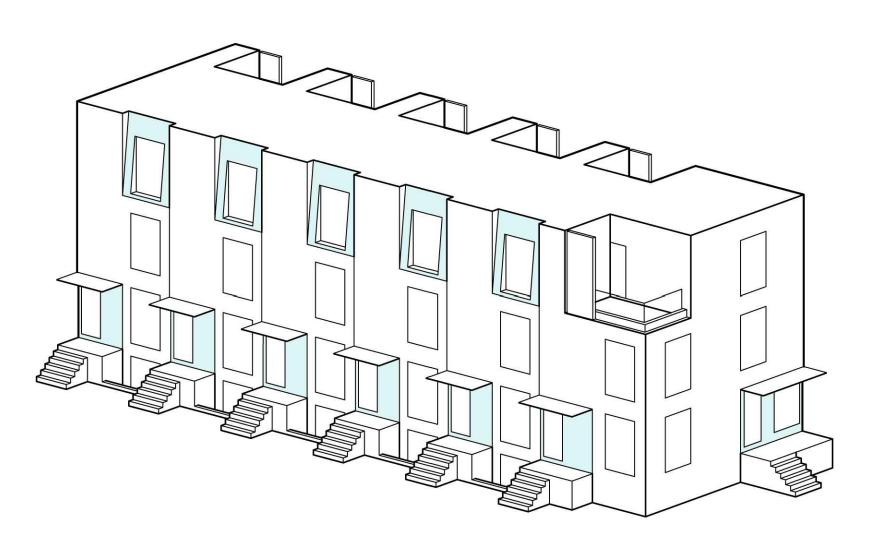
04/22/2025

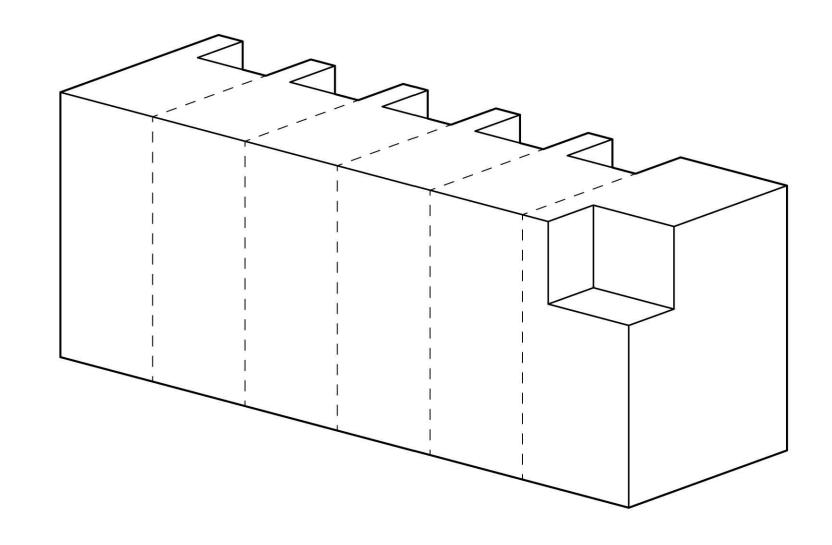

1. BUILDING TO READ AS 6 UNITS





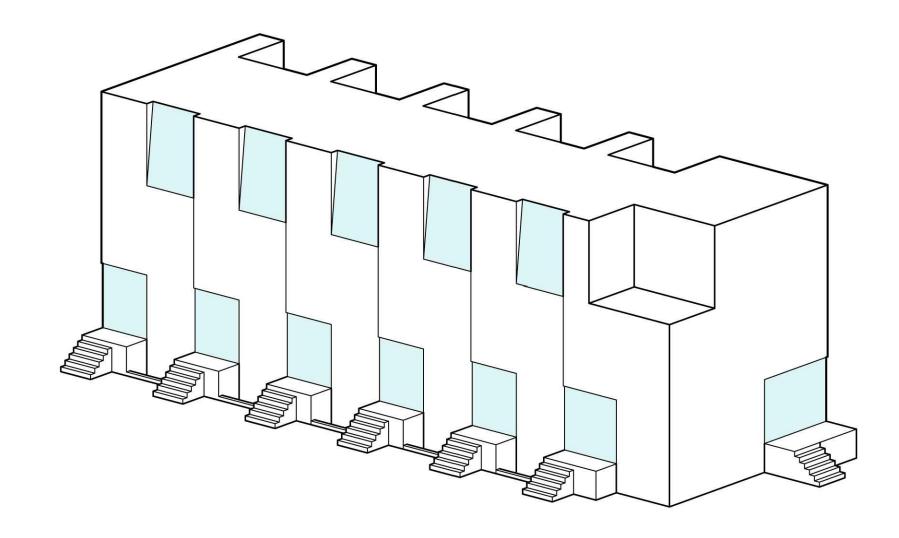

3. REPEAT 4. ARTICULATE



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APPLICANT: GREG GILLESPIE 250-858 6940

REISSUED FOR DEVELOPMENT PERMIT ISSUED FOR DEVELOPMENT PERMIT PROJECT NAME

> 1701 & 1705 **RICHARDSON VICTORIA, BC**

PROJECT ADDRESS:

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MASSING DIAGRAMS

DRAWN BY: KG REVIEW BY: CH DRAWING NO: A304



2 VIEW WEST FROM L1 WALKWAY



3 VIEW NORTHEAST FROM RICHMOND

VIEW SOUTH FROM RICHARDSON



4 VIEW SOUTHWEST FROM RICHARDSON

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SEAL



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NOTES

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PPLICANT: GREG GILLESPII 250-858 6940

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REVISION

REVISION

1701 & 1705 RICHARDSON VICTORIA, BC

PROJECT ADDRES

1701 & 1705 RICHARDSON ST. VICTORIA, BC, V8S 8Y8




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RENDERINGS

PROJECT NO: 2407 DRAWN BY: KG

SCALE: N/A REVIEW BY: CH

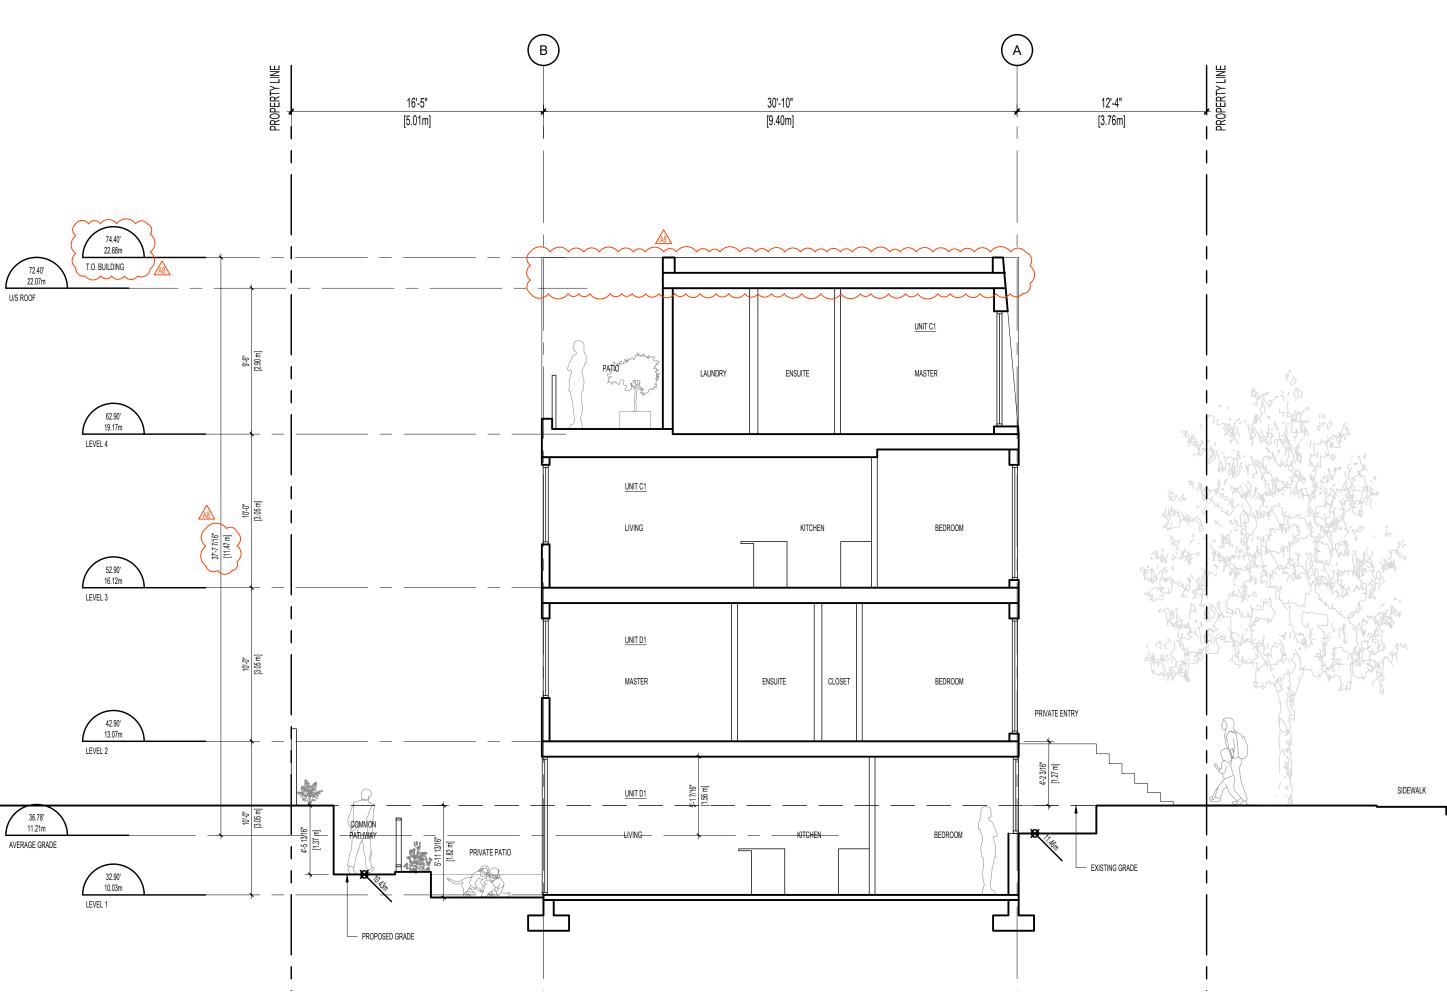

SECTION A

1/A201

1.75

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SE/



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PROJECT NAME

1701 & 1705 RICHARDSON VICTORIA, BC

04/22/2025

PROJECT ADDRESS:

1701 & 1705 RICHARDSON ST. VICTORIA, BC, V8S 8Y8




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1 / 0-304-030

SECTIONS

 PROJECT NO:
 2407
 DRAWN BY:
 KG

 SCALE:
 1:75
 REVIEW BY:
 CH

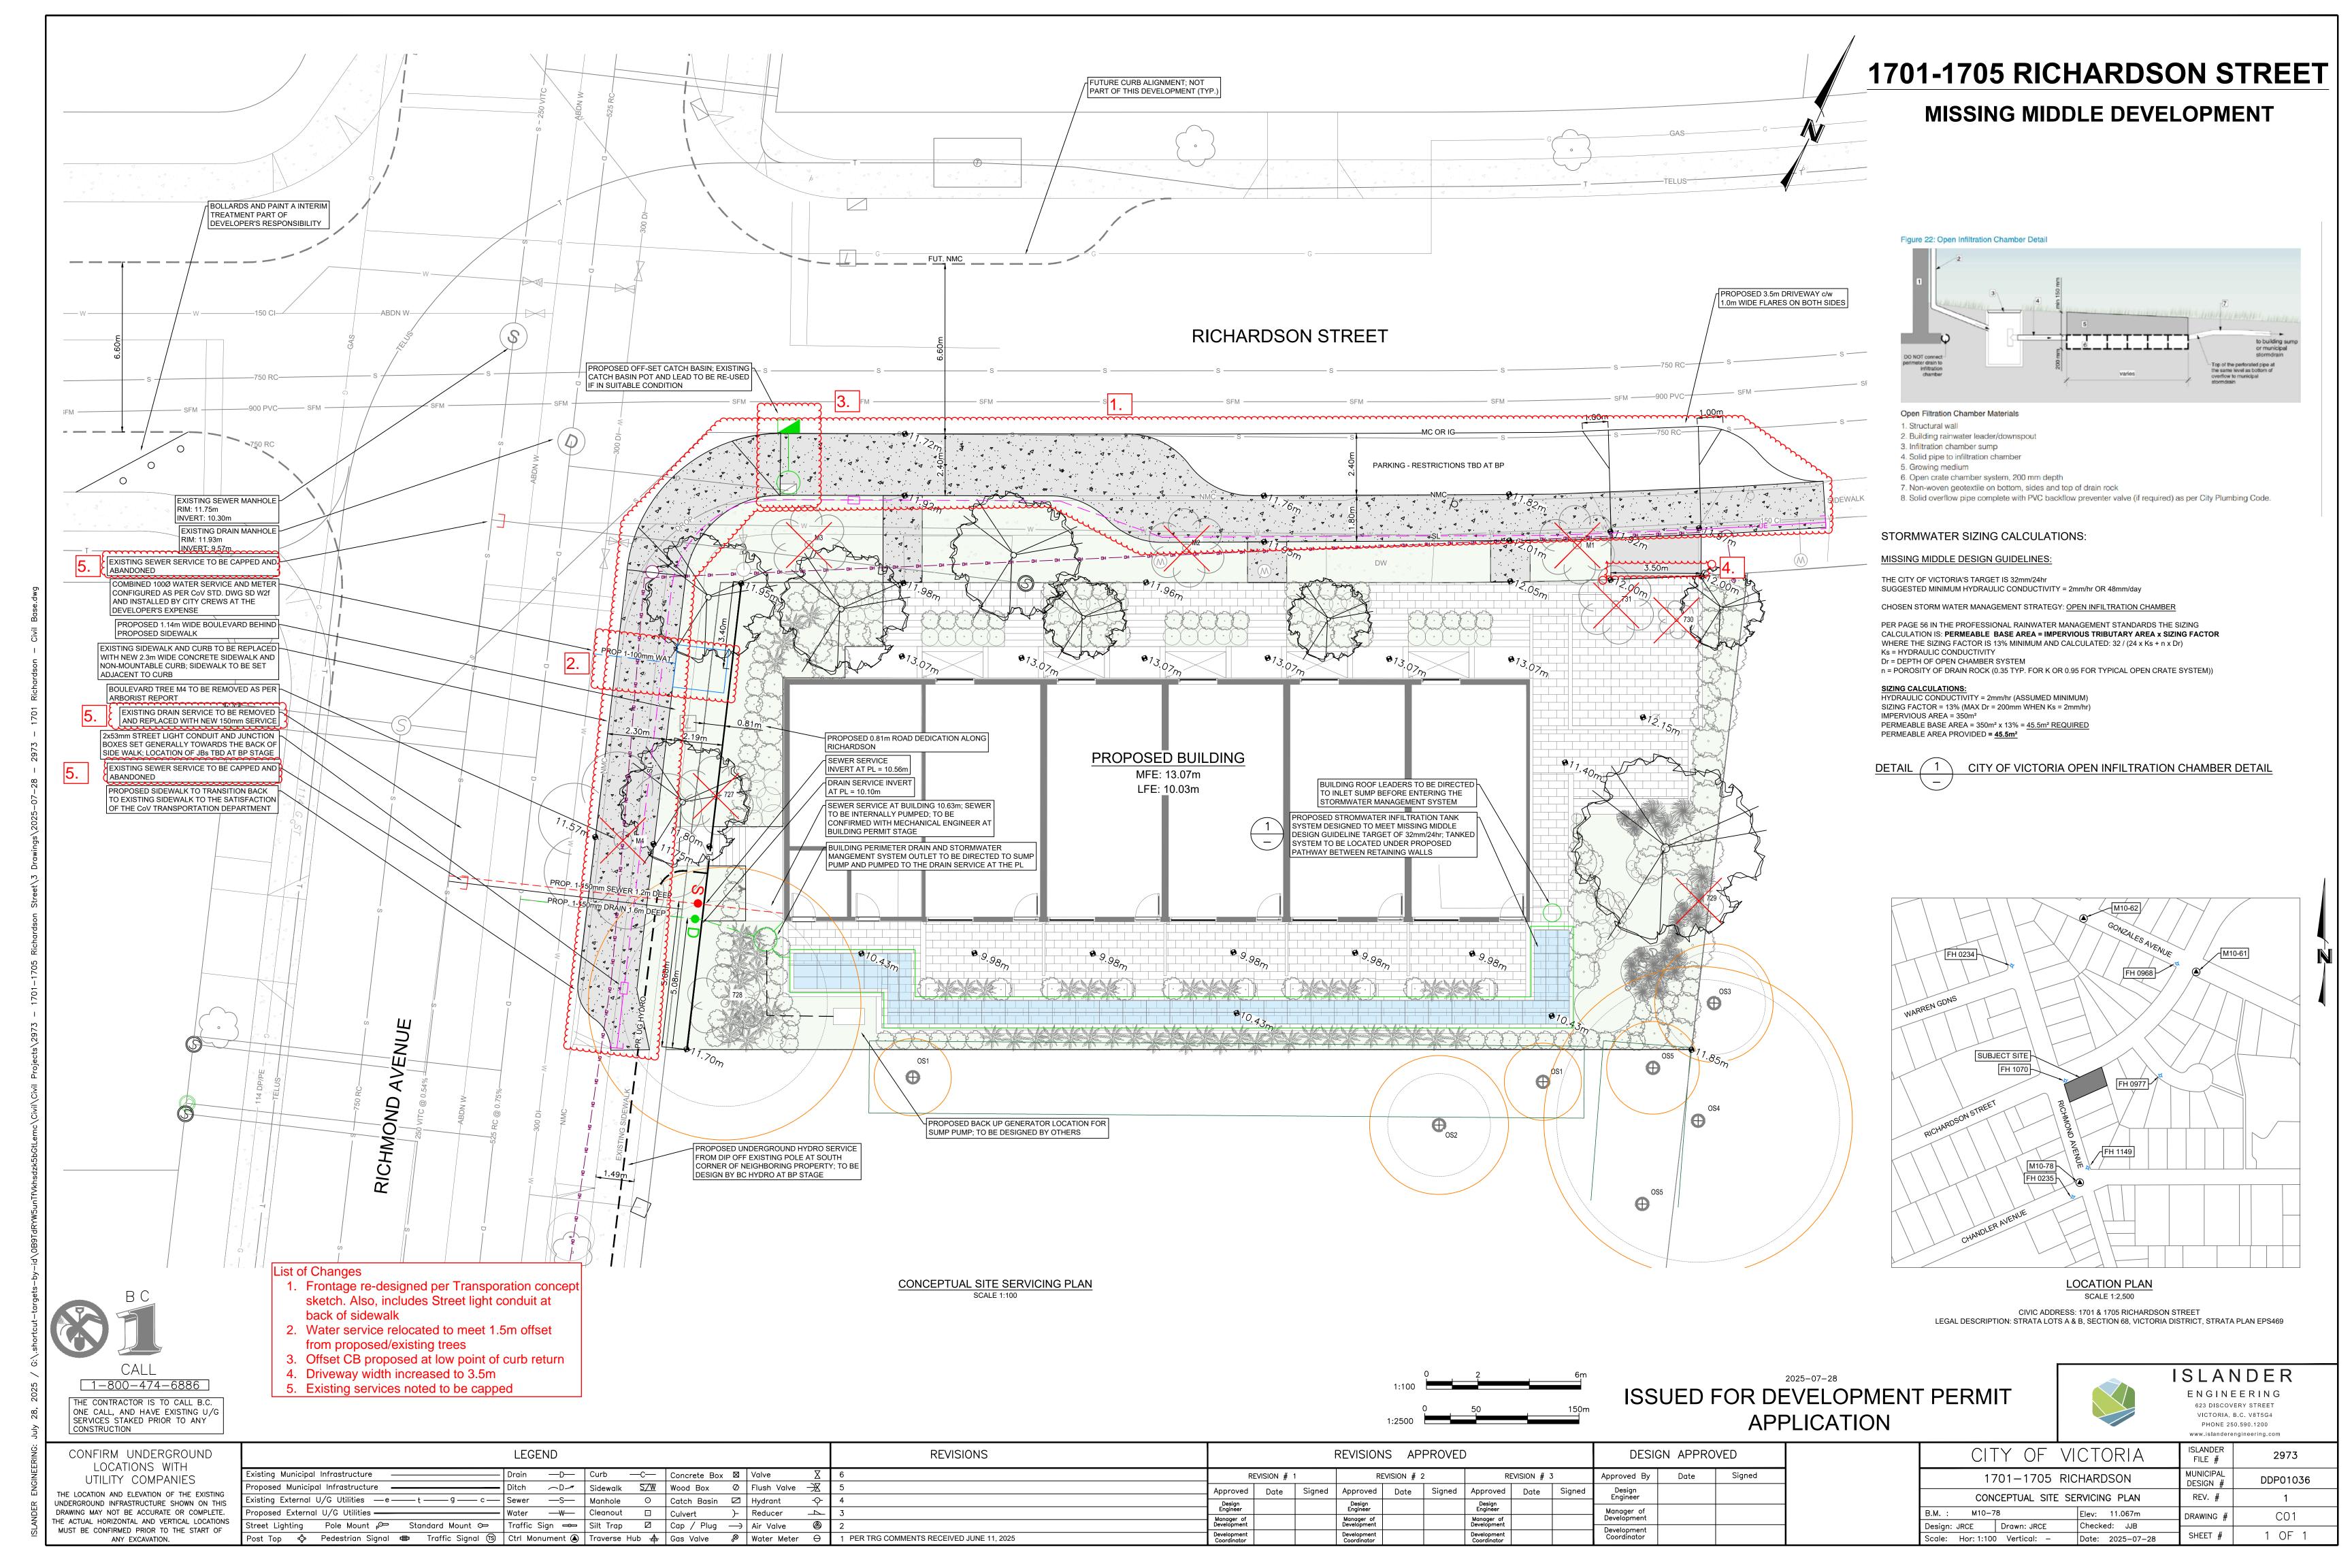

1701-1705 RICHARDSON STREET - CONCEPT PLAN **BUBBLED CHANGES** I. EV CHARGER LOCATION MOVED. 2. LANDSCAPE AREA ADJUSTED TO INCLUDE IM FROM LOT LINES AND NEW AREA ON PLANS. — IX NEW BOULEVARD TREE CORNUS KOUSA 'SATOMI' - 3X NEW BOULEVARD TREES. PARKS TO PROVIDE FINAL SPECIES OF TREES TO BE PLANTED AT BP STAGE. EACH BOULEVARD TREE WILL BE PROVIDED A MINIMUM OF 20M3 OF SOIL VOLUME WITH A MINIMUM DEPTH OF 1000MM. NEW BOULEVARD TREES ARE TO BE PROCURED RICHARDSON STREET AND PAID FOR BY THE CLIENT. - REMOVE TREE MI: NORTHERN —LOW SHRUBS AND EASY CARE FLOWERING PERENNIALS IN ALL GARDEN BEDS REMOVE TREE M2: EUROPEAN WHITE BIRCH EUROPEAN HAWTHORN BELGARD AQUALINE PERMEABLE PAVERS IN NATURAL COLOUR — --- NEW SMALL TREE CORNUS 'EDDIE'S WHITE WONDER' IX MEDIUM CANOPY TREE BETUAL NIGRA 'DURA HEAT' REMOVE TREE M3: NORTHERN EUROPEAN HAWTHORN -IX NEW BOULEVARD TREE CORNUS KOUSA 'SATOMI' -- REMOVE TREE 730 — REMOVE TREE 731 IX NEW SMALL TREE ACER DAVIDII HEATPUMPS — ALL PATHS AND DRIVEWAY TO BE BELGARD AQUAPAVE — EV CHARGER **ROAD DEDICATION** — IX NEW SMALL ACER DAVIDII - NEW 1.8 M VERTICAL SLAT PERIMETER FENCE AT EXISTING GRADE - RETAINING TOP OF WALL AT EXISTING GRADE REMOVE TREE #727: **LEGEND** 2 x .15m CONCRETE STEPS UP TO COMMUNAL SPACE LAWSON CYPRESS WIDE GRASSY PATH TO BE +/- .2 BELOW EXISTING GRADE AND GARDENS MOUNDED ABOVE — OPEN SITE AREA TO BE AT OR MOUNDED ABOVE EXISTING GRADE IX NEW BOULEVARD TREE POPULUS TREMULOIDES -REMOVE TREE M4: CHERRY PLUM — IX LARGE CANOPY TREE QUERCUS GARRYANA **EXISTING TREE TO BE RETAINED** SEWER —— NEW PROPERTY LINE —— —— REMOVE TREE #729 TREE TO BE REMOVED DRAIN — WINDING GRASSY PATH WITH MOUNDED HERB, AND NATIVE POLLINATOR GARDENS PATIO PATIO PATIO PATIO PATIO - NATURAL PLAYGROUND ELEMENTS CRITICAL ROOT ZONE - RETAIN EXISTING OS3 DRIP LINE RADIUS **NEW TREE RETAIN OS5** ☐ NEW 1.8M VERTICAL PERIMETER FENCE - Im SCREENS BETWEEN UNIT PATIOS AND WALKWAYS – BELGARD CLASSIC STANDARD PAVERS IN NATURAL COLOUR POPULUS TREMULOIDES - RETAIN OS4 BACKUP GENERATOR 1/2" CRUSH AROUND BACKUP GENERATOR *SEE ARBORIST PLAN FOR TREE PROTECTION FENCING — NATIVE PLANT SHADE GARDEN RETAIN OS I — - RETAIN EXISTING WILLOW TREE #728 CODNILIC VOLICA "CATOMI" VERTICAL PERIMETER FENCING — BETULA NIGRA 'DURA HEAT' Greenspace Designs Sustainable Landscape Design " PROJECT TITLE " PROPOSED CONCEPT PLAN for MIRIAM BYRNE 1701-1705 RICHARDSON STREET, VICTORIA, BC **# PAGE TITLE #** 1:100 SCALE CONCEPT PLAN, ONE of FIVE :: DATE :: **SCALE** 1:100 APRIL 15, 2025 0 I 2 3 4 5 Revised JULY 21, 2025 Revised NOVEMBER 6, 2025 —— HORIZONTAL SCREENING BETWEEN UNIT PATIOS AND COMMON WALKWAY ACER DAVIDII Quercus garryana — CORNUS 'EDDIE'S WHITE WONDER' —

TREES MUST BE PLANTED WITH NO MORE THAN A 50 mm DEPTH FROM FINISHED GRADE TO THE TOP OF THE ROOT BALL

GRASS BOULEVARD


ROOT BARRIER

450 mm x 4.0M LENGTH

REVISIONS DRAWING NUMBER:

SD P4

1701-1705 RICHARDSON STREET - TREE PLAN SUPPLEMENTARY STANDARD CITY OF VICTORIA BOULEVARD TREE NOTES **DETAIL DRAWINGS** STREET TREES PREPARATION NOTES: 'EDDIE'S WHITE WONDER' 1. CONTAINER GROWN: REMOVE COMPLETELY FROM CONTAINER - Proposed Street Trees must comply to City of Victoria Supplementary Specifications for Street Trees and 2. BURLAP AND ROPE: Irrigation Schedule C, Bylaw 12-042, Subdivision Bylaw and the current version of the Canadian Landscape REMOVE TOP 1/3 OF COVERING Standard. Planting details can be found in Schedule B3-4 or on the approved landscape plan. The following tree 3. WIRE AND BURLAP: inspections by Parks Staff are required by Schedule C. To schedule an inspection please contact Rob Hughes, REMOVE TOP & OF WIRE, ROPE AND BURLAP COVERING WITHOUT DAMAGING ROOTBALL. REMOVE ALL TWINE. DO NOT PRUNE LEADER CORNUS KOUSA 'SATOMI' rhughes@victoria.ca and also copy treepermits@victoria.ca 48 hours prior to the required inspection time. PRUNE ONLY DEAD OR DAMAGED BRANCHES — BOULEVARD POPULUS TREMULOIDES -PLANTING AREA: TREE PLANTING INSPECTIONS 32.79 SQM I. Excavated tree pits, soil cells, root barriers 2. Trees prior to planting. (Parks staff can inspect trees prior to shipping at local REMOVE TREE M2: EUROPEAN WHITE BIRCH EXISTING SEWER nurseries. Photos can be provided from up-island and mainland nurseries. Tree must meet the spec upon delivery.) 2-2 1/2" (64mm) ROUND PRESSURE — QUERCUS GARRYANA TREATED STAKES @ 8' 0" (2440mm) LENGTH. STAKE AT EDGES OF THE ACER DAVIDII WATER — 3. Completed planting-tree planting, grate/guard, stakes etc. ---- IX NEW BOULEVARD TREE ROOTBALL IN LINE WITH ROADWAY. ON EXPOSED SITES STAKE IN LINE WITH PREVAILING WIND. VERTICAL STAKES TO BE DRIVEN 600 mm INTO GROUND. **RICHARDSON STREET** CORNUS KOUSA 'SATOMI' 40mm NYLON WEBBING

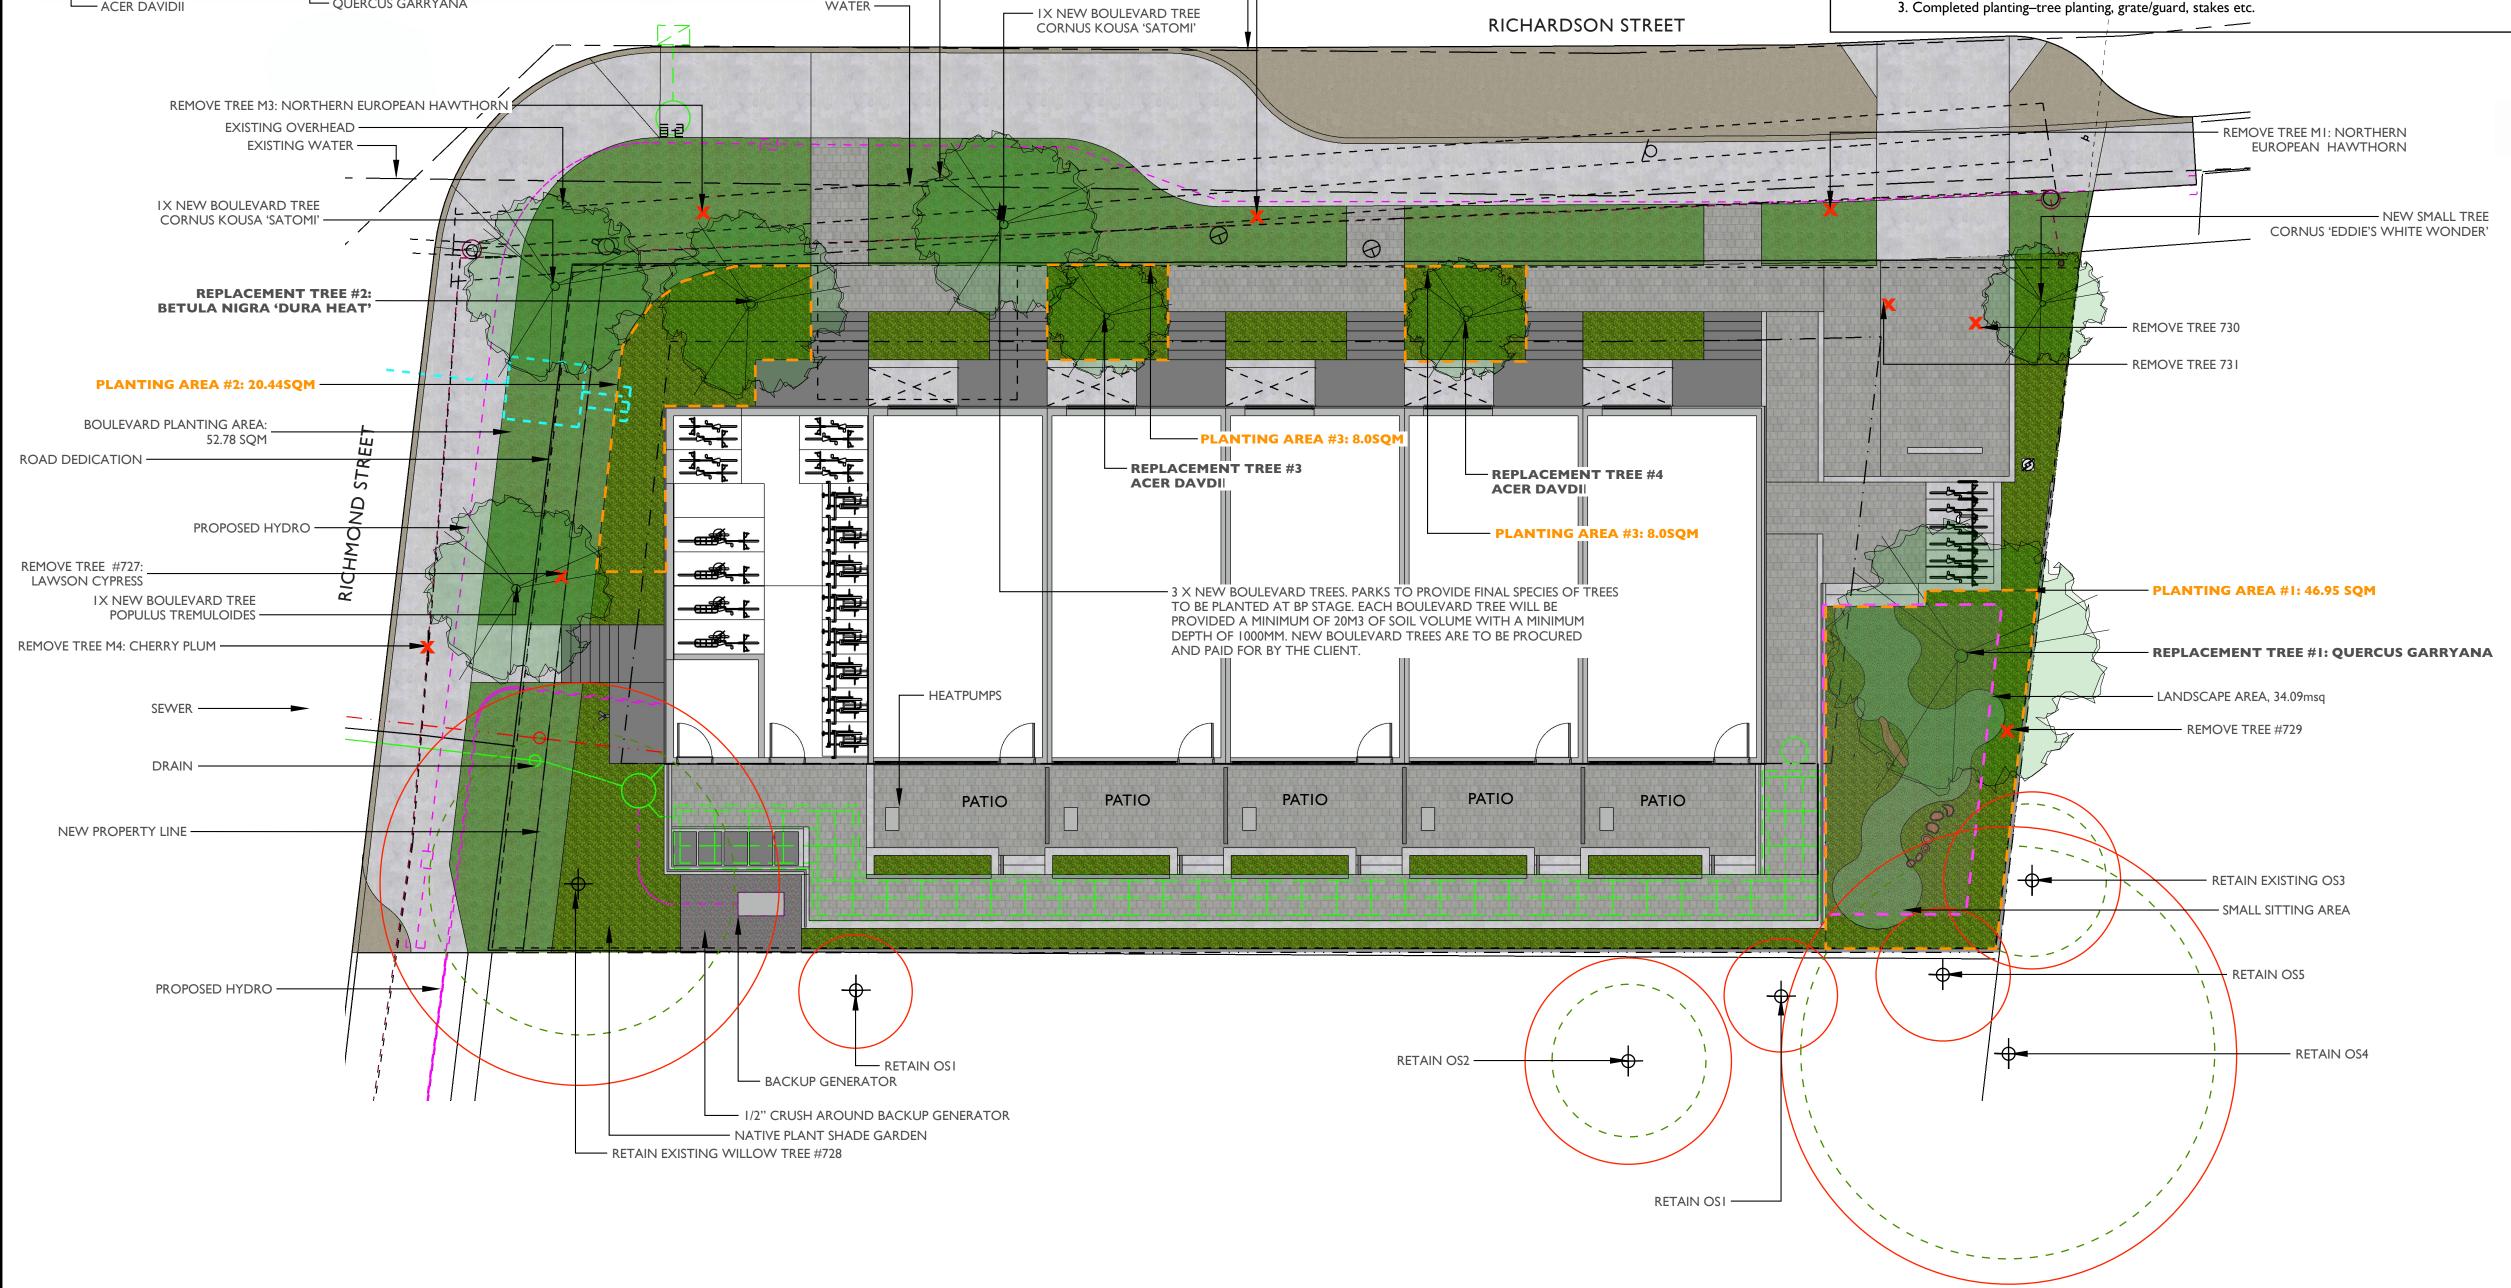



ALL TREES SHALL MEET OR EXCEED THE CITY OF VICTORIA TREE SPECIFICATIONS


ROOT BARRIER REQUIRED ON BLVD 2.0m OR LESS WIDE OR AS SPECIFIED BY THE DIRECTOR OF PARKS

ROOT BARRIER REQUIRED PENDING TREE SPECIES

TREE PLANTING IN BOULEVARD

AND/OR BLVD WIDTH.

				REPLACEMENT TREES PROPOSED			SOIL VOLUME REQUIRED (m3)			
PLANTING AREA ID	AREA (m2)	SOIL VOLUME MULTIPLIER	A. ESTIMATED SOIL VOLUME	B.#SMALL	C. #MEDIUM	D. #LARGE	E.#SMALL	F. #MEDIUM	G. #LARGE	TOTAL
PLANTING AREA #1	46.95	1	46.95	0	0	1	0	0	35	35
PLANTING AREA #2	20.44	1	20.44	0	1	0	0	20	0	20
PLANTING AREA #3	8.0	1	8.0	1	0	0	8	0	0	8
PLANTING AREA #4	8.0	1	8.0	1	0	0	8	0	0	8
*ALL PLANTING AREAS TO BE IRRIGATED					•					•

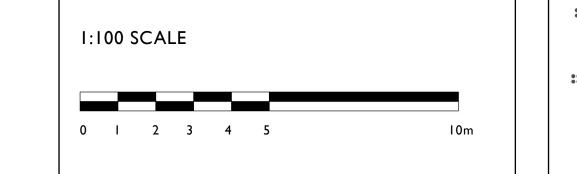



1.0m DIAMETER BARK MULCH

RING SAUCER OVER ROOTBALL 150mm DEPTH

GROWING MEDIA SHALL MEET B.C. LANDSCAPE

STANDARD TABLES 6-3 (SECTION 32 91 21-MMCD 2009) ALL SOIL PROPERTIES MUST MEET THIS STANDARD. DEPTH GROWING MEDIA TO BE PLACED AND TRAMPED IN 100 mm LIFTS—

ROOT BARRIER 450 mm x 4.0M LENGTH

" PROJECT TITLE "

PROPOSED CONCEPT PLAN for MIRIAM BYRNE 1701-1705 RICHARDSON STREET, VICTORIA, BC

PAGE TITLE

AGE IIILE "

TREE PLAN, PAGETWO of FIVE


DATE

Revised JULY 21, 2025


Revised NOVEMBER 6, 2025


APRIL 15, 2025

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1701-1705 RICHARDSON STREET - SITE PLAN

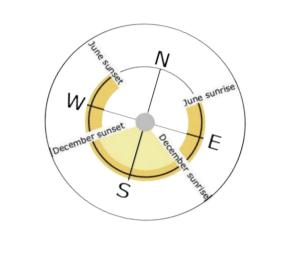

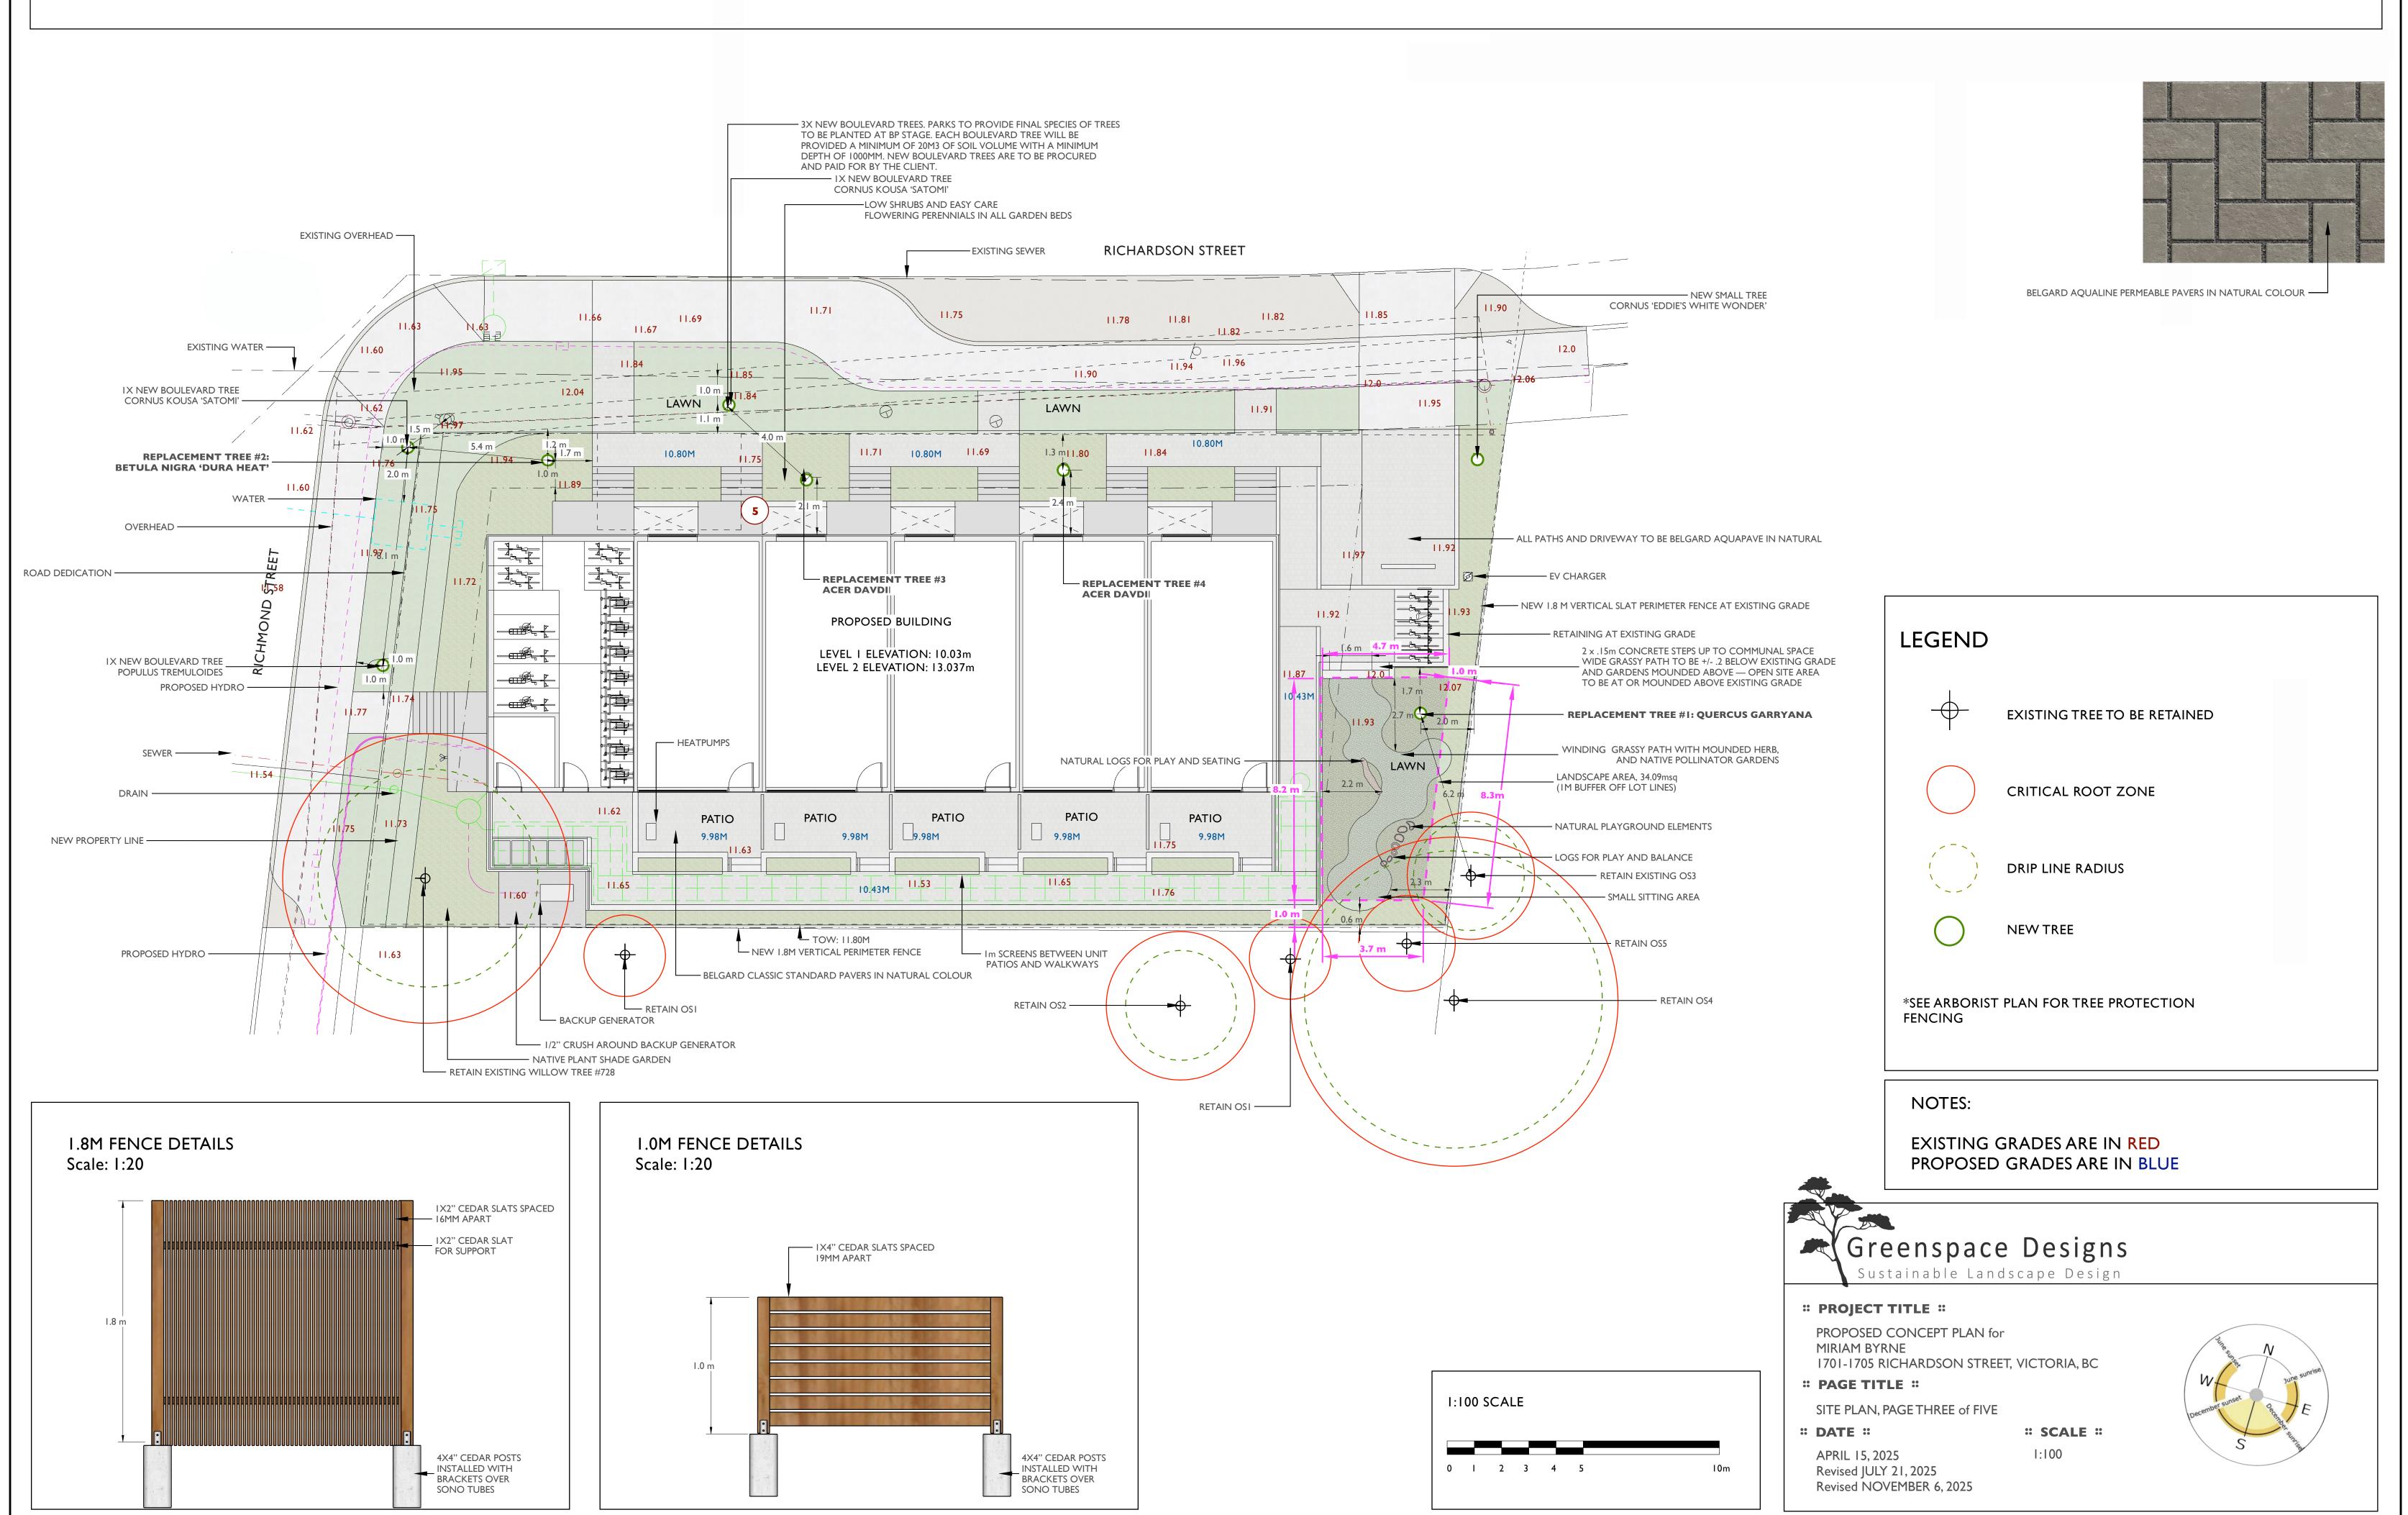

1701-1705 RICHARDSON STREET - LANDSCAPE NOTES

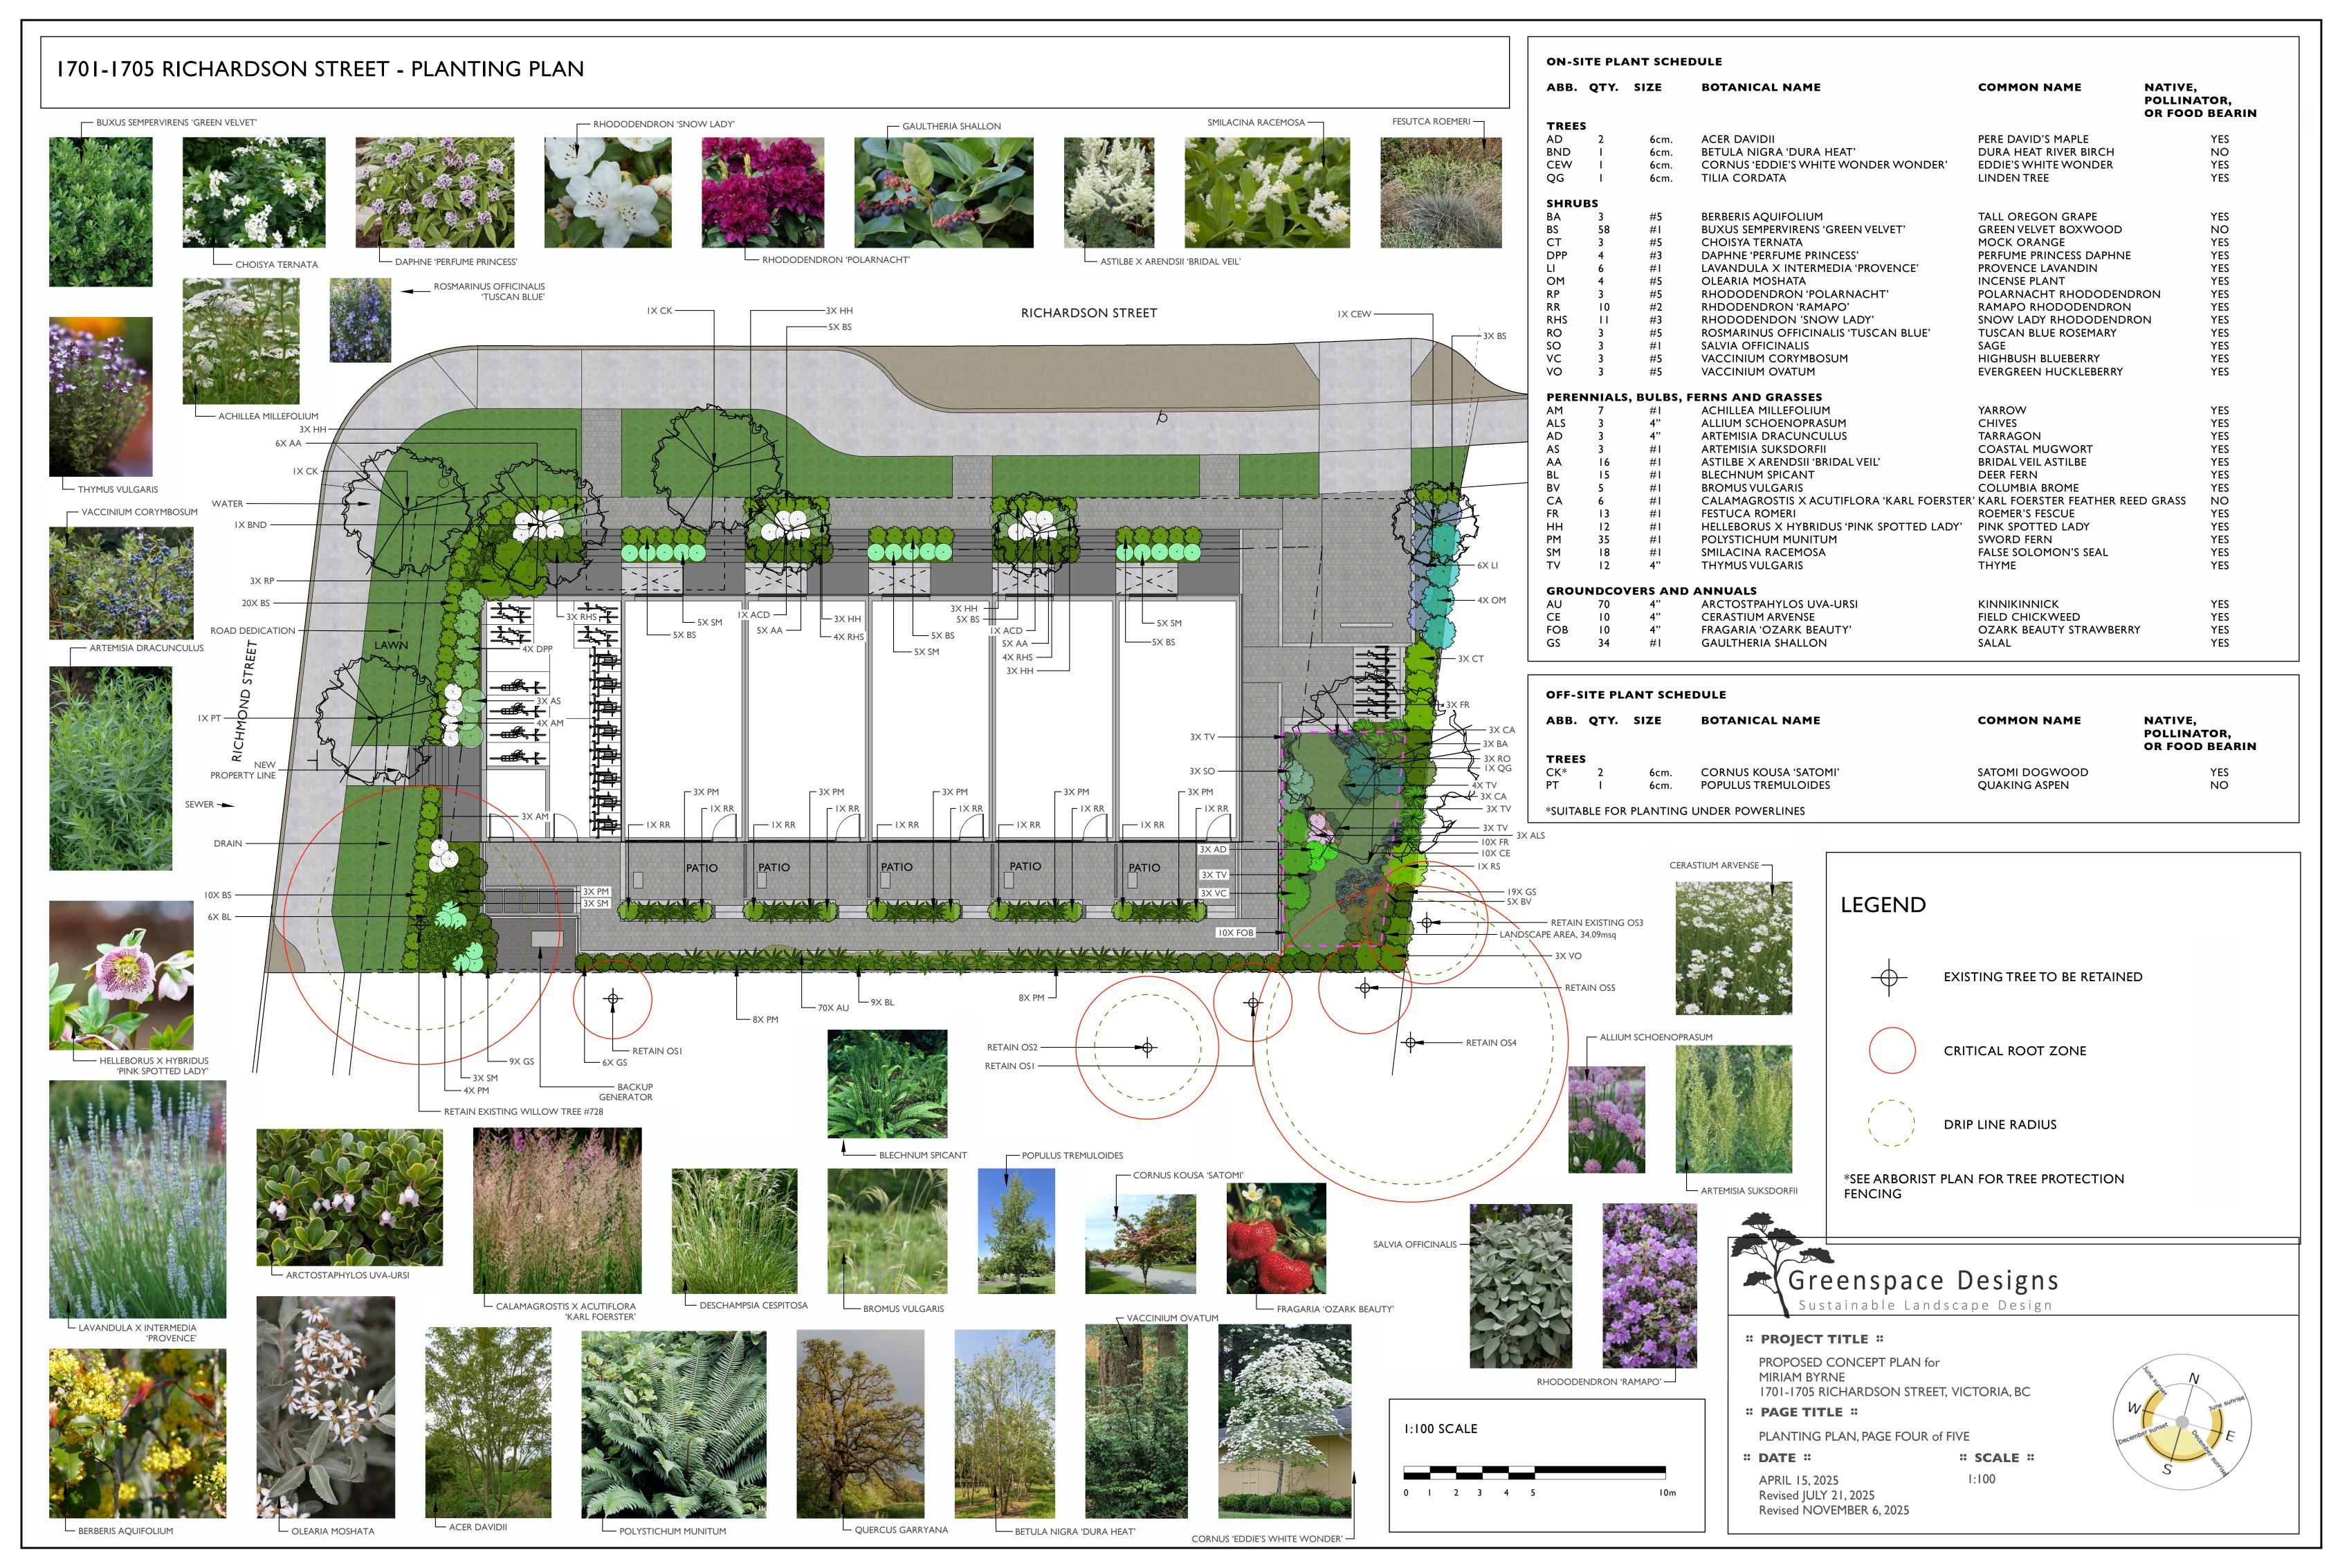
OVERALL NOTES

- 1. Plantings, landscape installation, and irrigations should all be installed in accordance with the BCLNA/BCSLA standard (2020)
- 2. Any plant substitutions shall be made in consultation with the landscape architect.
- 3. The Landscape and Irrigation Contractor shall determine the location of all underground services prior to the commencement of landscape work and shall be responsible for the repair of all damage caused by landscape work to the Owner's satisfaction.
- 4. All topsoil and plants shall conform to BCNTA / BCSLA specifications.
- 5. BCLNA/BCSLA standard (2020) is the guiding resource for all notes on this page

MATERIALS

CAST-IN-PLACE CONCRETE

- I. Cast-in-place concrete may have a finish of trowel finish, broom finish, exposed aggregate, or parging. To be finished as specified on landscape plans.
- 2. Concrete should be reinforced with rebar.

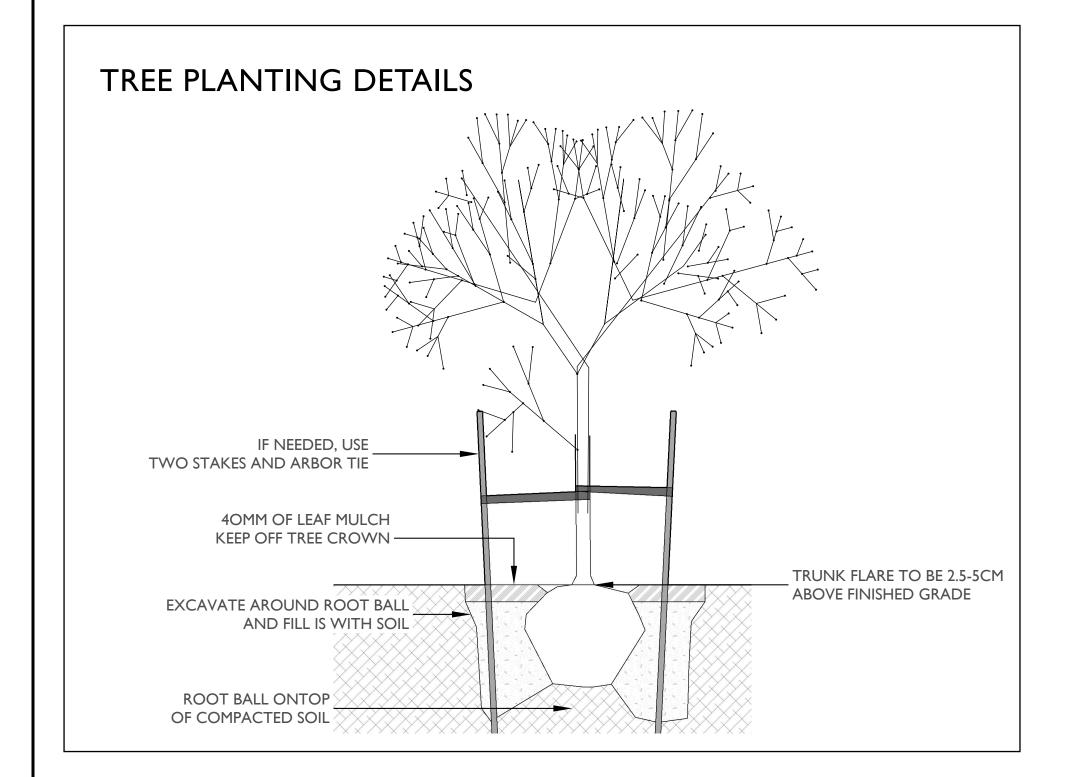

STOCKPILES

- I. Site materials should be stockpiled separately from the growing medium to avoid contaminating the growing medium.
- 2. Ideally, the growing medium is delivered on the day of installation.
- 3. Soils, fill, sand, gravel, or any construction materials should not be stockpiled within the t critical protection zones.
- 4. Soil or subsoil should not be stockpiled in low areas to avoid erosion or water pooling.

TOPSOIL


- I. On-site topsoil should be used if it meets the standards for a growing medium.
- 2. Topsoil should have a pH range of pH 5.5-7.5 and contain not less than 2 % Organic Matter [OM] by weight and a salt conductivity of less than 2.5 dS/m
- 3. Both imported and on-site topsoil should be tested and amended before landscape work commences on-site by the contractor or soil supplier. Modification costs should be included in the overall budget.

6. MULCH

- I. All planted beds shall be covered with a 55 mm layer of high organic low-wood content mulch.
- 2. 2.Mulch should be a minimum of 10cm (4in.) from the crown of any plant. It is never to be mounded up around the stem of the plant.
- 3. Mulch depths should be at most 10cm (4in.) around larger plants and 5cm (2in.) for smaller plants such as groundcovers.
- 4. Trees installed in lawns should have a mulch ring of 1m diameter that will be maintained for a minimum of 8 years.
- 5. Mulch is to be of a type suitable for the material planted.

PLANTING.

- I. All trees shall be secured with two 75 mm diameter \times 1.8 m long round poles set 1m into the ground.
- 2. Plants determined to be dead or dying at the end of one year from the installation date shall be replaced by the Contractor at the Contractor's expense.
- 3. Growing media settlement should be corrected prior to mulching.
- 4. Immediately after planting, trees shall be stabilized, ensuring that the tree's crown has free movement, but wind, snow loading, or human force will not disturb the buttress root system or cause the rootball to shift in the ground.
- 5. Trees may not need stabilization if the subsoil and growing medium are stable and can hold the rootball in place, and the rootball is solid and contained and shaped where it can resist shifting.
- 6. Planting debris and materials shall be removed promptly from the site.
- 7. Plants must be watered immediately after planting to the depth of their root systems.
- 8. The contractor is responsible for scheduling the delivery of plants to the site in conformance with the contract documents.
- 9. Plants should spend a minimal amount of time in the storage on site.

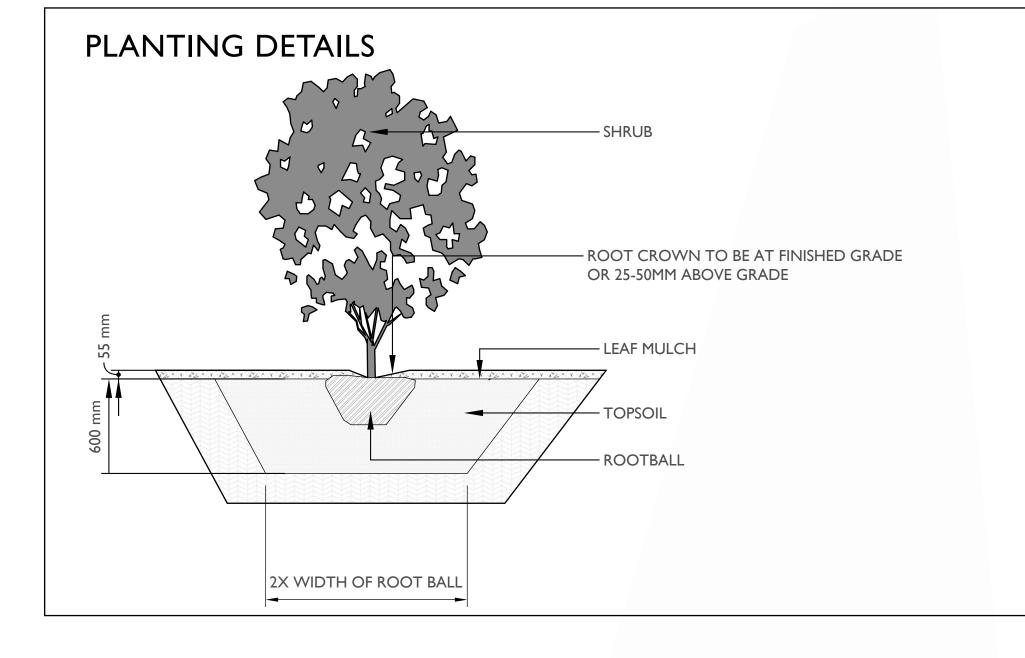

SEED

- I. All grass areas shall be seed.
- 2. The finished grade should be smooth, firm against footprints, loose textured, and free of all stones, roots, and branches.
- 3. Areas with heavy compaction should have their surfaces loosened employing thorough scarification, discing, or harrowing to a minimum of 150mm (6in.) depth.
- 4. Slope soil away from house and level soil by dragging a 2x6" board over area, rake the soil even, then roll over the soil three times in opposite directions until soil is firm.
- 5. Add a light dressing of peat moss, just as a measure to retain moisture.
- 6. A mix of 3 grass species is better than one species. The following grasses are known for their hardiness and have been tested for turf quality and resistance to many diseases and insects. A good basic mix would be 30% Kentucky blue, 30% perennial rye and 40% tall fescue. These do well in cool-season climates such as ours.
- 7. Seed should be applied at a rate of one pound per 200 square feet and spread in opposite directions.
- 8. After application seed should be lightly and gently raked.
- 9. After seeding the newly seeded area must be watered evenly, and kept moist until lawn is established.

IRRIGATION

- I. All planting beds shall be irrigated with an automatic underground system with automatic rain shut-off.
- 2. Irrigation sleeving is to be 150mm in diameter. Schedule 40 or SDR 28.
- 3. Must be installed 12" below finished grade for all lateral lines and 18" below finished grade for irrigation main lines.
- 4. All irrigation materials and installation methods shall conform to IIABC standards.
- 5. Irrigation within municipal rights of way shall conform to the City of Victoria requirements.
- 6. Backflow preventer requirements for irrigation lines shall conform to Victoria municipality requirements.
- 7. The Irrigation Contractor shall test the irrigation system and ensure that it is fully operational prior to acceptance by the owner.

CITY OF VICTORIA IRRIGATION NOTES

Irrigation Systems on City property shall comply to City of Victoria Supplementary Division for review and approval 30 days prior to installation work. The following irrigation and sleeving inspections by Parks are required tsherbo@victoria.ca 48 hours prior to the required inspection time. Irrigation Inspection Requirements.

- The irrigation system and sleeving inspection requirements can be found in Schedule C of the Victoria Subdivision and Development Servicing Bylaw No. 12-042.
- Irrigation Sleeving prior to backfilling*
- Open trench Main Line and Pressure Test
- Open trench Lateral Line
- Irrigation system, Controller, Coverage test, Backflow Preventer Assembly Test
- Report required, Backflow Assembly is to have an inspection tag completed and attached.
- Please Note: Parks is now requesting that 100mm SDR 28 pipe be used for irrigation sleeving under hard surfaces. Installations where a 90-degree

WATERING

- I. Plants shall be monitored for moisture at delivery and watered as necessary until planting with on-site irrigation during storage.
- 2. Plants and soil moisture should be monitored during the first and second growing seasons for a sufficient irrigation schedule and to ensure that the plants are healthy with the irrigation setup. If the plants are wilting or showing stress due to water, there shall be an increase in watering frequency.
- 3. Watering should reach the depth of the root zone.
- 4. Irrigation schedules may be skipped if rainfall has penetrated the full depth of the root zone.
- 5. Soil moisture should be maintained at 50 to 100 percent field capacity.

LANDSCAPE LIGHTING

I. Landscape lighting must adhere to the Canadian Electrical Code, British Columbia electrical and building codes, and Municipal by-laws regarding electrical, lighting, and light pollution.



" PROJECT TITLE "

PROPOSED CONCEPT PLAN for MIRIAM BYRNE 1701-1705 RICHARDSON STREET, VICTORIA, BC

PAGE TITLE

LANDSCAPE NOTES, PAGE FIVE of FIVE

" DATE "

APRIL 15, 2025 Revised JULY 21, 2025 Revised NOVEMBER 6, 2025