



Avg. Grade Calculation			
2024-02-28			
600 Dillas			
Average Grade Calculation			
Grade Point	Elevation (metres)		
GPA	17.45		
GPB	17.60		
GPC	17.75		
GPD	17.95		
GPE	18.10		
GPF	17.82		
GPG	17.78		
GPB	x		
Grade Point Average		Sub-Total	
GPA + GPB / 2	17.53	x	24.77 = 434.09
GPA + GPC / 2	17.73	x	11.43 = 202.60
GPA + GPD / 2	17.60	x	4.75 = 85.03
GPA + GPE / 2	18.03	x	6.64 = 116.98
GPE + GPF / 2	17.96	x	27.03 = 485.46
GPE + GPG / 2	17.90	x	8.07 = 143.65
GPG + GPD / 2	17.78	x	2.48 = 44.29
GPA + GPA / 2	17.45	x	7.72 = 134.71
PERIMETER DISTANCE =		92.69	TOTAL = 1,645.71
AVERAGE GRADE = TOTAL/PERIMETER DISTANCE			
Average Grade			17.75

		project name: 9 unit Multi-family Rezoning & Development Permit Application	project no. 2340			
MJM	Architect Inc.	600 Dallas Road, Victoria, B.C.				
	#10, 908 Vancouver Street, Victoria, B.C. V8V 2V6 ph: (250)661-5492 e-mail: mjmoody@shaw.ca	drawing title: Legal Survey/Site Plan Infrastructure Plan	drawn by: mjmm	scale: As Noted	date: 24/12/02 yjmm/dd	drawing no. SK-1

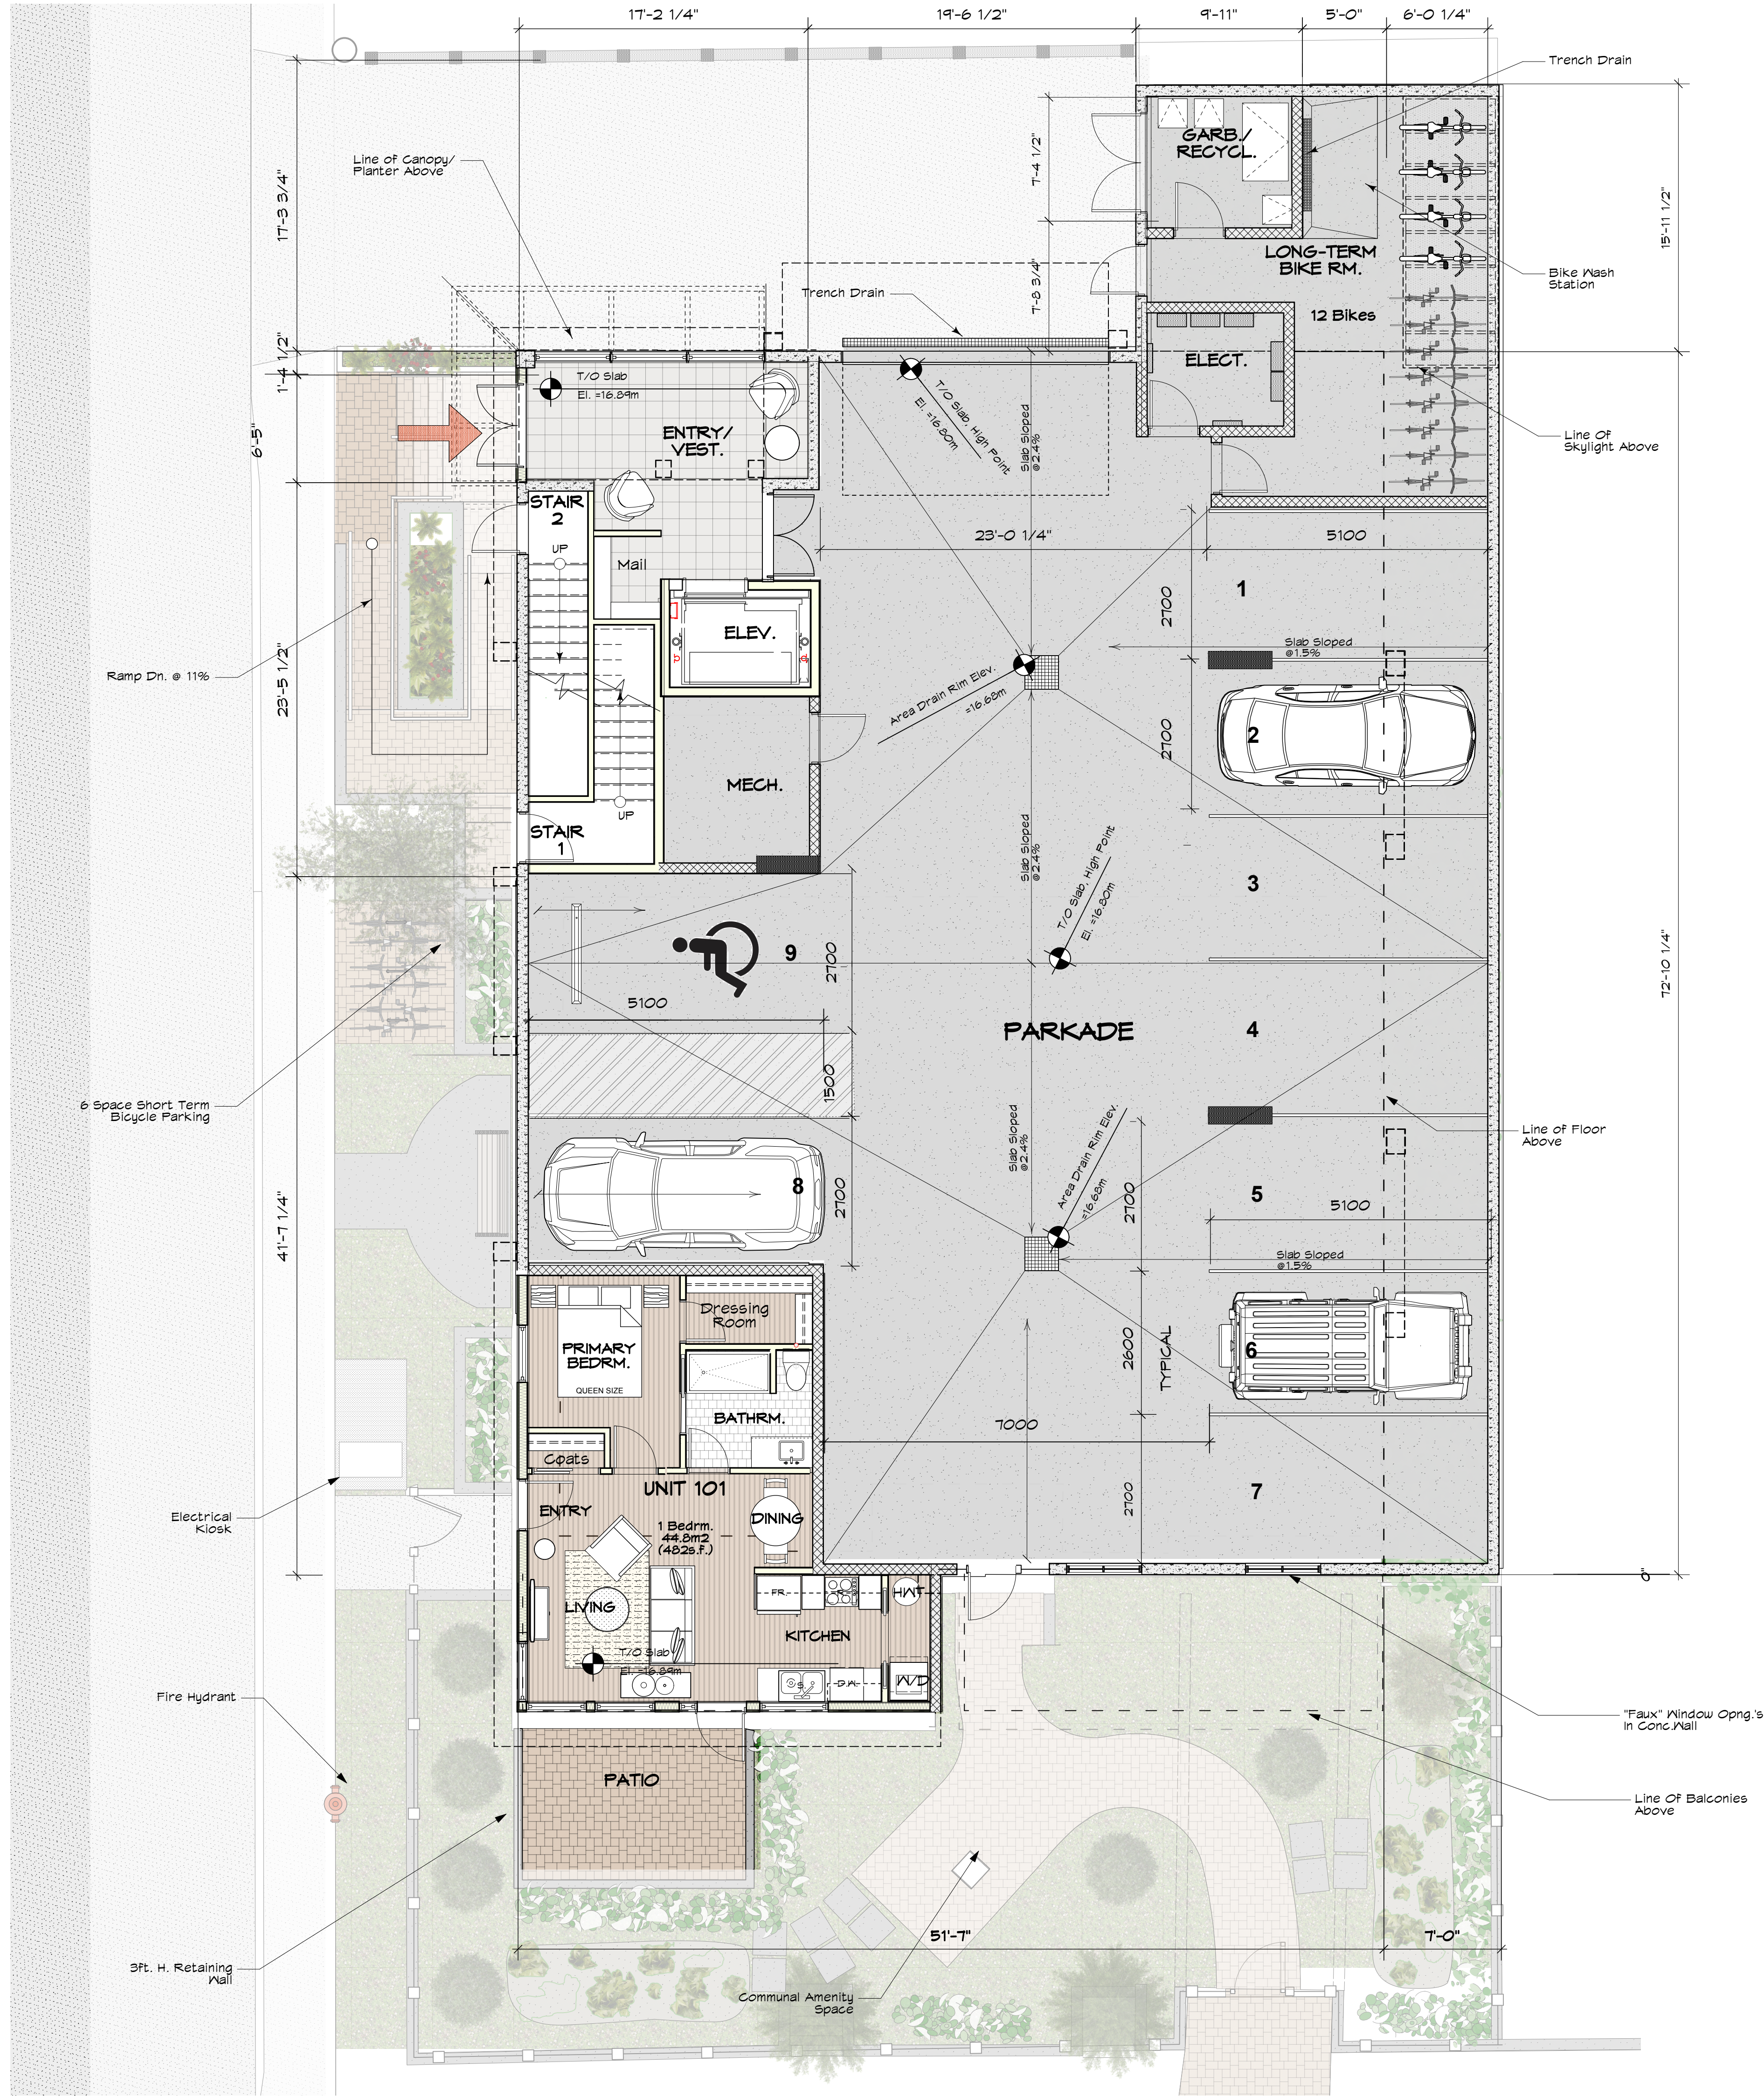

1 Parkade (Main) Floor Plan
Scale: 3/16" = 1'-0"



project name: 9 unit Multi-family Rezoning & Development Permit Application				project no. 2340
600 Dallas Road, Victoria, B.C.				
drawing title: Parkade & Main Floor Plans	drawn by: mjm	scale: As Noted	date: 24/12/02 yy/mm/dd	drawing no. SK-2.1

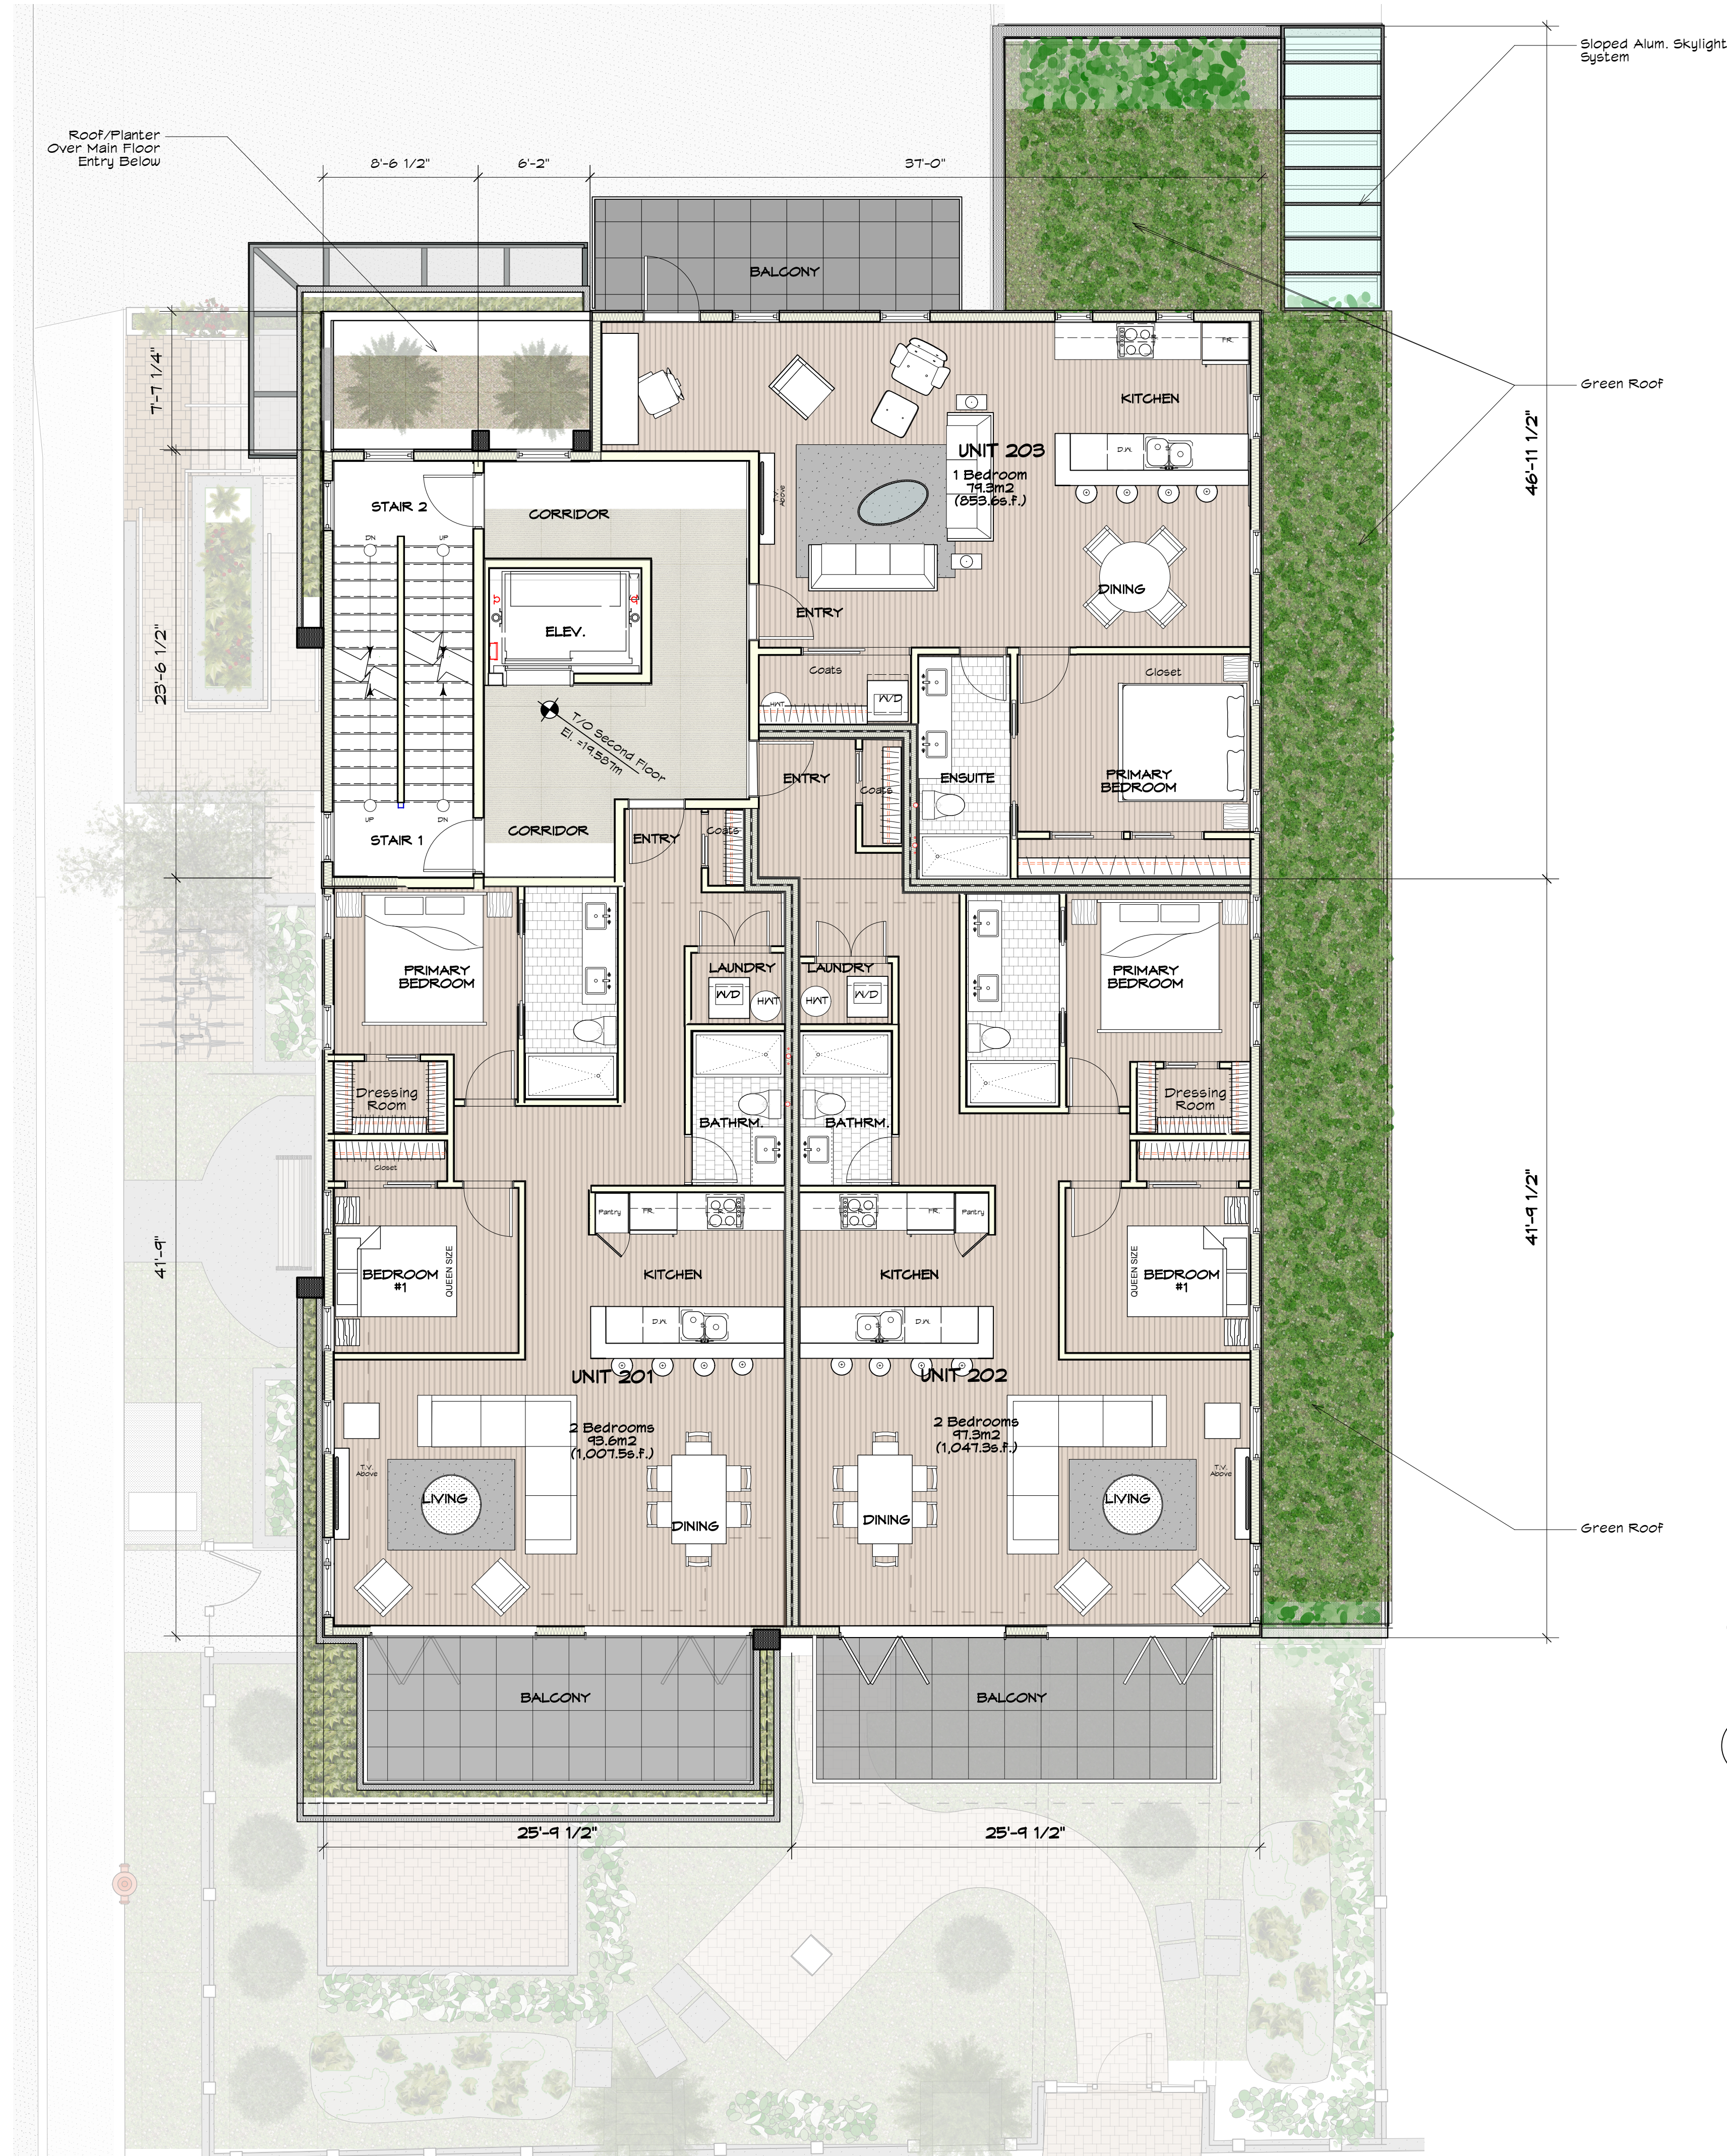

1 Second Floor Plan
Scale: 1/8" = 1'-0"


Scale: $1/8" = 1'-0"$

		project name: 9 unit Multi-family Rezoning & Development Permit Application			project no. 2340
		600 Dallas Road, Victoria, B.C.			
drawing title: Second Floor Plans		drawn by: mjm	scale: As Noted	date: 24/12/02 yy/mm/dd	drawing no. SK-2.2
		checked by: mjm			

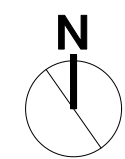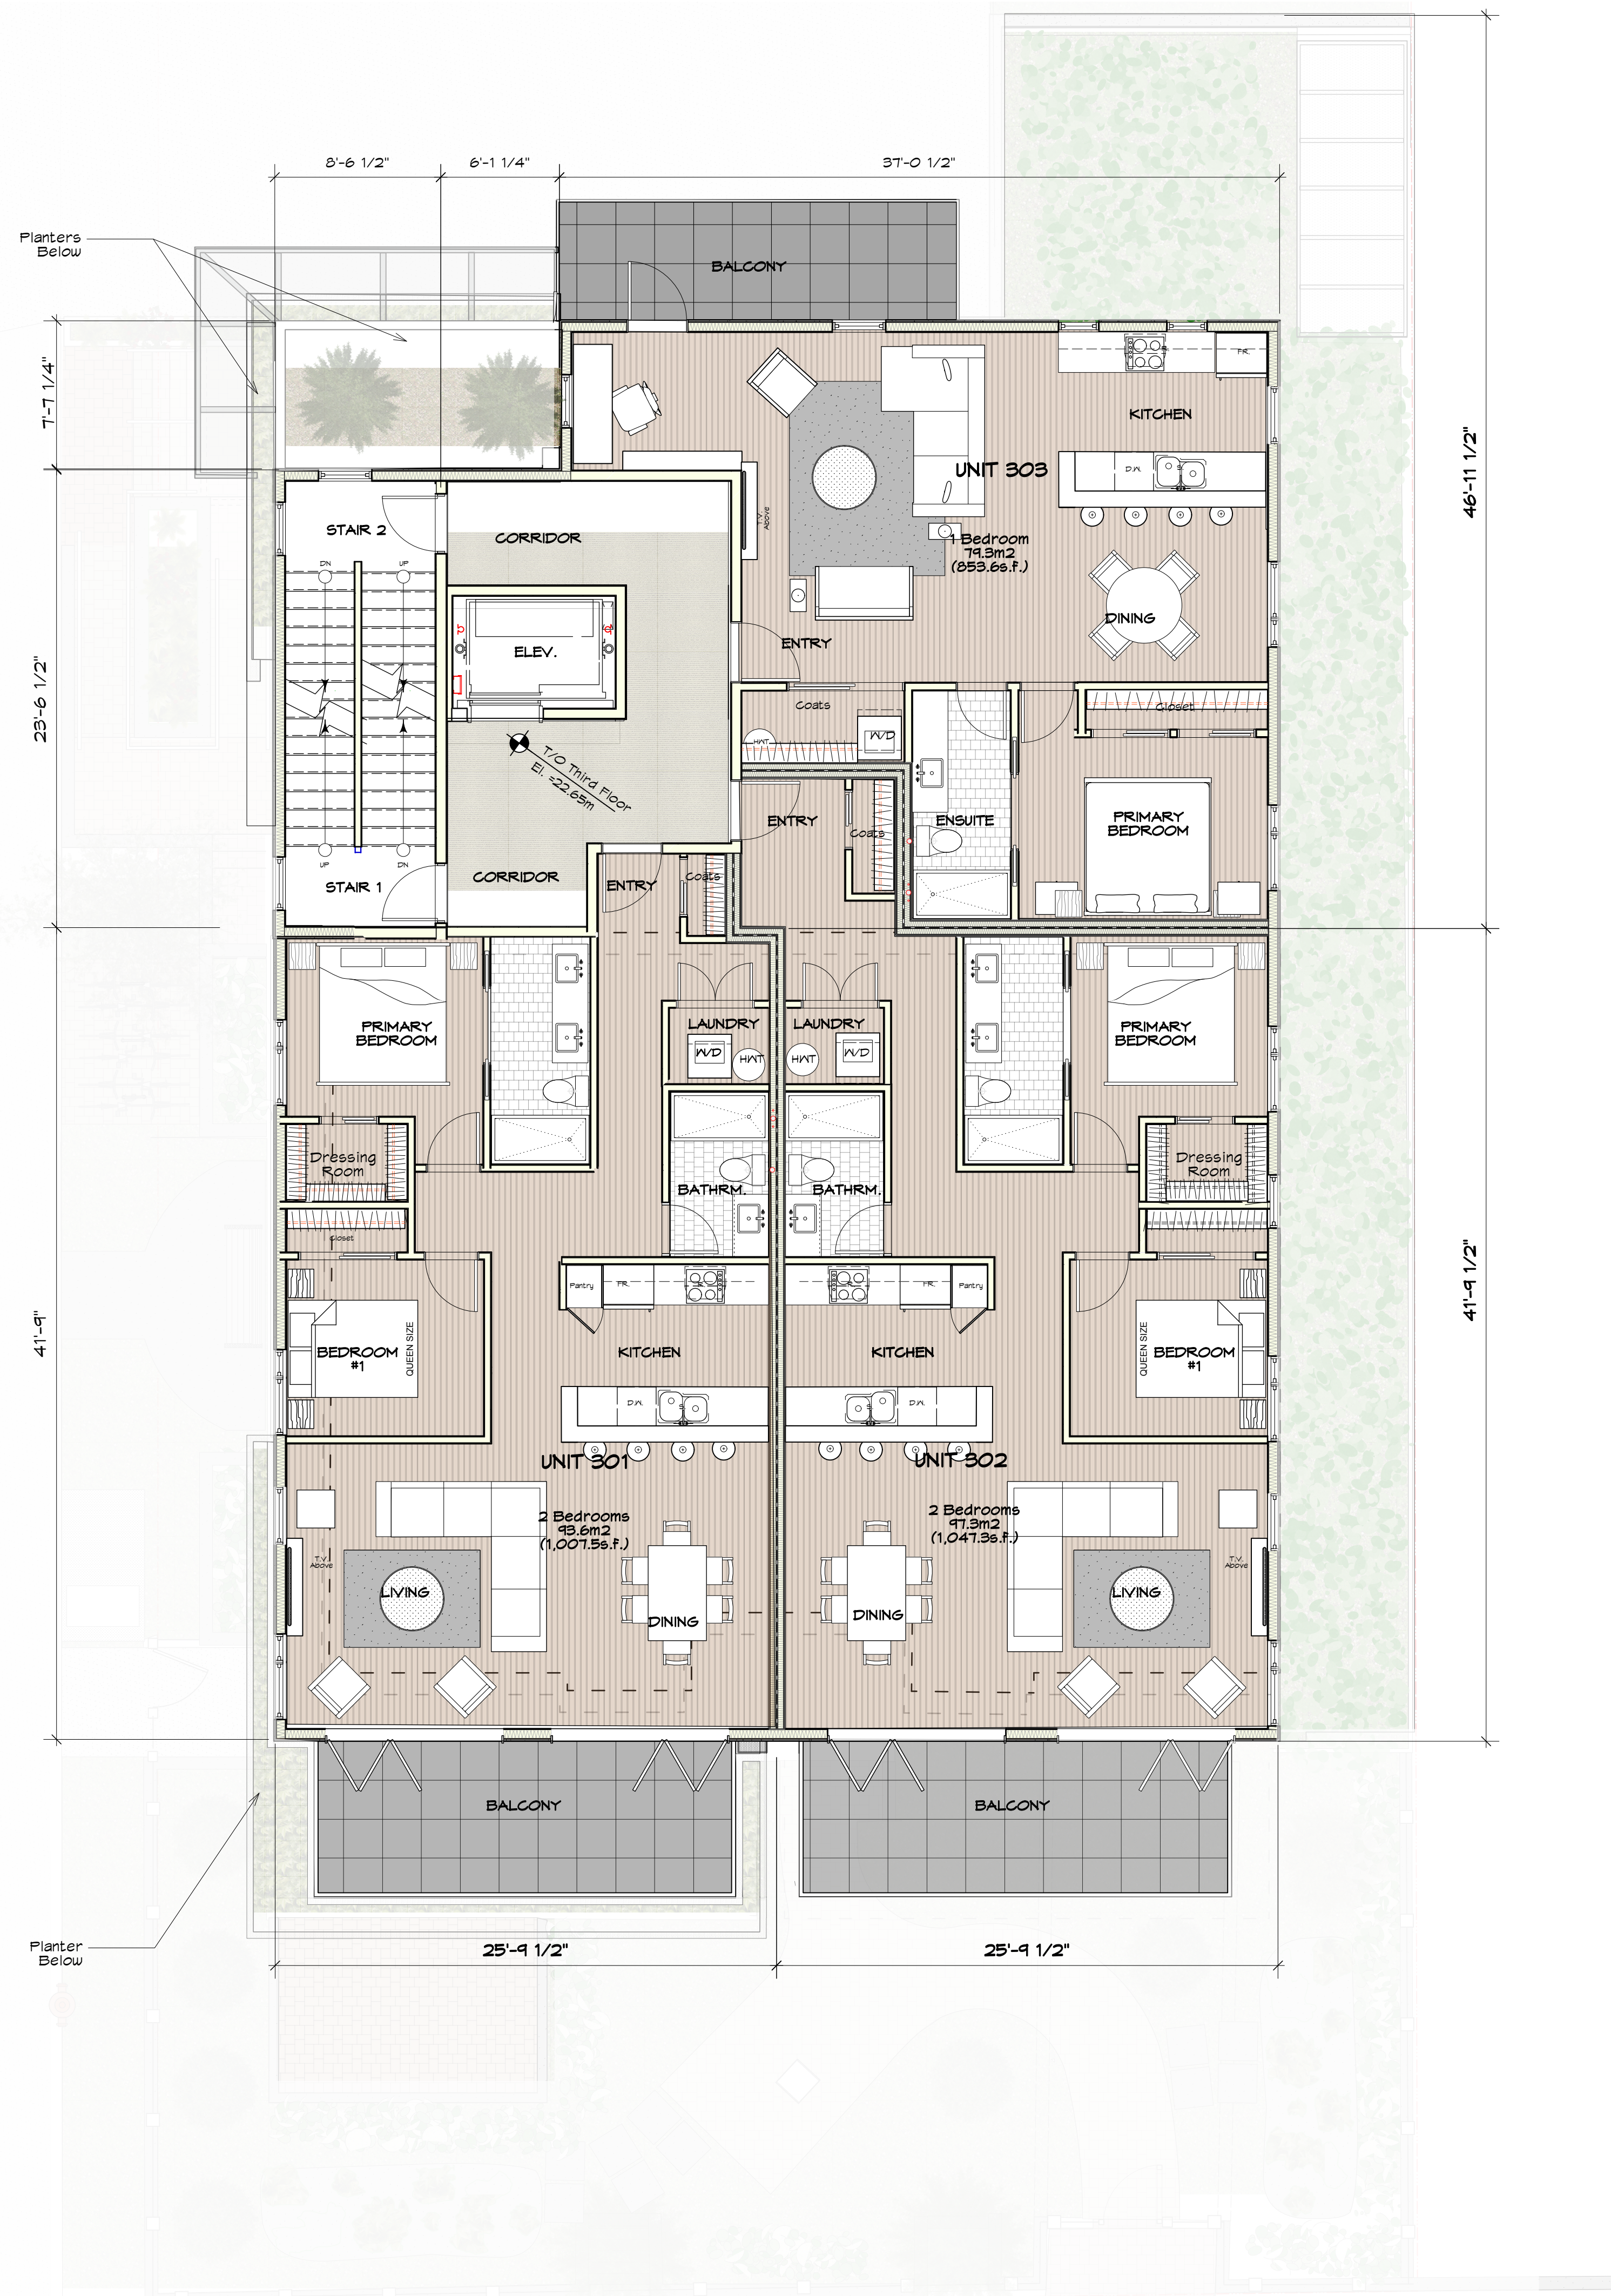

1 Third Floor Plan
Scale: 1/8" = 1'-0"

project name: 9 unit Multi-family Rezoning & Development Permit Application				project no. 2340
600 Dallas Road, Victoria, B.C.				
drawing title: Third Floor Plans	drawn by: mjm checked by: mjm	scale: As Noted	date: 24/12/02 yy/mm/dd	drawing no. SK-2.3

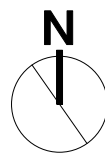

1 Fourth Floor Plan
Scale: 1/8" = 1'-0"

	project name: 9 unit Multi-family Rezoning & Development Permit Application			project no. 2340
	600 Dallas Road, Victoria, B.C.			
	drawing title: Fourth Floor Plans	drawn by: mjm	scale: As Noted	date: 24/12/02 yy/mm/dd
		checked by: mjm		drawing no. SK-2.4



project name: 9 unit Multi-family Rezoning & Development Permit Application				project no. 2340
600 Dallas Road, Victoria, B.C.				
drawing title: Roof Plan	drawn by: mjm	scale: As Noted	date: 24/12/02 yy/mm/dd	drawing no. SK-2.5
	checked by: mjm			



MATERIAL LEGEND	
1	Vert. Metal Siding Finish
2	Hardie Panels (Ftd. White) w/ 3/8" Reveal Panel Gaps
3	Horizontal Cedar Cladding
4	Pre-Fin. Metal Flashing
5	Boardformed (Vert.) Concrete
6	Thermally Broken Dbl. Glazed Vinyl Windows (Blk.)
7	Face-mounted Alum. Picket Guardrails (Blk.)
8	Hollow Metal Door in Pressed Steel Frame (Ftd.)

2 North Elevation
Scale: 3/16" = 1'-0"



1 West Elevation
Scale: 3/16" = 1'-0"

project name: 9 unit Multi-family Rezoning & Development Permit Application				project no. 2340
600 Dallas Road, Victoria, B.C.				
drawing title: West & North Elevations	drawn by: rjpn	scale: As Noted	date: 24/12/02 yy/mm/dd	drawing no. SK-4.1




MATERIAL LEGEND	
1	Vert. Metal Siding Finish
2	Hardie Panels (Ptd. White) w/ 3/8" Reveal Panel Gaps
3	Horizontal Cedar Cladding
4	Pre-fin. Metal Flashing
5	Boardformed (Vert.) Concrete
6	Thermally Broken Dbl. Glazed Vinyl Windows (Blk.)
7	Face-mounted Alum. Picket Guardrails (Blk.)
8	Hollow Metal Door in Pressed Steel Frame (Ptd.)



project name: 9 unit Multi-family Rezoning & Development Permit Application		project no. 2340	
600 Dallas Road, Victoria, B.C.			
drawing title: South & East Elevations	drawn by: mjm	scale: As Noted	date: 24/12/02 yy/mm/dd
	checked by: mjm		SK-4.2



2 N/S Section Looking East
Scale: 1:46

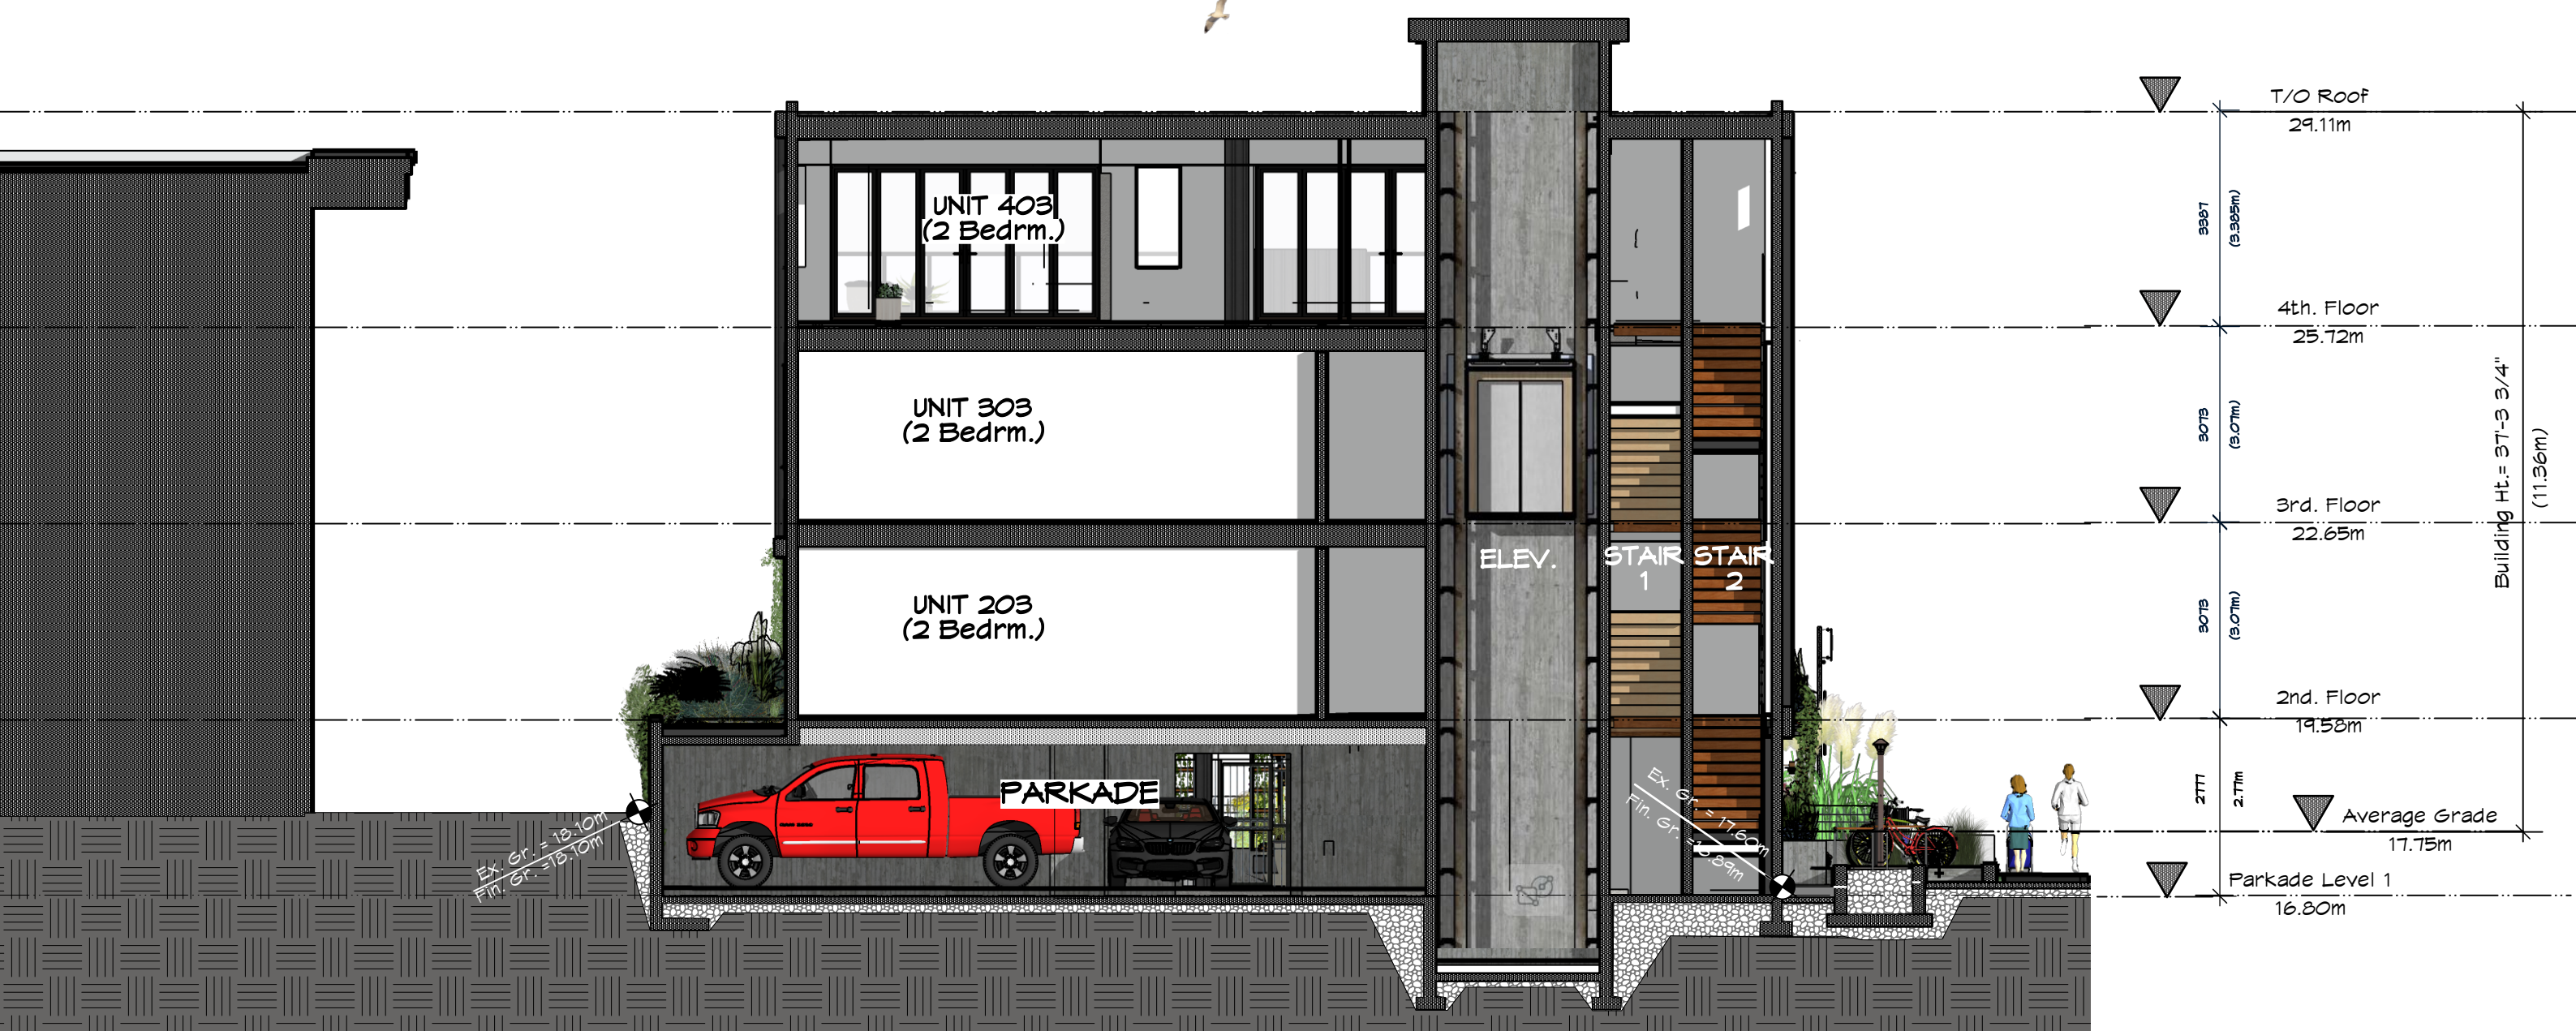

1 E/W Section Looking South
Scale: 1:46

project name: 9 unit Multi-family Rezoning & Development Permit Application				project no. 2340
600 Dallas Road, Victoria, B.C.				
drawing title: Sections	drawn by: mjm	scale: As Noted	date: 24/12/02 yy/mm/dd	drawing no. SK-5.1
	checked by: mjm			



		project name: 9 unit Multi-family Rezoning & Development Permit Application			project no. 2340
MJM Architect Inc.		600 Dallas Road, Victoria, B.C.			
		drawing title: Exterior Views	drawn by: mjm	scale: As Noted	date: 24/12/02 yy/mm/dd
			checked by: mjm		drawing no. SK-6.1
		#10, 909 Vancouver Street, Victoria, B.C. V8V 3V6 ph:(250)661-5492 e-mail: mjmood@shaw.ca			



Planter Boxes

Exit Door

Planter Boxes

Auminum Entry Doors
With "600 DALLAS ROAD"
Signage Above

Handicapped Ramp
& Planter Box



Communal
Amenity
Space

Short Term
Bicycle
Parking

Ground Floor
One Bedroom Suite

Sunken Patio


MJM Architect Inc.	project name: 9 unit Multi-family Rezoning & Development Permit Application			project no. 2340
	600 Dallas Road, Victoria, B.C.			
	drawing title: Exterior Views	drawn by: mjm	scale: As Noted	date: 24/12/02 yy/mm/dd
		checked by: mjm		SK-6.2




2 Streetscape Looking North From Dallas Road
Scale: 3/32" = 1'-0"



1 Streetscape Looking East on Government Street
Scale: 3/32" = 1'-0"

	project name: 9 unit Multi-family Rezoning & Development Permit Application		project no. 2340	
	600 Dallas Road, Victoria, B.C.			
#10, 909 Vancouver Street, Victoria, B.C. V8V 3V9 ph:(250)661-5492 e-mail: mjmood@shaw.ca	drawing title: Streetscapes	drawn by: mjm checked by: mjm	scale: As Noted	date: 24/12/02 yy/mm/dd
			drawing no. SK-6.3	

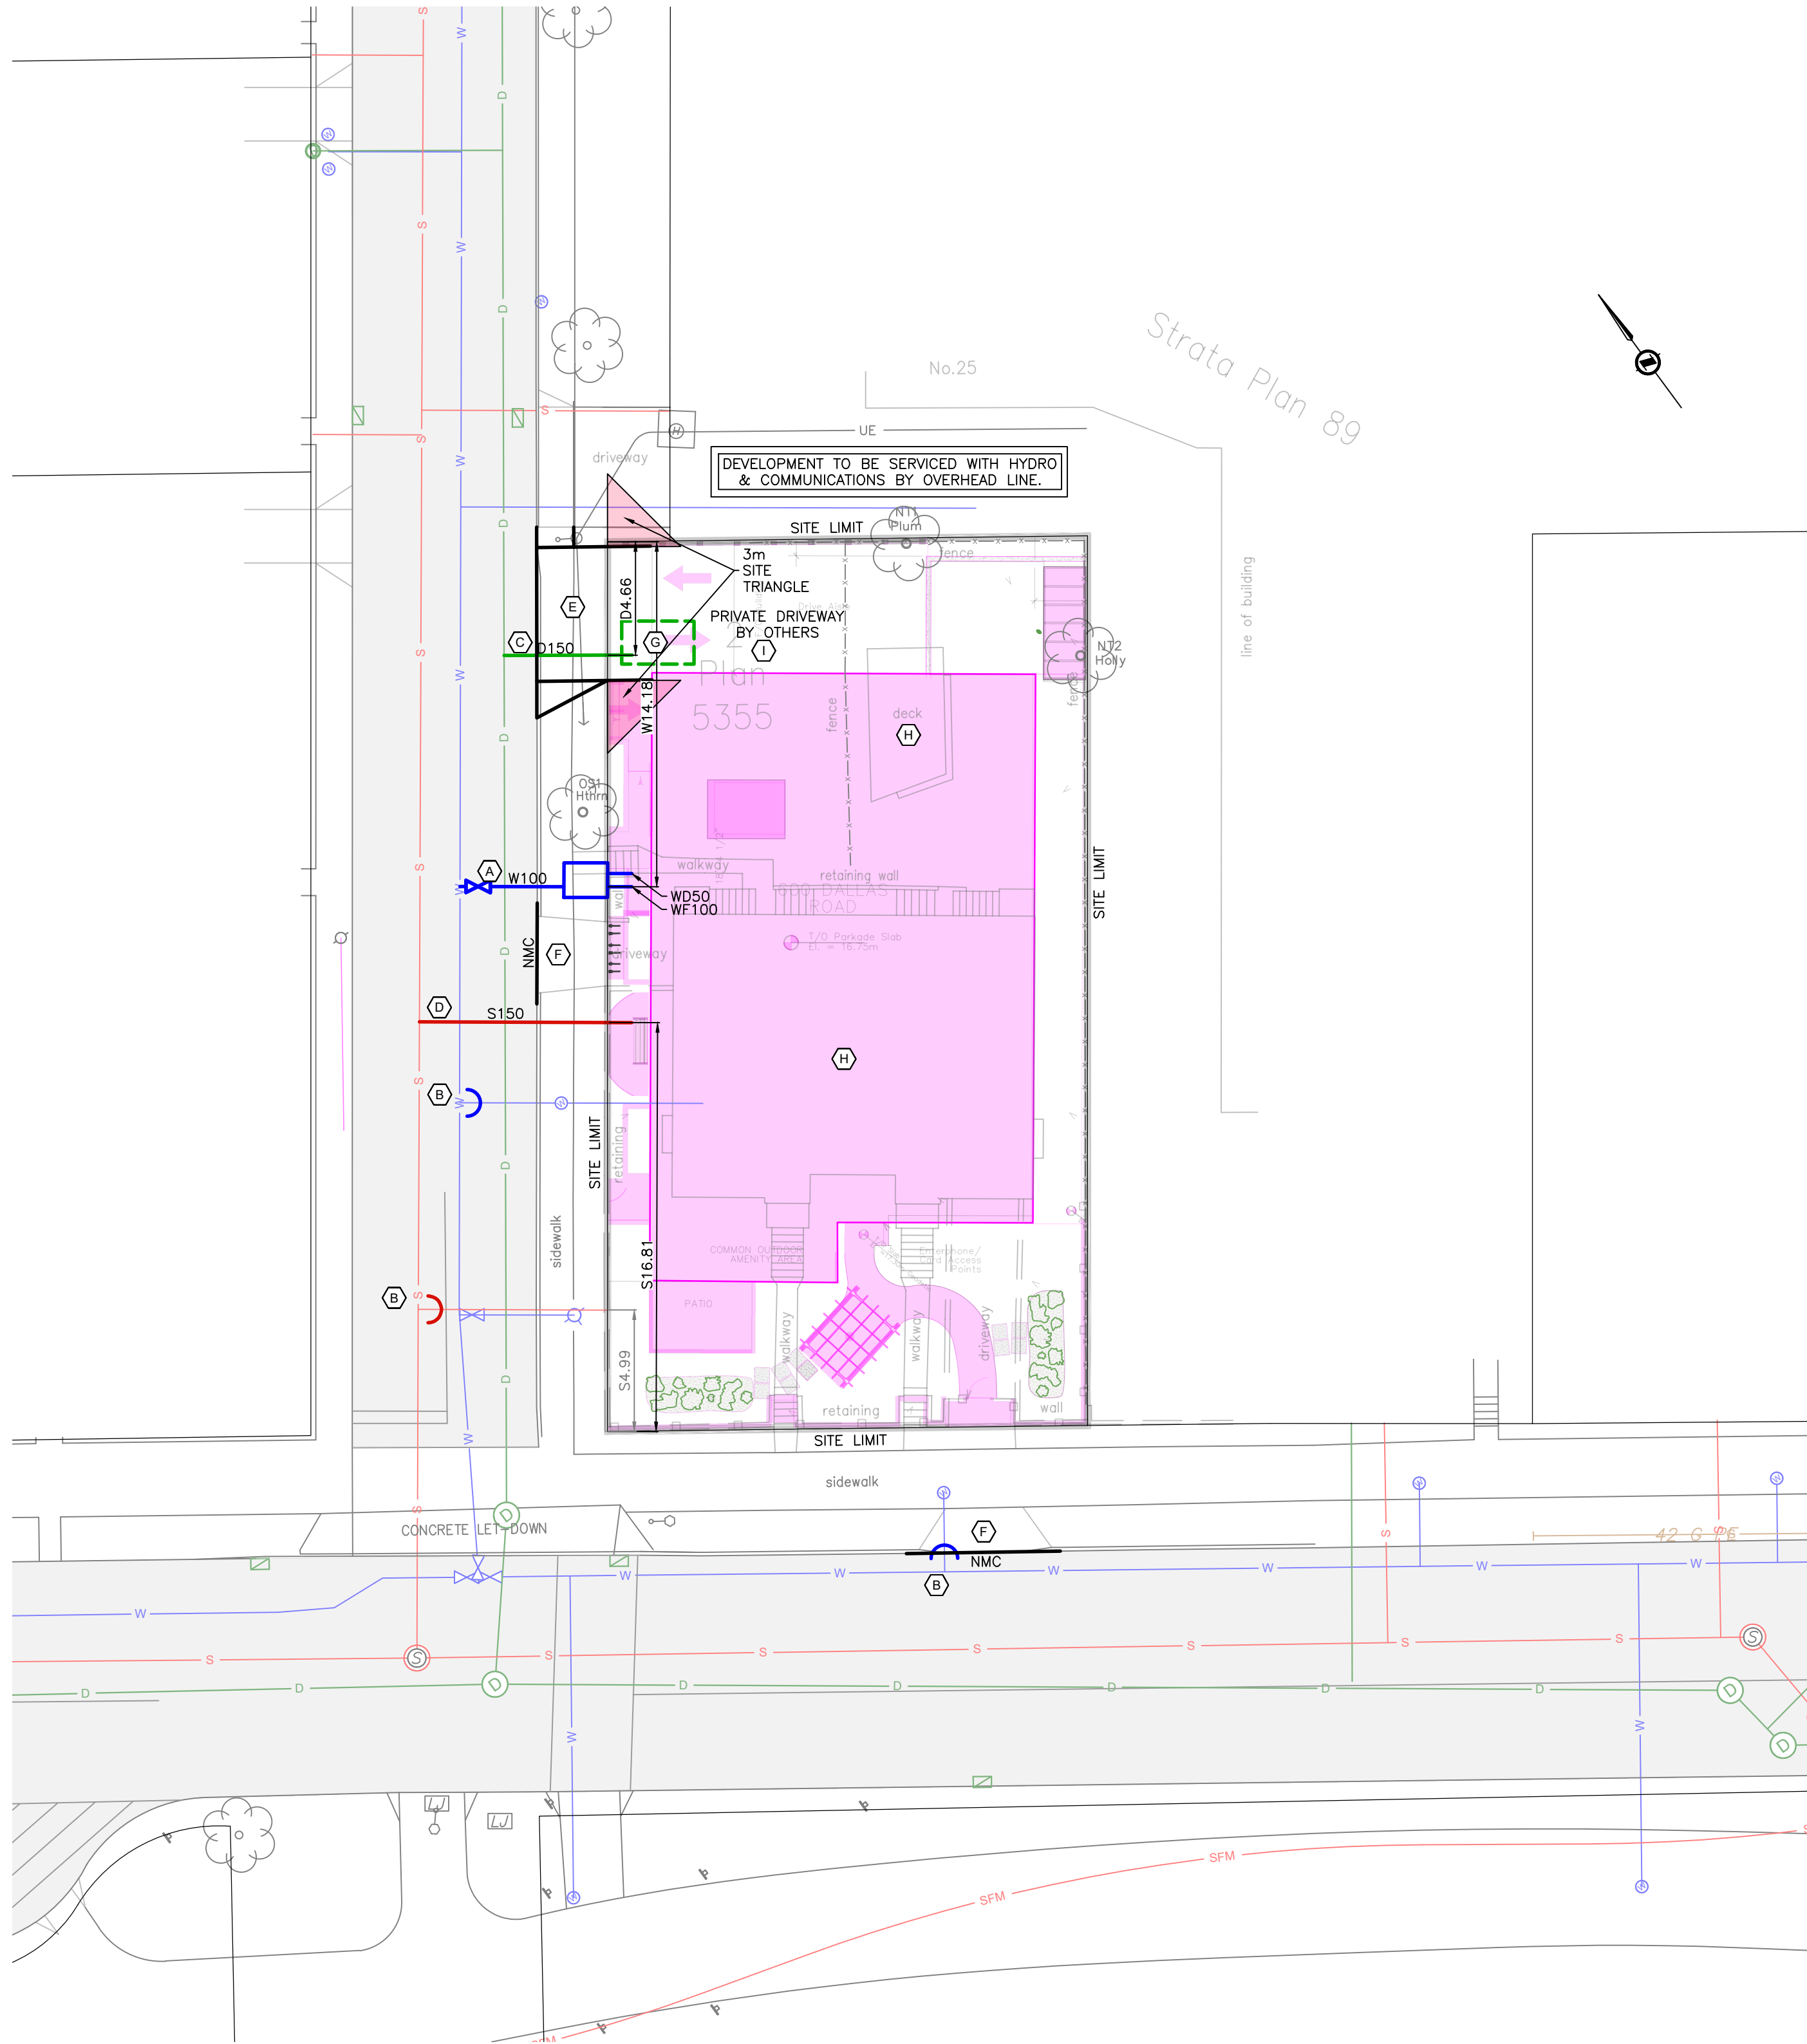

SITE SERVICING PLAN
H 1:200

PRELIMINARY SERVICING NOTES:

- (A) NEW 100mm FIRE WATER SERVICE AND 50mm DOMESTIC WATER SERVICE C/W METER AT DEVELOPERS EXPENSE. DETAILS TO BE CONFIRMED AT BUILDING PERMIT.
- (B) SERVICES TO BE CAPPED AT DEVELOPERS EXPENSE.
- (C) CITY OF VICTORIA TO INSTALL NEW 150mm DRAIN SERVICE COMPLETE WITH IC AT DEVELOPERS EXPENSE.
- (D) CITY OF VICTORIA TO INSTALL NEW 150mm SEWER SERVICE COMPLETE WITH IC AT DEVELOPERS EXPENSE.
- (E) CONTRACTOR TO INSTALL NEW 5.5m WIDE CONCRETE DRIVEWAY APRON AS PER CITY OF VICTORIA SD C7a.
- (F) CONTRACTOR TO REMOVE EXISTING DRIVEWAYS, REINSTATE BOULEVARD AND INSTALL NEW NON-MOUNTABLE CURB. DETAILS TO BE CONFIRMED AT BUILDING PERMIT.
- (G) ONSITE STORMWATER MANAGEMENT AREA COMPLETE WITH UNDERGROUND STORAGE / INFILTRATORS AND SEDIMENT SUMP WITH FLOW CONTROL AS PER CoV RAINWATER MANAGEMENT STANDARDS - PROFESSIONAL EDITION. DETAILS TO BE CONFIRMED AT BUILDING PERMIT.
- (H) EXISTING STRUCTURES TO BE REMOVED. OWNER TO APPLY FOR SEPARATE DEMO PERMIT.
- (I) ONSITE GRADING FOR 6m AS PER CoV HIGHWAY ACCESS BYLAW.

CLIMATE FORWARD FEATURES:

NOTE: PRIVATE ON-SITE STORMWATER MANAGEMENT WILL USE BMP's AND MAY INCLUDE:

- MIX OF PERMEABLE AND UNIT PAVERS
- BIOSWALE OR RAIN GARDEN INLETS WHERE POSSIBLE.
- INFILTRATION,
- SEDIMENT SUMPS, AND
- FLOW CONTROLS

PRELIMINARY STORMWATER MANAGEMENT NOTES:

DETAILED STORMWATER MANAGEMENT DESIGN AND CALCULATIONS TO BE CONFIRMED AT BUILDING PERMIT.


PRELIMINARY STORAGE CALCULATIONS: 200m³ per HECTARE. = 0.07HA = 14m³.

STORAGE TO BE PROVIDED UNDERGROUND. LOCATIONS AND TYPE TO BE CONFIRMED AT BUILDING PERMIT.

RUN-OFF TREATMENT BY TREATMENT TRAIN APPROACH WITH SEDIMENT SUMPS AND FLOW CONTROL MANHOLE. DETAILS AND RELEASE RATE TO BE CONFIRMED AT BUILDING PERMIT.

ALL PERIMETER DRAINS TO BYPASS FLOW CONTROL DEVICES.

ALL ROOF LEADERS AND HARD SURFACE RUN-OFF TO BE DIRECTED TO ONSITE STORMWATER MANAGEMENT AREAS OR LANDSCAPED AREAS FOR TREATMENT.

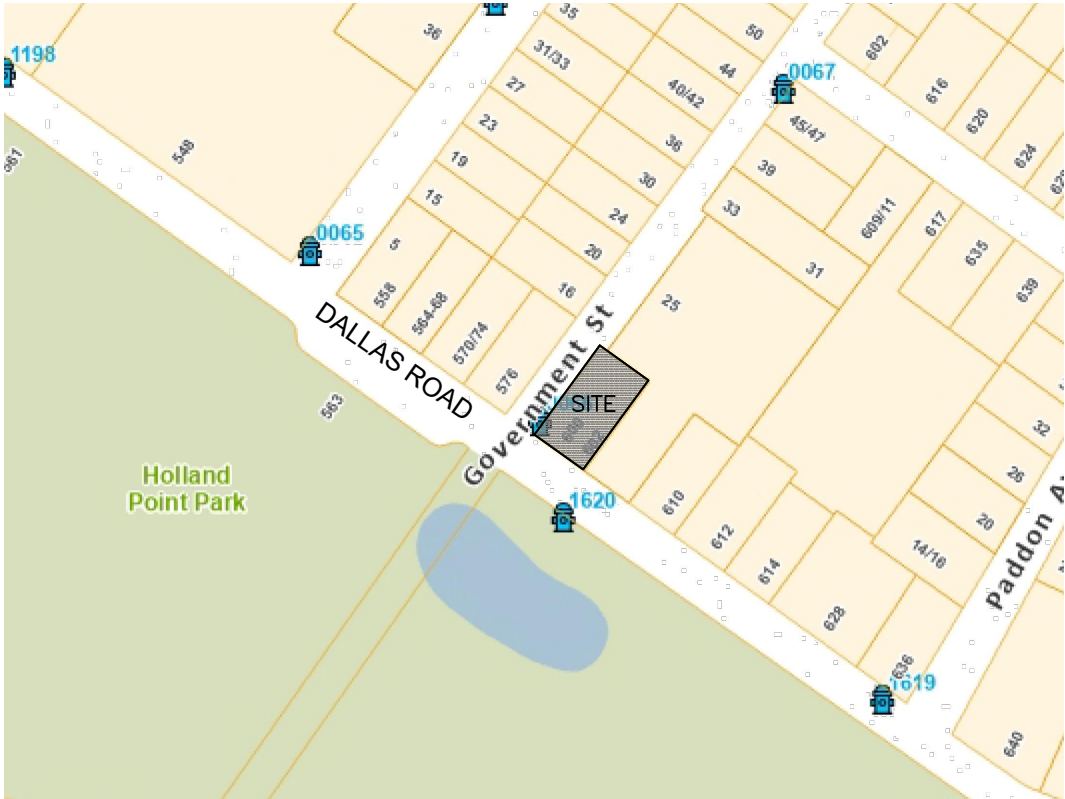

KEY PLAN
1:2500

LEGAL DESCRIPTION: LOT 2, SECTION 5, BECKLEY FARM, VICTORIA CITY, PLAN 5355

BENCHMARK: MONUMENT _____ ELEV. _____

600 DALLAS
PRELIMINARY
SITE SERVICING

Scale 1:200 Scale
horiz. vert.
Sheet 1 of 1
Eng. Project No. 34922
Drafted by. KHG

J E A J E ANDERSON &
ASSOCIATES
SURVEYORS - ENGINEERS
VICTORIA NANAIMO PARKSVILLE CAMPBELL RIVER
PHONE: 250-727-2214 info@jeanderson.com

20241121

ISSUED FOR DEVELOPMENT PERMIT



RECOMMENDED PLANT LIST

BOTANICAL NAME	COMMON NAME	SIZE /REMARKS
TREES		
Fagus sylv. Dawyckii Gold	Columnar Gold Beech	5cm. cal. /B&B
Syrax japonica	Japanese Snowbell	3cm. cal. /B&B
SHRUBS & PERENNIALS		
Alchemilla mollis robusta	Lady's Mantle	#1 Pot
Buxus Microphylla Winter Gem	Littleleaf Boxwood	#5 Pot
Calamagrostis x acutiflora	Karl Foerster Grass	#1 Pot
Euonymus Alatus Compacta	Dwarf Burning Bush	#5 Pot
Euphorbia characias Wulfenii	Wolf's Euphorbia	#5 Pot
Hamamelis Int. Jellena	Orange Witch Hazel	1.5M. Ht.
Hakonechloa macra aureola	Hakone Grass	#1 Pot
Hosta Hadspen Blue	Hadspen Blue Hosta	#1 Pot
Lavandula Munstead	English Lavender	#1 Pot
Liriope Muscari	Big Blue Lily Turf	#1 Pot
Mahonia aquifolium *	Oregon Grape	#5 Pot
Ophiopogon planiscapus nigra	Black Mondo Grass	#1 Pot
Polystichum munitum*	Western Sword Fern	#3 Pot
Ribes Sang. King Edward*	Ornamental Currant	#5 Pot
Rosemary Officinalis	Rosemary	#3 Pot
Rudbeckia Fulgida	Orange Coneflower	#1 Pot
Spiraea japonica Goldflame	Goldflame Spirea	#3 Pot
VINES & GROUND COVER		
Arctostaphylos uva ursi *	Kinnikinnick	SP3
Gaultheria procumbens*	Wintergreen	SP3
Thymus pseudolanuginosus	Woody Thyme	SP3

LEGEND

HARDSCAPE FINISHES:

PP1	CIP natural finish concrete Driveway, Natural colour
PP2	Concrete unit paving, Origins by Belgard, all sizes, Tofino Gray colour
PP3	Concrete unit paving, Origins by Belgard, all sizes, Iron Bay colour
PP4	1/2" crushed gravel base
PP5	CIP concrete sidewalk, Natural

SOFTSCAPE:

	Lawn
	Planting area c/w groundcover planted
	Green roof planting area

MISCELLANEOUS:

	New concrete or mortared rock retaining/upstand walls; Heights vary.
	Exist concrete or mortared rock retaining/upstand walls; Heights vary.

NOTES:

- 1) All building layout information and setback dimensions supplied by MJM Architect Inc.
- 2) All survey information supplied by MJM Architect Inc.
- 3) This drawing must not be scaled. The General Contractor shall verify all dimensions, datums and levels prior to commencement of work.
- 4) All errors and omissions must be reported immediately to the Designer.
- 5) This drawing is the exclusive property of the Designer and can be reproduced only with the permission of the designer, in which case the reproduction must bear the designers name.

NOTES:

THIS PLAN IS NOT FOR CONSTRUCTION.

Plant material, installation and maintenance to conform to BCSLA/ BCLNA standard (current edition).
All growing medium to comply to BCSLA/ BCLNA standard designation "IP - Level-1 Well Groomed Areas". Greenroof soil depth to comply with required Greenroof soil requirements. Greenroof to include a temporary irrigation system approved by project Landscape Architect. Automatic underground irrigation system to be installed. Irrigation materials and installation to conform, as a minimum, to BCSLA/ BCLNA Standard (current edition) and IABC Standards. Irrigation to include a timer and rain sensor. Drip irrigation for groundcover and shrub beds, emitter loops for trees, and sprays for lawn areas. All irrigation piping under hardsurfaces to be sleeved. Boulevard lawn or plantings must be compliant with City of Victoria Specifications and Standards.


Fencing to be built as shown on plan; portions of fencing along sideyards may be built with trellis top as an option.
Proposed Street tree locations and species selection to be approved by City of Victoria Parks Dept. Street trees must have one dominant central leader or single straight trunk, 6-8cm diameter caliper measured 15cm above ground, and a well balanced crown with the branching starting at 1.8m -2.5m above ground. Trees must be planted per the City of Victoria Supplemental Drawing SD P4 (Tree Planting in Boulevard) or the Canadian Landscape Standard.

Required Parks inspections for street tree planting: 1. Inspection of soil and planting area prior to planting. 2. Inspection of tree stock prior to planting. 3. Inspection of installed tree. Trees must be in good health and condition with no signs of disease, insect pests, or damage, and comply with the latest version of the Canadian Landscape Standard.


All existing trees located on plan are approximate. Size and dripline of trees are not shown, and should be verified by a surveyor and /or arborist where necessary. Arborist to install tree protection fencing for boulevard trees where necessary. See also Davey Resource Group Arborist Report dated September 11, 2024. See also (specifically) Arborist Tree Management Plan (Appendix 4) and Replacement Tree Plan (Appendix 5) dated September 11, 2024.

Boulevard landscape to remain unchanged from existing. Driveway crossing to be removed and grassed boulevard to be reinstated to municipal standards and City of Victoria approval. The details for the seed and soil boulevard can be found in schedule B3.4. Ensure that adequate soil volumes for the proposed street trees are installed in the grass boulevards. Required inspections for seed and soil boulevard: 1. Inspection of excavation and scarified subgrade prior to backfill. 2. Inspection of installed, rolled and prepared growing medium prior to sodding. 3. Inspection when the installed turfgrass meets the conditions for total performance as required in the Current Edition of the Canadian Landscape Standard. A soil test for the growing media, for each landscape application on City Property must be submitted top City Parks for review at least one week prior to soil placement. Growing media must meet the standards for each specific landscape application as required in the current edition of the Canadian Landscape Standard.



The Victoria Subdivision and Development Servicing Bylaw No. 12-042 and the associated Schedules can be found on the City of Victoria webpage.

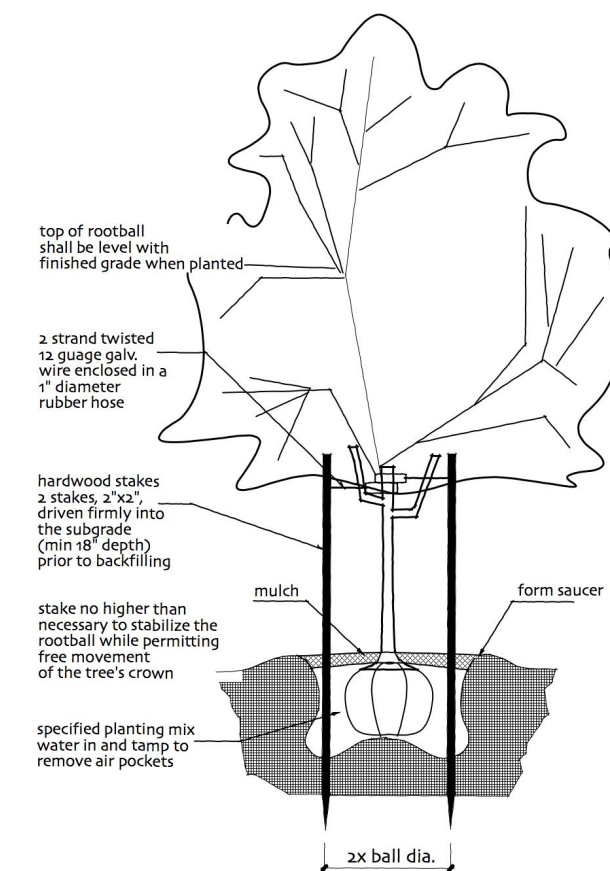

TREE PLANTING DETAIL
SCALE: NTS

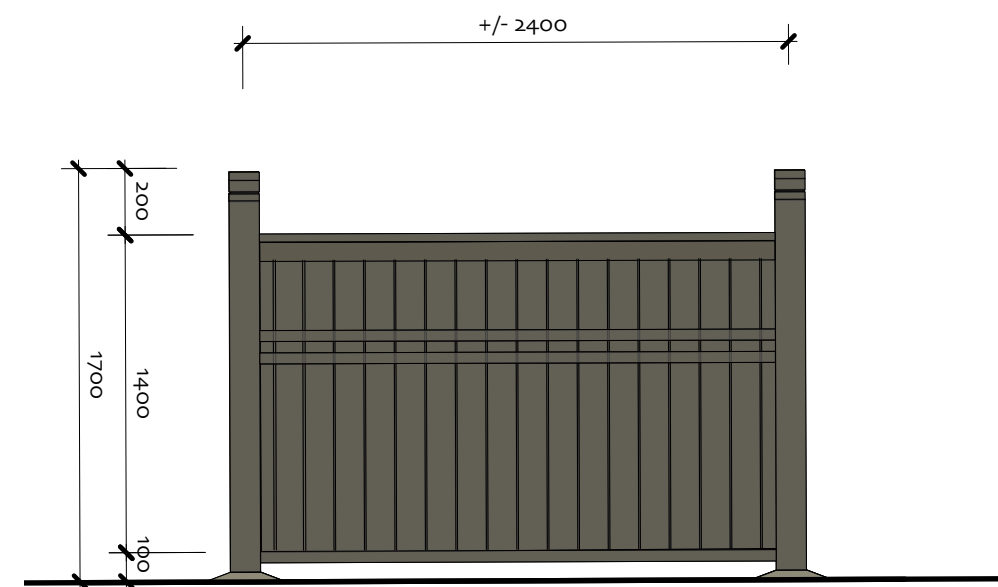

PERIMETER FENCING DETAIL
SCALE: NTS

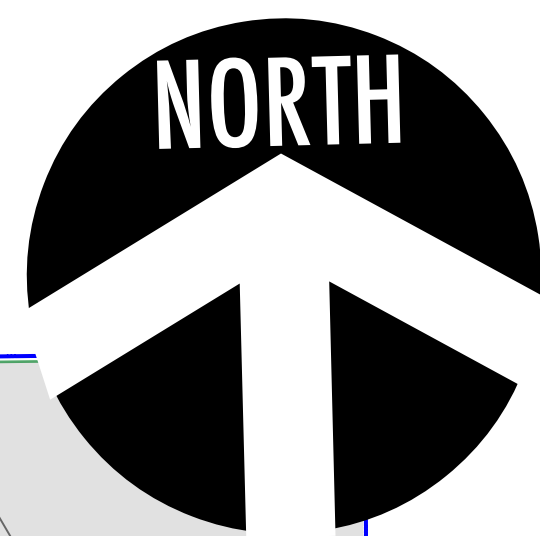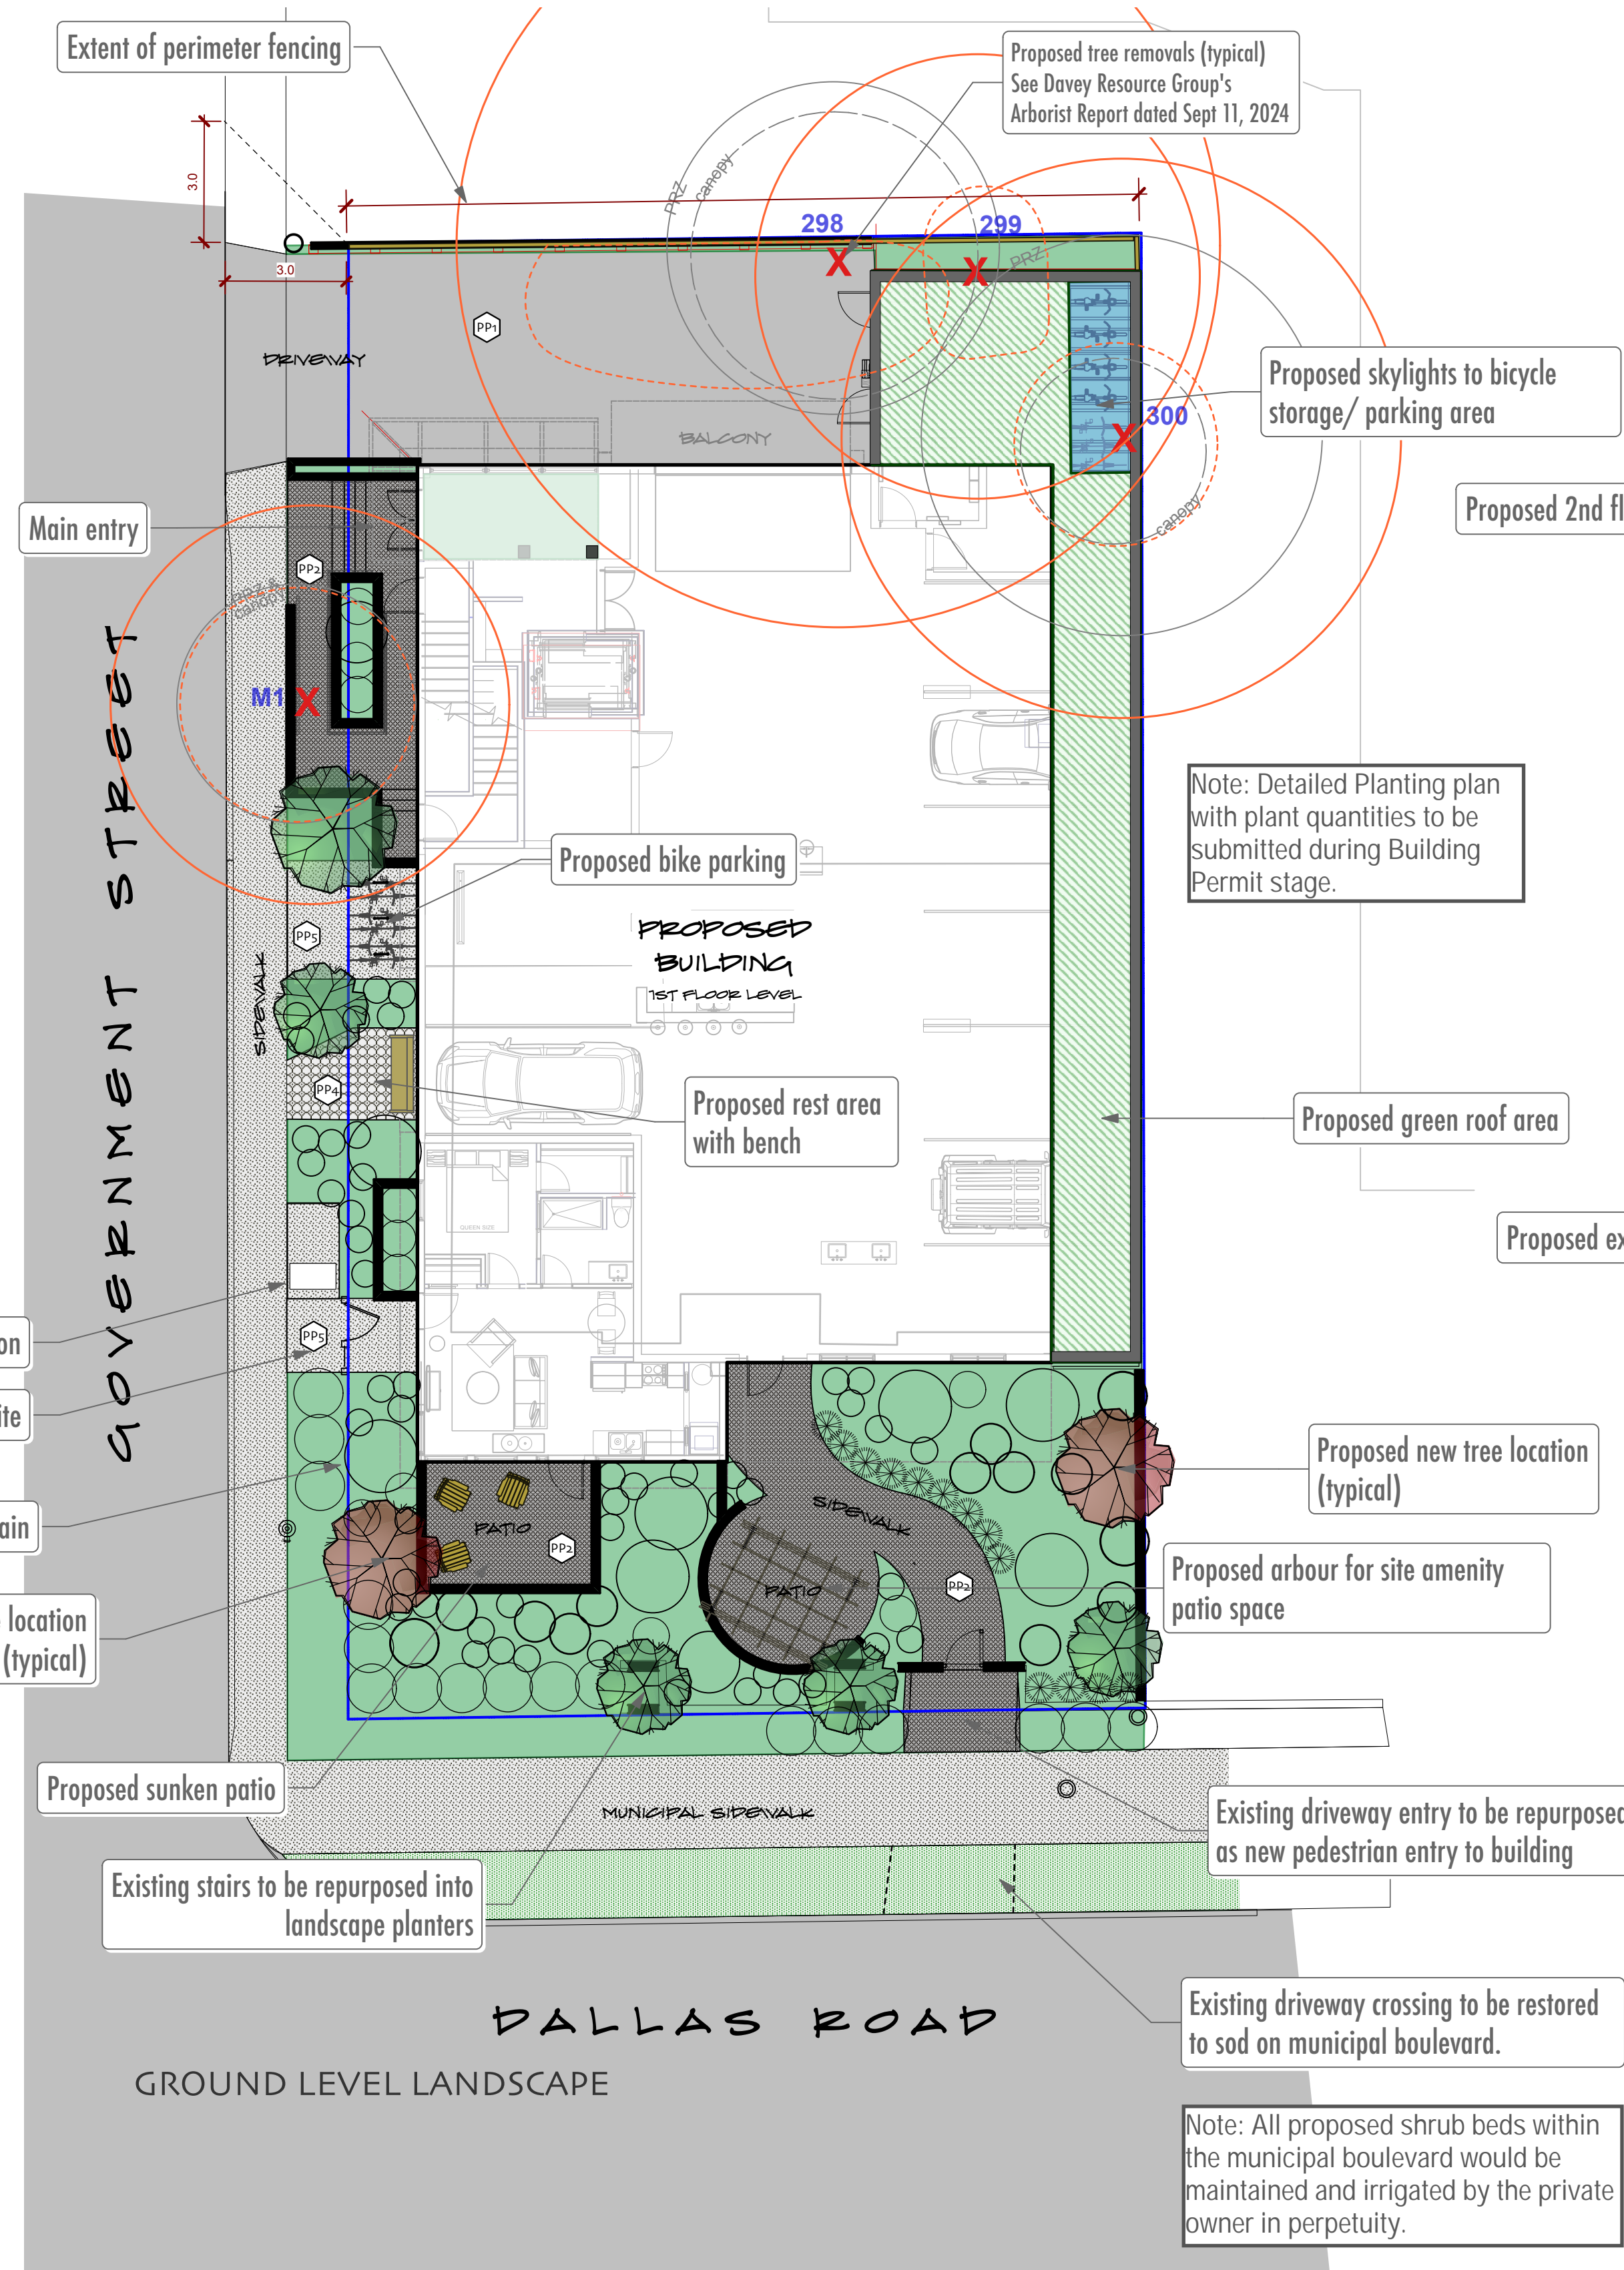

SKL.01

10.JULY.2024

1:125

LATEST REVISION: 25.NOVEMBER.2024

**NOT FOR CONSTRUCTION.
FOR DEVELOPMENT PERMIT ONLY.**

600 DALLAS ROAD LANDSCAPE LAYOUT

STUDIO ONE CREATIVE
250.881.0706 - 4539 Viewmont Avenue, Victoria, BC

CALID SERVICES LTD
250.388.6919 - 2750 Quadra St, Victoria, BC

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RESIDENTIAL DEVELOPMENT :: 600 DALLAS ROAD :: SKL.01 :: landscape layout ::