


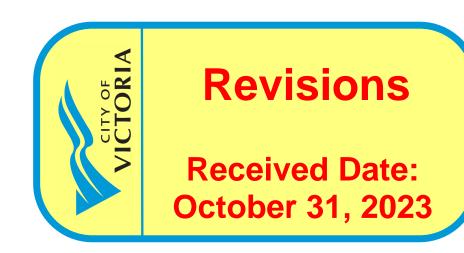

Urban Design Architecture Interior Design

REISSUED FOR DEVELOPMENT PERMIT APRIL 11, 2022





architectural

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Building Sections

257 BELLEVILLE STREET

VICTORIA, BRITISH COLUMBIA

Prepared for the City of Victoria on behalf of ADZ Properties Ltd.

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Project No. 20.118 set no.

$\overline{}$	PENETRATION OF FIRE SEPARATIONS	CORRIDOR SEPARATION - PUBLIC
	3.1.9.4 Combustible Piping Penetrations	3.3.1.4 Public Corridor Separations
	3.1.9.5 Openings Through a Membrane Ceiling REPAIR GARAGES	CORRIDOR SEPARATION - ASSEMBLY OCCUPAN
	3.3.5.5 N/A	3.3.2.6 Corridors
	ROOM WITH FUEL FIRE APPLIANCES	SUITE EGRESS
	3.6.2.1 Fire Separations Around Service Rooms 3.6.2.2 Service Rooms Under Exits	3.3.1.5 Egress Doorways
	3.6.2.3 Service Rooms 3.6.2.6 Door Swing for Service Rooms	JANITORS ROOM RATING 3.3.1.21 Fire Rating of 1 Hour
WN	SERVICE EQUIPMENT THROUGH FIRE SEPARATION	STORAGE ROOM RATING
VVIN	3.1.9.1 Fire Stopping of Service Penetrations	3.3.4.3 Fire Rating of 1 Hour
0%	SERVICE ROOMS	REPAIR GARAGE SEPARATION
201	3.6.2.1 Fire Separations Around Service Rooms 3.6.2.2 Service Rooms under Exits	3.3.5.5 Fire Rating of 2 Hours
9%	SUITE TO SUITE SEPARATION	STORAGE GARAGE SEPARATION
%	3.3.1.1 Separation of Suites	3.3.5.6 Fire Rating of 1.5 Hours
	SEPARATION BETWEEN MAJOR OCCUPANCIES	EGRESS AND EXIT REQUIREMENTS 3.3.3.4
1%	3.1.3.1 Separation of Major Occupancies	ACCESS TO EXIT DIMENSIONS (WIDTH)
	STORAGE ROOMS	3.3.1.9 1100mm Minimum Width
3%	3.3.4.3 Storage Rooms 3.6.2.5 Combustible Refuse Storage	ACCESS TO EXIT DIMENSIONS (CLEARANCE) 3.3.1.8 (see 3.4.3.4) 2100mm Minimum Clearai
10/	STORAGE GARAGES	CORRIDORS
1%	3.3.5.6 Storage Garage Separation	Corridor and Aisle Widths
0 %	VERTICAL SERVICE SPACES 3.3.5.6 Storage Garage Separation	3.3.1.9 1100mm minimum width 3.3.2.5 Aisle Seating (N/A)
	VERTICAL SERVICE SPACES	3.3.3.3 Minimum of 1100mm wide CORRIDOR OBSTRUCTIONS IN ACCESS TO EXIT
3%	3.1.8.3 Continuity of Fire Separations	3.3.1.9 (3) to 3.3.1.9 (6) Projections limited to 1
	3.1.9.1 Fire Stopping of Service Penetrations3.5.3 Fire Separations3.6.3.1 Fire Separations for Vertical Service Spaces	corridor 3.3.1.23 Obstructions
00%	3.6.3.3 Linen and Refuse Chutes	CORRIDOR OBSTRUCTIONS IN EXITS
	CLOSURES IN FIRE SEPARATIONS 3.1.8	3.4.3.3 Exit Width Reduction
00%	DAMPERS 3.1.8,7,8,9 Fire Dampers, Fire Dampers Waived, Installation	CROSS-OVER FLOORS
0%	of Fire Dampers	3.4.6.17 Emergency Access to Floor Areas
	DOORS	DOORS DOOR RELEASE HARDWARE
%	3.1.8.4 Determination of Ratings 3.1.8.5 Installation of Closures	3.3.1.13 Doors and Door Hardware
	3.1.8.10 Twenty Minute Closures 3.1.8.11 Self-Closing Devices	3.3.2.7 Doors 3.4.6.15 Door Release Hardware
	DOOR LATCHES	DOOR - SLIDING
一	3.1.8.13 Door Latches	3.3.1.12 Sliding Doors 3.4.6.13 Sliding Doors
WN	HOLD OPEN DEVICES	INTERCONNECTED FLOOR SPACE (3.2.8)
7%	3.1.8.12 Hold-Open Devices MAXIMUM OPENINGS PERMITTED IN FIRE SEPARATIONS	EXCEPTIONS TO SPECIAL PROTECTION
	3.1.8.6 Maximum Openings	3.2.8.2 Exceptions to special protection CONSTRUCTION REQUIREMENTS
9%	SELF CLOSING DEVICES	2.2.8.3 Construction Requirements
	3.1.8.11 Self Closing Devices	SPRINKLERS
2%	WIRED GLASS AND GLASS BLOCK	2.2.8.4 Building containing interconnected floo
	3.1.8.5 Installation of Closures 3.1.8.14 Wired Glass and Glass Block	shall be sprinklered throughout
3%	MAXIMUM AREA OF GLASS IN EXITS AND FIREWALLS	VESTIBULES 3.2.8.5 Vestibules
_	3.1.8.15-16 Temperature Rise Limits, Area Limits for Wired Glass and Glass Block	DRAFT STOPS
		3.2.8.7 Draft Stops
\dashv	SIZE AND OCCUPANCY REQUIREMENTS FOR FIRE SAFETY 3.2	DOOR SWING
_	BASEMENT FLOOR AND LOAD BEARING RATING	3.3.1.11 Door Swing
-	3.2.1.4 Floor Assembly Over Basement	3.4.5.11 Direction of Door Swing
	BUILDING HEIGHT (NUMBER OF STORETS) FIRST STOREY DEFINITION - MAX 2.0m ABOVE GROUND	DOOR WIDTH
4	3.2.1.1 8 Storeys	3.3.3.4 Doorway Width 3.4.3 Width and Lenght of Exits 3.4.6.10 Doors
	NUMBER OF STREETS BUILDING IS FACING WITHIN 15.0m (3.2.2.10)	ELECTROMAGNETIC LOCKS
	3.2.2.10 Fire Lanes Requirements	3.4.6.15 (4) Door Release Hardware - Electroma
	BUILDING CLASSIFICATION (BUILDING SIZE AND CONSTRUCTION RELATIVE TO OCCUPANCY 3.2.2.2083)	TRANSPARENT DOORS AND PANELS
	Classification Article - C Residential	3.3.1.19 Transparent Doors and Panels
d	Construction Type - Non-Combustible Sprinklered - Yes	3.4.1.8 Transparent Doors and Panels
	RATINGS Floors	WIRED GLASS IN DOORS
	Roofs Load Bearing	3.1.8.15 / 16 Temperature Rise Limit for Door / . for Wired Glass & Blocks 3.1.8.17 Temperature Rise and Area Limits Waiv
	SPRINKLER REQUIREMENTS	EMERGENCY LIGHTING AND POWER
	3.2.5.13 Automatic Sprinkler Systems	3.2.7.3 Emergency Lighting
ies	FIRE ALARM REQUIREMENTS	3.2.7.4 Emergency Power for Lighting EXIT DIMENSIONS (WIDTH)
nts sed	3.2.4.1 Determination of Requirement for a Fire Alarm System	3.4.3.2 Exit Width
	CACETY DECLIDENTENTS WITHIN STOOM ASSACES	EXIT DIMENSIONS (HEADROOM CLEARANCE)
	SAFETY REQUIREMENTS WITHIN FLOOR AREAS 3.3 SEPARATION OF SUITES	3.4.3.4 Headroom Clearance
	3.3.1.1 Separation of Suites	LOCATION OF EXITS FROM FLOOR AREAS
	3.3.2 Assembly Occupancy 3.3.3 Care or Detention Occupancy	3.4.2.3 Distance between Exits 3.4.2.5 Location of Exits
	3.3.4 Residential Occupancy	· · · · · · · · · · · · · · · · · · ·

3.3.4 Residential Occupancy 3.3.5 Industrial Occupancy


	EXIT CAPACITY	PUBLI
	3.4.3.2 Exit Width	3.8.3.
PANCY	EXIT THROUGH LOBBY	RAMP
	3.4.4.2 Exits Through Lobbies	3.8.3.
	EXIT SIGNAGE	SIGNS
	3.4.5 Exit Signs	3.8.3.
	GUARDS	SPACI
	3.3.2.9 Guards 3.3.1.1.8 Guards 3.4.6.5 Guards	3.8.3. TELEP
	HANDRAILS	3.8.3.
	3.4.6.4 Handrails	3.8.3.
	LIGHTING	WASH
	3.2.7.1 Minimum Lighting Requirements	3.8.2.
	OBSTRUCTIONS TO EGRESS	STALL
	3.3.1.23 Obstructions	3.8.3. 3.8.3.
	3.4.3.3 Exit Width Reduction OCCUPANT LOAD	URINA
	3.1.17 Occupant Load (3.1.17.1) 2 persons per sleeping	3.8.3.
r	room in a dwelling unit	LAVA
arance	RAMPS	3.8.3.
	3.3.1.14 Ramps and Stairways 3.4.1.4 Public Corridor Separations	UNIVE
	3.4.6.7 Treads, Risers and Tactile Warning	3.8.3.
	FIXED SEATS, ASSEMBLY OCCUPANCY	PLENU
XITS	3.3.2.4 Fixed Seats 3.3.2.8 Fixed Bench Type Seats Without Arms	3.1.9. 3.6.4.
o 100mm into	STAIR LANDINGS AND STAIR FLIGHTS	
	3.4.6.3 Landings and Maximum Vertical Rise of Stair Flights	FIRE A
	STAIR TREADS AND RISERS	DETE
	3.3.1.14 Ramps and Stairways 3.3.1.16 Curved or Spiral Stairs	3.2.4. Syster
	3.3.2.14 Risers for Stairs 3.4.6.7 Treads, Risers and Tactile Warning	Full Fi
	STAIR WIDTH	REQU
	3.4.3.1 Exit Width Based on Occupant Load	3.2.4.
	TRAVEL DISTANCE TO:	Smok /.15-1
	3.3.1.5 Egress Doorways (Table 3.3.1.5.B)	Alarm /.19-2 Comr
	3.3.1.6 Egress Travel Distance (refer to 3.4.2.5 for distances)3.4.2.3 Distance between Exits3.4.2.5 Location of Exits	HOSE
	3.4.2.3 LOCATION OF EXILS	3.2.5.
	INTERIOR FINISH	HOSE
	ATTACHMENT TO WALLS AND PARTITIONS	3.2.5.
	3.1.5.6 Nailing Elements	STAN
	ELECTRICAL AND COMMUNICATIONS CABLE RATINGS	3.2.5.
	3.6.1.1 Scope LIMITS IN LOBBIES USED AS EXITS	PORT
	3.4.4.2 Exits Through Lobbies	3.2.5. Locati
		HEAL
oor space	LIMITS IN LOBBIES USED AS EXITS 3.4.4.2 Exits Through Lobbies	3.7.2.
	INTERIOR FINISH, FLAME SPREAD	3.7.2.
	3.1.5.10 Combustible Interior Finishes	
	3.1.12 Flame Spread Rating and Smoke Developed Classification	
	3.1.13 Interior Finish	EXTER
	PLASTIC PIPE AND DUCTS	
	3.1.9.4 Combustible Piping Penetrations	<u> </u>
	BARRIER FREE DESIGN FOR PERSONS WITH DISABILITIES	
	ACCESS ROUTES WITHIN BUILDING	
	3.8.1.3 Access Routes	
	PARKING AREAS	ĺ
magnetic	3.8.3.4 Parking Stalls for Persons with Disabilities	
	AREAS REQUIRING BARRIER FREE PATH OF TRAVEL 3.8.2.1 Application and Exemptions	E1)
	3.8.2.3 Specific Requirements 3.8.2.27 Apartment Buildings and Condominiums	
	ASSISTIVE LIVING DEVICES	
	3.8.3.7 Assistive Living Devices	
r / Area Limits	BUILDING ENTRANCES	WIND
aived	3.8.3.5 Main Entrances	
	CONTROLS	(E2)
	3.8.3.21 Controls	
	DOORS AND DOORWAYS	<u> </u>
	3.8.3.5 Main Entrances 3.8.3.13 Door Numbers	
E)	DRINKING FOUNTAINS	
1		•


3.8.3.17 Drinking Fountains

3.8.3.2 Parking and Driveways

EXTERIOR WALKS, PARKING AND DRIVEWAYS

	DRAWING REI	ERENCE SYMBOLS:
3.8.3.14 Public Counters	1- A0.0	——— DETAIL NUMBER ——— SHEET NUMBER WHERE LOCATED
RAMPS	$\stackrel{\smile}{\Leftrightarrow}$	
SIGNS	A0.0	——— ELEVATION NUMBER ——— SHEET NUMBER WHERE LOCATED
3.8.3.12 Directional Signs	1-	SECTION NUMBER
PACES IN SEATING AREAS	A0.0	SHEET NUMBER WHERE LOCATED
8.3.6 Seating Areas	1-	——— ELEVATION NUMBER ——— INTERIOR ELEVATION NUMBER
ELEPHONE SHELVES AND COUNTERS	A0.0	SHEET NUMBER WHERE LOCATED
8.3.18 Counters	1	INTERIOR ELEVATION NUMBER
3.3.16 Pubic Telephones ASHROOMS	4 A0.0 2	ELEVATION NUMBER SHEET NUMBER WHERE LOCATED
3.2.3 Location and Washrooms	3 7 7 7 7 7 7 7 7 7 7	DRAWING NUMBER
ALLS AND WATER CLOSETS	A0.0 SCALE	DRAWING TITLE DRAWING SCALE
3.3.8	7.0.0	SHEET NUMBER WHERE LOCATED
.8.3.9	12 TITLE	DRAWING NUMBER DRAWING TITLE
JRINALS	A0.0 A0.0 SCALE	DRAWING SCALE SHEET NUMBER WHERE LOCATED
AVATORIES	\	SHEET NUMBER REFERENCED FROM
NVATORIES 8.3.11	TITLE - HEIGHT -	
NIVERSAL TOILET ROOMS		A GIVEN ELEVATION
.8.3.12	% OR DIST -	SLOPE DIRECTION SLOPE INCRIMENT
	C1 000 AFE	CEILING TYPE HEIGHT ABOVE FINISHED FLOOR
ENUM SPACES	000 A>	SUB KEYNOTE REFERNECE
.1.9.6 Plenums .6.4.3 Plenum Requirements		KEYNOTE REFERENCE NUMBER
IRE ALARM SYSTEMS	SYMBOL LEGEN	ND
ETERMINE THE NEED	P1 INTERIOR WALL A	SSEMBLY DOOOD DOOR TYPE
2.4.1 Determination of Requirement for a Fire Alarm stem	E1 EXTERIOR WALL A	NAME SSEMBLY 0000 ROOM NAME
ll Fire Alarm System Required & Supplied	R1 ROOF ASSEMBLY	
QUIREMENT FOR DEVICES	F1 FLOOR ASSEMBLY	0000 AFF CEILING HEIGHT
2.4.10-12 Fire Detectors, Smoke Detectors, Prevention of noke Circulation 5-17 System Monitoring, Manual Stations, Alert and	W1 WINDOW TYPE	SPOT ELEVATION
arm Signals 9-21 Visual Signals, Smoke Alarms, Voice		EXIST'G ELEVATION
ommunications Systems		———— SMOKE SEPARATION
OSE CABINET DESIGN 2.5.10/. 11 Hass Connections Hass Stations		45 MINUTE FIRE RATING 1 HOUR FIRE RATING
2.5.10/ .11 Hose Connections, Hose Stations OSE CABINET LOCATION		2 HOUR FIRE RATING
2.5.11 Hose Stations		• • • • • 1.5 HOUR FIRE RATING
TANDPIPE SYSTEM DESIGN	DIMENSION	OTEC.
.2.5.8 Standpipe System Design	• ALL WALL DIMENSIONS	OTES: S ARE TO FACE OF CONCRETE OR FACE OF
	STUD UNLESS OTHERW • CLEAR DIMENSIONS AF	
ORTABLE FIRE EXTINGUSHERS	SURFACE.	
ORTABLE FIRE EXTINGUSHERS 3.2.5.17 Portable Fire Extingushers. For Types Required and ocations see BC Fire Code	IN WALL BETWEEN ADJOINING WALL AS SI	H OPENINGS ARE EITHER TO BE CENTRED DINING WALLS OR 150mm FROM AN HOWN ON FLOOR PLANS UNLESS NOTED
.2.5.17 Portable Fire Extingushers. For Types Required and	IN WALL BETWEEN ADJ	OINING WALLS OR 150mm FROM AN

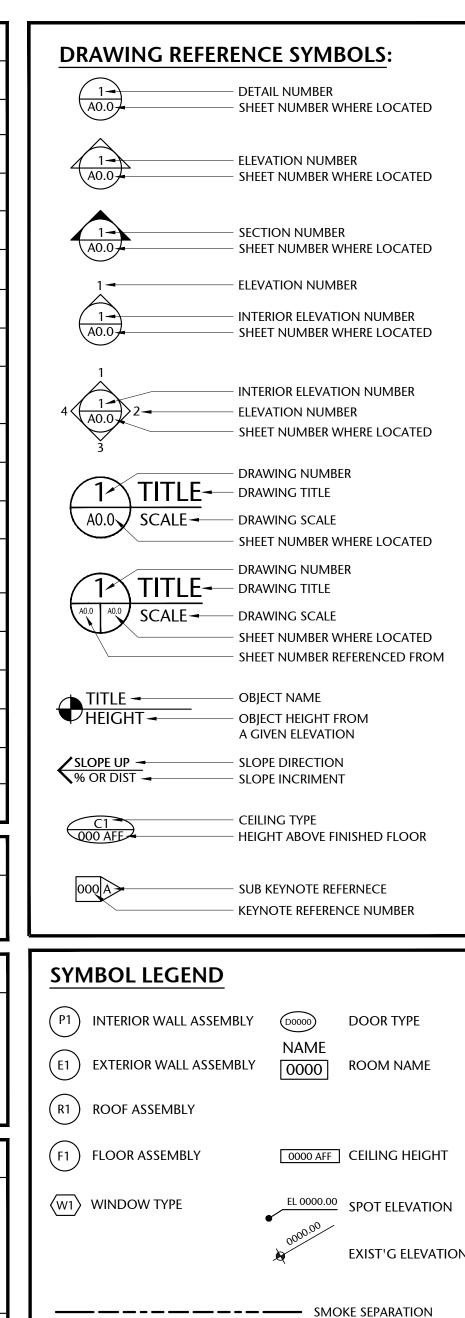

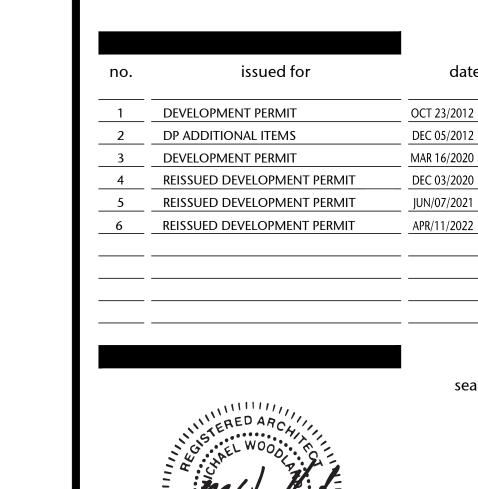

257 BELLEVILLE

VICTORIA, BRITISH COLUMBIA

STREET

THE USE OF HIGHLY CONDUCTIVE METAL FRAMING IS OFFSET THROUGH THE USE OF A CONTINUOUS LAYER OF RIGID INSULATION OVER THE MAIN MEMBERS. FOUNDATION WALLS INCLUDE THE CONTINUATION OF RIGID INSULATION FROM THE ASSEMBLY ABOVE TO 1220MM (4 FEET) BELOW GRADE.

FOUNDATION WALL BELOW GRADE:

- DRAINAGE LAYER
- BENTONITE LAYER (IF REQUIRED) FOUNDATION WATERPROOFING

CONCRETE FOUNDATION WALL

CLEAR ANODIZED ALUMINUM WINDOW-WALL SYSTEM. THE INTERIOR FRAMES MAY BE WOOD CLAD WITH MILLED WOOD SILLS. THE FLANGE SIDE OF EACH WINDOW IS TO CONFORM TO A PRECISE SEQUENCE OF MEMBRANE INSTALLATION. THE VAPOUR BARRIERS. AND AIR BARRIERS MUST TIE INTO THE ROUGH OPENING OF ALL WINDOW SYSTEMS AT THE WINDOW PLANE.

THE GLAZING DOUBLE GLAZED WITH A LOW- E COATING ON SURFACE 3 FOR THE SEALED UNIT. CONSIDER GLAZING AND FRAMES OF THE HIGHEST AFFORDABLE INSULATING VALUE AND THERMAL PERFORMANCE. AN ADDITIONAL TINT IS RECOMMENDED ON THE GLASS TO REDUCE SOLAR HEAT GAIN.

SOLAR SHADING HORIZONTAL SOLAR SHADING DEVICES AND OVERHANGS MAY BE USED TO REDUCE SOLAR GAIN EXPOSURE ON THE SOUTH FAÇADE. ADDITIONAL, VERTICAL SHADING DEVICES MAY BE USED ON THE EAST AND WEST FACADES IF REQUIRED AS WELL. FINALLY, THE SLENDER MASSING AND STEPPING ALLOWS FOR INCREASED DAYLIGHT

ROOF ASSEMBLY

OPTION #2 - ROOFS AND DECKS CONCRETE PAVERS

 SBS ROOFING BASE SHEET

GYPSUM WALL BOARD

- FIBER BOARD • 150MM (R 30) RIGID INSULATION SLOPED TO DRAIN
- PROTECTION BOARD SELF ADHERING AIR / VAPOUR BARRIER MEMBRANE
- CONCRETE STRUCTURE RESILIENT CHANNELS
- ACOUSTIC INSULATION
- GYPSUM WALL BOARD

TYPICAL ROOF AT LANDSCAPE

- PLANTING SOIL (DEPTH VARIES)

- FILTER FABRIC DRAINAGE MAT
- 150MM (R 30) RIGID INSULATION SLOPED TO DRAIN
- WATERPROOF PROOFING MEMBRANE (AIR/VAPOUR BARRIER) CONCRETE STRUCTURE

ASSEMBLIES

GENERAL NOTES AND

scale

project no.

alan lowe architect inc.

consultant

t. 403.264.8700 f. 403.264.8029

> Urban Design Architecture Interior Design drawing title

sheet A0.01

POR, DS



VIEW FROM BELLEVILLE STREET



VIEW FROM INNER HARBOR




VIEW FROM QUEBEC STREET



VIEW FROM PENDRAY & QUEBEC STREET

VICTORIA, BRITISH COLUMBIA

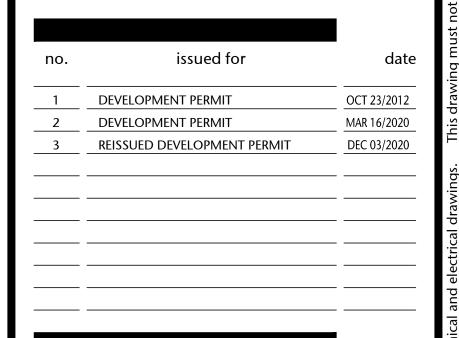



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PERSPECTIVES

A0.02

drawn DL

AS SHOWN

project no.
20 118

drawing title

MARCH SHADOW STUDIES

JUNE SHADOW STUDIES

MARCH 21ST 2011 - 10.00am

MARCH 21ST 2011 - 12.00pm



MARCH 21ST 2011 - 2.00pm

JUNE 21ST 2011 - 10.00am



JUNE 21ST 2011 - 12.00pm



JUNE 21ST 2011 - 2.00pm

SEPTEMBER SHADOW STUDIES



SEPTEMBER 21ST 2011 - 10.00am



SEPTEMBER 21ST 2011 - 12.00pm



SEPTEMBER 21ST 2011 - 2.00pm

DECEMBER SHADOW STUDIES



DECEMBER 21ST 2011 - 10.00am




DECEMBER 21ST 2011 - 12.00pm



DECEMBER 21ST 2011 - 2.00pm



VICTORIA, BRITISH COLUMBIA

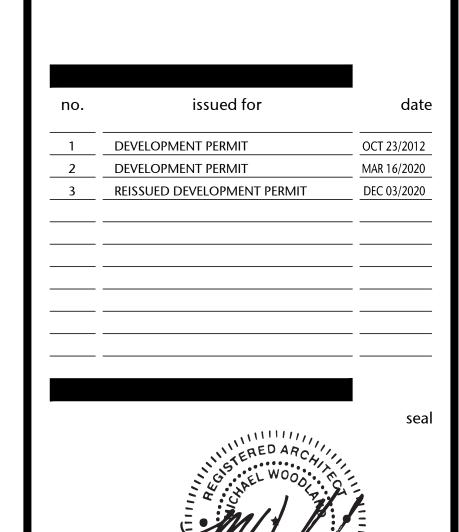

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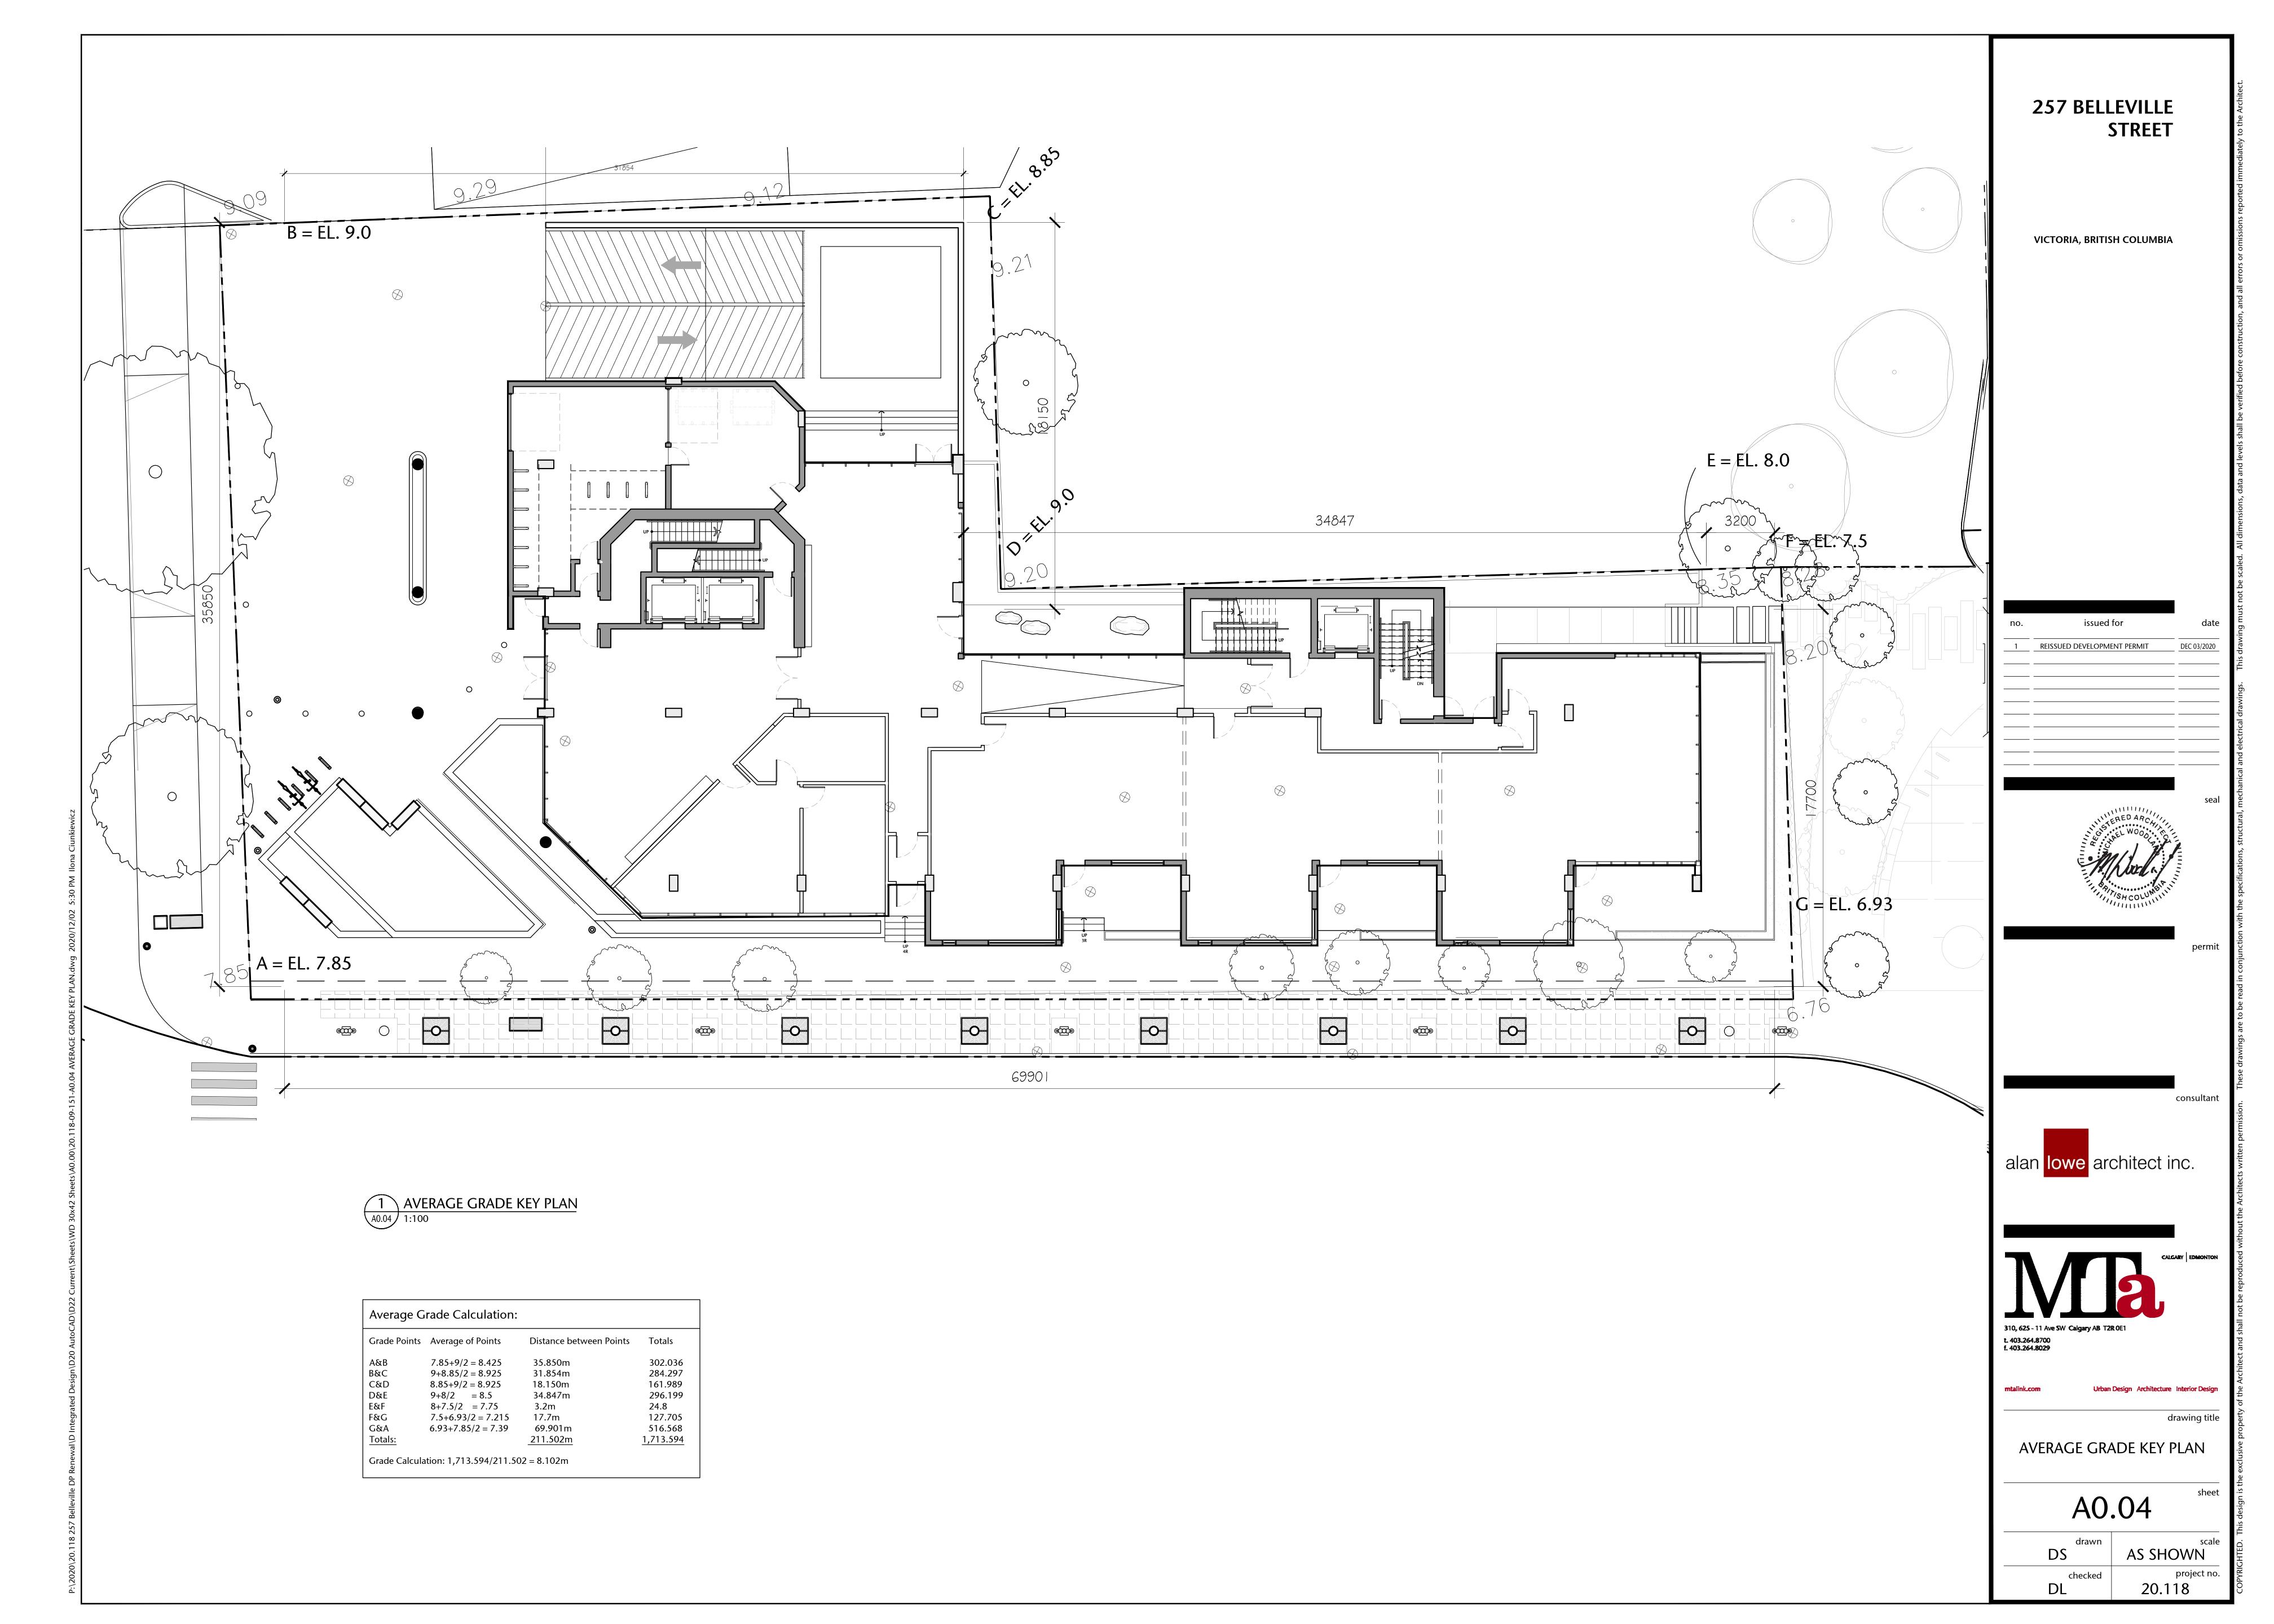
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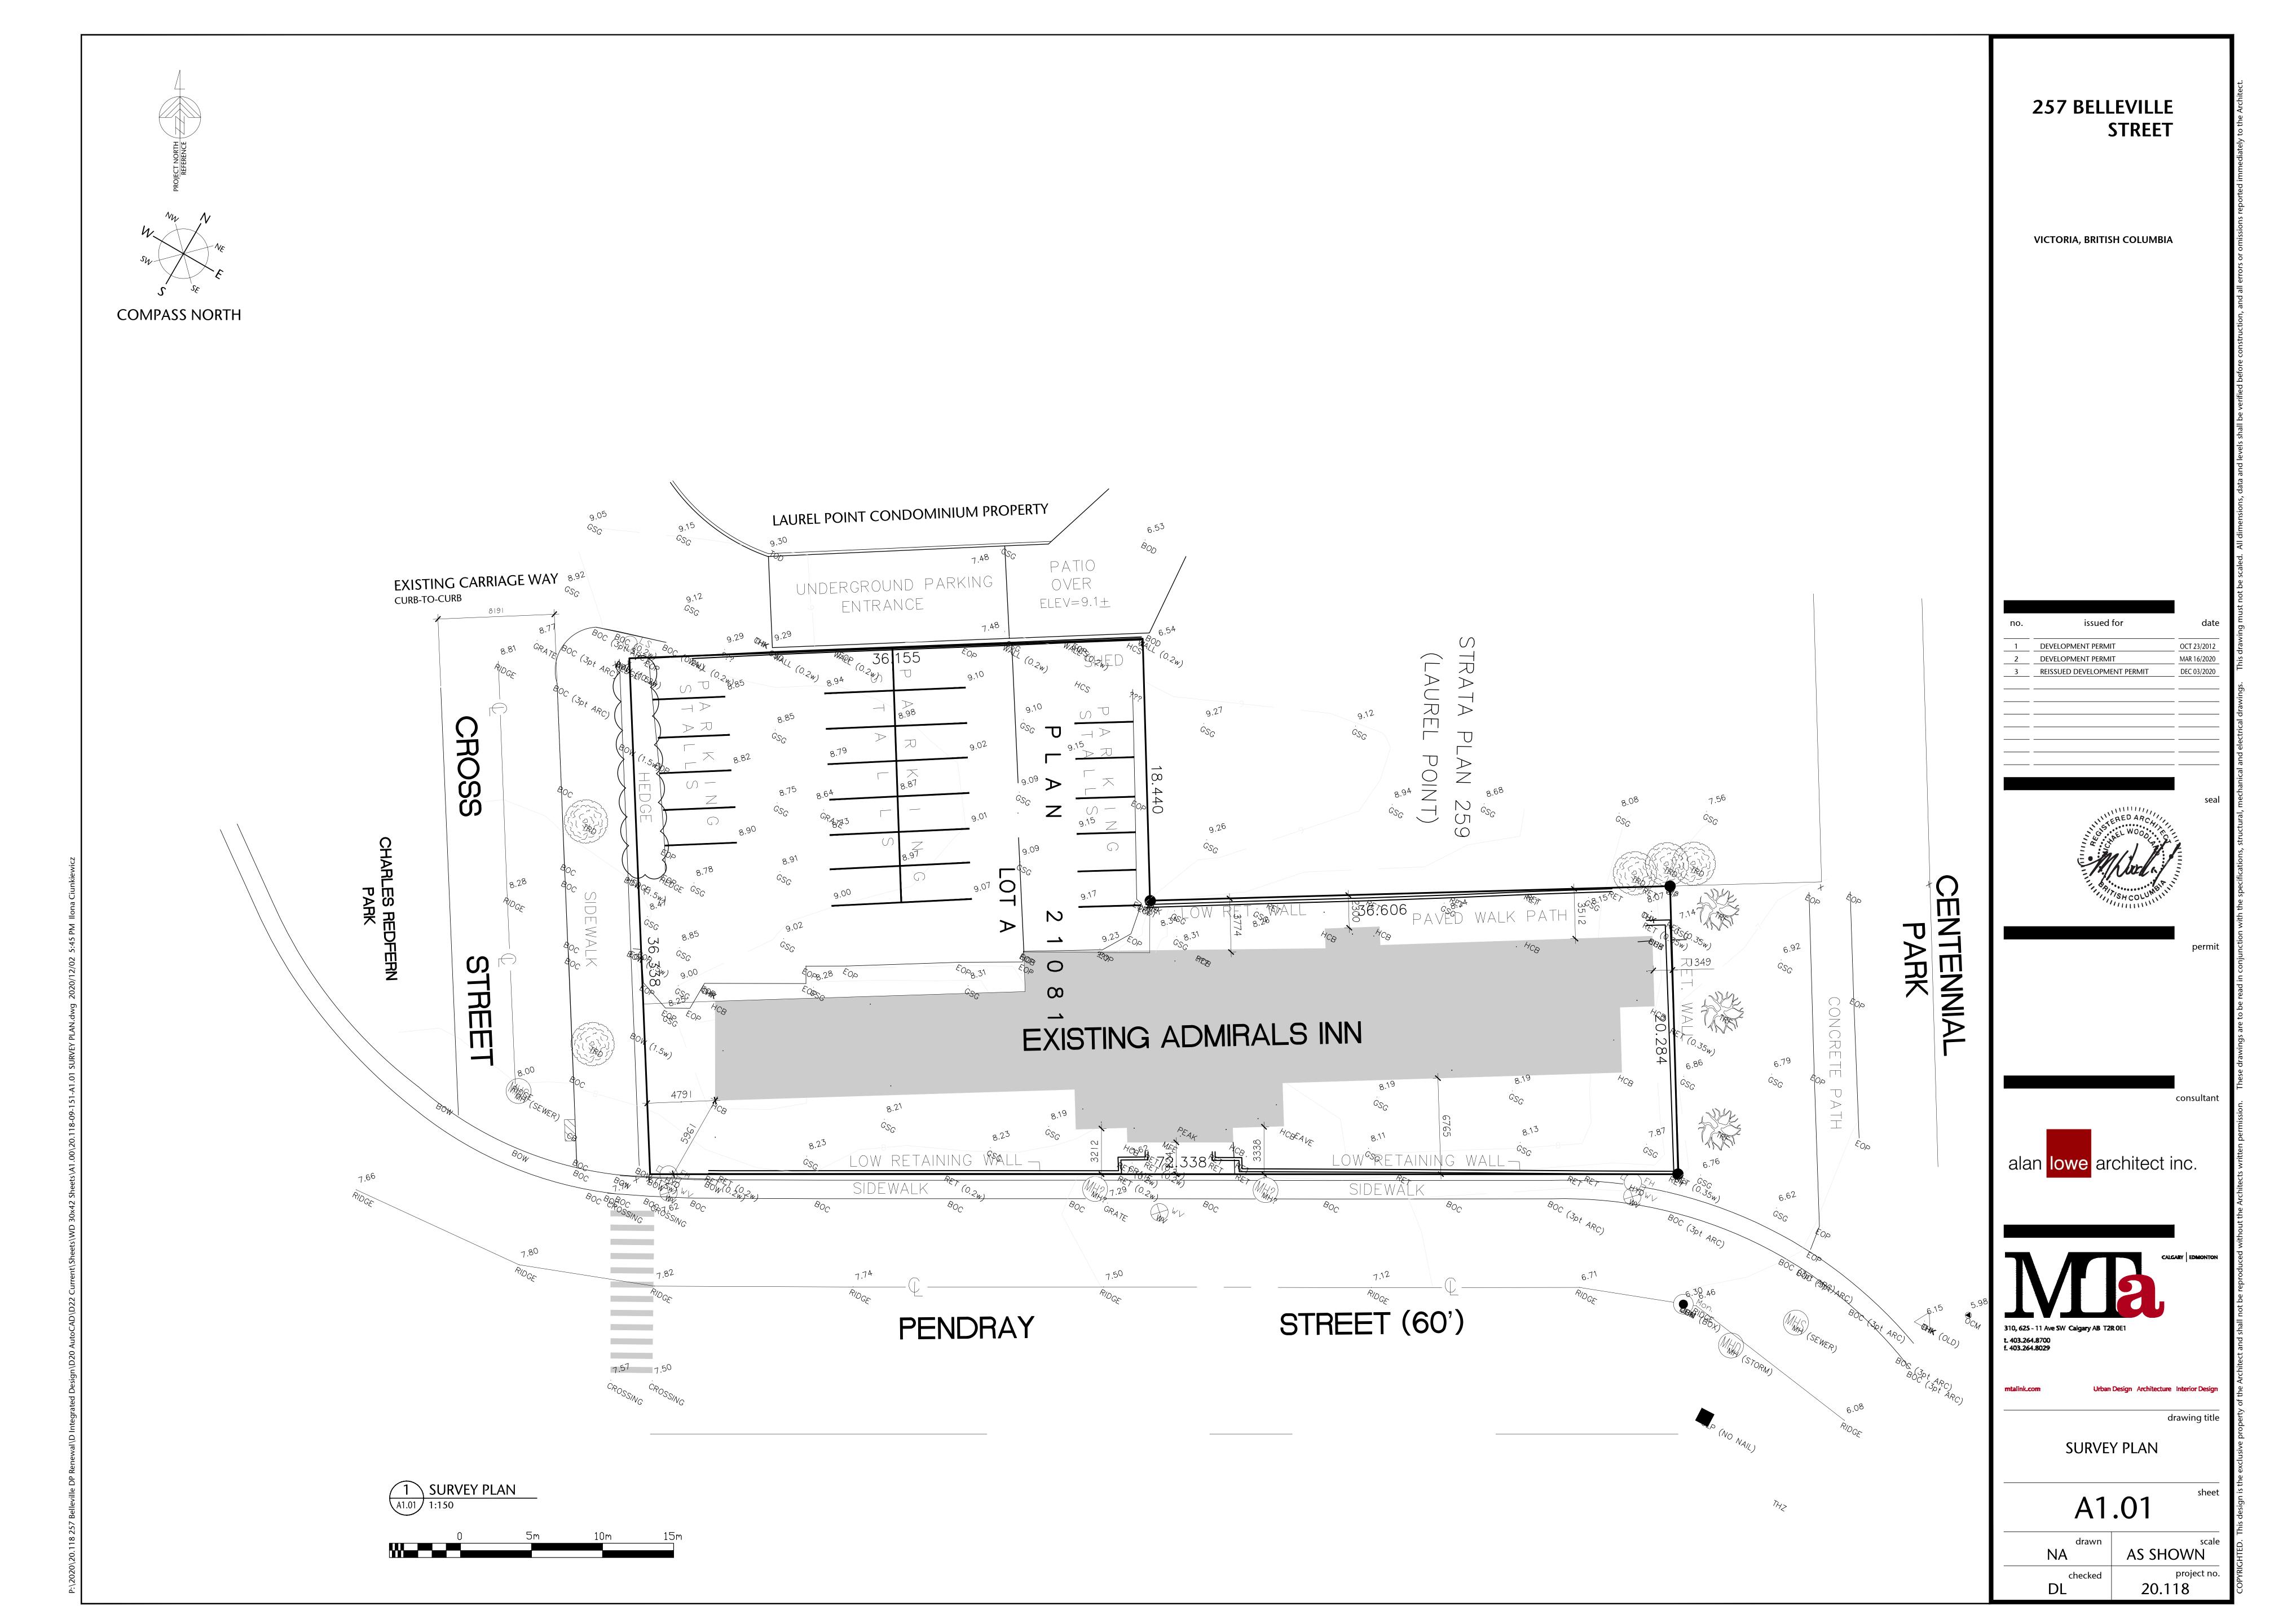
SUN & SHADOW STUDIES


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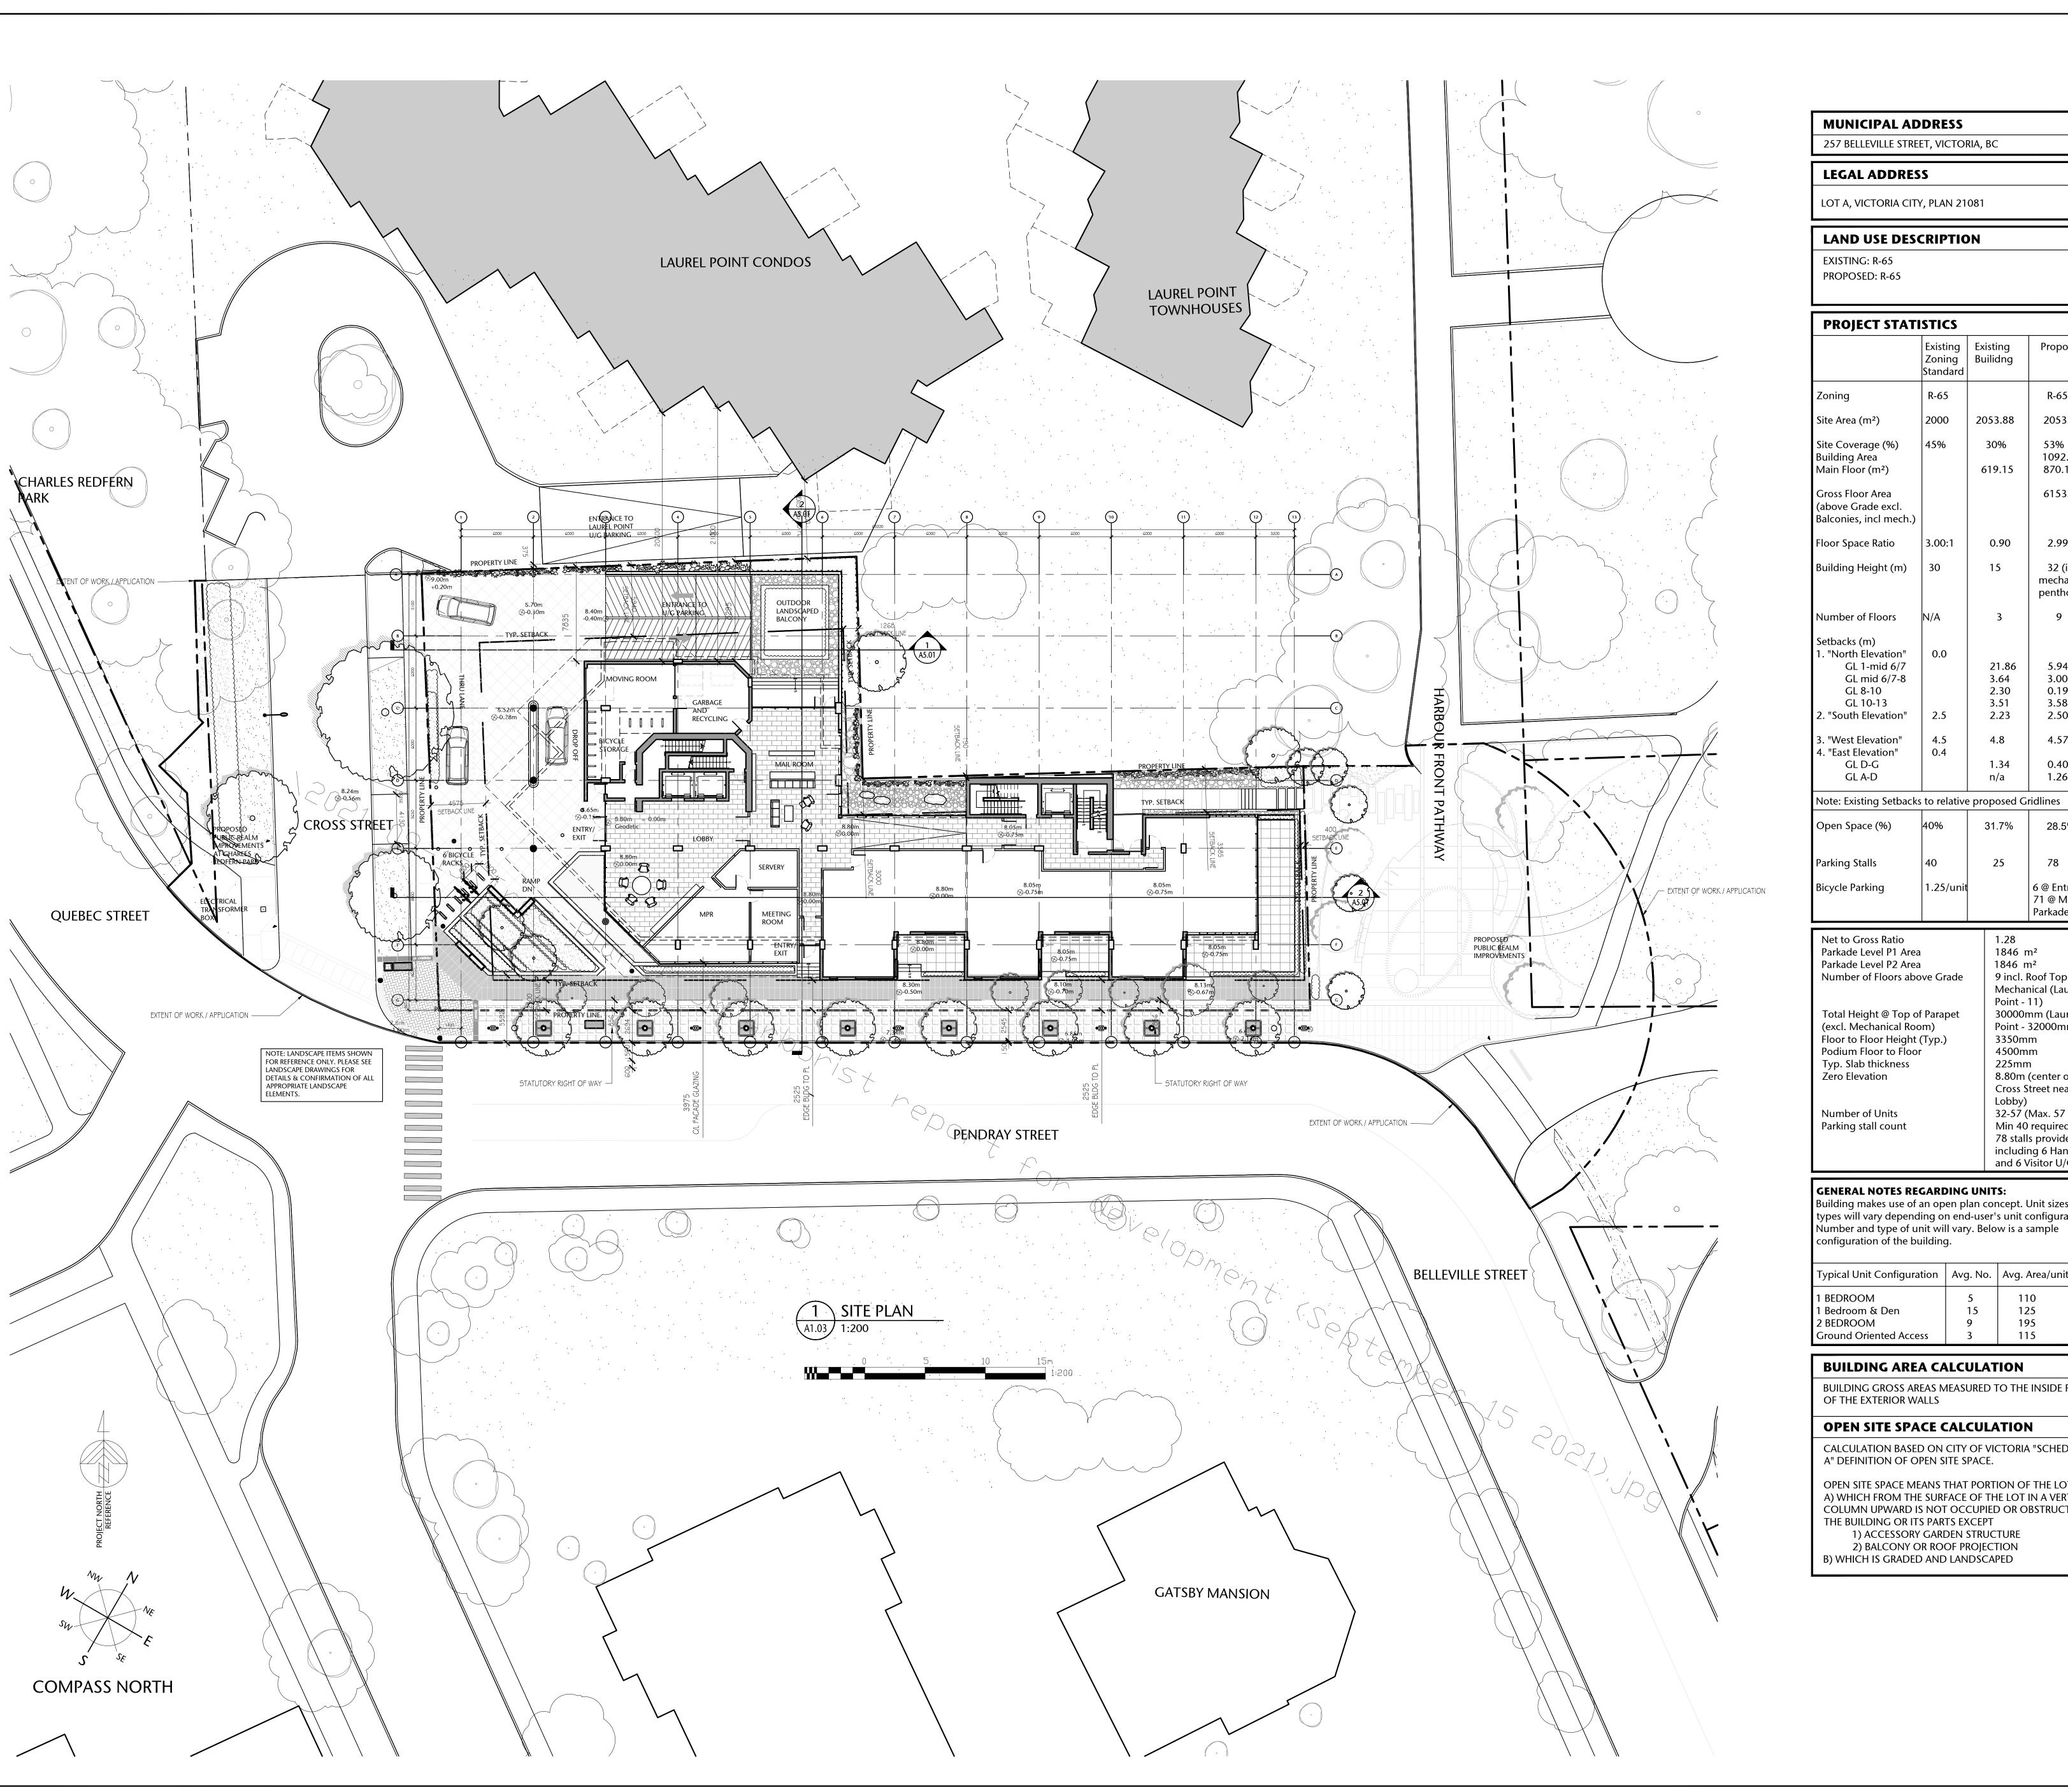
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MUNICIPAL ADDRESS

257 BELLEVILLE STREET, VICTORIA, BC

LEGAL ADDRESS

LOT A, VICTORIA CITY, PLAN 21081

LAND USE DESCRIPTION

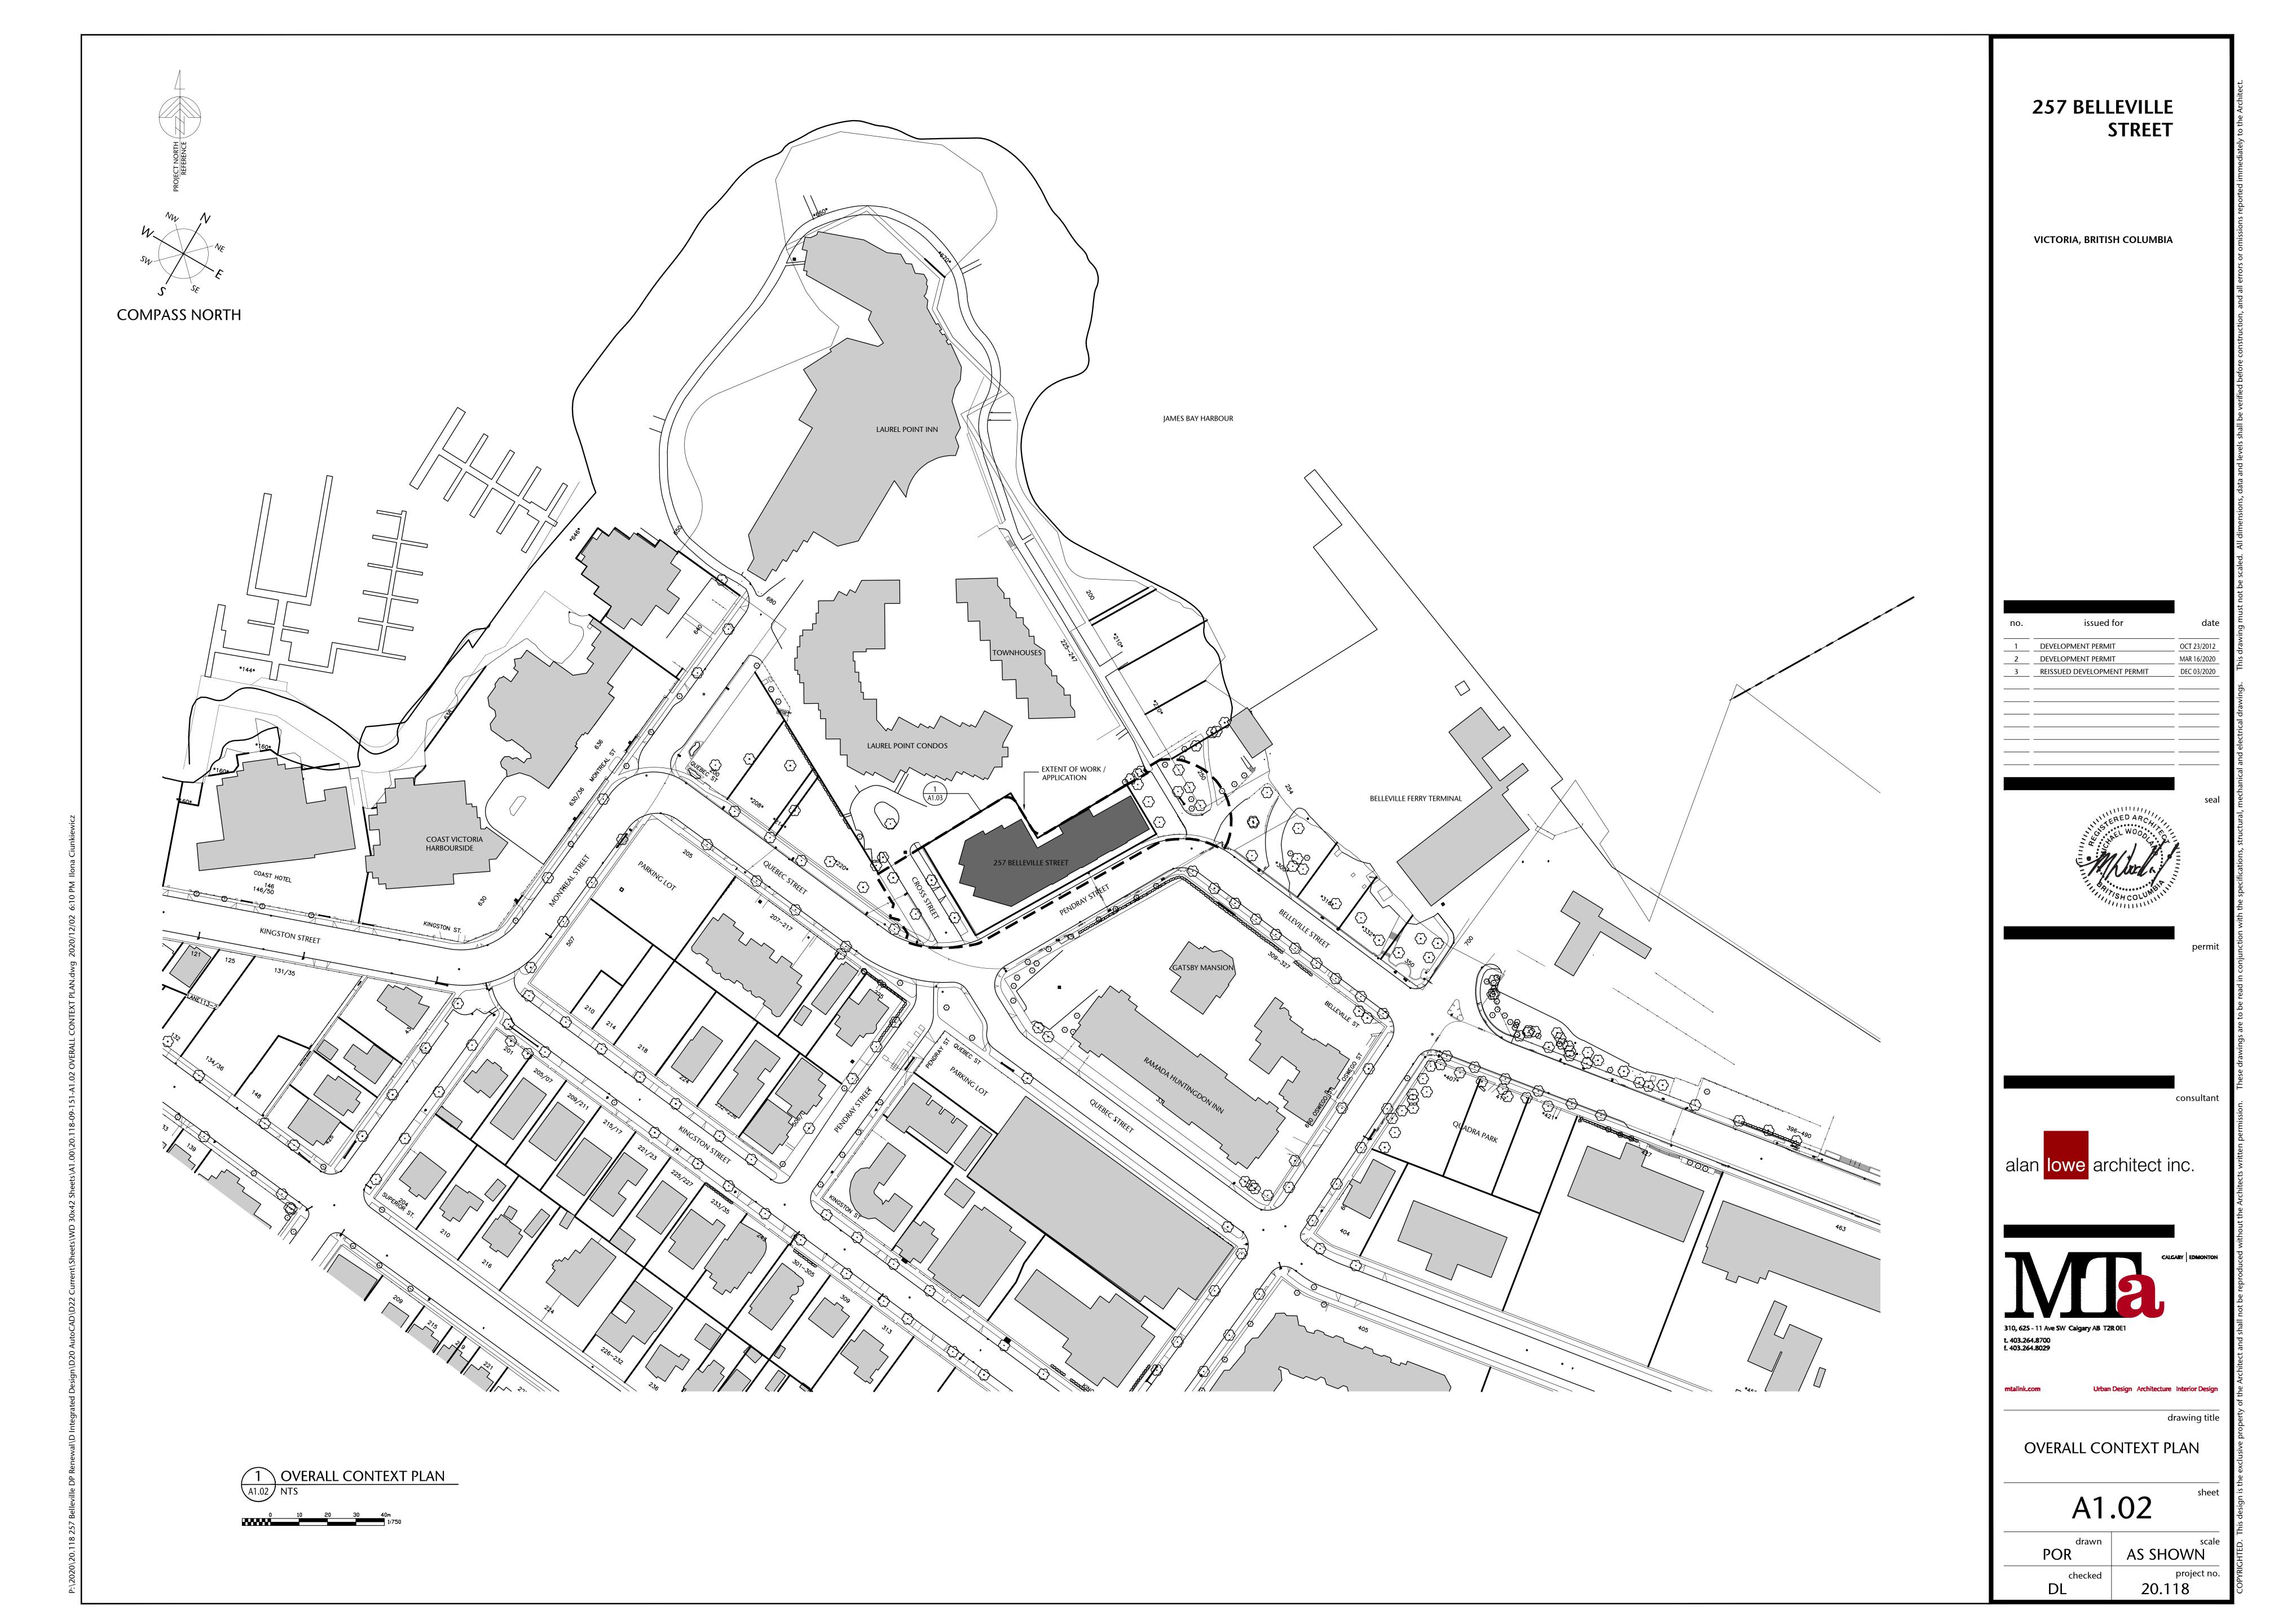EXISTING: R-65 PROPOSED: R-65

PROJECT STAT	ISTICS		
	Existing Zoning Standard	Existing Builidng	Proposal
Zoning	R-65		R-65
Site Area (m²)	2000	2053.88	2053.88
Site Coverage (%)	45%	30%	53%
Building Area Main Floor (m²)		619.15	1092.56 870.14
Gross Floor Area (above Grade excl. Balconies, incl mech.)			6153.22
Floor Space Ratio	3.00:1	0.90	2.995
Building Height (m)	30	15	32 (incl. mechanic penthous
Number of Floors	N/A	3	9
Setbacks (m) 1. "North Elevation" GL 1-mid 6/7 GL mid 6/7-8 GL 8-10 GL 10-13 2. "South Elevation"	0.0	21.86 3.64 2.30 3.51 2.23	5.94 3.00 0.19 3.585 2.50
3. "West Elevation"	4.5	4.8	4.575
4. "East Elevation" GL D-G GL A-D	0.4	1.34 n/a	0.40 1.26

Bicycle Parking	1.25/unit		6 @ Entry & 71 @ Main & Parkade Level
Net to Gross Ratio Parkade Level P1 Area Parkade Level P2 Area Number of Floors abo Total Height @ Top of (excl. Mechanical Roo Floor to Floor Height (Podium Floor to Floor Typ. Slab thickness Zero Elevation Number of Units Parking stall count	rve Grade F Parapet m) (Typ.)	Mechar Point - 30000r Point - 3350m 4500m 225mn 8.80m Cross S Lobby) 32-57 (Min 40 78 stall includir	n ² Roof Top nical (Laurel 11) nm (Laurel 32000mm) m

28.5%

78

25

GENERAL NOTES REGARDING UNITS:

Building makes use of an open plan concept. Unit sizes and types will vary depending on end-user's unit configuration. Number and type of unit will vary. Below is a sample configuration of the building.

Typical Unit Configuration	Avg. No.	Avg. Area/unit (m²
1 BEDROOM	5	110
1 Bedroom & Den	15	125
2 BEDROOM	9	195
Ground Oriented Access	3	115

BUILDING AREA CALCULATION

BUILDING GROSS AREAS MEASURED TO THE INSIDE FACE OF THE EXTERIOR WALLS

OPEN SITE SPACE CALCULATION

CALCULATION BASED ON CITY OF VICTORIA "SCHEDULE A" DEFINITION OF OPEN SITE SPACE.

OPEN SITE SPACE MEANS THAT PORTION OF THE LOT: A) WHICH FROM THE SURFACE OF THE LOT IN A VERTICAL COLUMN UPWARD IS NOT OCCUPIED OR OBSTRUCTED BY THE BUILDING OR ITS PARTS EXCEPT

1) ACCESSORY GARDEN STRUCTURE 2) BALCONY OR ROOF PROJECTION B) WHICH IS GRADED AND LANDSCAPED

257 BELLEVILLE STREET

VICTORIA, BRITISH COLUMBIA

no.	issued for	l date
1	DEVELOPMENT PERMIT	OCT 23/2012
2	DP ADDITIONAL ITEMS	DEC /05/2012
3	DEVELOPMENT PERMIT	MAR 16/2020
4	REISSUED DEVELOPMENT PERMIT	DEC 03/2020
5	REISSUED DEVELOPMENT PERMIT	JUN/07/2021
6	REISSUED DEVELOPMENT PERMIT	DEC/06/2021
7	REISSUED DEVELOPMENT PERMIT	APR/11/2022



consultant



alan lowe architect inc.




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SITE CONTEXT PLAN & DATA SHEET

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AS SHOWN



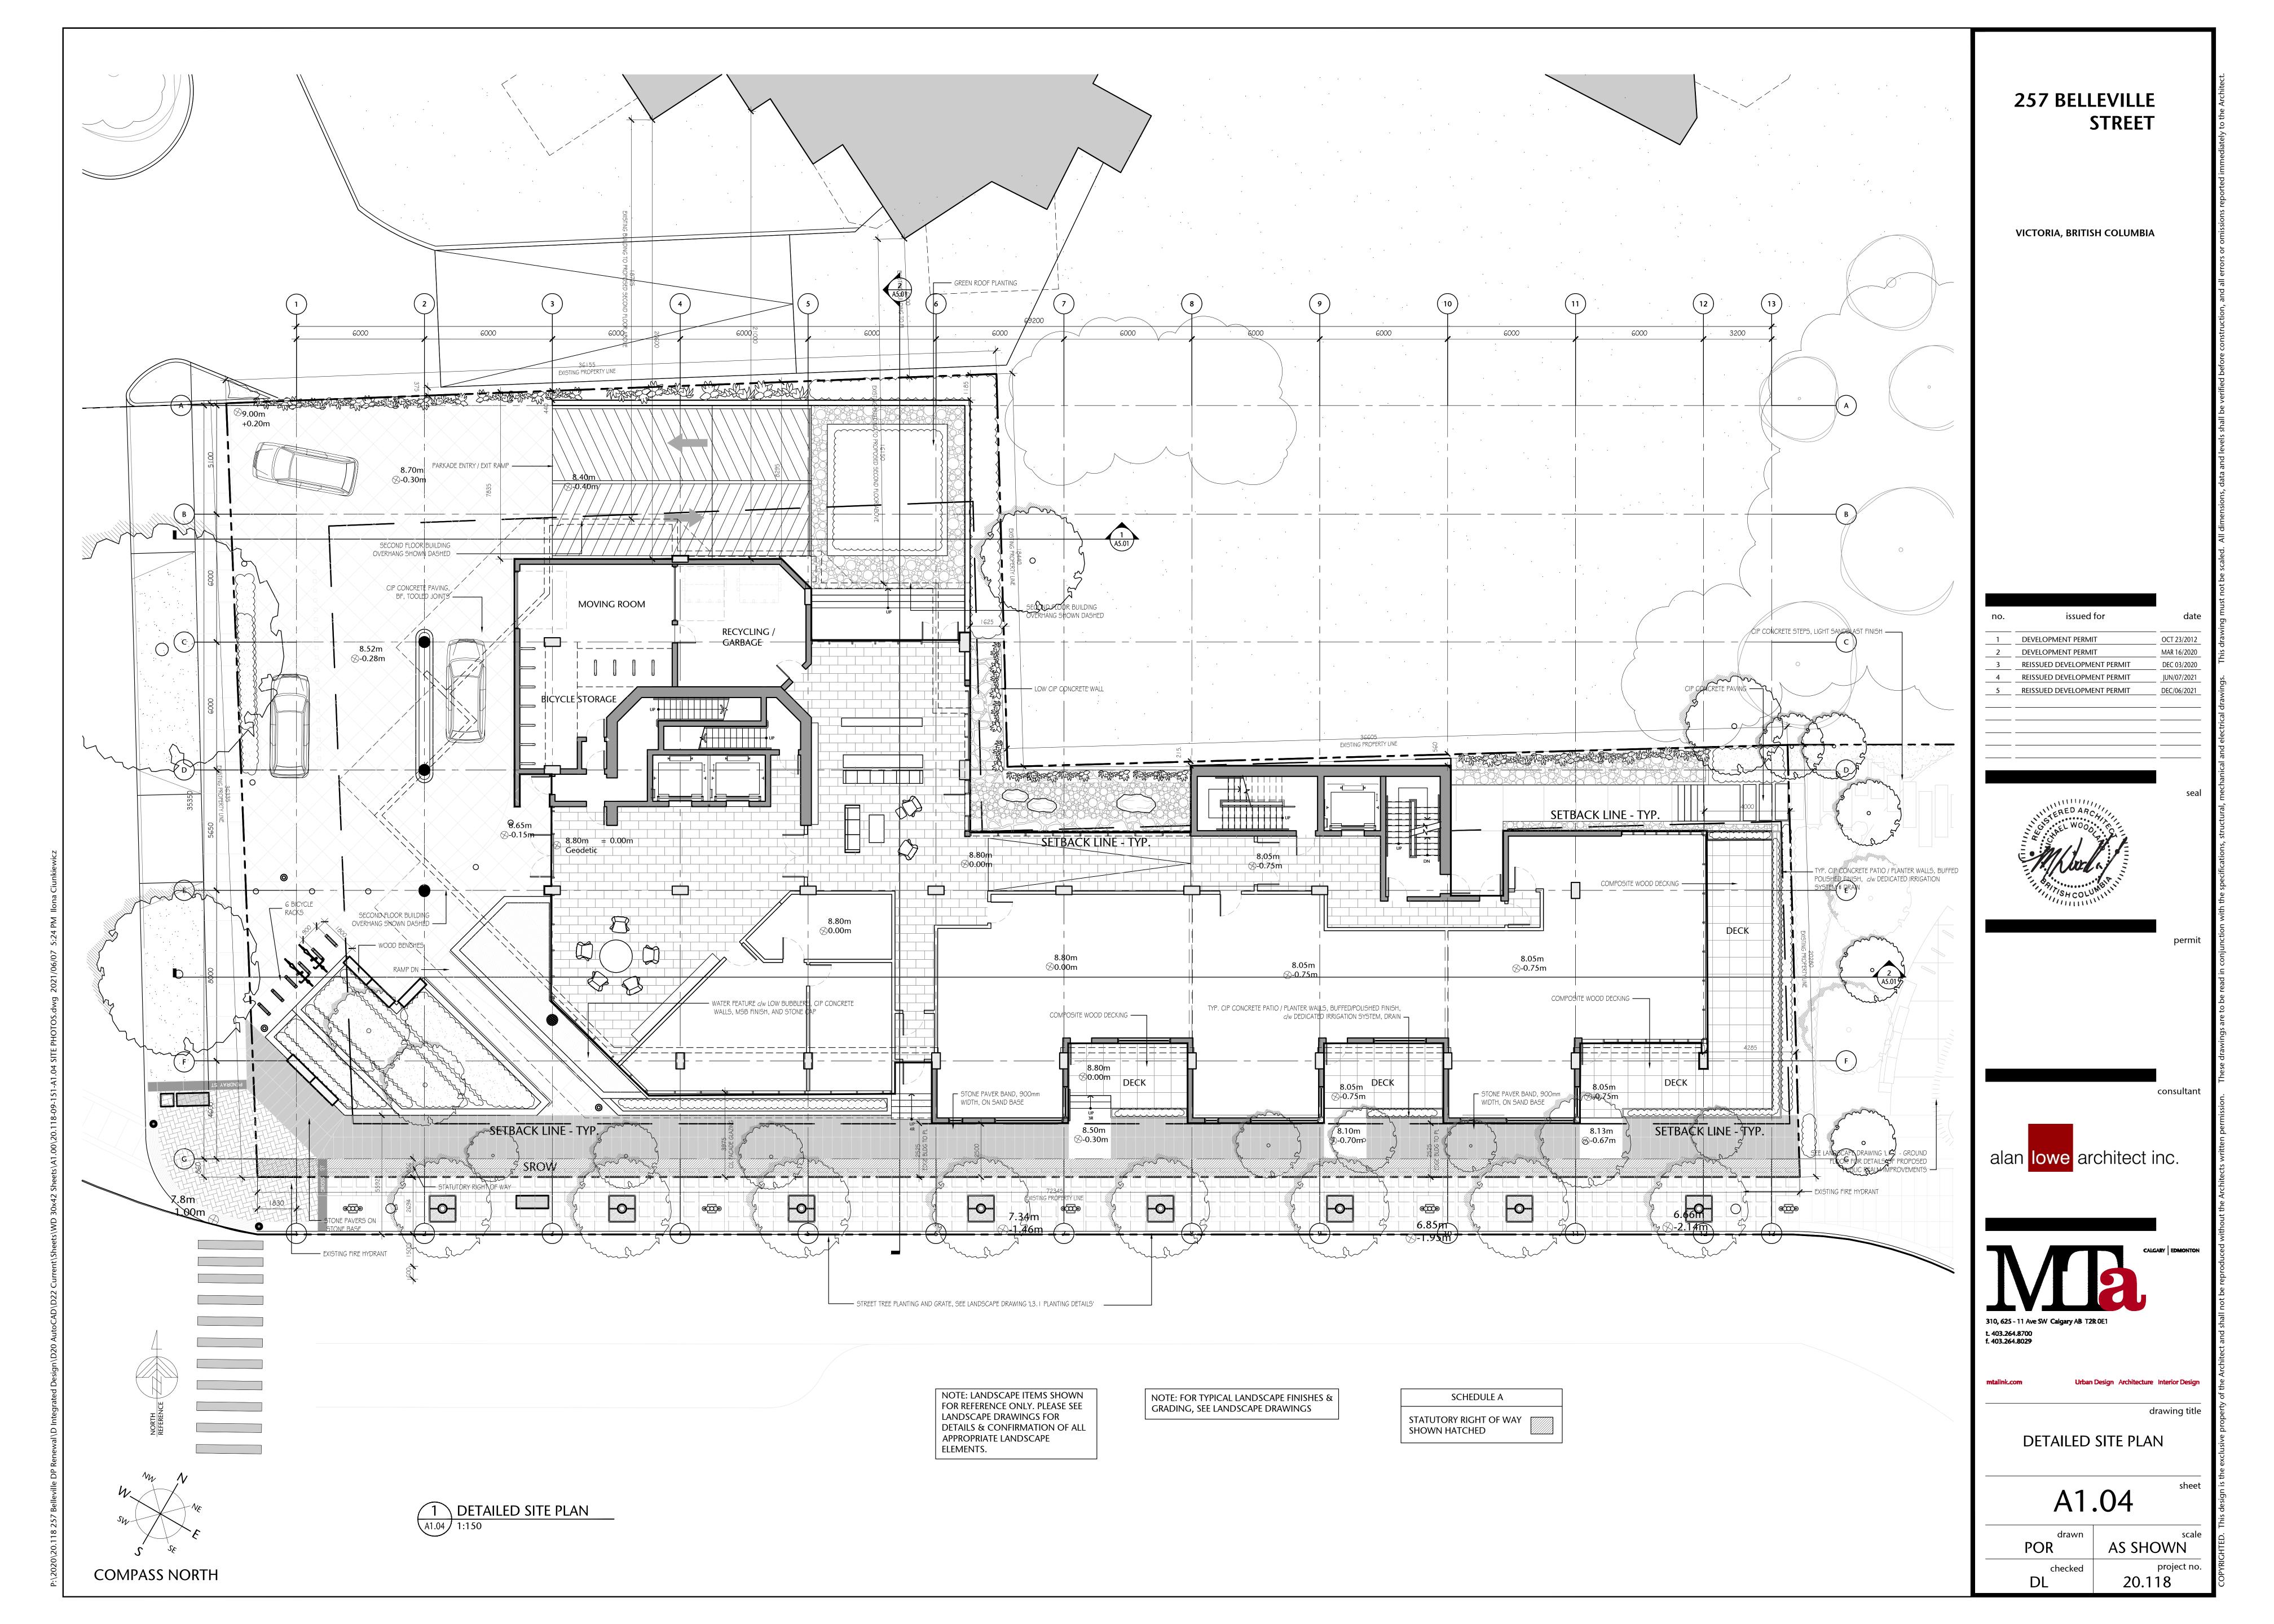


PHOTO LOCATION PLAN

NTS



1 QUEBEC STREET LOOKING EAST DOWN PENDRAY STREET

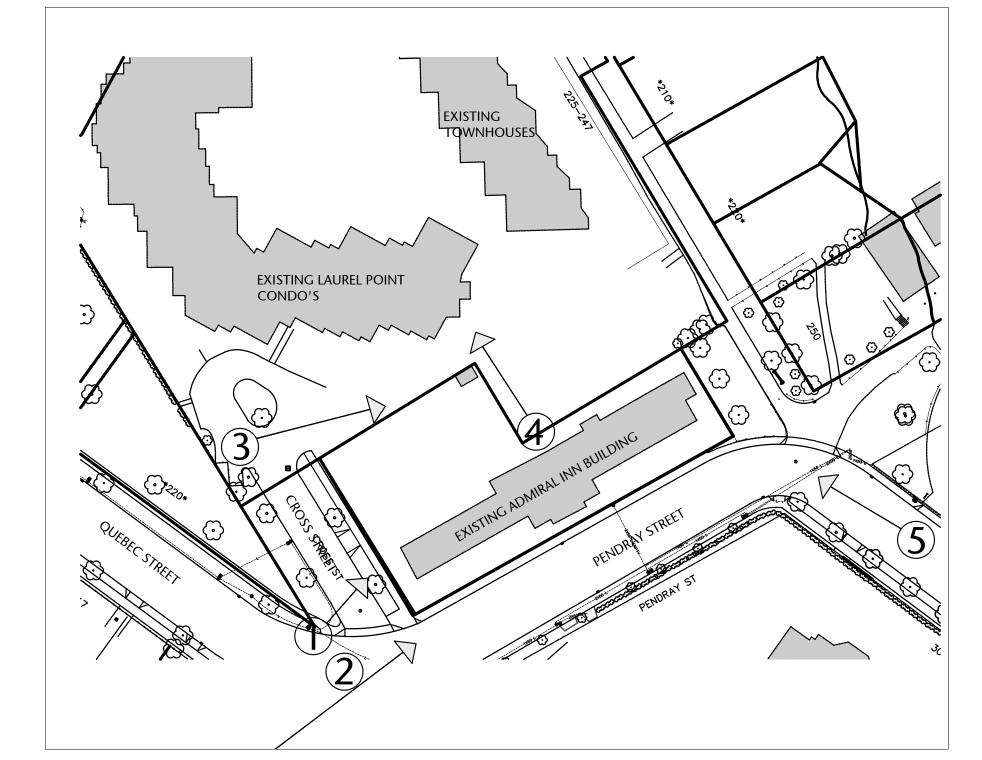PENDRAY STREET LOOKING NORTH - EXISTING ADMIRAL'S INN BUILDING



3 VIEW LOOKING SOUTH DOWN CROSS STREET

NTS



4 LOOKING NORTH AT ADJACENT LAUREL POINT CONDO'S



5 VIEW LOOKING NORTH UP BELLEVILLE STREET - EXISTING ADMIRAL'S INN BUILDING

257 BELLEVILLE STREET

VICTORIA, BRITISH COLUMBIA





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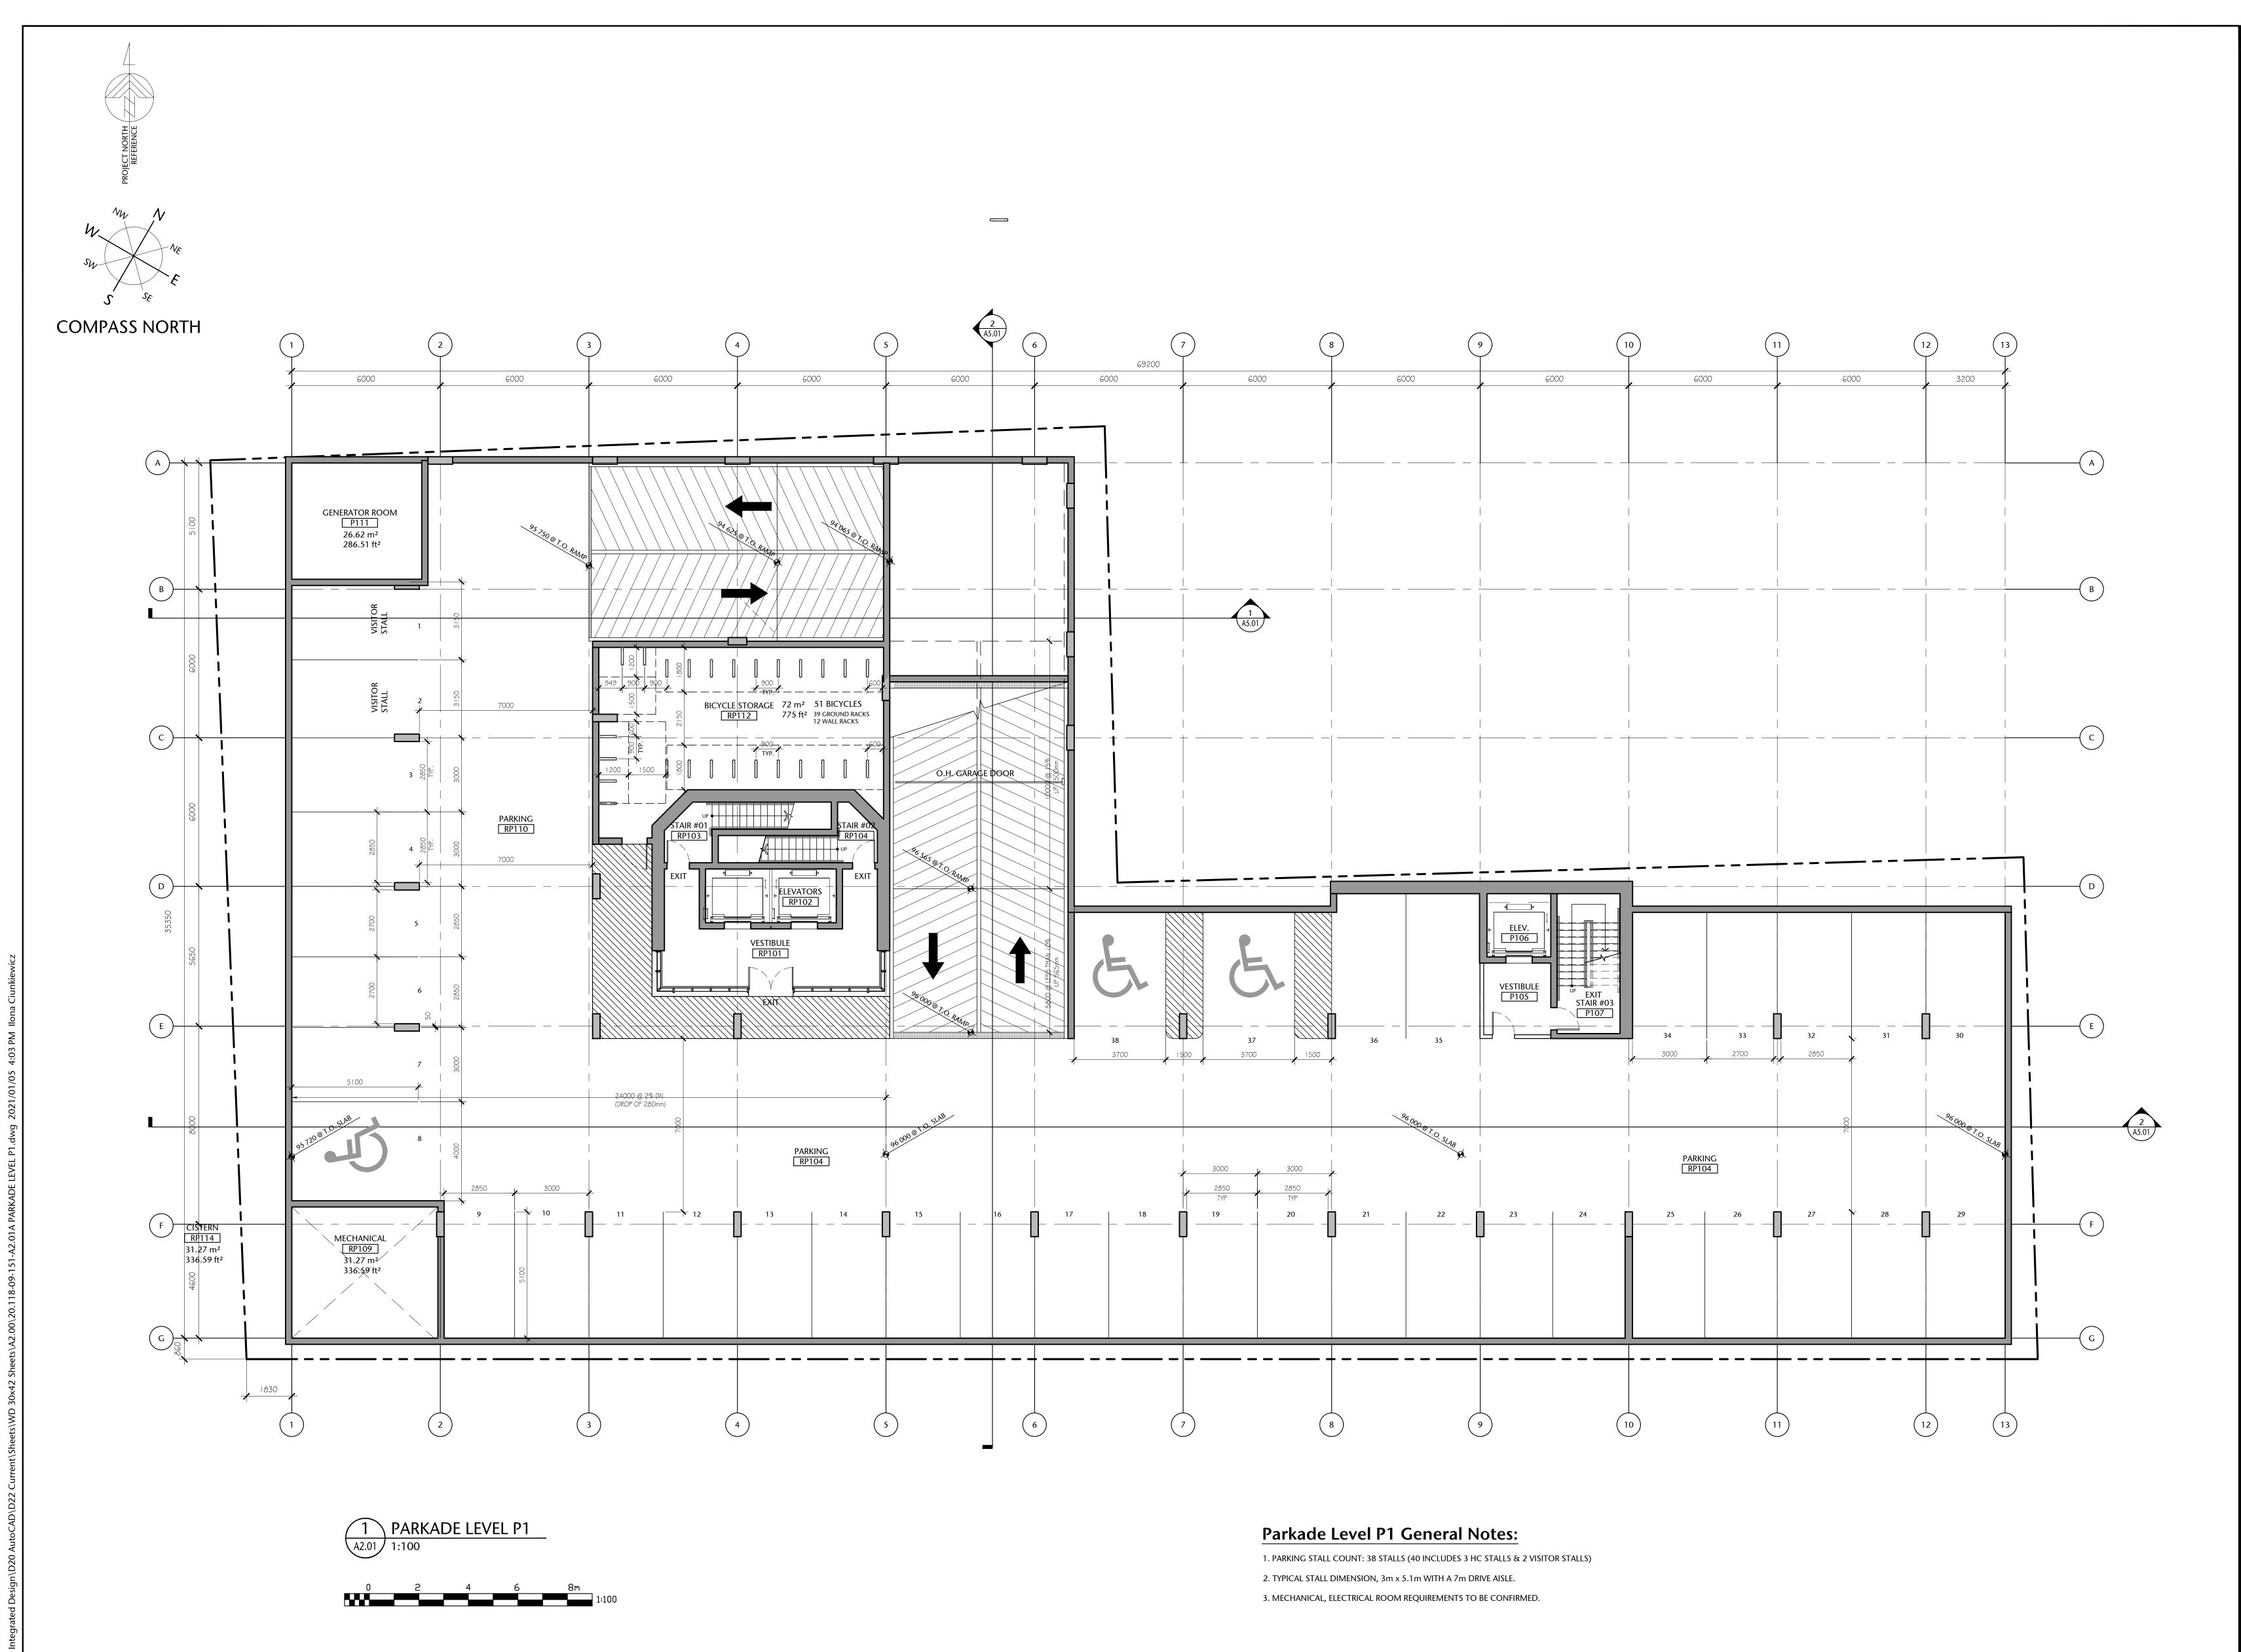
drawing title

SITE PHOTOS

A1.05

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checked proje



VICTORIA, BRITISH COLUMBIA

no.	issued for	date
1	DEVELOPMENT PERMIT	OCT 23/2012
2	DP ADDITIONAL ITEMS	DEC 05/2012
3	DP ADDITIONAL ITEMS	DEC 12/2012
4	DEVELOPMENT PERMIT	MAR 16/2020
5	REISSUED DEVELOPMENT PERMIT	DEC 03/2020



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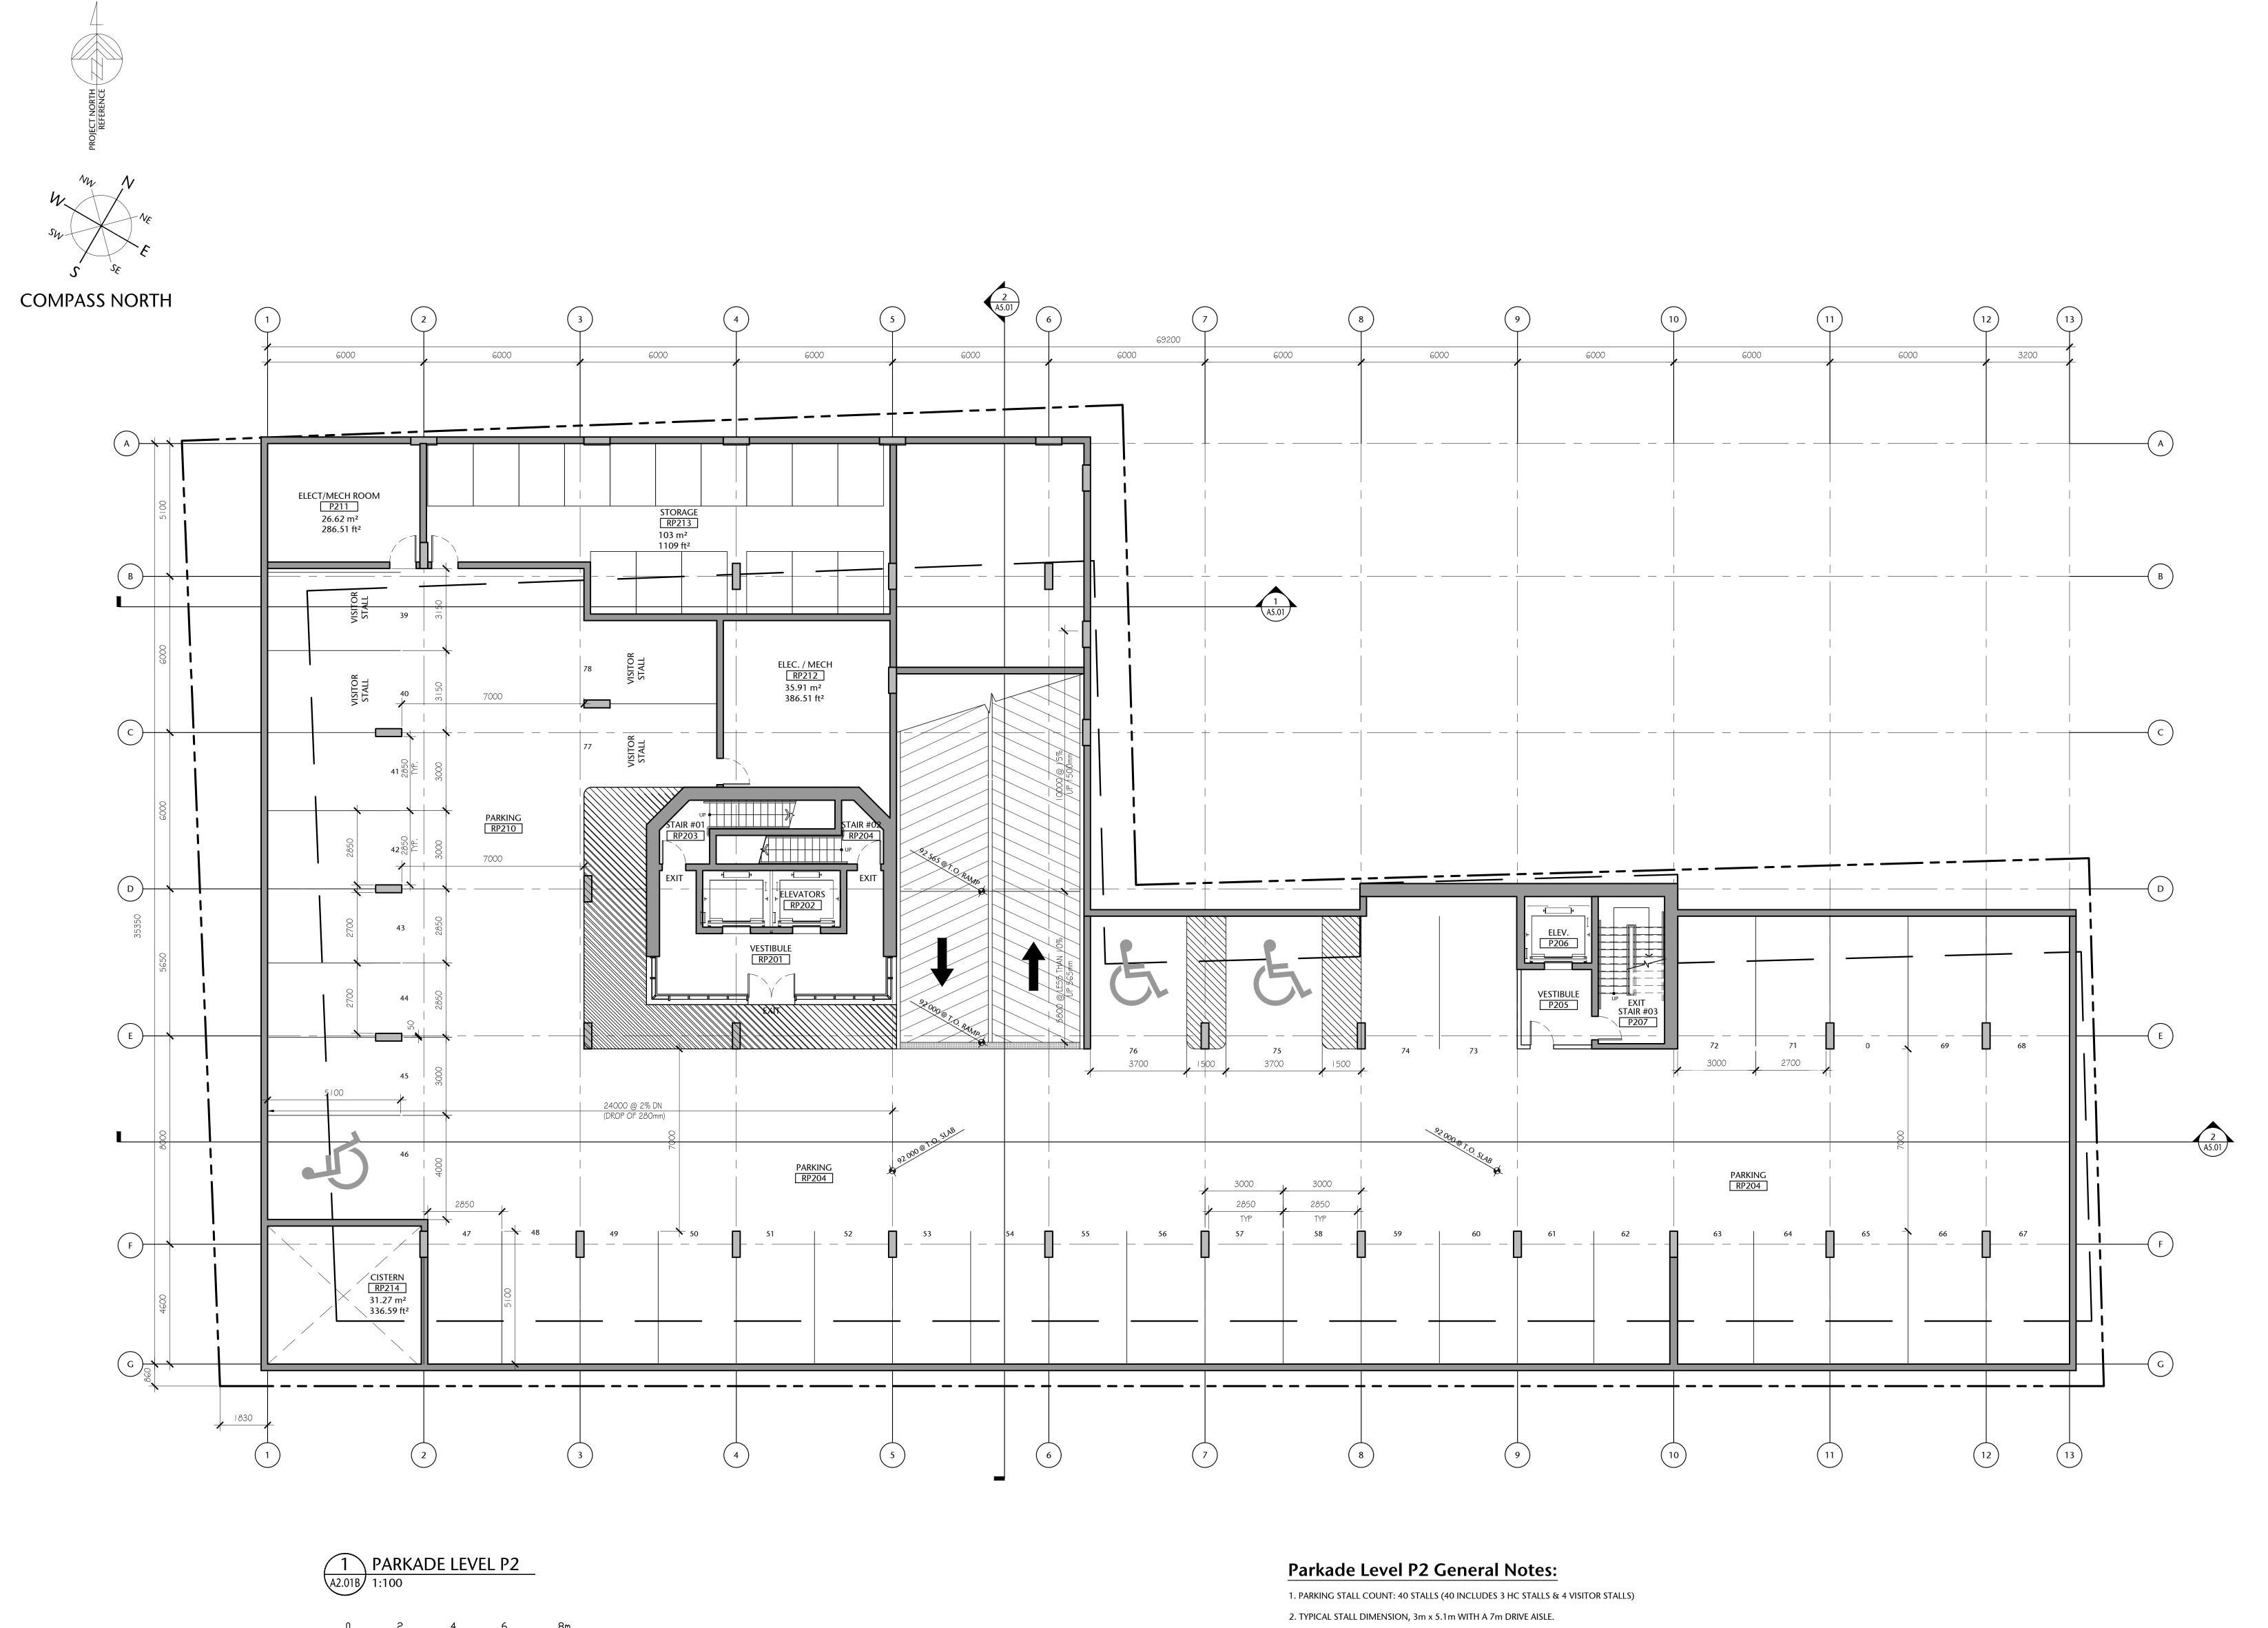
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PARKADE LEVEL P1

A2.01A

POR AS SHOWN

checked project no



3. TENANT STORAGE AS SHOWN. MECHANICAL, ELECTRICAL ROOM REQUIREMENTS TO BE CONFIRMED.

257 BELLEVILLE STREET

VICTORIA, BRITISH COLUMBIA

issued for	date
DEVELOPMENT PERMIT	OCT 23/2012
DP ADDITIONAL ITEMS	DEC 05/2012
DP ADDITIONAL ITEMS	DEC 12/2012
DEVELOPMENT PERMIT	MAR 16/2020
REISSUED DEVELOPMENT PERMIT	DEC 03/2020
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Urban Design Architecture Interior Design


drawing title

PARKADE LEVEL P2

A2.01B

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VICTORIA, BRITISH COLUMBIA

OCT 23/2012 MAR 16/2020 DEC 03/2020 REISSUED DEVELOPMENT PERMIT

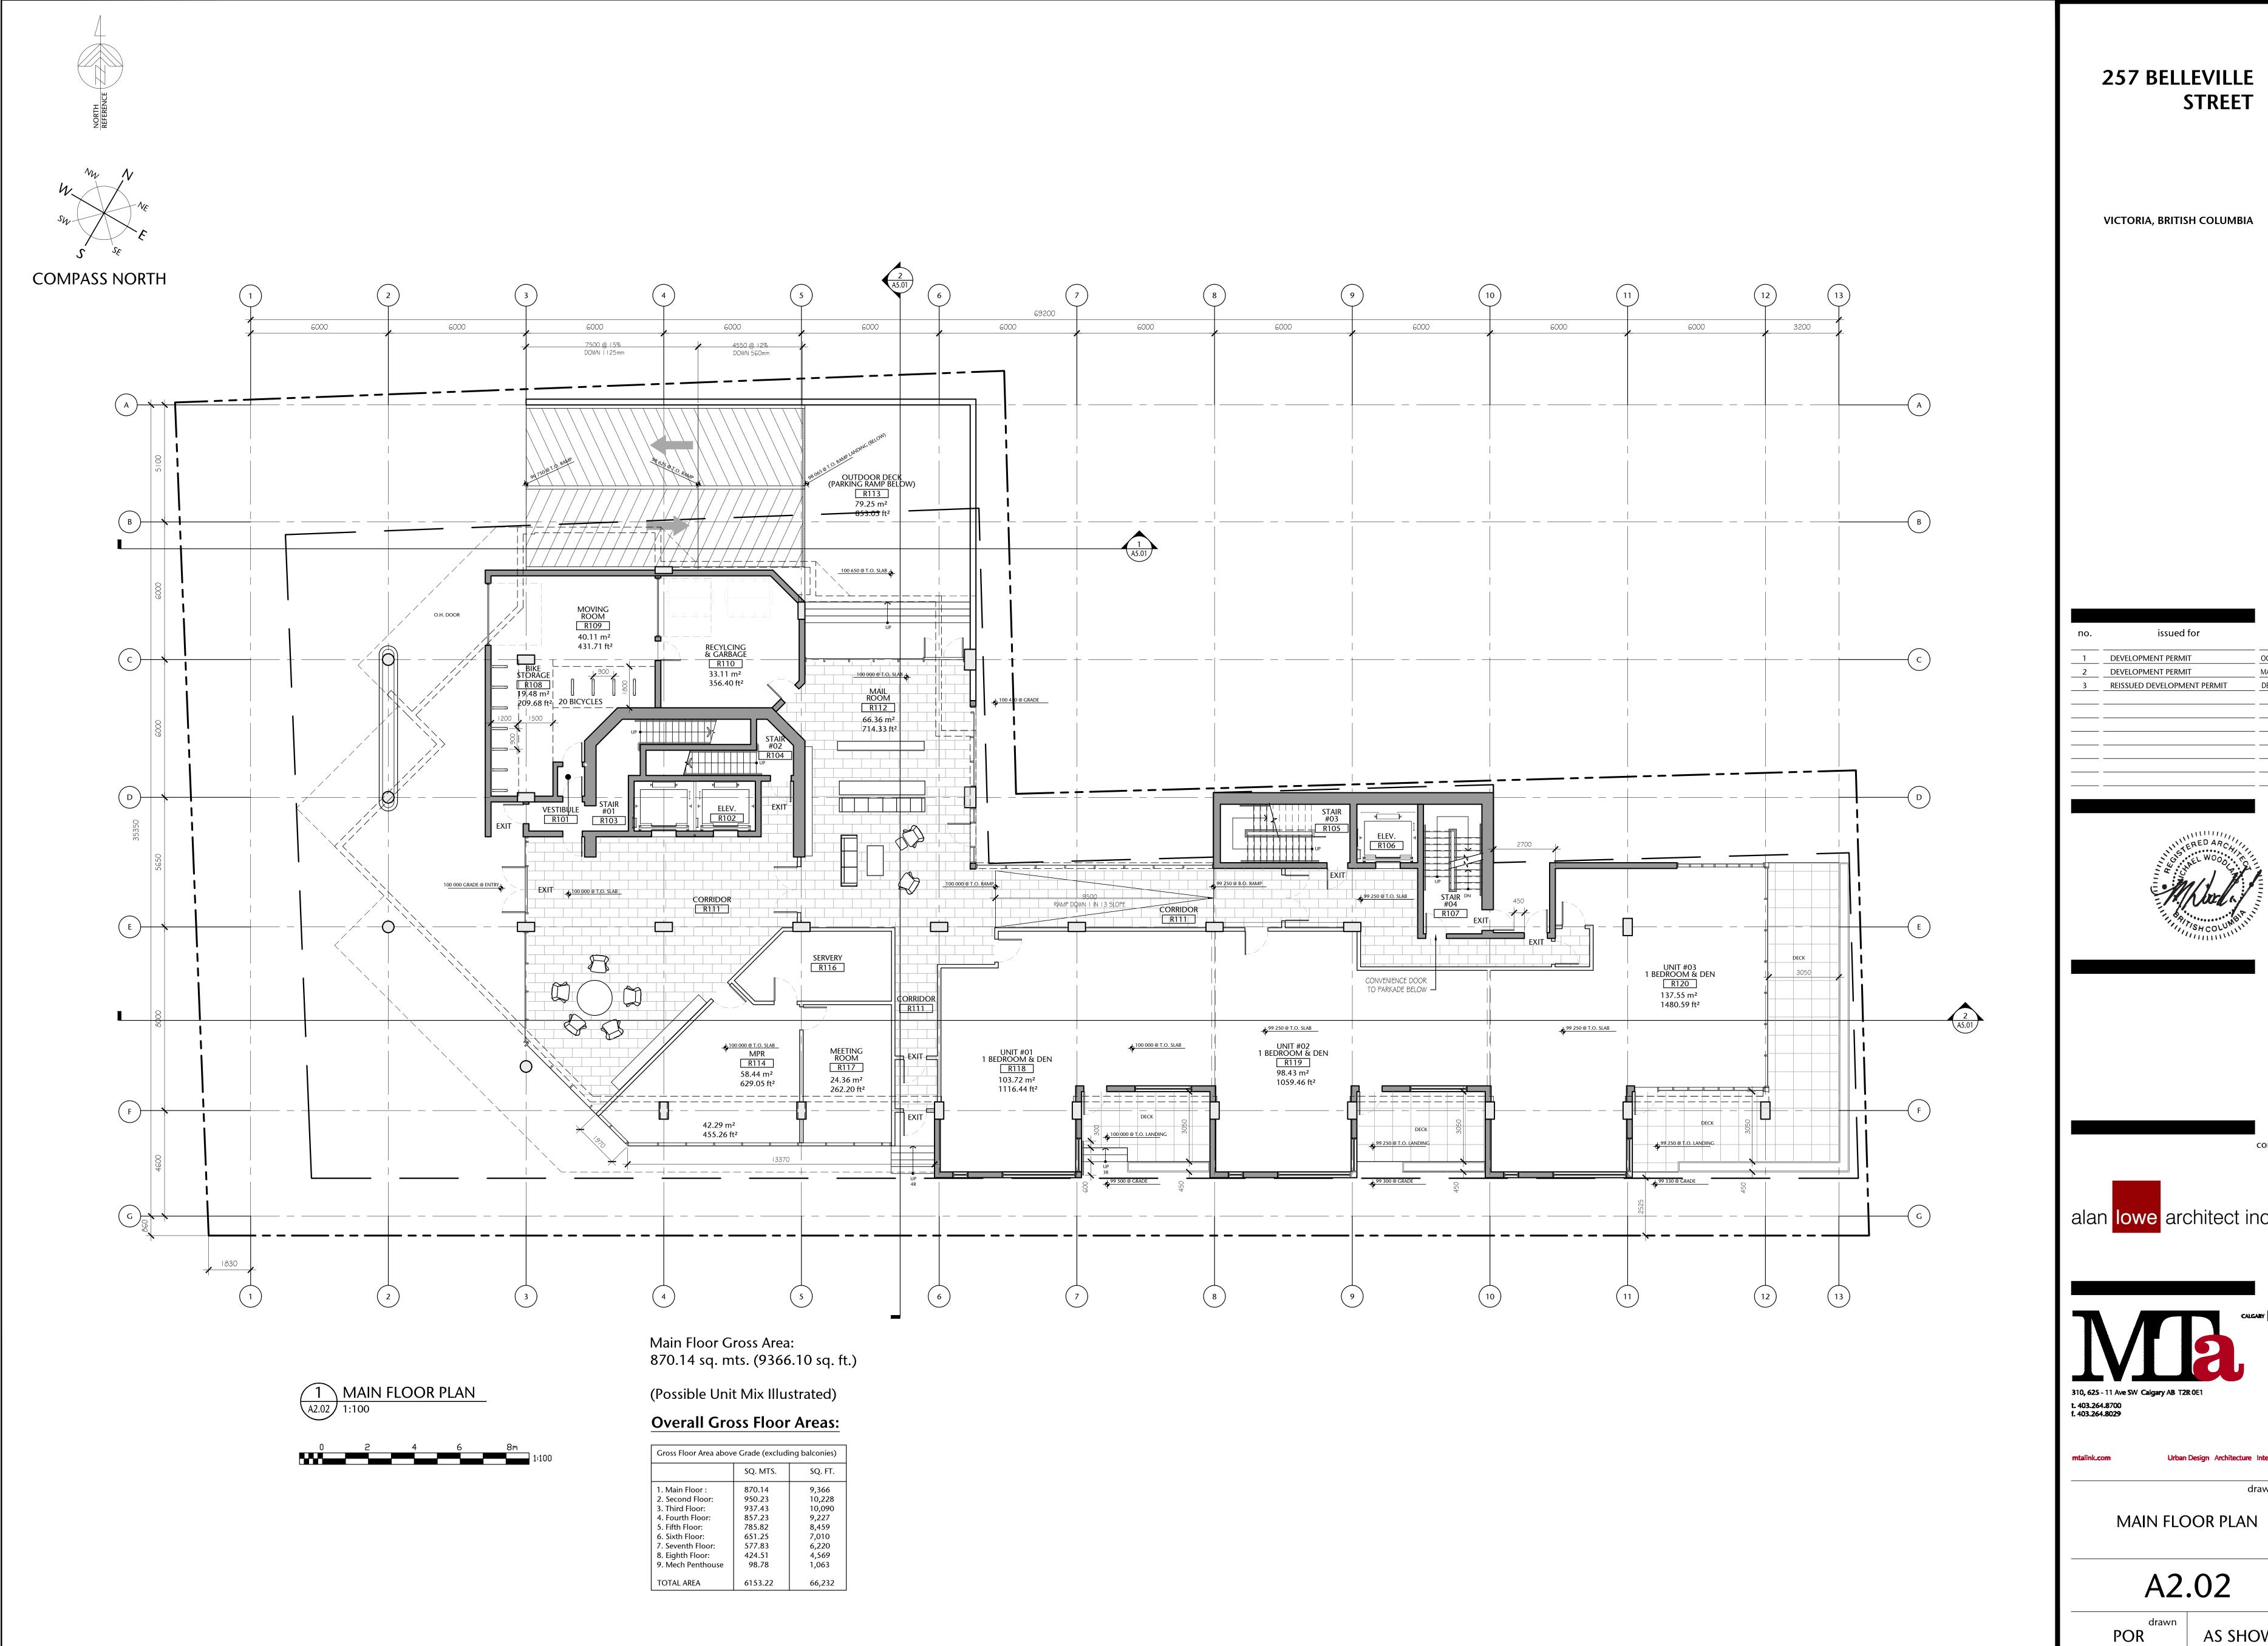

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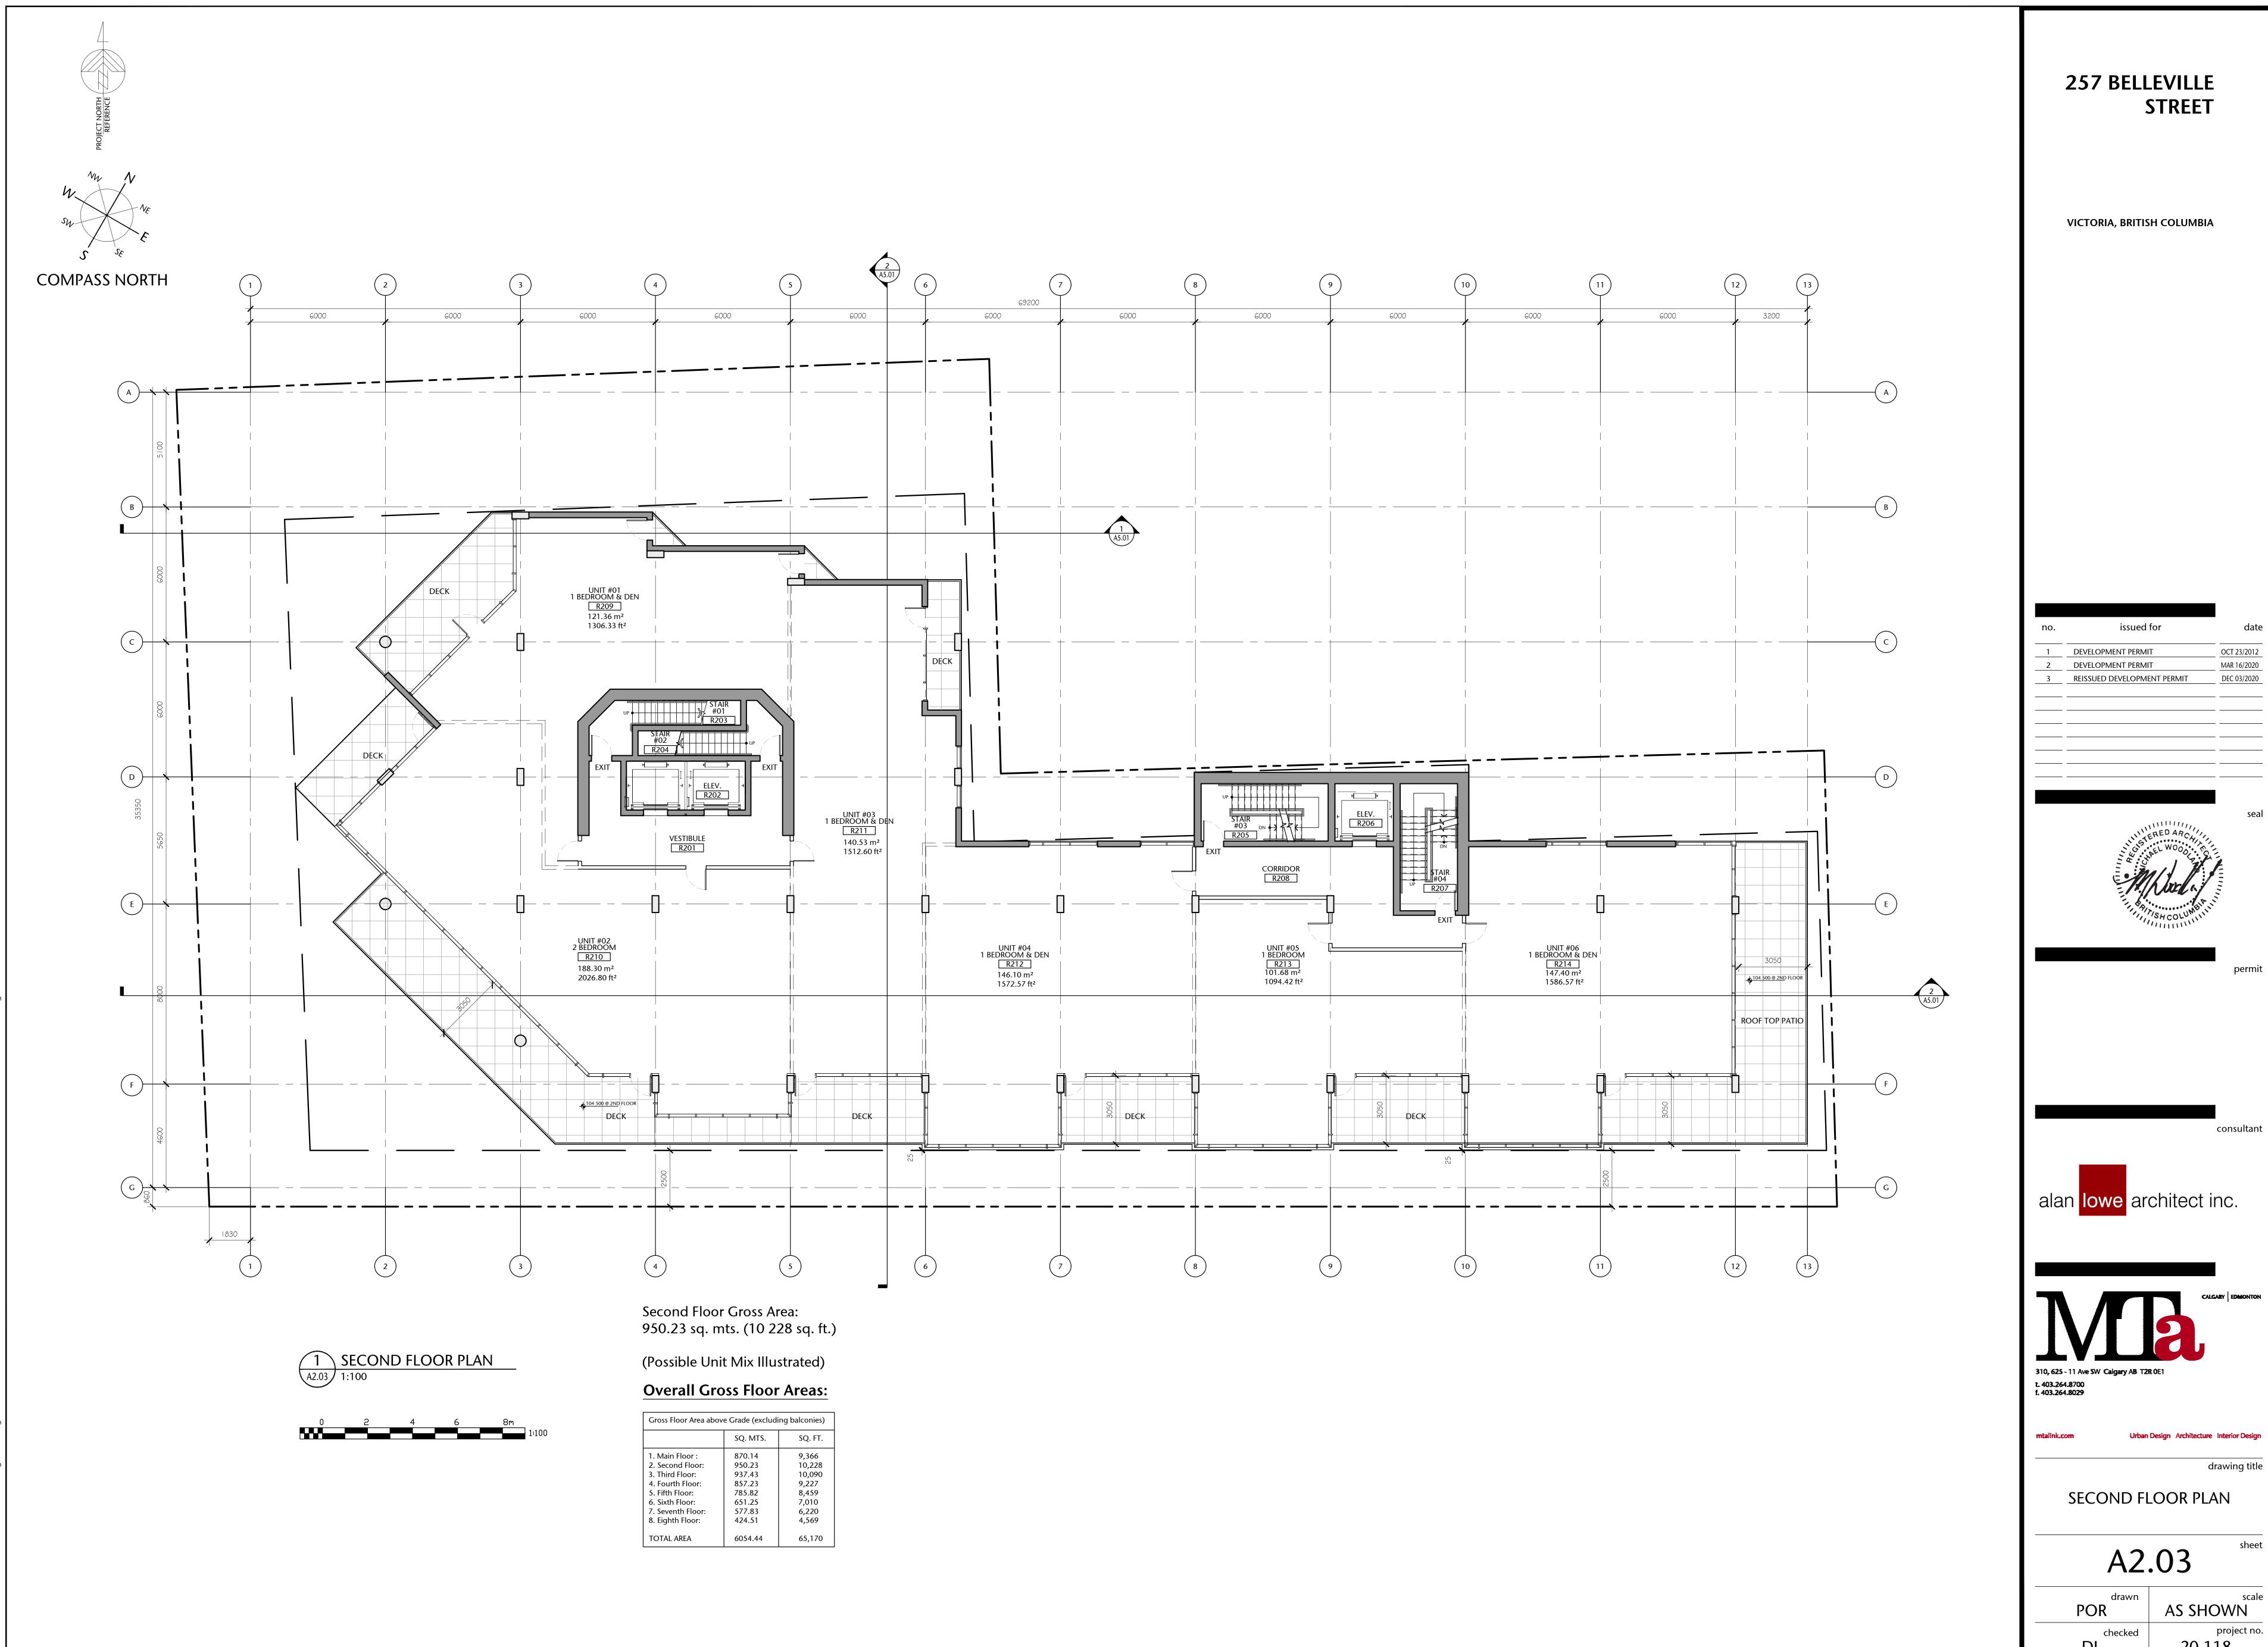
alan lowe architect inc.




Urban Design Architecture Interior Design


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AS SHOWN project no.



OCT 23/2012



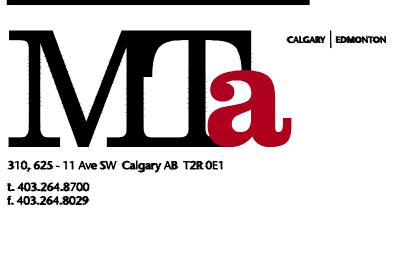

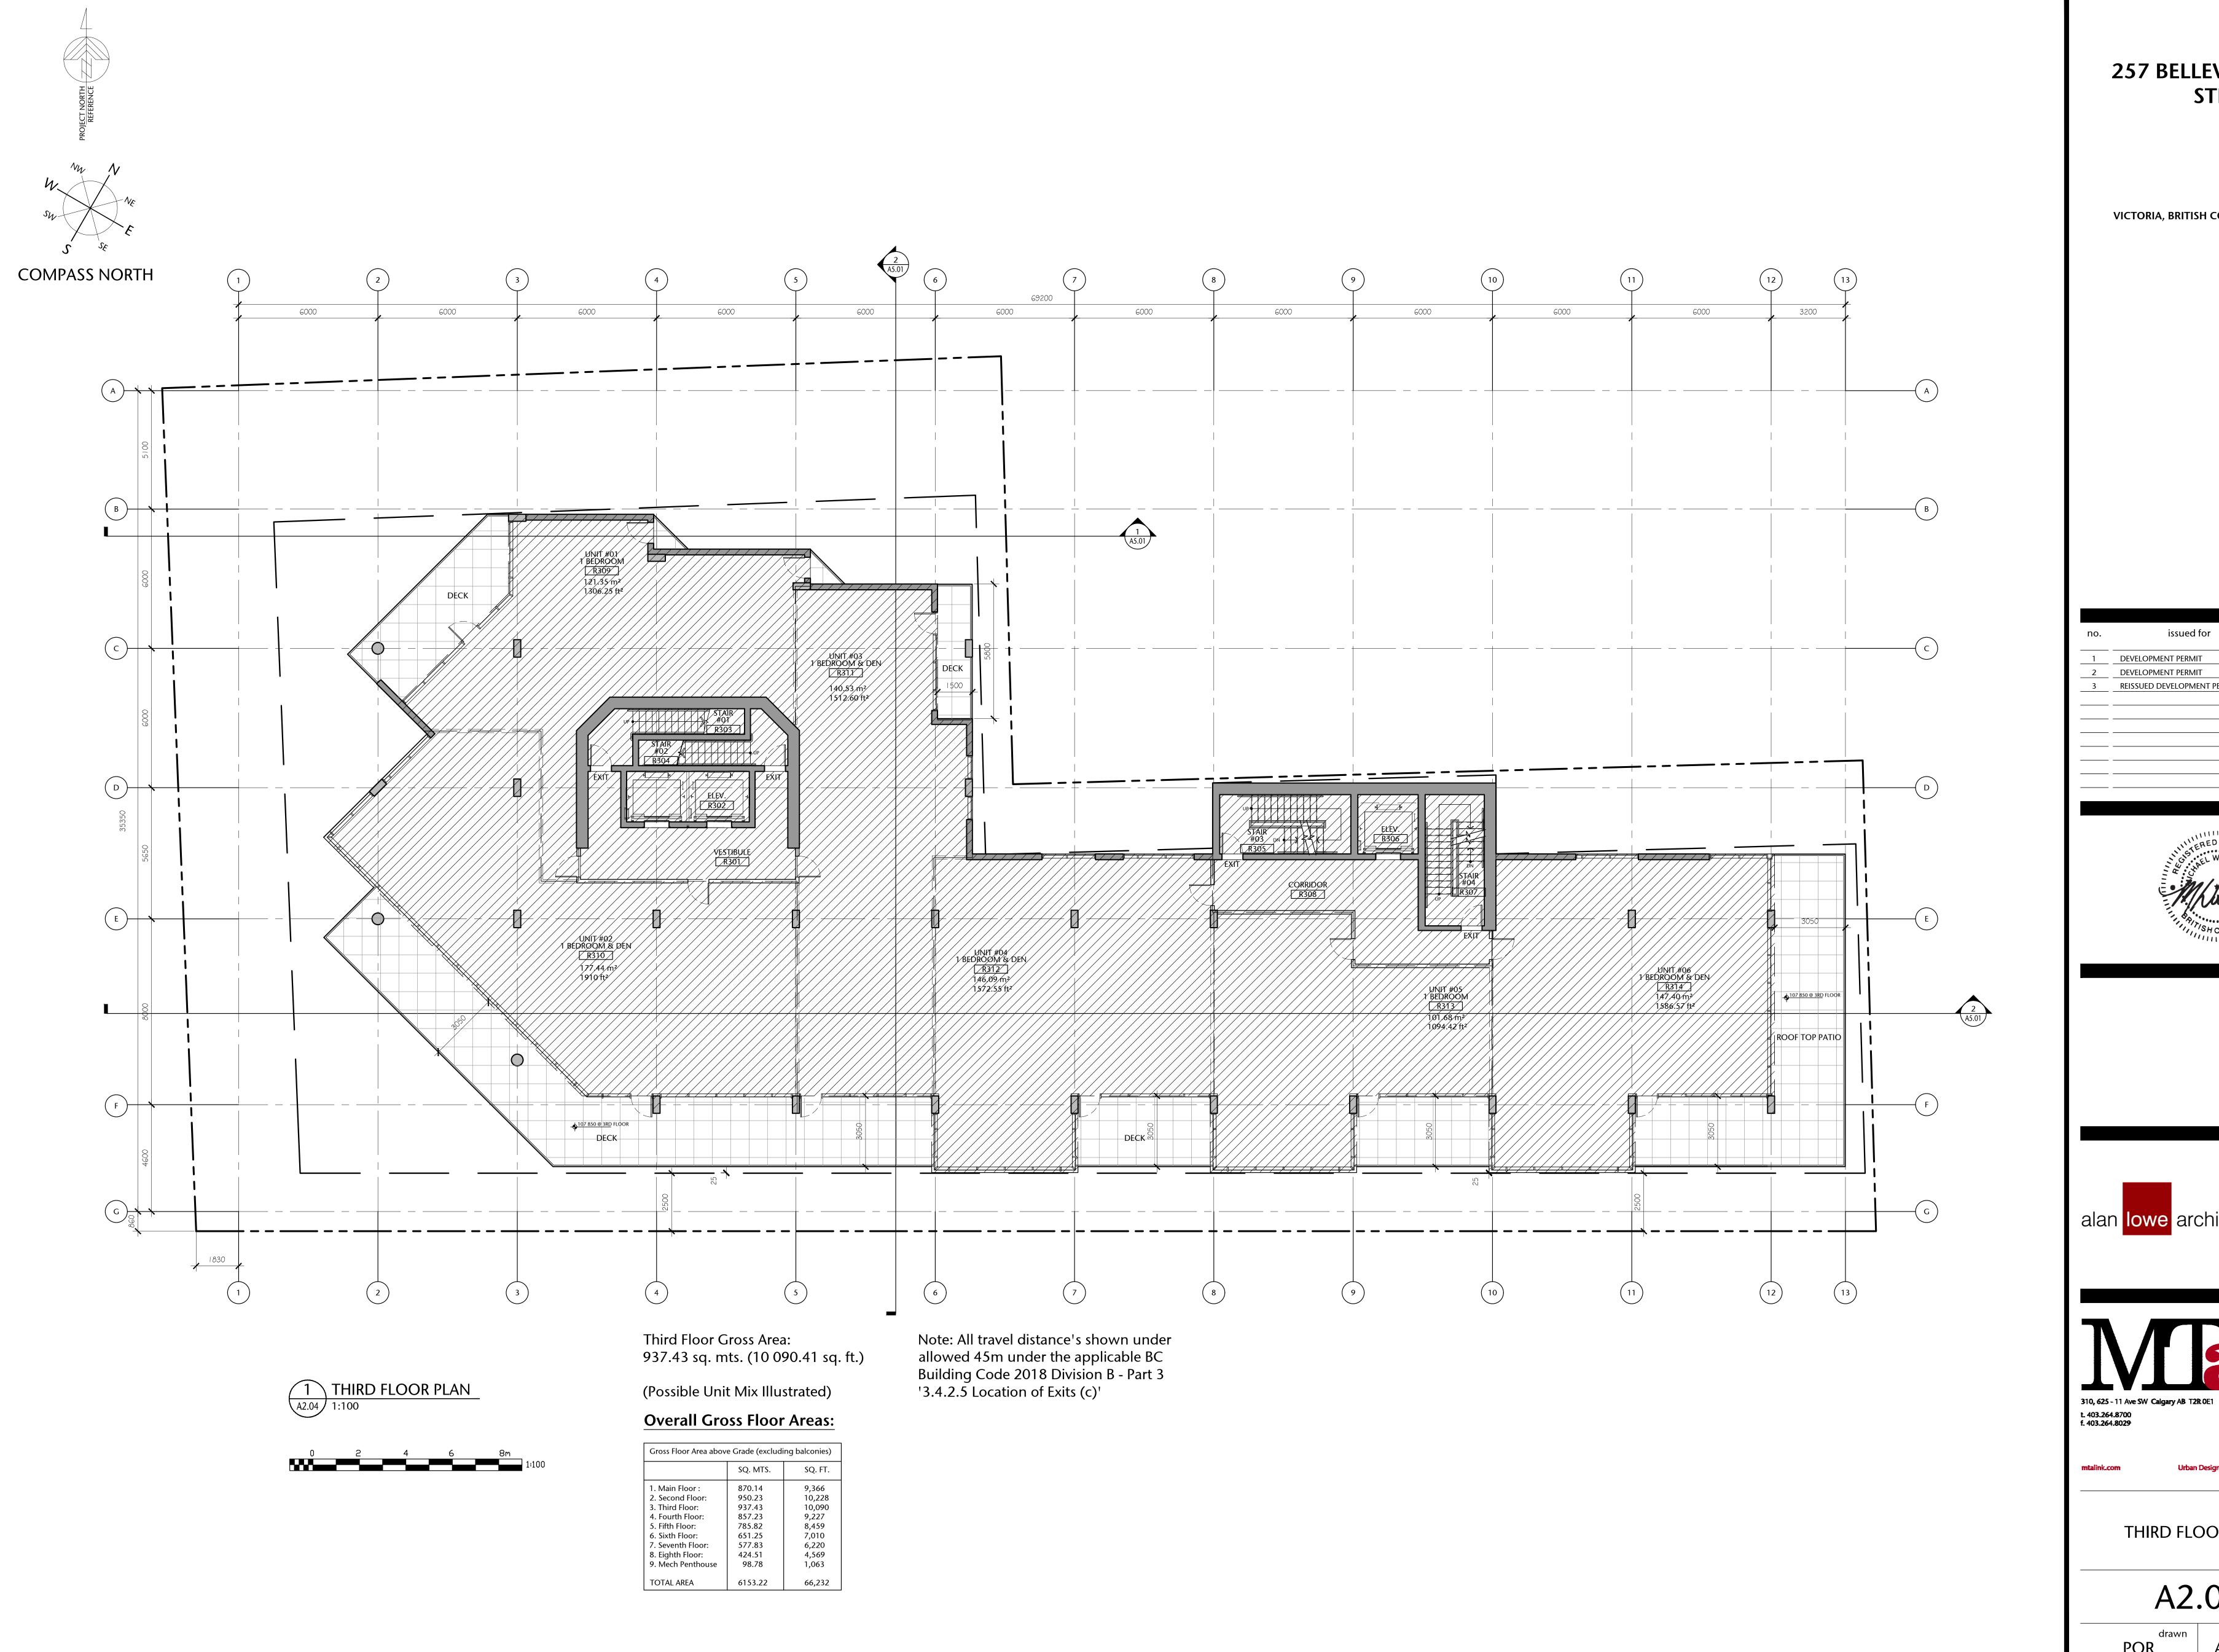VICTORIA, BRITISH COLUMBIA

no.	issued for	date
1	DEVELOPMENT PERMIT	OCT 23/2012
2	DEVELOPMENT PERMIT	MAR 16/2020
3	REISSUED DEVELOPMENT PERMIT	DEC 03/2020








drawing title

THIRD FLOOR PLAN


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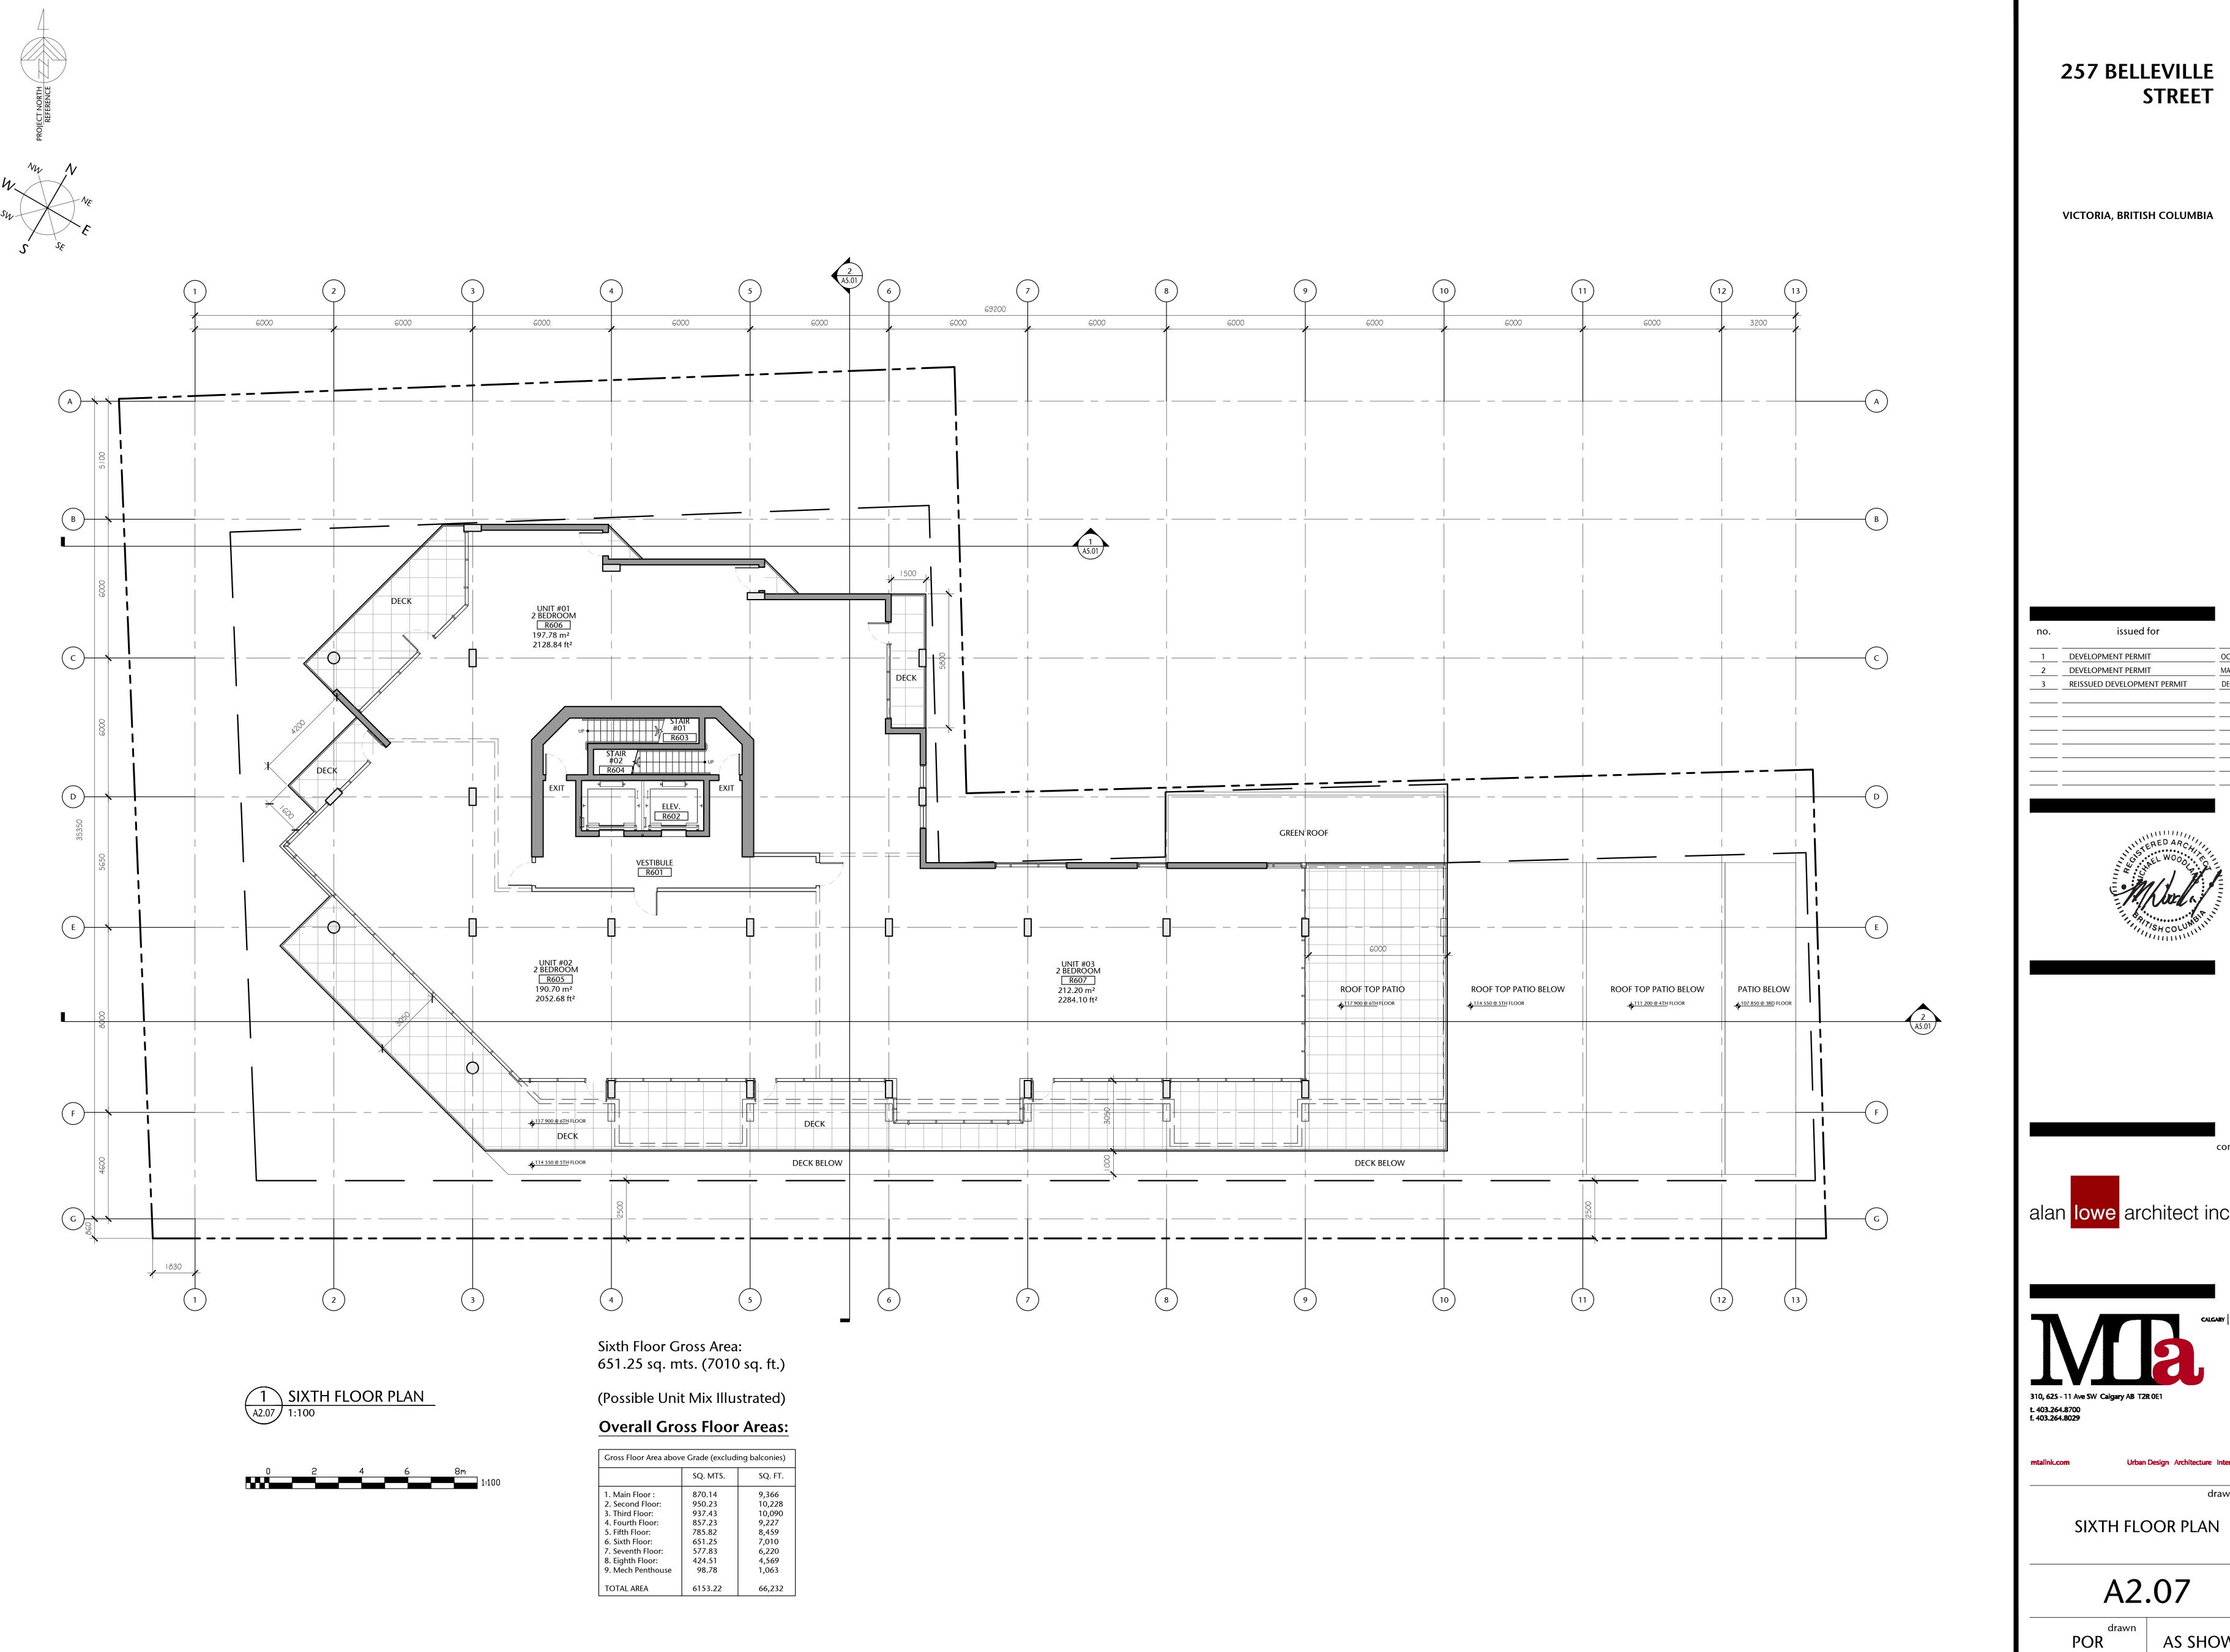
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drawing title

FIFTH FLOOR PLAN

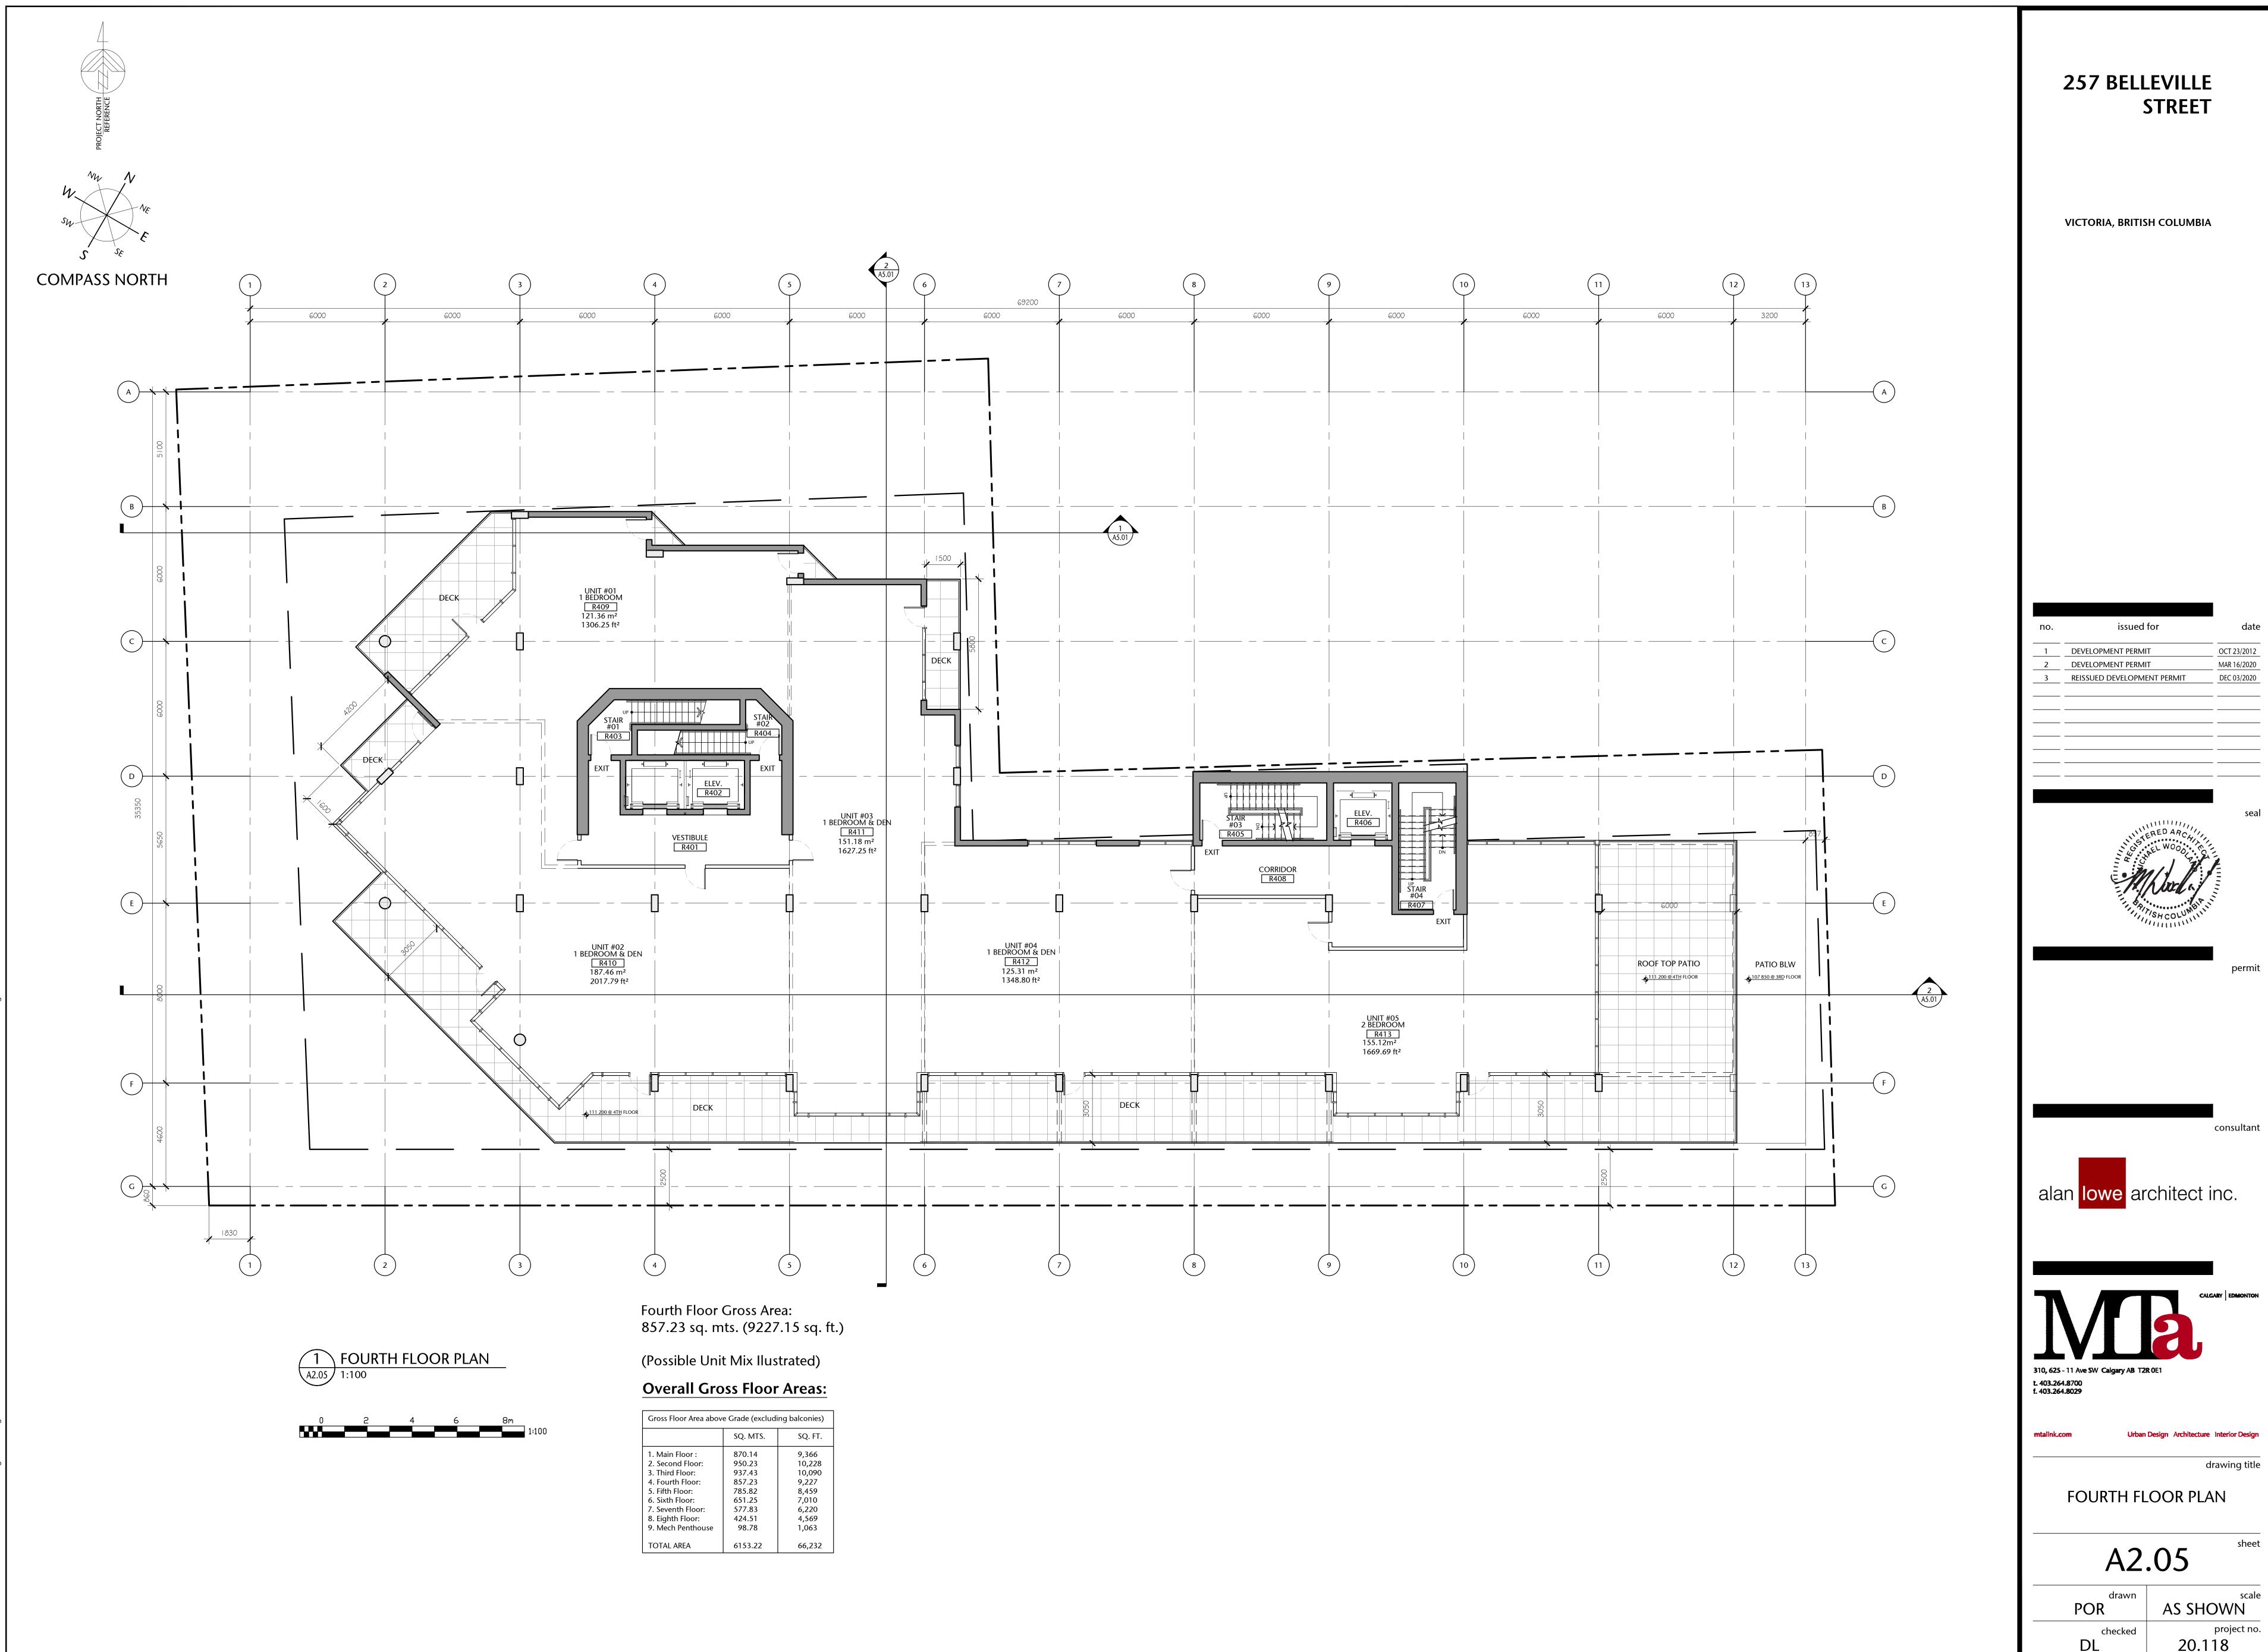A2.06

AS SHOWN

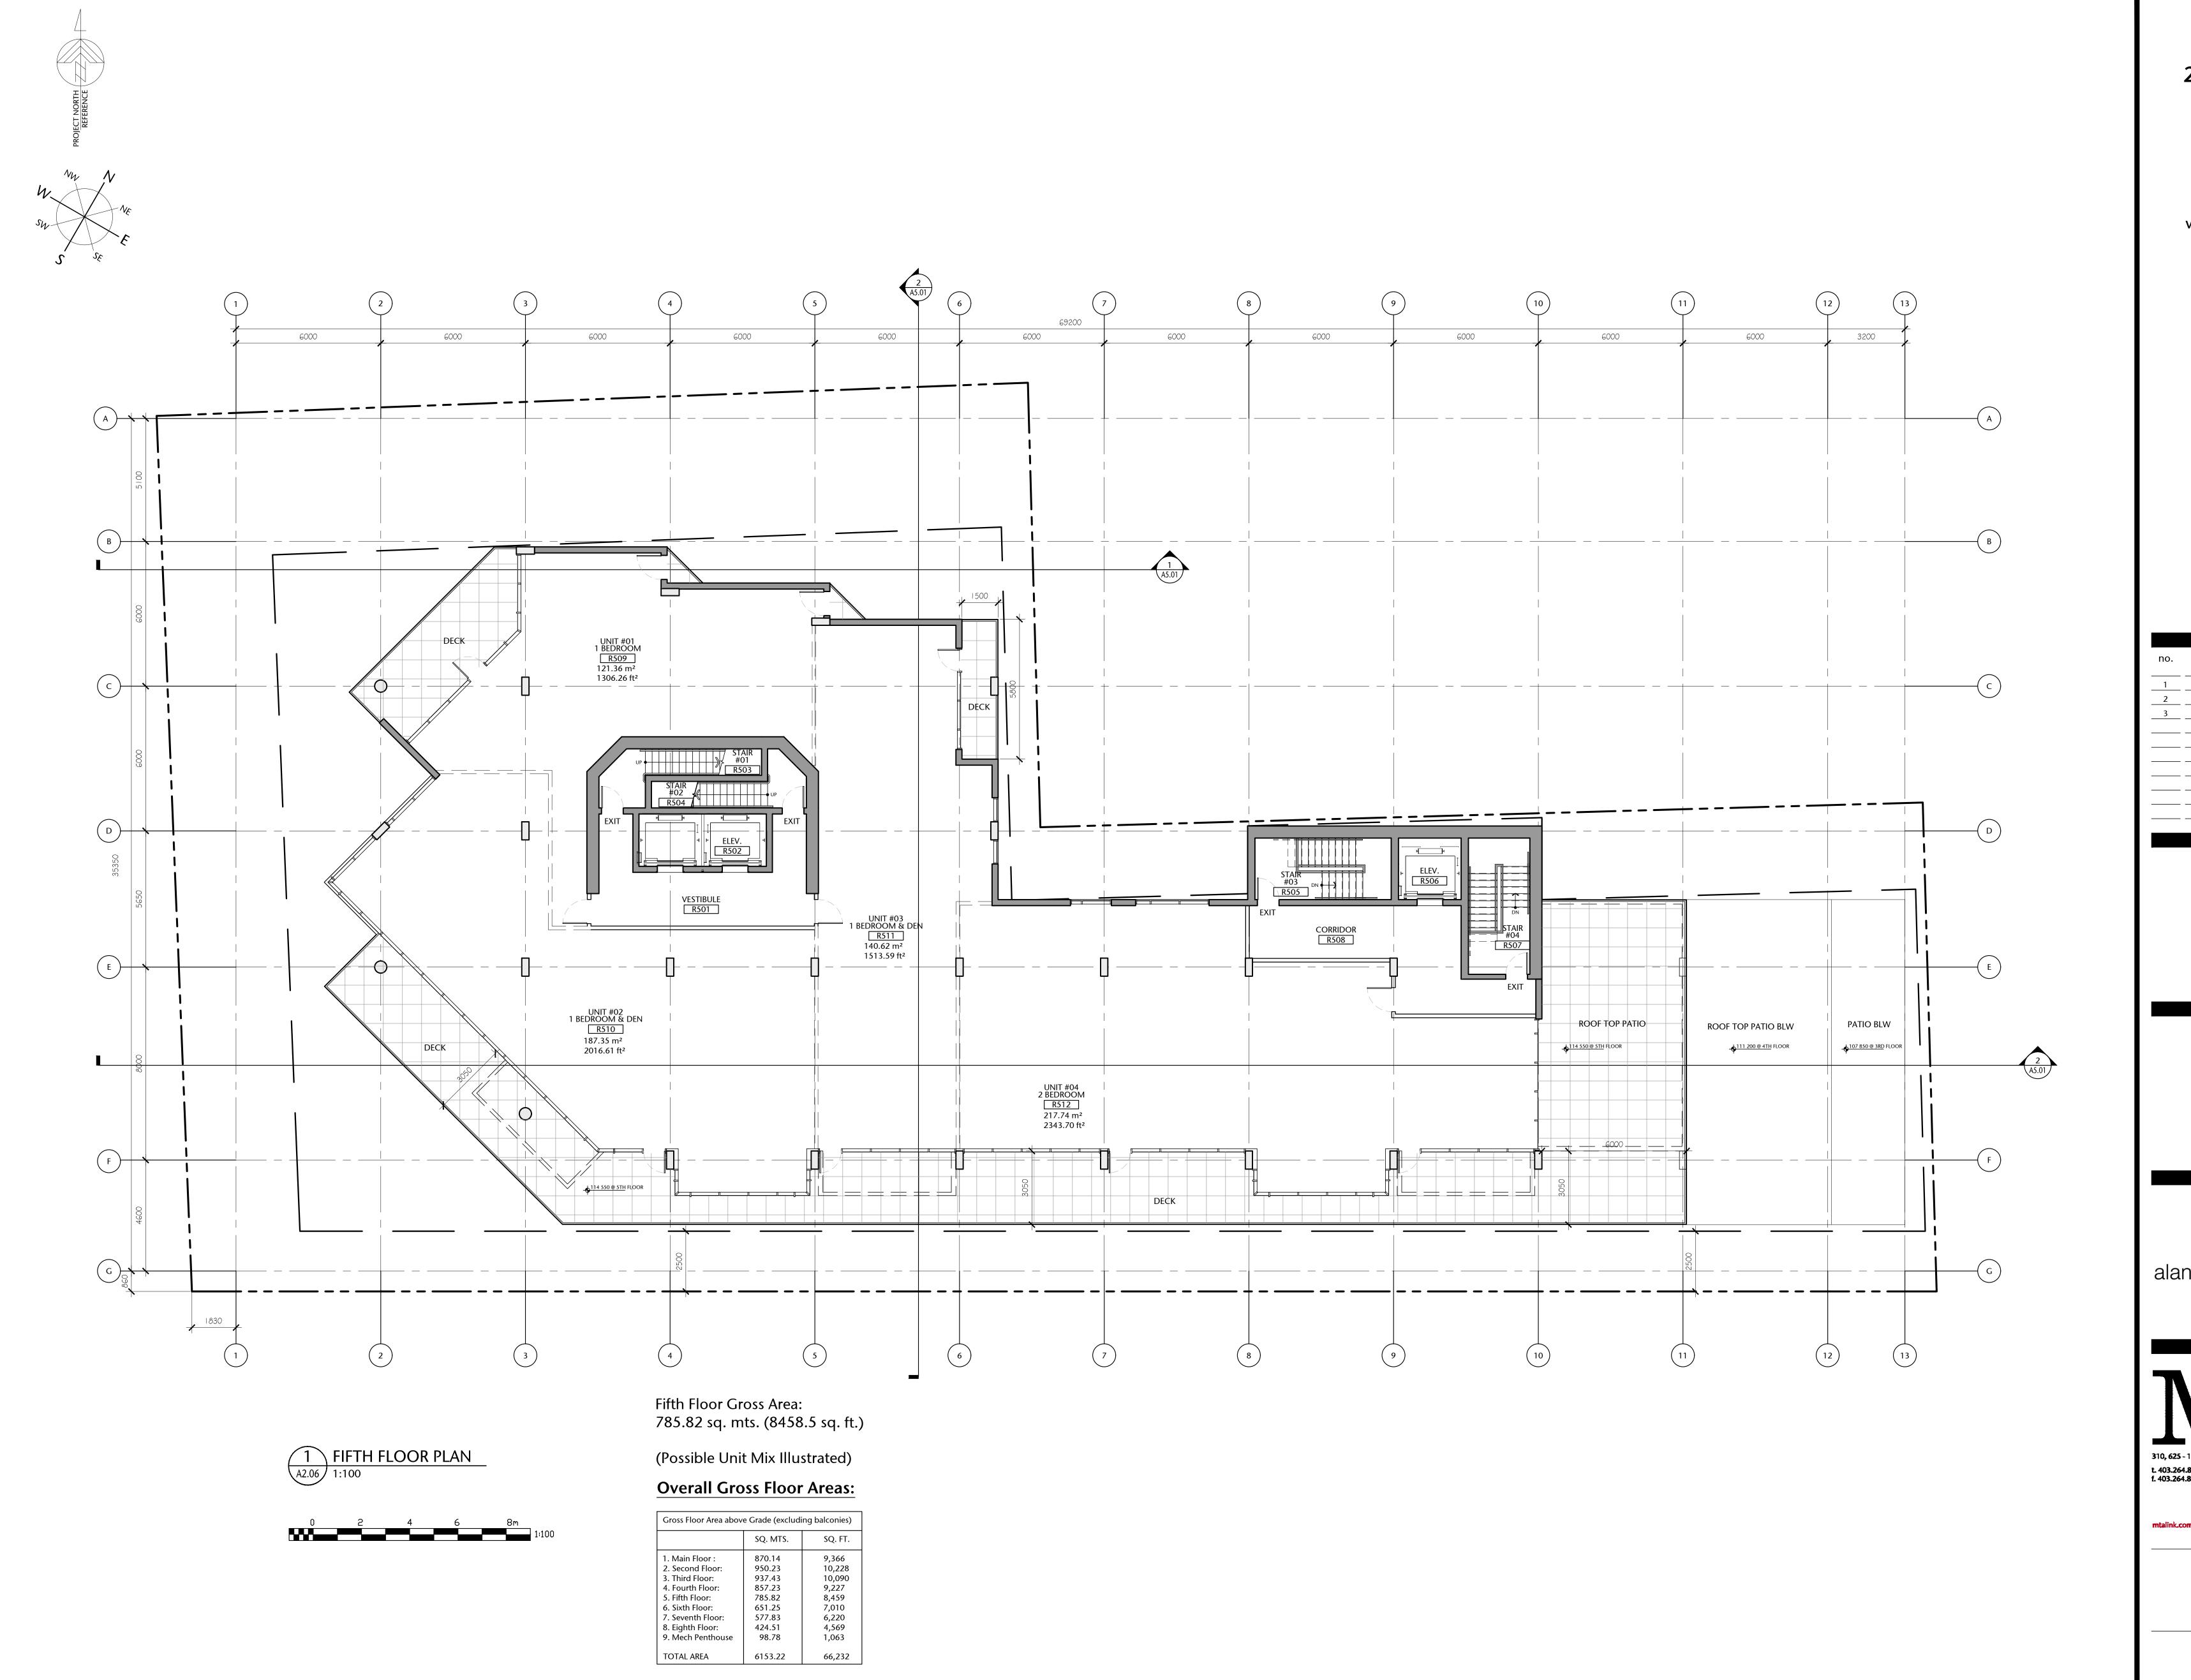


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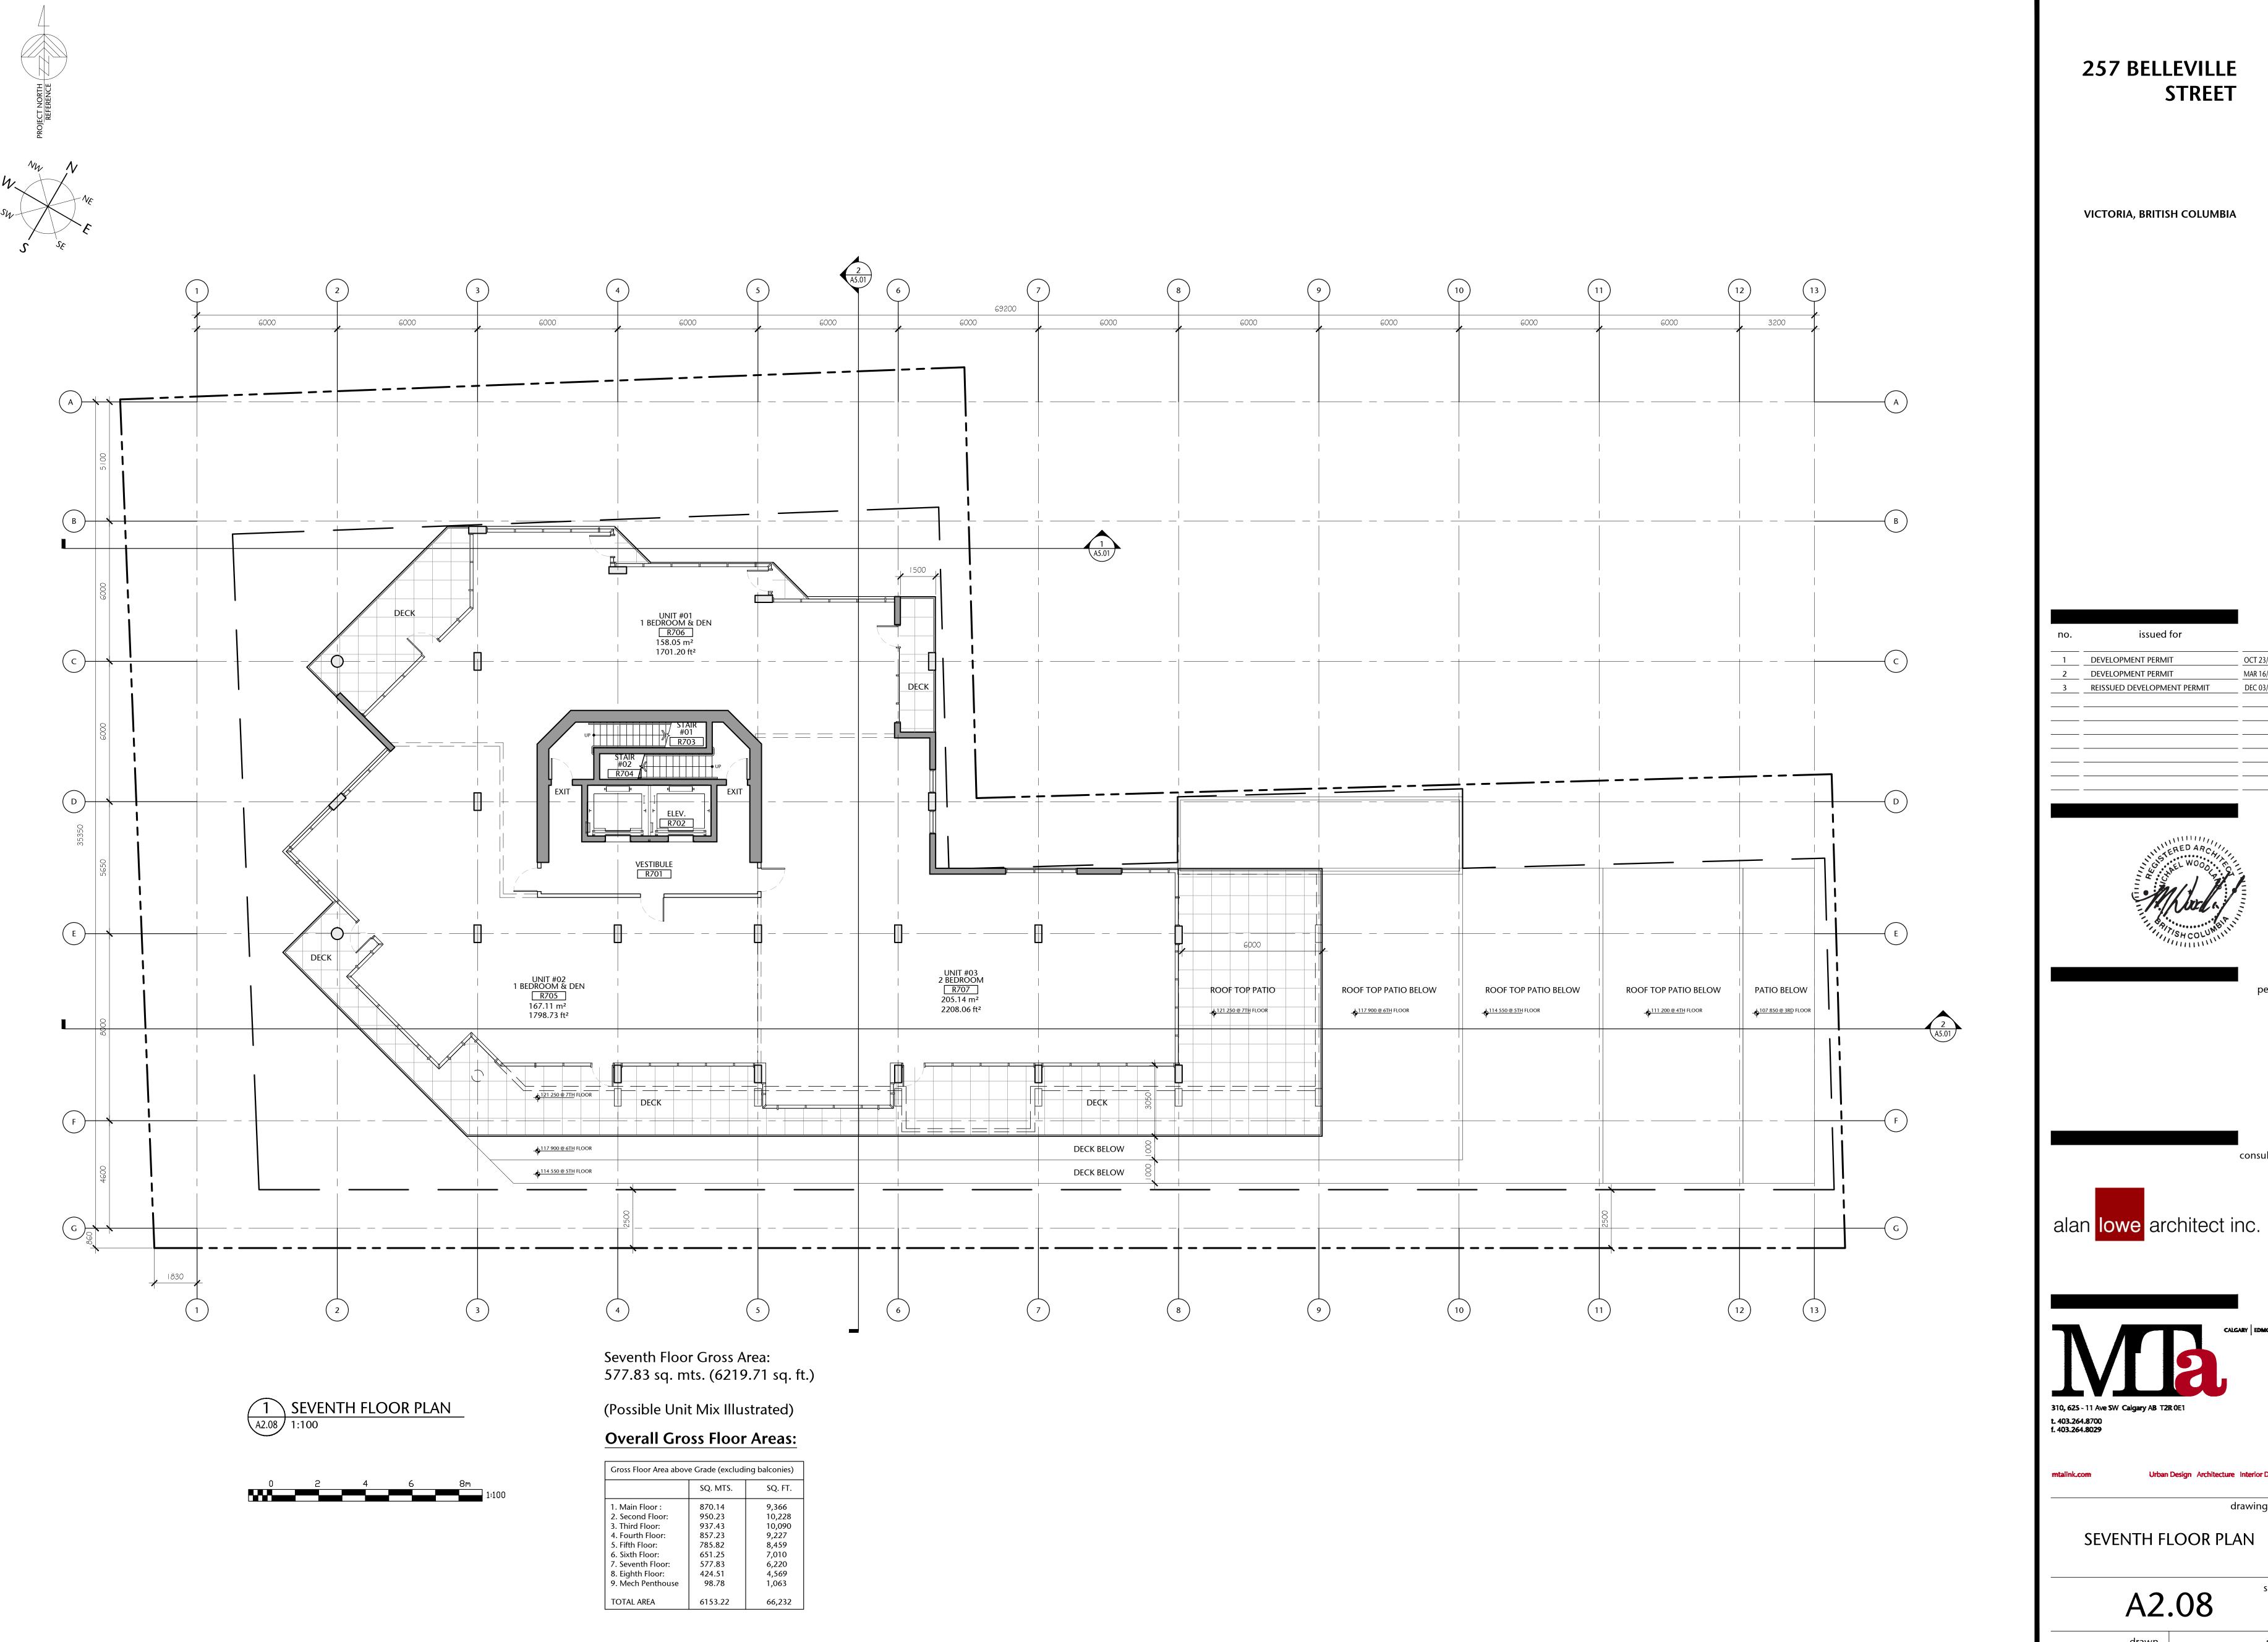
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Urban Design Architecture Interior Design

drawing title

AS SHOWN project no.



VICTORIA, BRITISH COLUMBIA

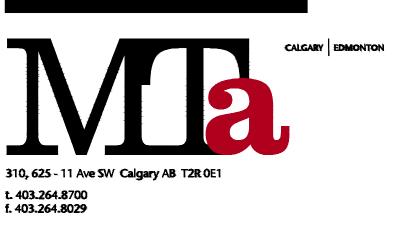OCT 23/2012 DEVELOPMENT PERMIT MAR 16/2020 DEC 03/2020 DEVELOPMENT PERMIT REISSUED DEVELOPMENT PERMIT






Urban Design Architecture Interior Design

drawing title


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AS SHOWN project no.

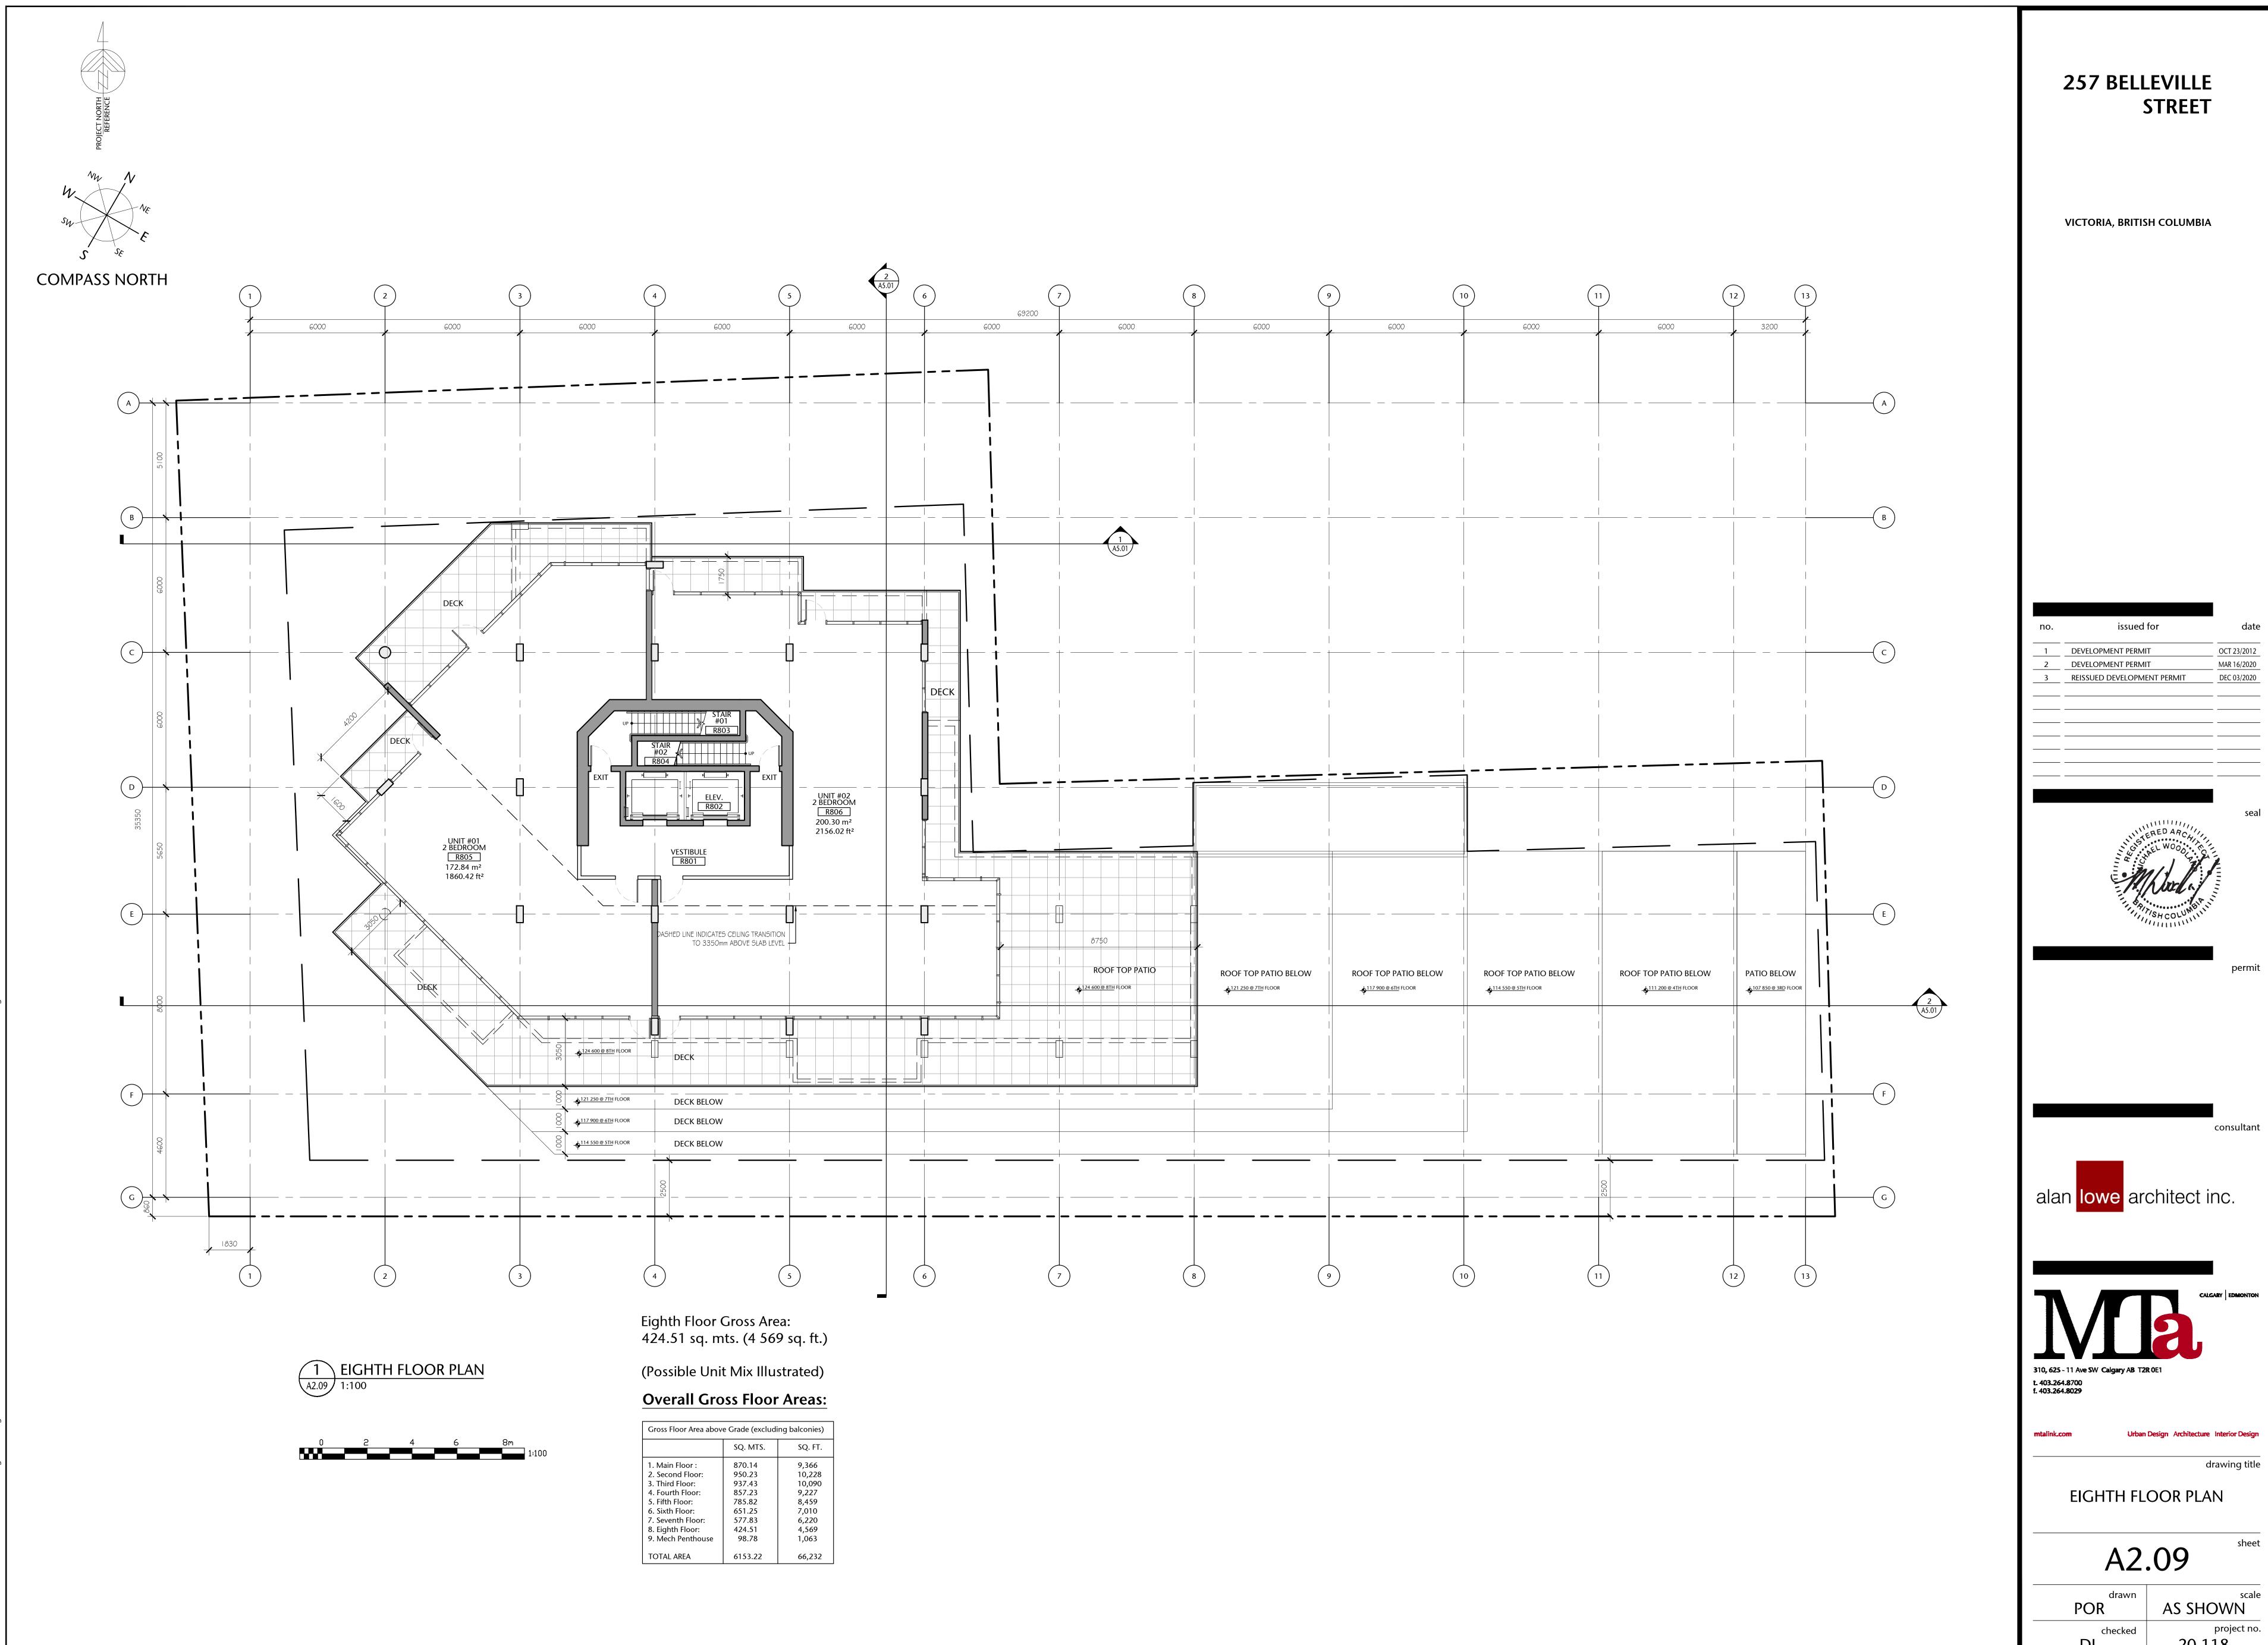

OCT 23/2012 MAR 16/2020 DEC 03/2020



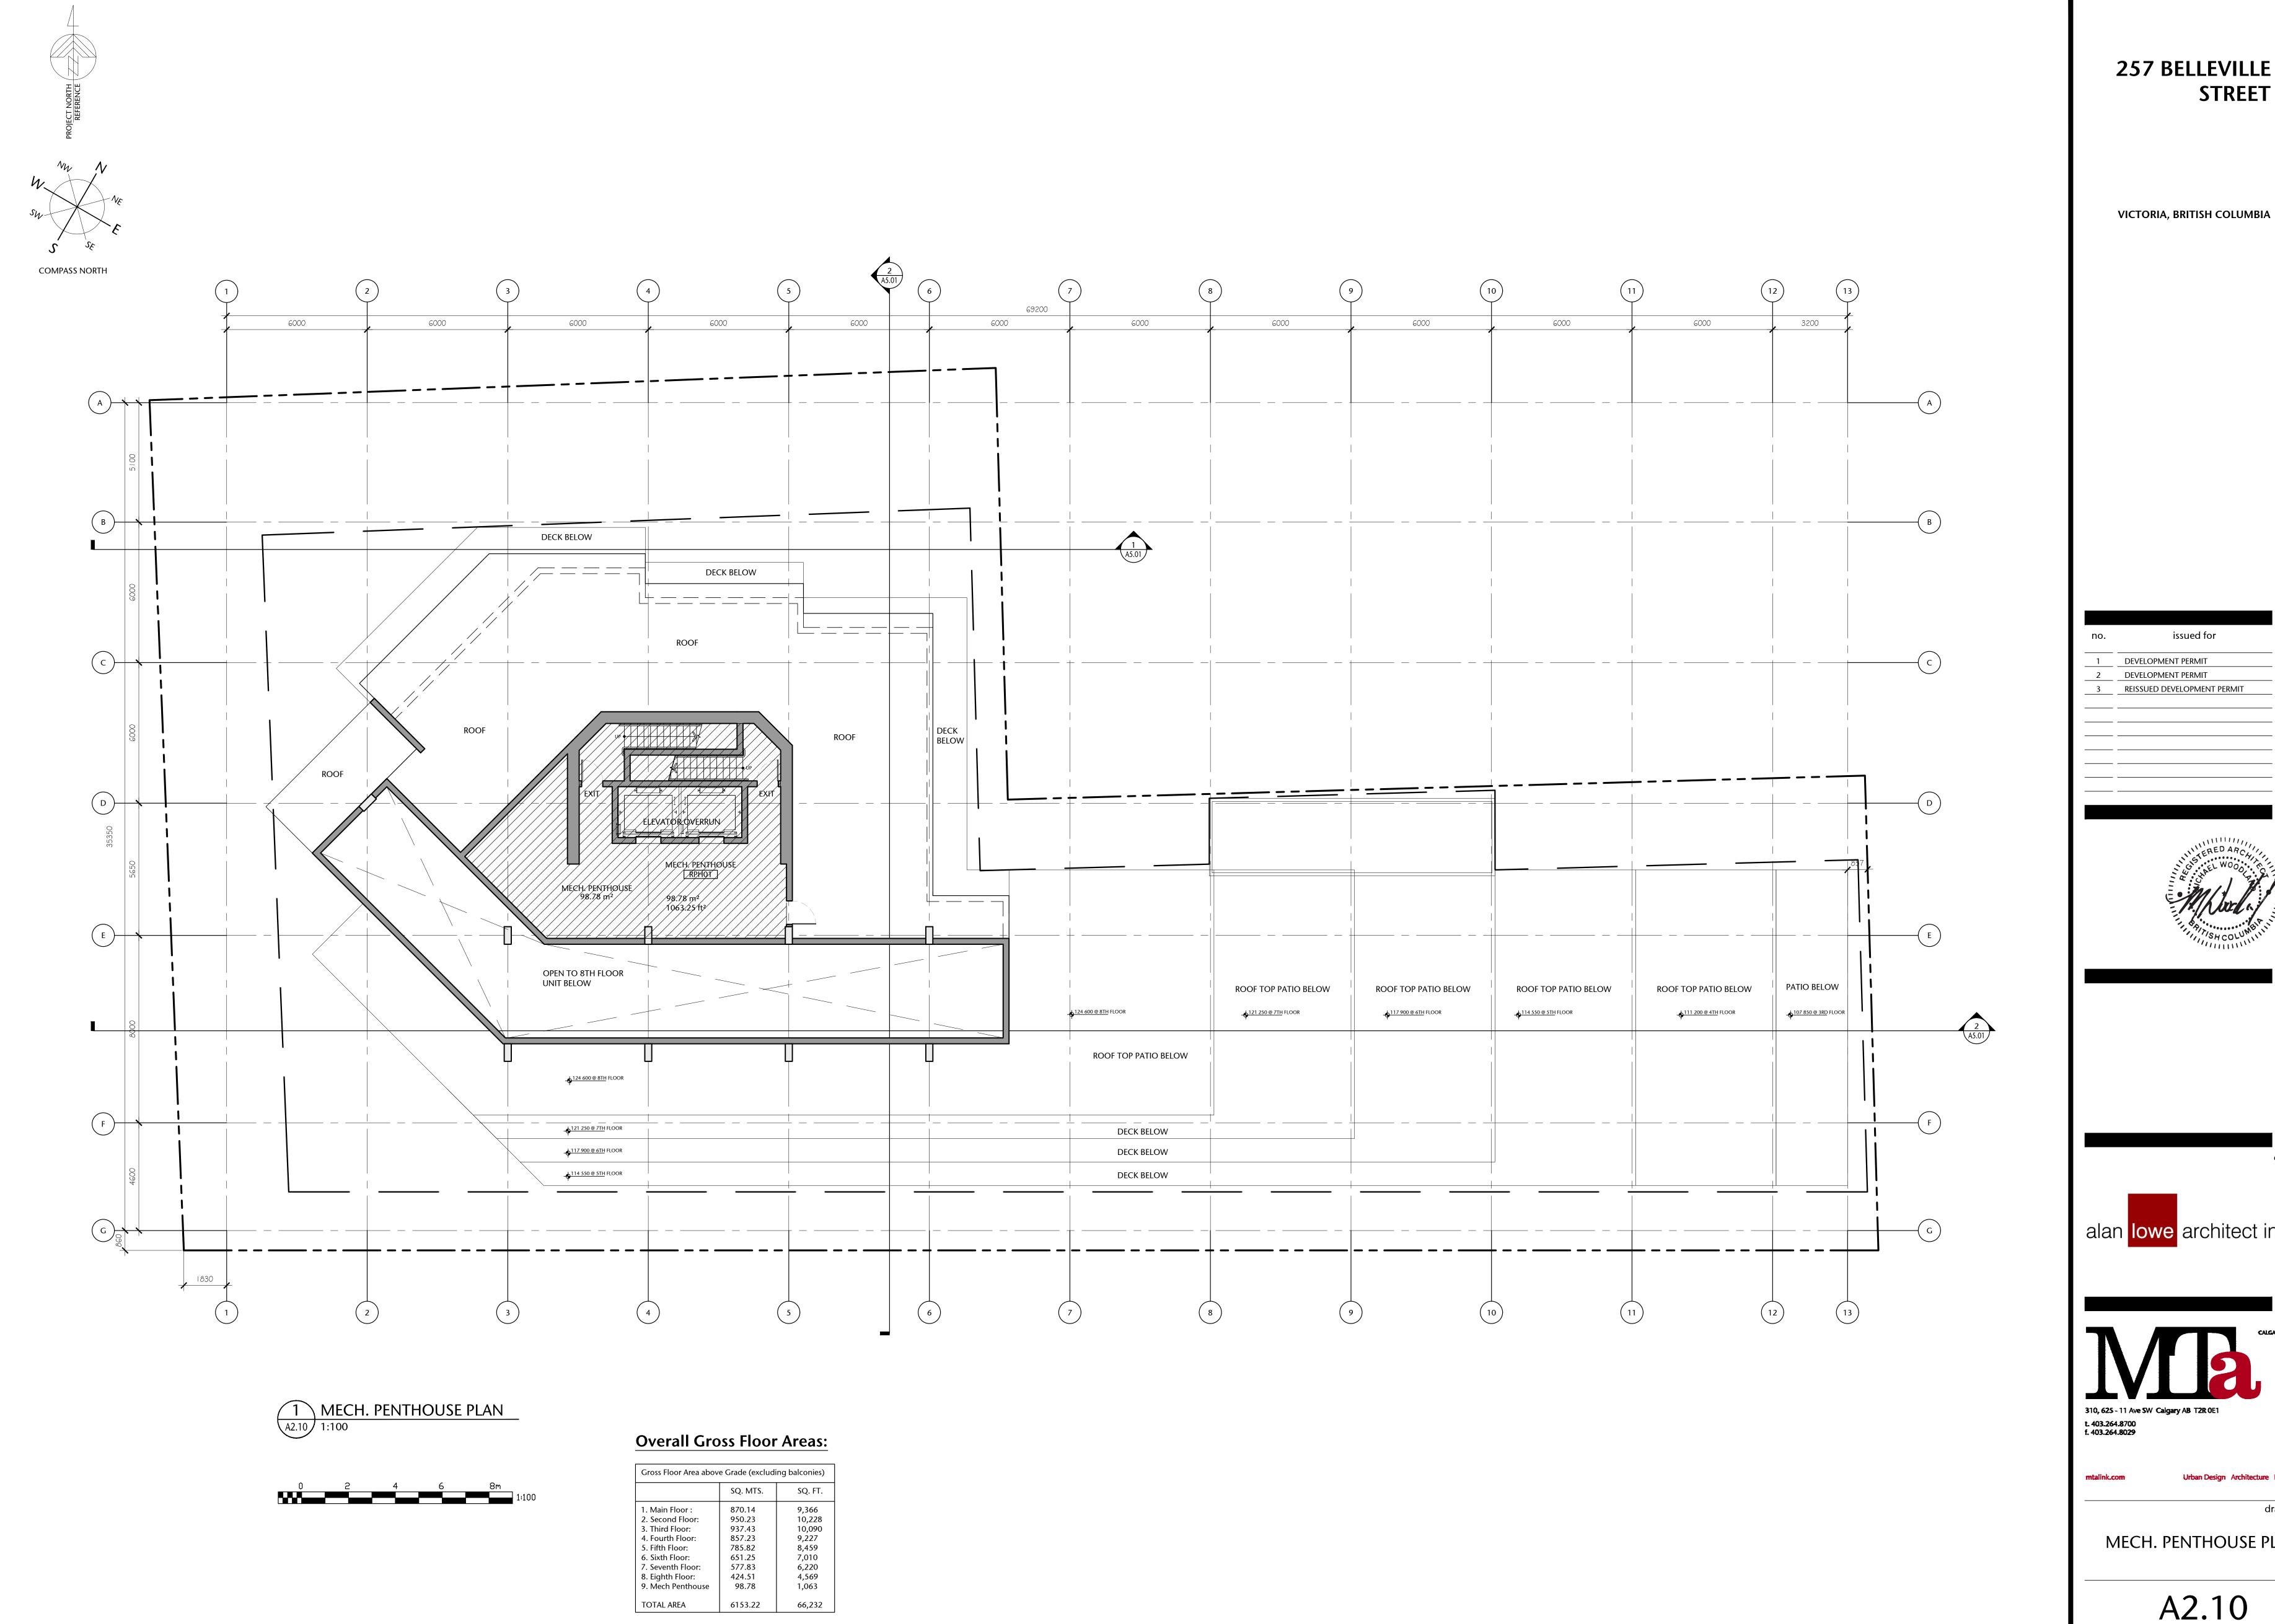

OCT 23/2012 MAR 16/2020 DEC 03/2020 REISSUED DEVELOPMENT PERMIT



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drawing title

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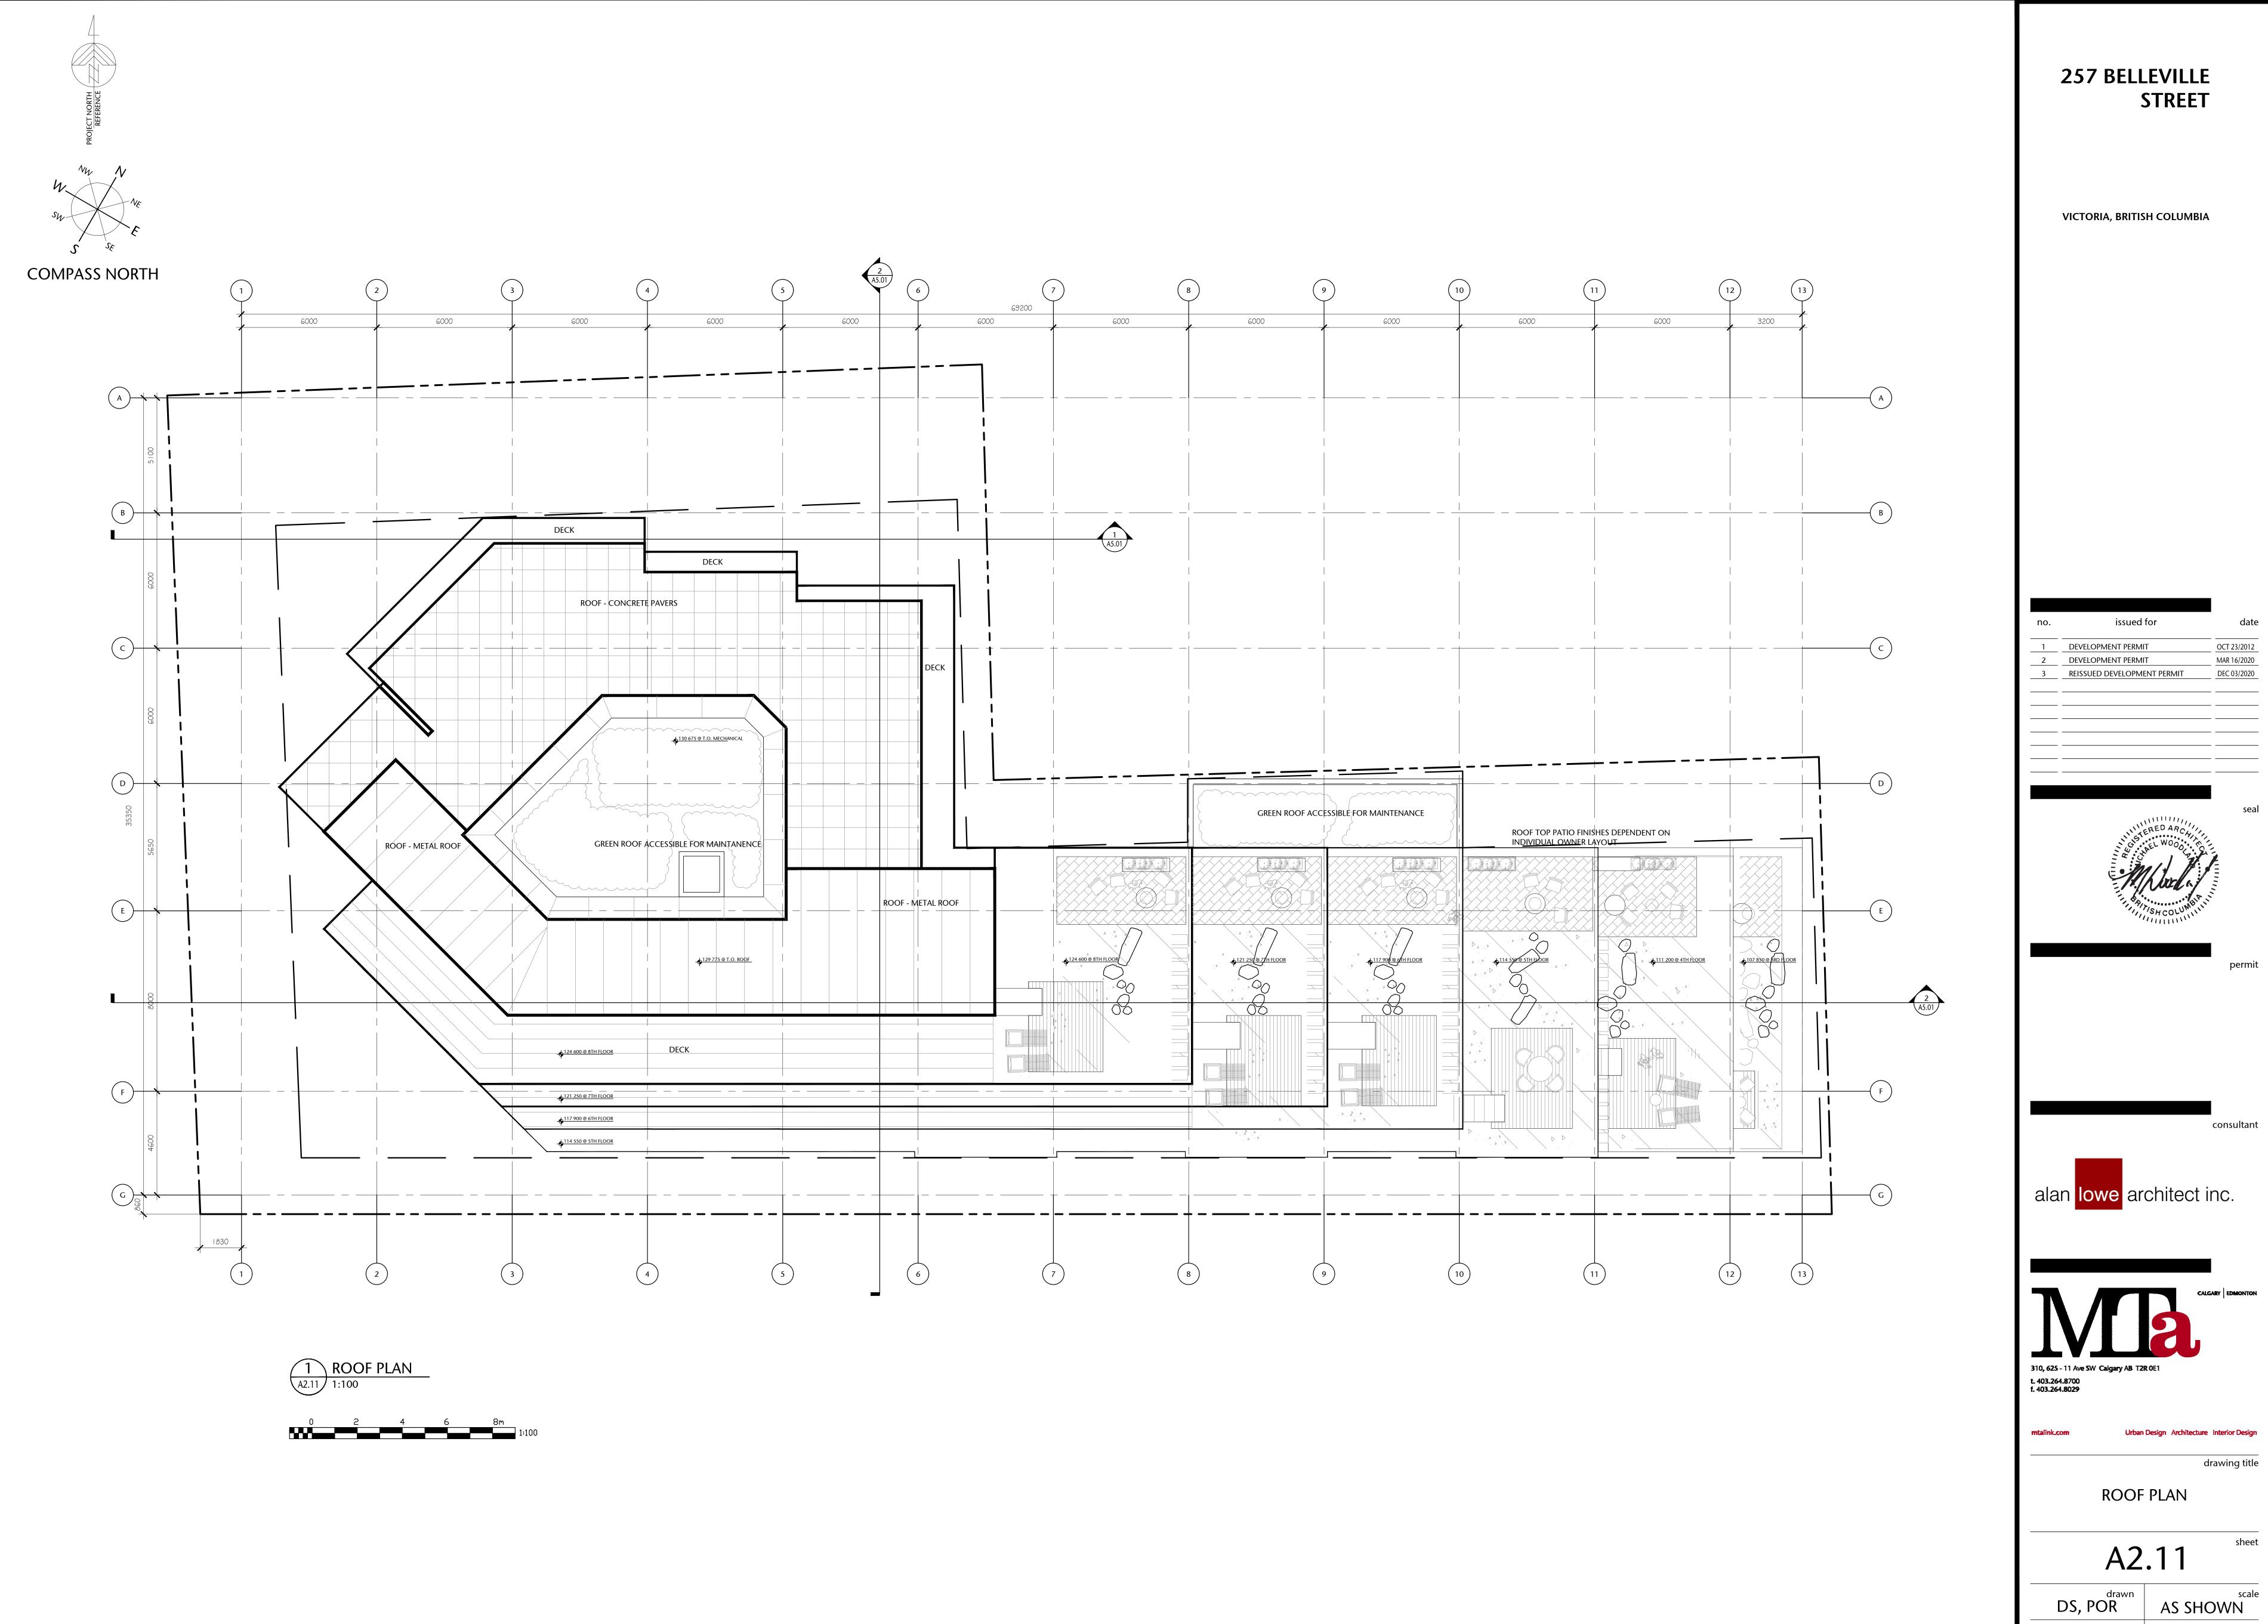


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MECH. PENTHOUSE PLAN

A2.10

AS SHOWN project no.




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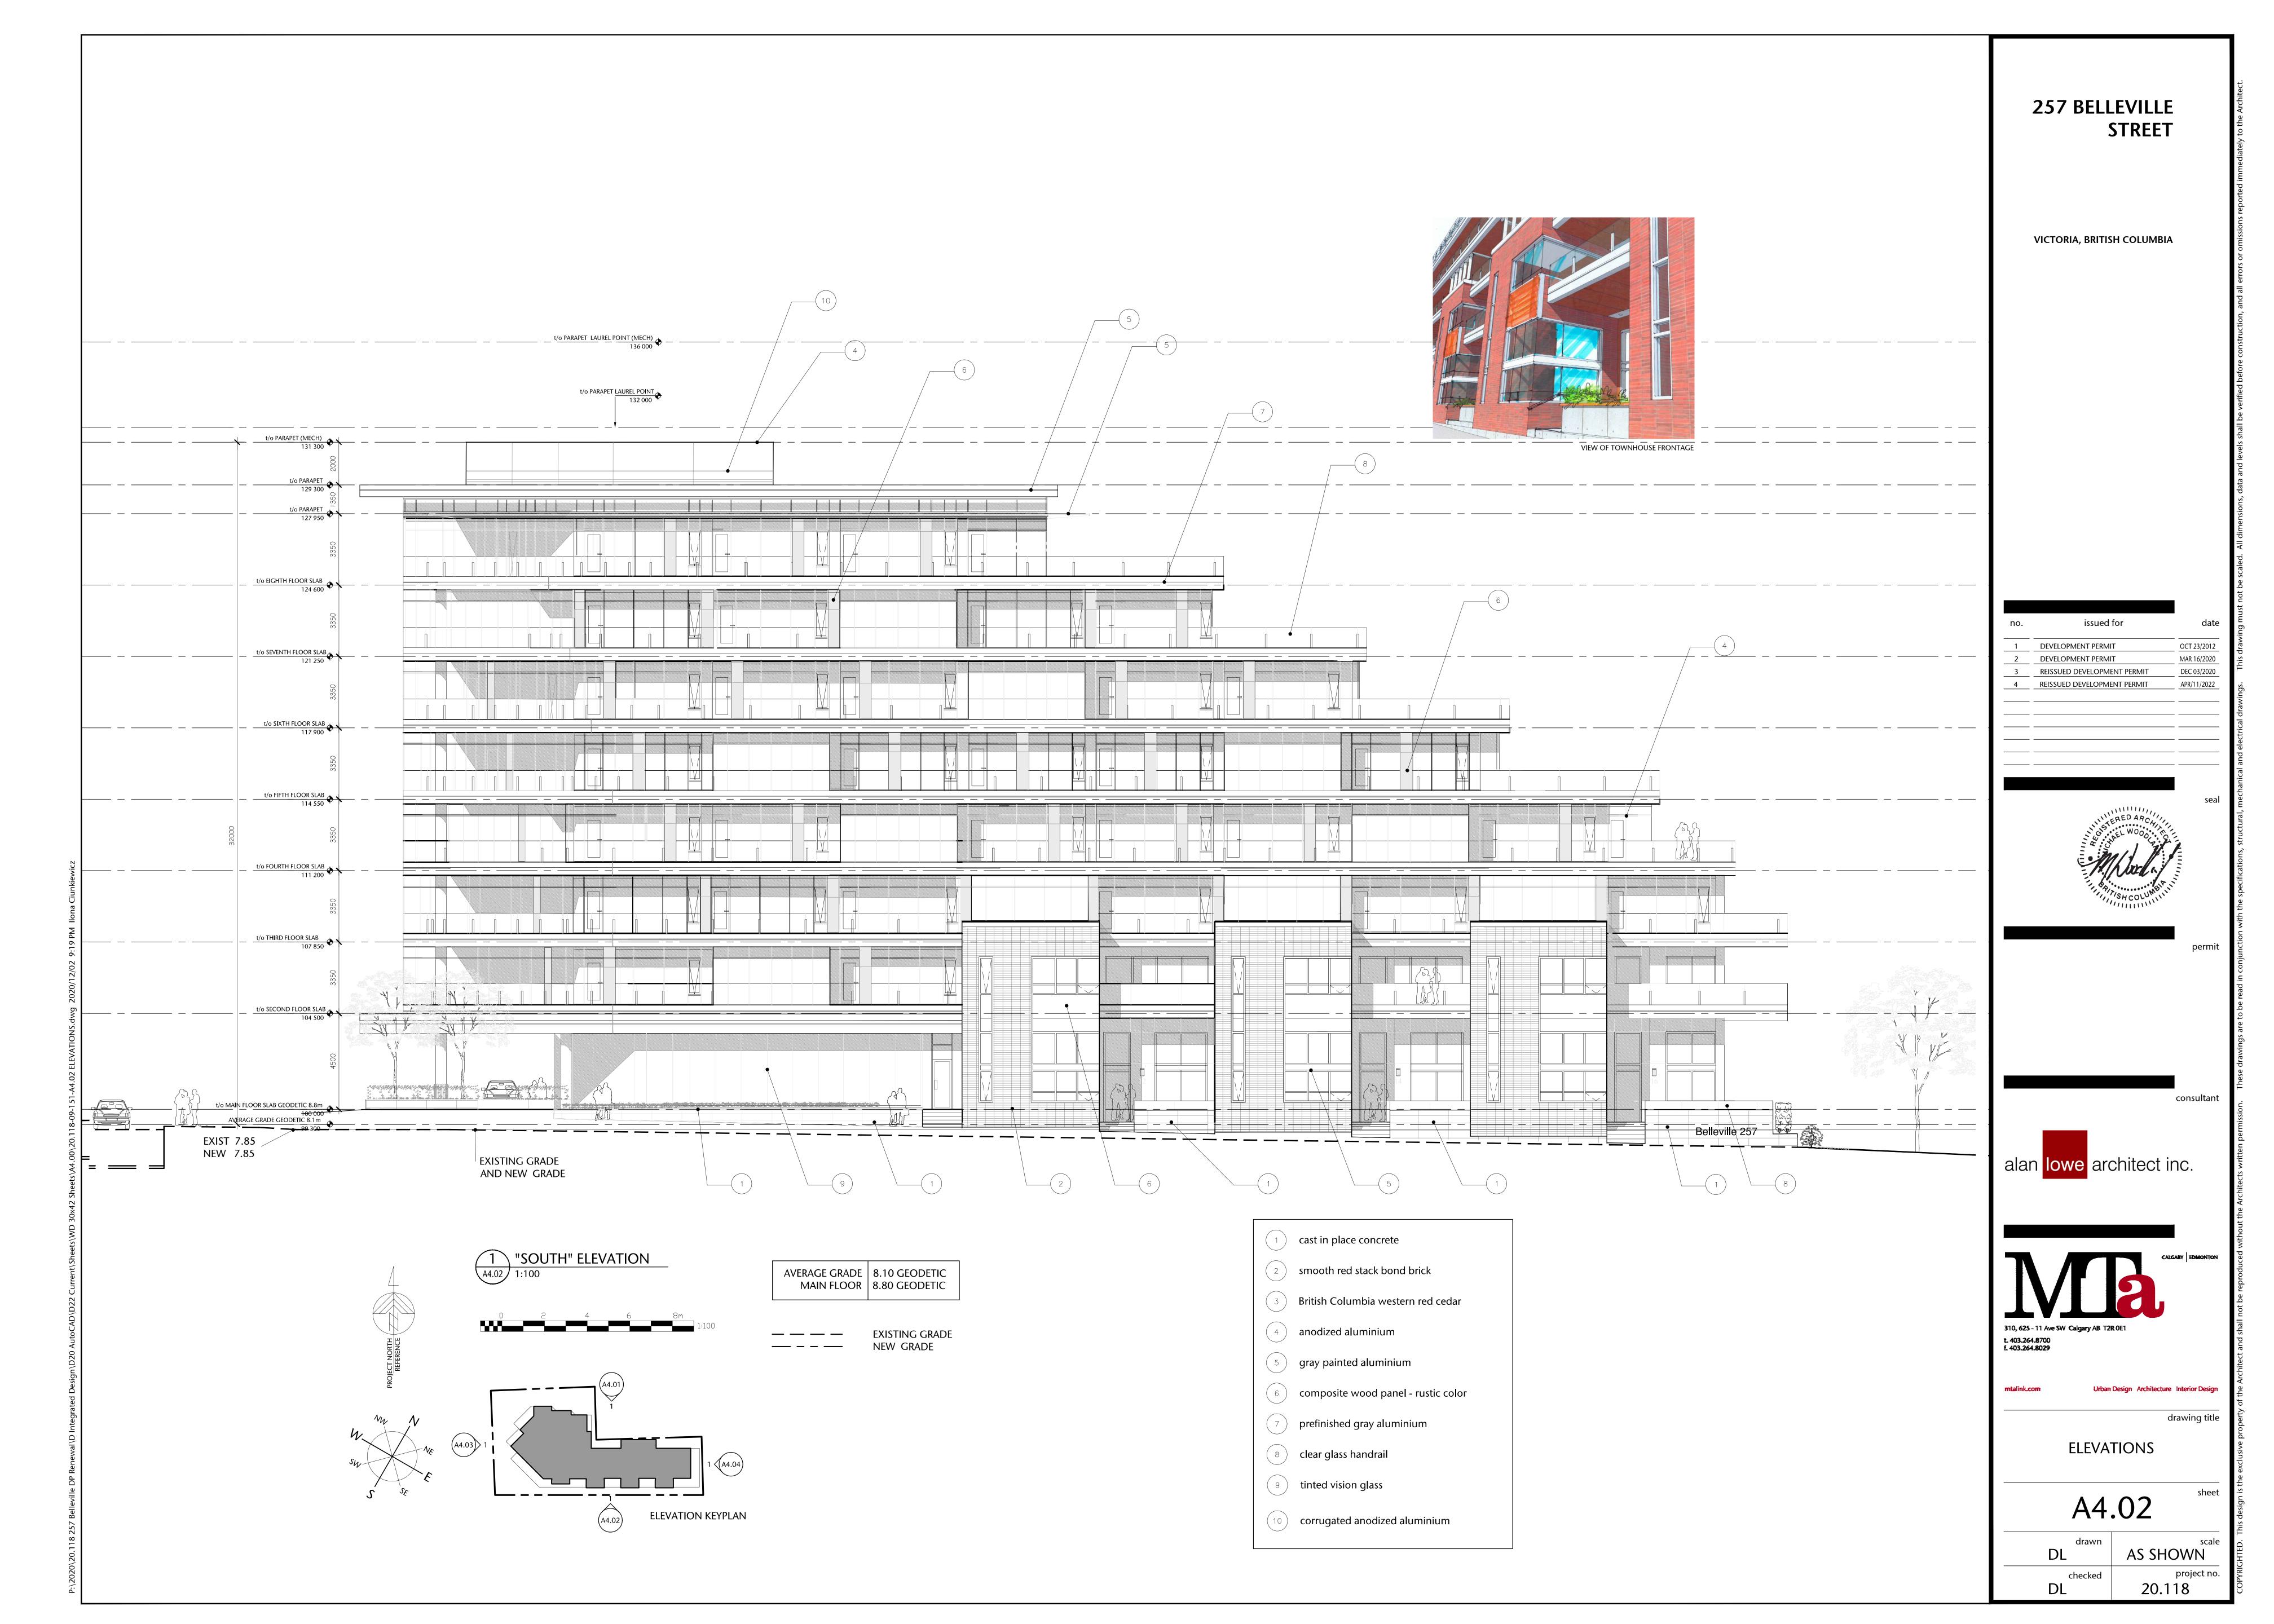
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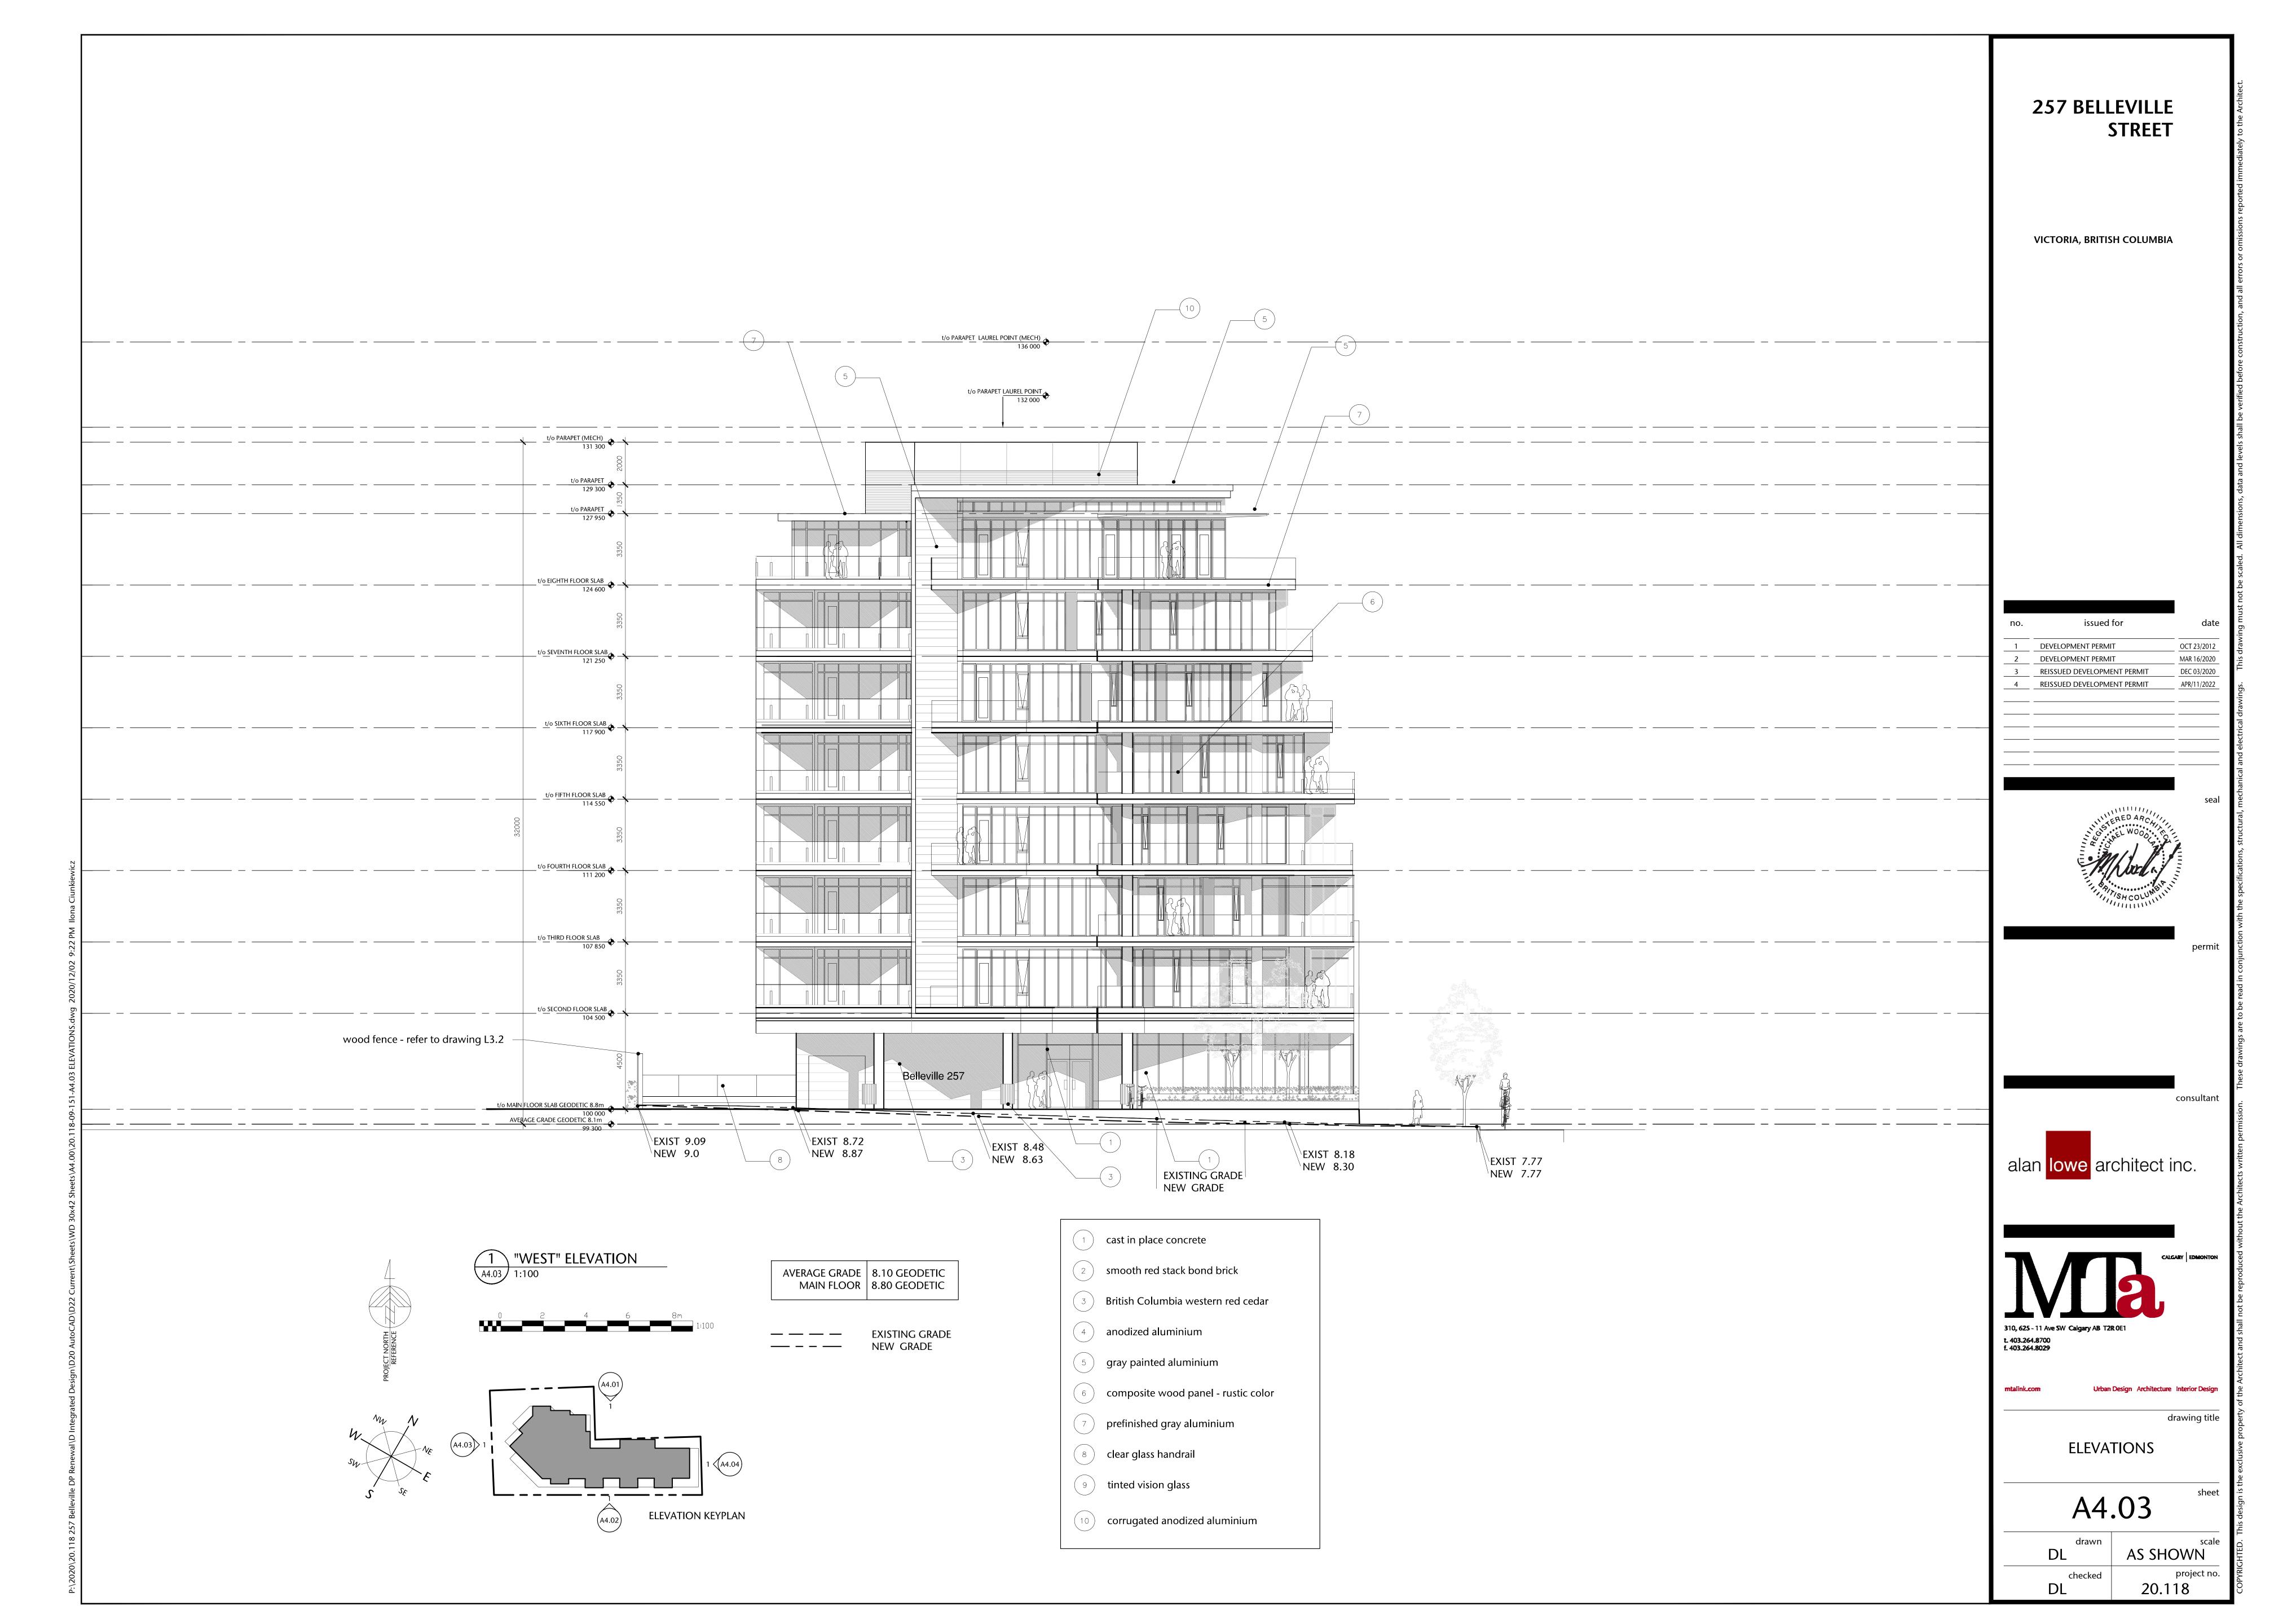



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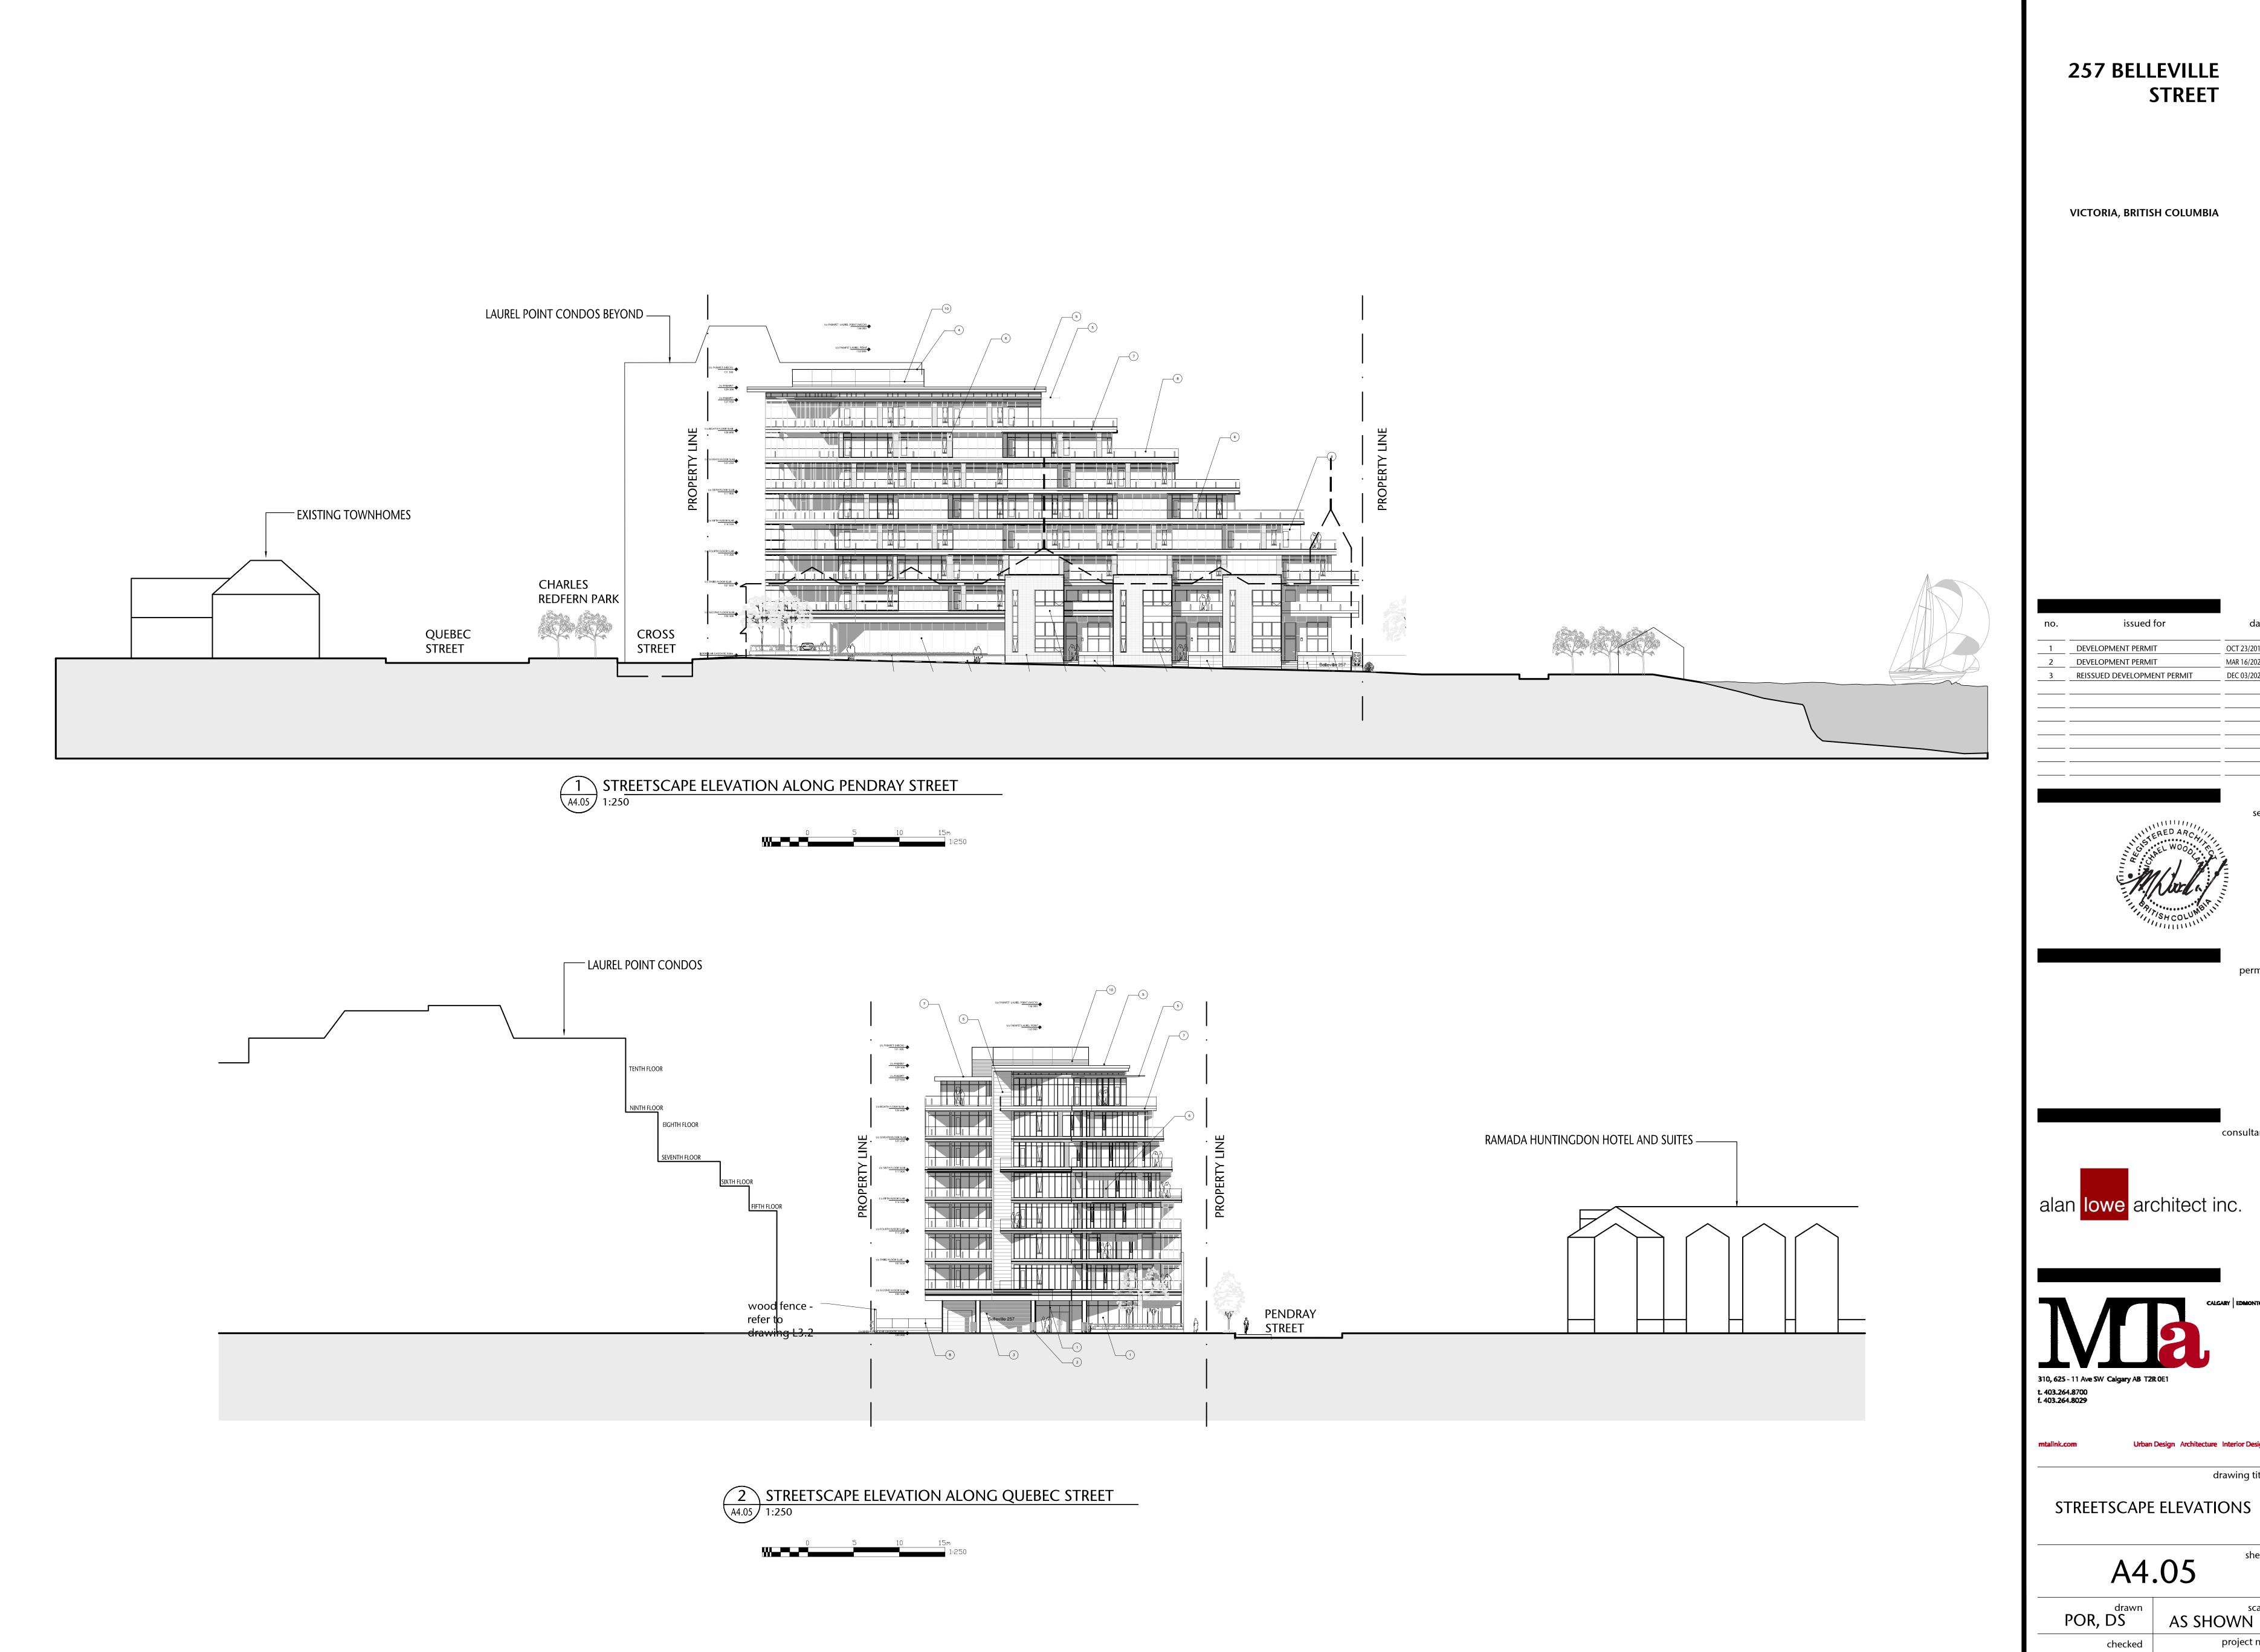
ROOF PLAN







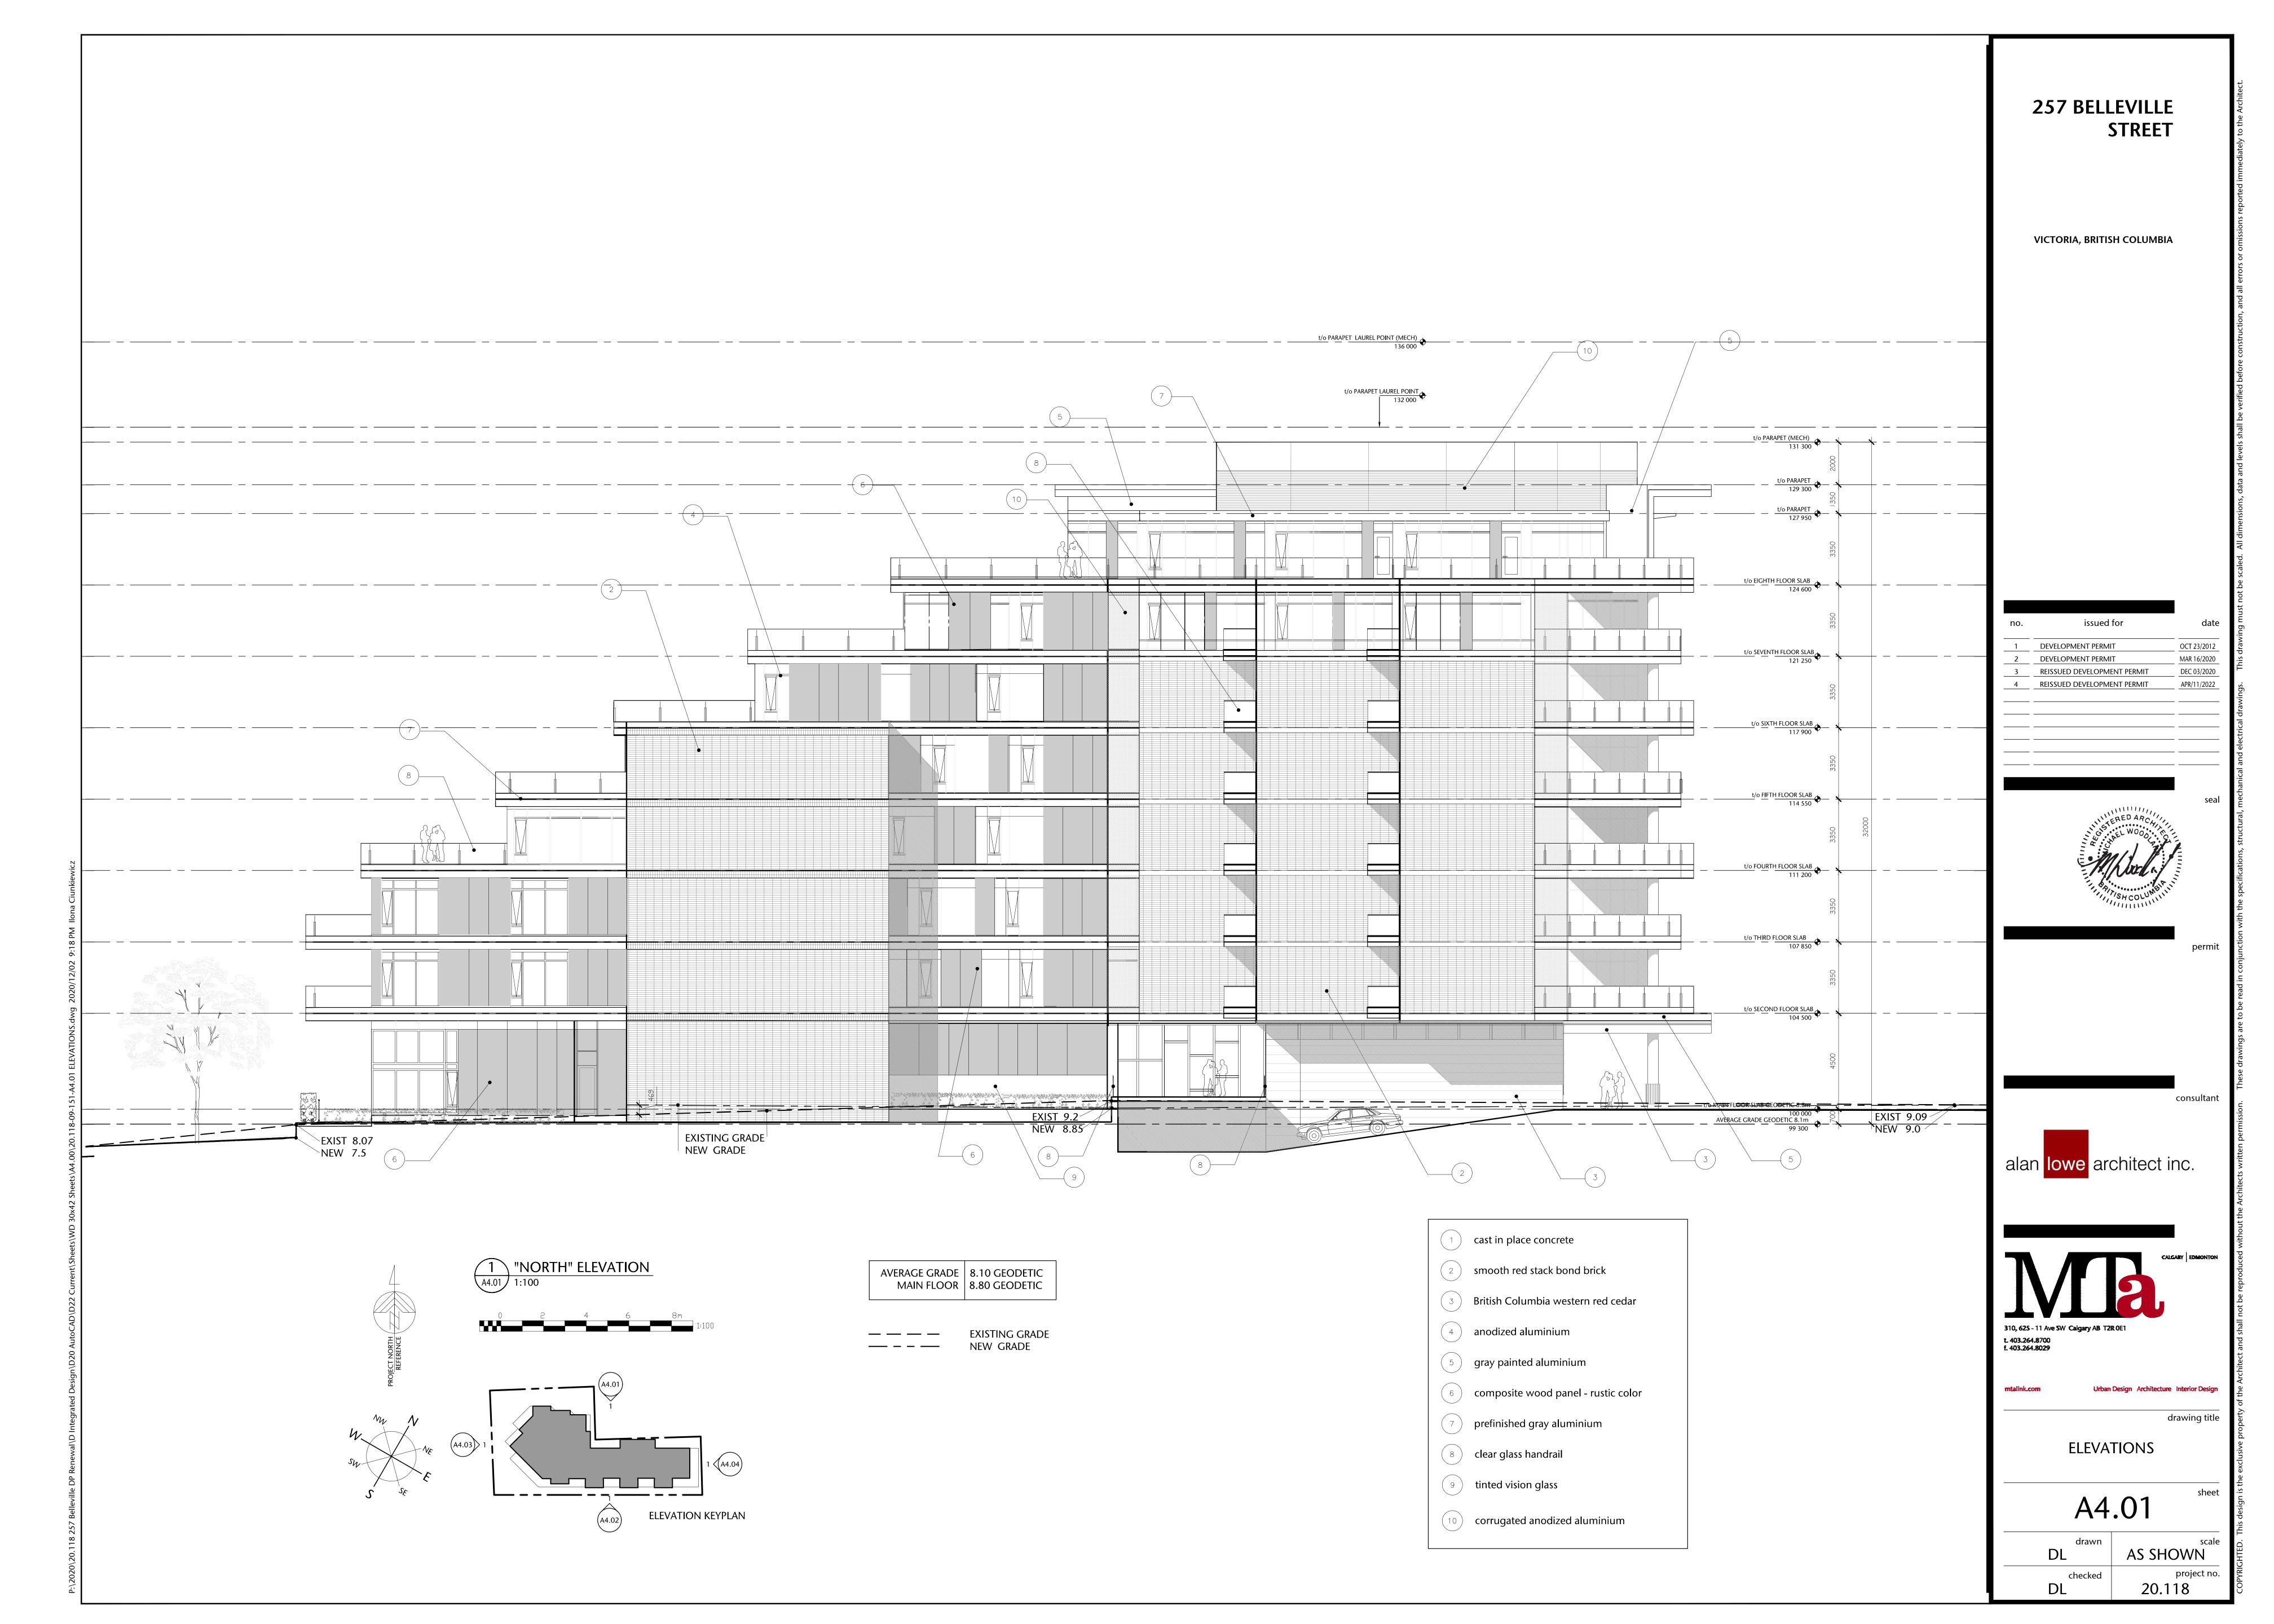

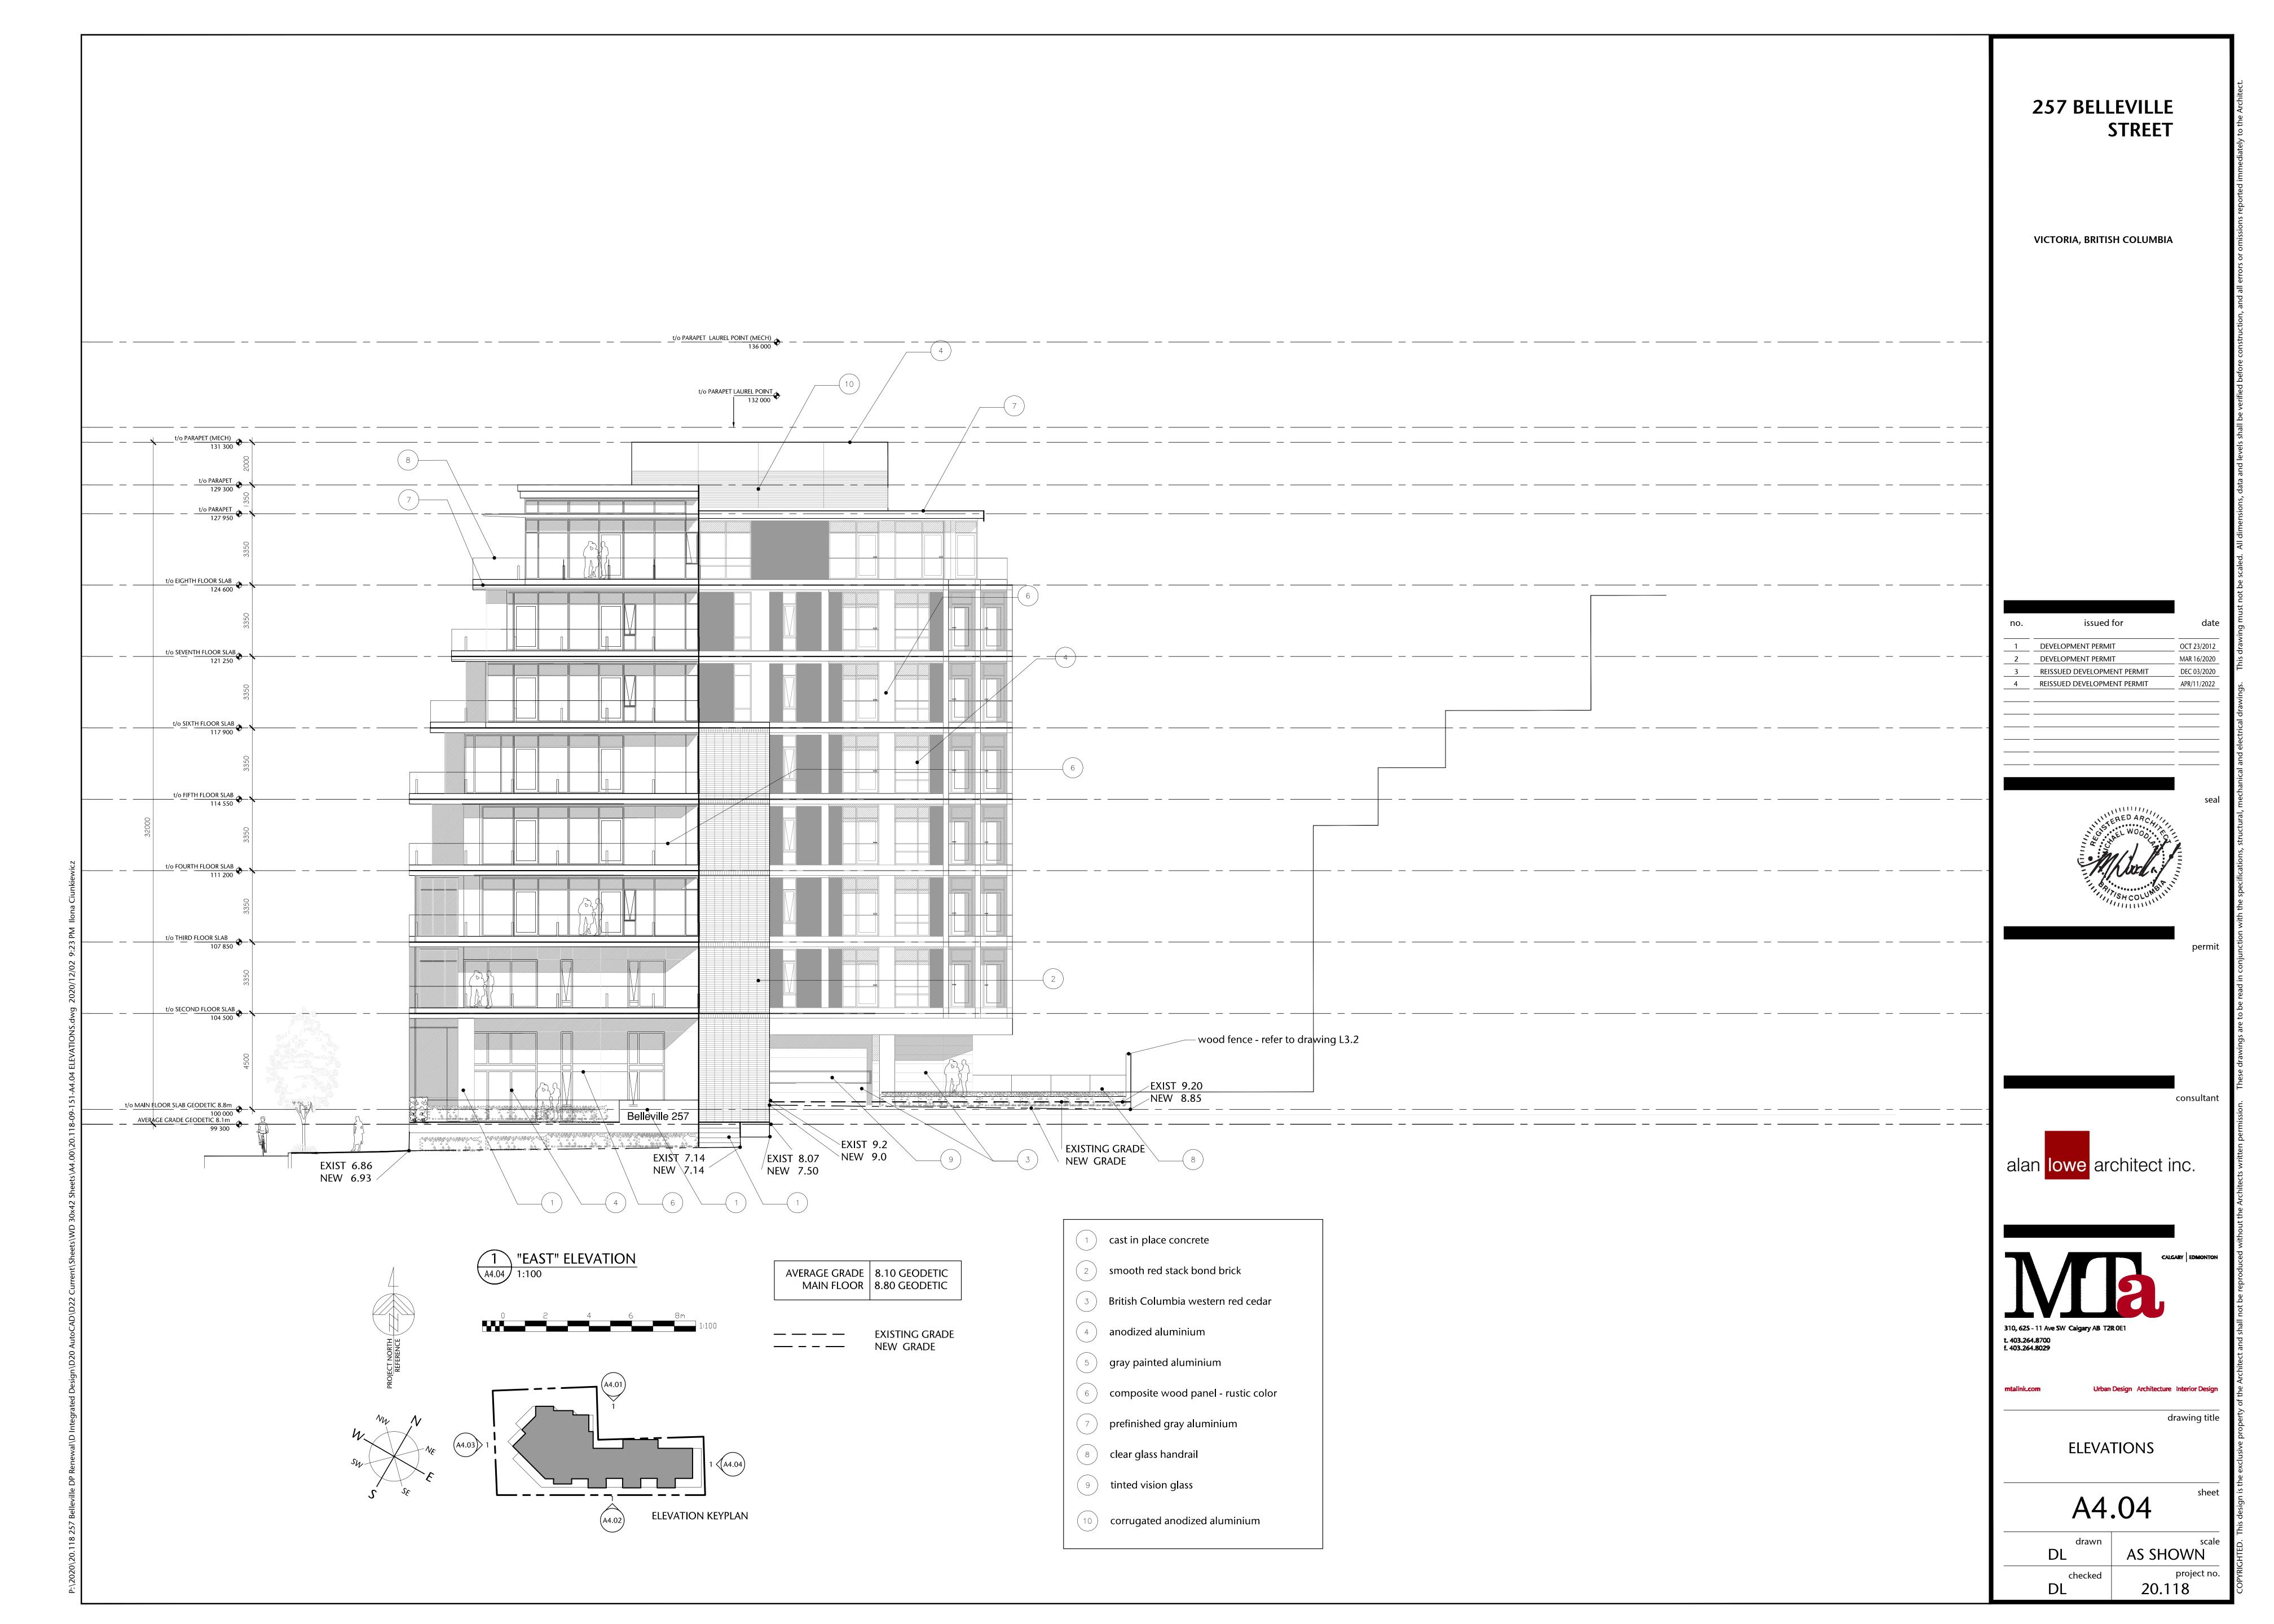


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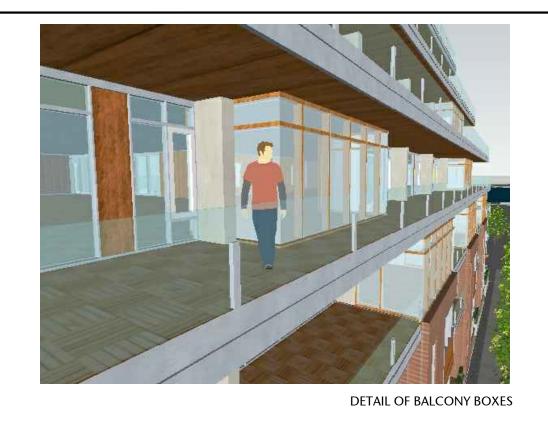




drawing title

AS SHOWN



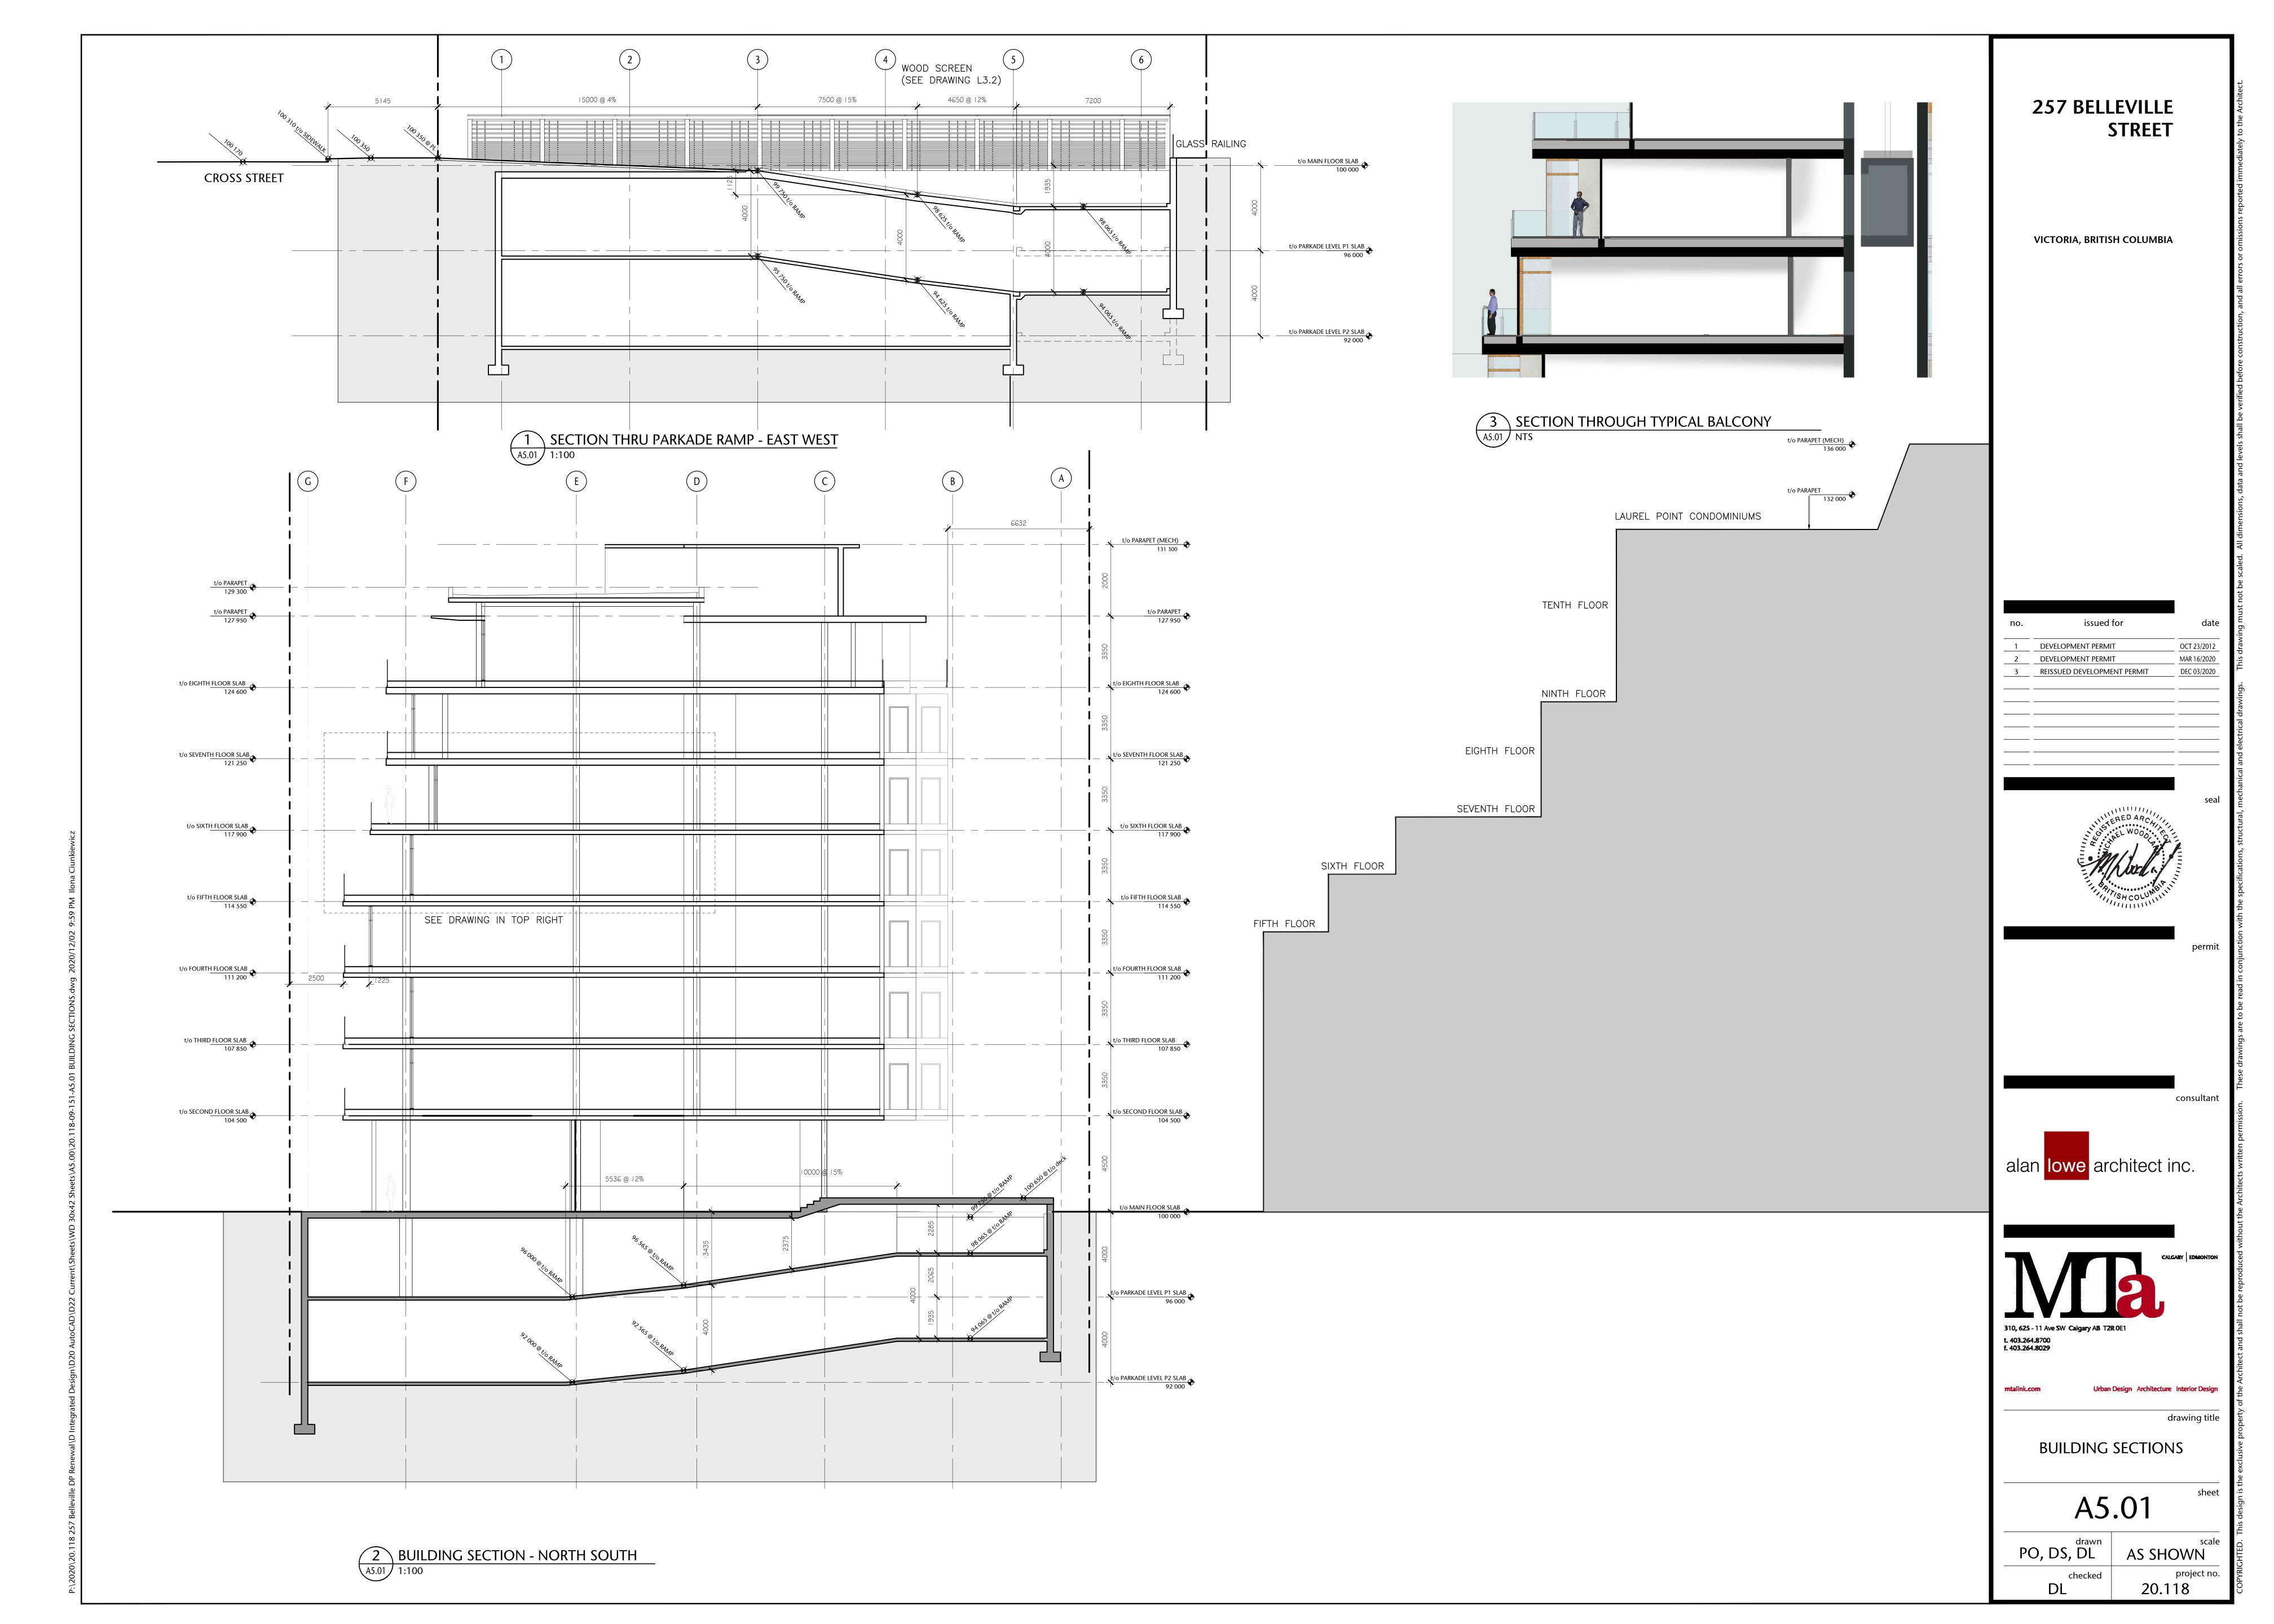



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1	DEVELOPMENT PERMIT	OCT 23/2012
2	DEVELOPMENT PERMIT	MAR 16/2020
3	REISSUED DEVELOPMENT PERMIT	DEC 03/2020
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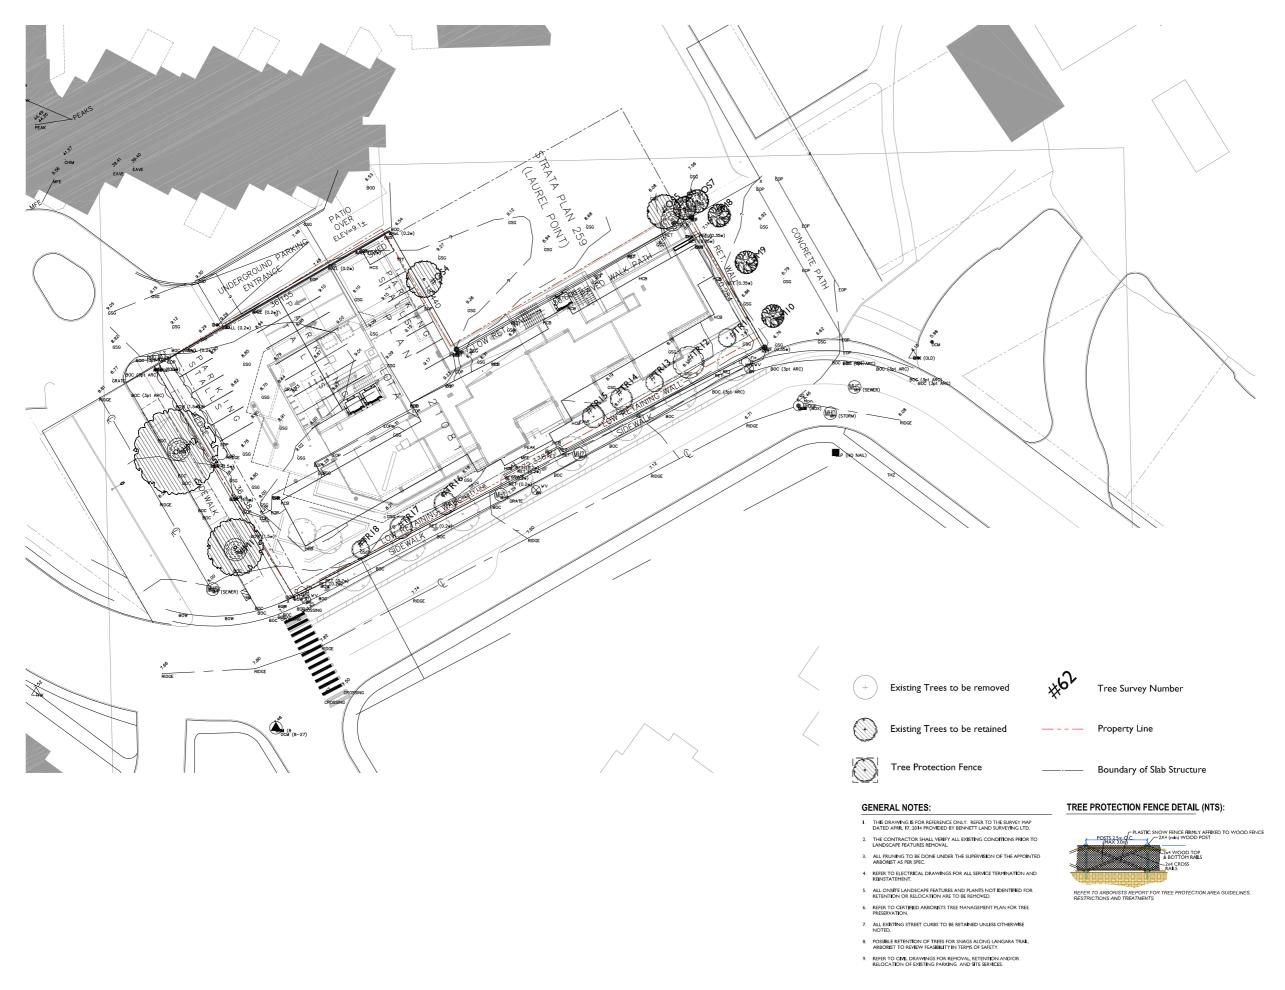
alan lowe architect inc.



drawing title **BUILDING SECTIONS**

A5.02

PO, DS, DL AS SHOWN scale



VICTORIA, BRITISH COLUMBIA.



date	issued for	no.
Nov 15/10	Development Permit	
Feb 04/11	Revised Development Permit	
Feb 16/11	Revised Development Permit	
Apr 29/11	Revised Development Permit	
Nov 07/11	Issued for Costing	
Dec 05/12	Re-issued for Development Permit	
Nov 26/20	Re-issued for Development Permit I	
June 03/21	Re-issued for Development Permit	
July 30/21	For Coordination	
Dec 06/21	Re-issued for Development Permit	
Jul 10/23	Re-issued for Development Permit	



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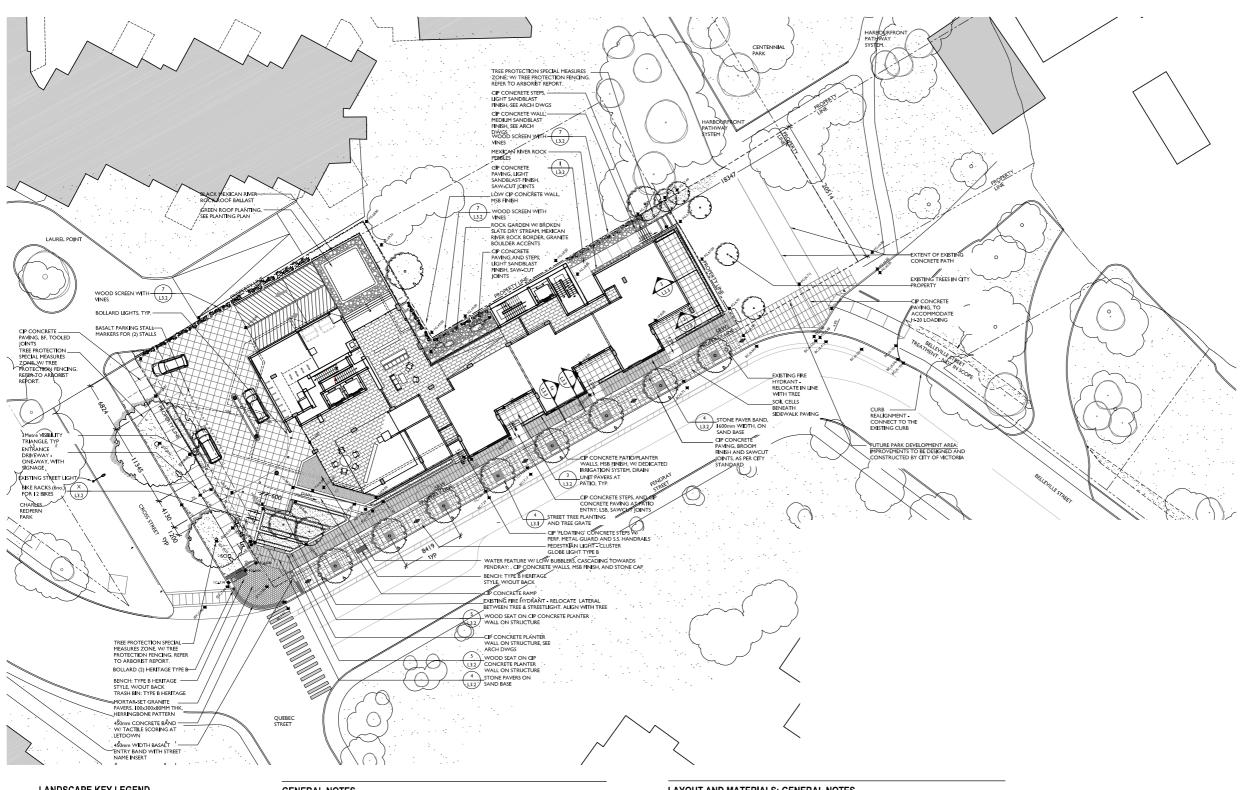
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TREE MANAGEMENT PLAN

LO. I

checked

PROJECT NORTH sheet scale scale ct no.



LANDSCAPE KEY LEGEND

POOL BOTTOM WATER LEVEL TOP OF STA**I**R BOTTOM OF STAIL TOP OF WALL BOTTOM OF WALI TOP OF CURB

BOTTOM OF CURB AREA DRAIN PROPOSED SPOT ELEVATION (FINISHED GRADE)

PROPOSED TREE

EXISTING TREE TO BE REMOVED



PLANT SPECIES PLANT QUANTITY



DETAIL NUMBER SET SHEET NO.

SET SHEET NO.

GENERAL NOTES

1. PROVIDE A DEQUATE SUB-SURFACE DRAINAGE IN ALL LAWN AND PLANTING AREAS.

2. SEE CMIL. AND ARCHITECTURAL DRAWINGS FOR GRADING.

3. ENSURE POSITIVE DRAINAGE.

4. STREETSCAPE TO APPROVIAL OF ENGINEERING SERVICES, ALL STREET TREES TO HAVE 8' WIDE 18' DEPTH 'DEEP ROOT ROOT BARRIER, OR RESAPPROVED EQUIVALENT, AT ALL SIDEWAIL LOCATIONS.

5. ALL STREET TREE SPECIES AND SPACING TO CONFORM TO CITY OF WICTORIA STANDARD SPACING AND CLEARANCE.

6. INALL TREE LOCATIONS TO BE DETERMINED TO THE SATISFACTION OF ENGINEERING SERVICES.

7. ANA AUTOMATIC IRRIGATION SYSTEM SHALL BE PROVIDED FOR ALL FANT MATERIAL, INCLUDING STREETLEVEL PLANTINGS AND GREEN ROOF PLANTINGS. HOSSEINS AND LEE PROVIDED IN ALL PRIVATE COUNTY AND AND PATIO AREAS RIGGATION SYSTEM DESIGN AND INSTALLATION SHALL BE PROVIDED IN ALL PRIVATE COUNTY AND AND PATIO AREAS RIGGATION SYSTEM DESIGN AND INSTALLATION SHALL BE IN ACCORDANCE WITH THE RRIGATION INDUSTRY OF BC STANDARDS AND GUIDELINES. SYSTEM DENOM AND INSTALLABORATION OF SYSTEM DENOM SERVICES.

8. ALL PLANT MATERIAL TO BCLNA AND BCSLA STANDARDS.

9. ROOT BARRIERS TO BE 'DEEP ROOT,' ROOT SOLUTIONS' OR EQUAL

IRRIGATION: GENERAL NOTES

I. ALL LANDSCAPE BRIGATION SHALL CONFORM TO IABC STANDARDS.
2. LANDSCAPE DRIPLINE SHALL BE LOOPED UNLESS OTHERWISE SPECIFIED.
3. ALL BRIGATION WORK SHALL BE DONE BY A SUITBAIL PERPERIENCED AND QUALIFIED BRIGATION CONTRACTOR
ADEQUATE FOR THE SCOPE OF WORK. THE CONTRACTOR SHALL BE A MEMBER IN GOOD STANDING OF THE BRIGATION
INDUSTRY ASSOCIATION OF BC. AND HAVE MET THE QUALIFICATION STANDARDS CURRENTLY APPLIED TO
CONTRACTORS BY THAT ORGANIZATION.
4. UNLESS OTHERWISE SPECIFIED OR INDICATED ON THE DRAWMINGS, ALL LANDSCAPE BRIGATION EQUIPMENT SHALL BE
SUPPLIED BY A SINGLE MANUFACTURER. ANY SUBSTITUTIONS WITHOUT THE PRIOR APPROVAL OF THE CONSULTANT WILL BE
REIECTED.

LAYOUT AND MATERIALS: GENERAL NOTES

I. DO NOT SCALE DRAWINGS, LAYOUT AS PER DIMENSIONS NOTED ON LANDSCAPE PLANS, REPORT ANY DISCREPANCIES TO THE CONSULTANT FOR REVIEW AND RESPONSE. L LAYOUT, AND MATERIALS DRAWINGS ARE TO BE READ IN CONJUNCTION WITH LANDSCAPE SPECIFICATIONS FOR

Z LATOUT AND MATERIALD DRAWINGS ARE TO BE READ IN CONJUNCTION WITH LANDSCAPE SPECIFICATIONS FOR COMPLIANCE. 3. LANDSCAPE DRAWINGS ARE TO BE READ IN CONJUNCTION WITH ARCHITECTURAL AND ENGINEERING DRAWINGS, REPORT ANY DISCREPANCIES TO THE CONSULTANT FOR REVIEW AND RESPONSE. 4. VERIET ALL DIMENSIONS WITH FIELD CONDITIONS, REPORT ANY DISCREPANCIES TO THE CONSULTANT FOR REVIEW AND

4. VEREY ALL DIMENSIONS WITH HELD CONDITIONS, REPORT AND DEGRESSIONS.

5. LIGHTING INFORMATION REFERENCED ON LANDSCAPE DRAWINGS IS TO BE READ IN CONJUNCTION WITH ELECTRICAL ENGINEERS DRAWINGS, REPORT ANY DISCREPANCIES TO THE CONSULTANT FOR REMEW AND RESPONSE.

6. CHIEF AND LIGHTING ARE INDICATED FOR REFERENCE ONLY, REFER TO ENG. DRAWINGS FOR LOCATIONS, DETAILS, AND TREPER OF THE CONTROL OF THE

GRADING: GENERAL NOTES

I. CONFIRM ALL EXISTING GRADES PRIOR TO CONSTRUCTION AND REPORT ANY DISCREPANCIES TO THE CONSULTANT TEAM FOR REVIEW AND RESPONSE.

2. UNIESS OTHERWISE NOTED, ALL DRAINS LOCATED IN LAWN OR PLANTED AREA ARE TO BE COMPLETE WITH INSPECTION

CHAMBER SAND, CEANING IT.

CHAMBER AND CLEANOUT.

3. PROVIDE POSTITE DRAINAGE THROUGHOUT - AWAY FROM BUILDINGS AND TO DRAINAGE STRUCTURES, UNLESS OTHERWISE NOTED, PROVIDE A MINIMUM SLOPE OF 28: ON ALL HARD AND SOFT LANDSACPE SURFACES.

4. UNLESS OTHERWISE NOTED PROVIDE A MAXIMUM SLOPE OF 41 (25%) AT ALL SOFT LANDSCAPE AREAS. REPORT ANY DISCRETANGES TO THE CONSULTANT TEAM FOR REMEW AND RESPONSE.

5. ALL GRADING INFORMATION TO BE COORDINATED WITH ARCHITECTURAL DRAWINGS TO ENSURE ADEQUATE SOIL DEPTHS AND POSTITUE DRAINAGE.

257 BELLEVILLE STREET

VICTORIA. BRITISH COLUMBIA.

		ı
no.	issued for	date
	Development Permit	Nov 15/10
	Revised Development Permit	Feb 04/11
	Revised Development Permit	Feb 16/11
	Revised Development Permit	Apr 29/11
	Issued for Costing	Nov 07/11
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	For Coordination	July 30/21
	Re-issued for Development Permit	Dec 06/21
	Re-issued for Development Permit	Jul 10/23

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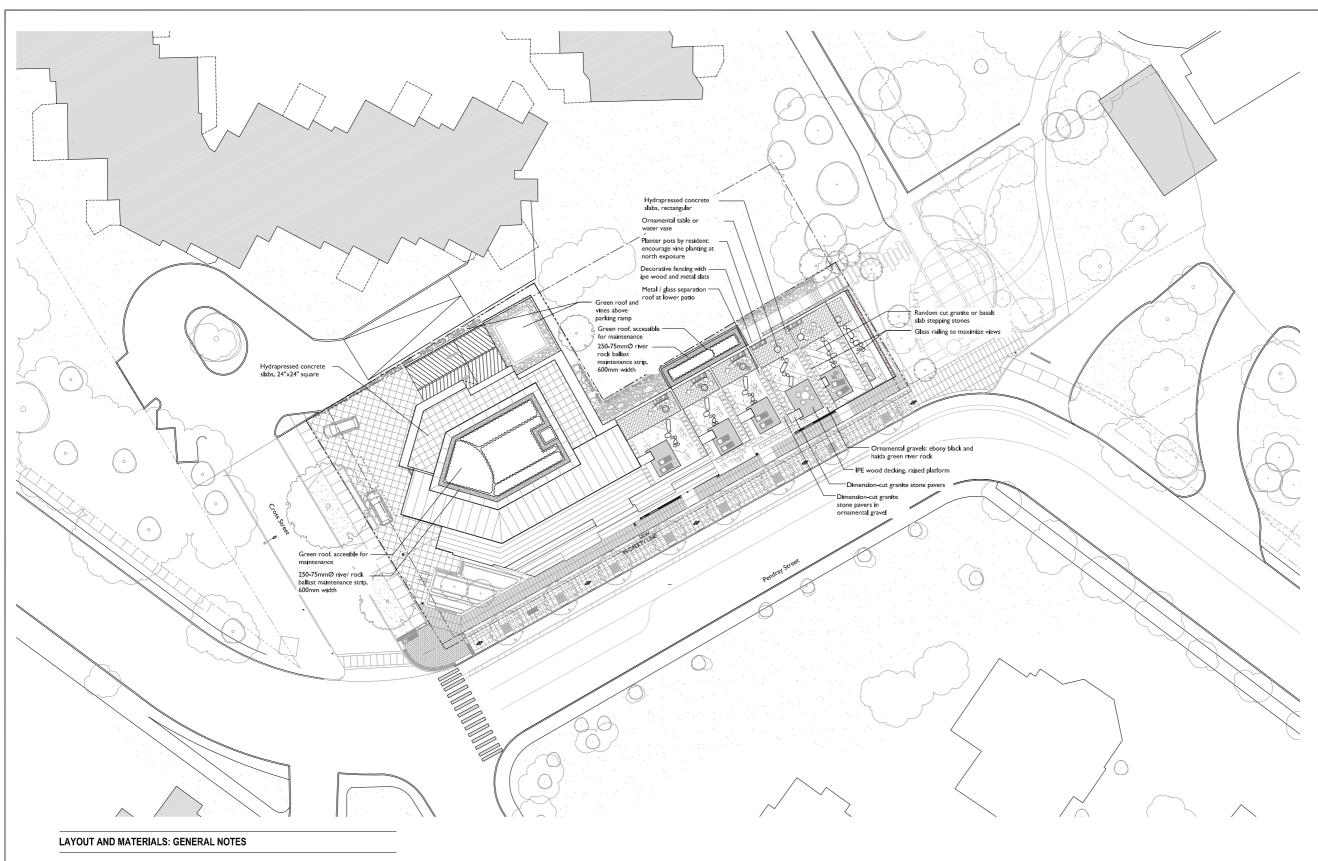
LANDSCAPE PLAN -**GROUND FLOOR**

1:200

MD checked

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PROIECT



I. DO NOT SCALE DRAWINGS. LAYOUT AS PER DIMENSIONS NOTED ON LANDSCAPE PLANS. REPORT ANY DISCREPANCIES TO THE CONSULTANT FOR REVIEW AND RESPONSE.

2. LAYOUT AND MATERIALS DRAWINGS ARE TO BE READ IN CONJUNCTION WITH LANDSCAPE SPECIFICATIONS FOR COMPRIANCE.

3. LANDSCAPE DRAWINGS ARE TO BE READ IN CONJUNCTION WITH ARCHTECTURAL AND ENGINEERING DRAWINGS. REPORT ANY DISCREPANCIES TO THE CONSULTANT FOR REVIEW AND RESPONSE.

4. YEBRIY ALL DIMENSIONS WITH HELD CONDITIONS. REPORT ANY DISCREPANCIES TO THE CONSULTANT FOR REVIEW AND RESPONSE.

5. LIGHTING INFORMATION REFERENCED ON LANDSCAPE DRAWINGS IS TO BE READ IN CONJUNCTION WITH ELECTRICAL ENGINEERS DRAWINGS. REPORT ANY DISCREPANCIES TO THE CONSULTANT FOR REVIEW AND RESPONSE.

6. UTILITY AND LIGHTING ARE INDICATED FOR REFERENCE ONLY, REFER TO ENG. DRAWINGS FOR LOCATIONS, DETAILS, AND SPECIFICATIONS.

7. REFERENCE CIMIL ENGINEERS DRAWINGS FOR LAYOUT OF ROAD CURBS AND GUTTERS AND PEDESTRAIN LET-DOWNS.

8. REFER TO ENGINEERING DRAWINGS FOR DETAILS, SUBGRADE, AND RENFORCING OF ALL PAYED SURFACES IN ROADWAYS.

IRRIGATION: GENERAL NOTES

I. ALL LANDSCAPE BRIGATION SHALL CONFORM TO IABC STANDARDS.

2. LANDSCAPE DRIPLINE SHALL BE LOOPED UNLESS OTHERWISE SPECIFIED.

3. ALL BRIGATION WORK SHALL BE DONE BY A SUITABLY EXPERIENCED AND QUALIFIED REGATION CONTRACTOR ADEQUATE FOR THE SCOPE OF WORK. THE CONTRACTOR SHALL BE A MEMBER IN GOOD STANDING OF THE IRRIGATION INDUSTRY ASSOCIATION OF B.C. AND HAVE MET THE QUALIFICATION STANDARDS CURRENTLY APPLIED TO CONTRACTORS BY THAT ORGANIZATION.

4. UNLESS OTHERWISE SPECIFIED OR INDICATED ON THE DRAWNINGS, ALL LANDSCAPE BRIGATION EQUIPMENT SHALL BE SUPPLED BY A SINGLE MANUFACTURER. ANY SUBSTITUTIONS WITHOUT THE PRIOR APPROVAL OF THE CONSULTANT WILL BE SEIGHTED.

REJECTED.
5. GREEN ROOF PLANTING IS TO BE FULLY IRRIGATED.



257 BELLEVILLE STREET

VICTORIA, BRITISH COLUMBIA.

For Coordination July 30/2
Re-issued for Development Permit Dec 06/2 pment Permit Jul 10/2

PFS STUDIO 1777 Week 5" footn Vancouver BC V6] 604,775,0798


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LANDSCAPE PLAN -**ROOF LEVELS**

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SET 26 SMILACINA RACEMOSA SITE 26 SMILACINA RACEMOSA FALSE SOLOMON'S SEAL FASS J SEDUM ACRE SECURI SECURIA SECURIALIS SEDUM ACRE FASS SEDUM SPECTABILE 'BRILLIANT' FOR ASSON SEDUM SPECTABILE 'BRILLIANT' FOR ASSON SEAL STRAWBERRY #1 POT 300mm O.C. 430 POT 450mm O.C. 440 POLYSTICHUM MINUTUM FLOWERING CURRANT #2 POT 500mm O.C. 50	PLAN	IT SCH	EDULE			
TBD 8 BOULEVARD TREE SPECIES TO BE DETERMINED AT BUILDING PERMIT STAGE MEDIUM CD 2 CRATAEGUS DOUGLASII BLACK HAWTHORN 7 CM CAL MATCHING, FULL SHRUBS / GROUNDCOVERS A 120 ARCTOSTAPHYLOS UVA-JURSI KINNIKINNICK #2 POT 450mm O.C. BM 99 BUXUS MICROPHYLLA GREEN BEAUTY GREEN BEAUTY LITTLE LEAF BUXUS #3 POT 450mm O.C. CF 150 FRAGARIA CHILOENSIS COASTAL STRAWBERRY #1 POT 300mm O.C. CG 52 GAULTHERIA SHALLON SALAL #2 POT 300mm O.C. CM 44 POLYSTICHUM MINUTUM WESTERN SWORD FERN #2 POT 500mm O.C. CM 46 POLYSTICHUM MINUTUM FLOWERING CURRANT #3 POT 600mm O.C. CM 100 TAXUS MEDIA HICKSII, MAL HICKS YEW #5 POTS 380mm O.C., MALE TAX 35 TAXUS MEDIA HICKSII, MAL HICKS YEW #2" HT., FIELD GROWN, FULL 500mm O.C. GRASS / PERENNIALS FALSE SOLOMON'S SEAL #2 POTS 450mm O.C. CLIMBERS CA 46 CLEMATIS ARMANDII EVERGREEN CLEMATIS 1200 O.C. CLIMBERS CA 55 SEDUM SPECTABILE 'BRILLIANT' 100" O.C. CLIMBERS CA 2450 SEDUM SPECTABILE 'BRILLIANT' 100" O.C.	KEY	QTY	BOTANICAL NAME	COMMON NAME	SIZE	DESCRIPTION
SHRUBS / GROUNDCOVERS ABA 120 ARCTOSTAPHYLOS UVA-URSI KINNIKINNICK #2 POT 450mm O.C. ABA 120 ARCTOSTAPHYLOS UVA-URSI KINNIKINNICK #2 POT 450mm O.C. ABA 120 ARCTOSTAPHYLOS UVA-URSI KINNIKINNICK #2 POT 450mm O.C. ABA 120 ARCTOSTAPHYLOS UVA-URSI KINNIKINNICK #2 POT 450mm O.C. ABA 120 ARCTOSTAPHYLOS UVA-URSI KINNIKINNICK #2 POT 450mm O.C. ABA 120 ARCTOSTAPHYLOS UVA-URSI KINNIKINNICK #2 POT 450mm O.C. ABA 120 ARCTOSTAPHYLOS UVA-URSI KINNIKINNICK #2 POT 300mm O.C. ABA 120 ARCTOSTAPHYLOS UVA-URSI KINNIKI	TREE	s				
SHRUBS / GROUNDCOVERS Aa 120 ARCTOSTAPHYLOS UVA-URSI KINNIKINNICK #2 POT 450mm O.C. Am 99 BUXUS MICROPHYLLA GREEN BEAUTY GREEN BEAUTY LITTLE LEAF BUXUS #3 POT 450mm O.C. CC 150 FRAGARIA CHILOENSIS COASTAL STRAWBERRY #1 POT 300mm O.C. AS 52 GAULTHERIA SHALLON SALAL #2 POT 300mm O.C. AND 44 POLYSTICHUM MINUTUM WESTERN SWORD FERN #2 POT 500mm O.C. AS 36 RIBES SANGUINEUM FLOWERING CURRANT #3 POT 600mm O.C. AS 36 RIBES SANGUINEUM FLOWERING CURRANT #3 POT 600mm O.C. AND 100 TAXUS MEDIA HICKSII, MAL HICKS YEW #5 POTS 380mm O.C., MALE AND 35 TAXUS MEDIA HICKSII, MAL HICKS YEW 42" HT., FIELD GROWN, FULL 500mm O.C., MALE AND 37 THUJA OCCIDENTALIS SMARAGD EMERALD GREEN CEDAR 2.5M HEIGHT 500mm O.C. CLIMBERS CC 26 SMILACINA RACEMOSA FALSE SOLOMON'S SEAL #2 POTS 450mm O.C. CLIMBERS CC 26 SMILACINA RACEMOSA FALSE SOLOMON'S SEAL #2 POTS 450mm O.C. CLIMBERS CC 26 SECUM ACRE CC 27 SECUM ACRE CC 28 SECUM ACRE CC 28 SECUM SPECTABILE 'BRILLIANT' 10° O.C.	TBD	8	BOULEVARD TREE SPECIES TO BE DETERMIN	ED AT BUILDING PERMIT STAGE	MEDIUM	
AA 120 ARCTOSTAPHYLOS UVA-URSI KINNIKINNICK #2 POT 450mm O.C. 3m 99 BUXUS MICROPHYLLA GREEN BEAUTY GREEN BEAUTY LITTLE LEAF BUXUS #3 POT 450mm O.C. 5c 150 FRAGARIA CHILOENSIS COASTAL STRAWBERRY #1 POT 300mm O.C. 5c 52 GAULTHERIA SHALLON SALAL #2 POT 300mm O.C. 5c 54 GAULTHERIA SHALLON SALAL #2 POT 500mm O.C. 5c 55 52 GAULTHERIA SHALLON SALAL #2 POT 500mm O.C. 5c 56 52 GAULTHERIA SHALLON SALAL #2 POT 500mm O.C. 5c 56 52 GAULTHERIA SHALLON SALAL #2 POT 500mm O.C. 5c 65 52 GAULTHERIA SHALLON SALAL #2 POT 500mm O.C. 5c 66 S 53 TAXUS MEDIA HICKSII, MAL HICKS YEW #5 POTS 380mm O.C., MALE 5c 7 TAXUS MEDIA HICKSII, MAL HICKS YEW #5 POTS 380mm O.C., MALE 5c 7 TAXUS MEDIA HICKSII, MAL HICKS YEW #2" HT., FIELD GROWN, FULL, 500mm O.C., MALE 5c 7 TAXUS MEDIA HICKSII, MAL HICKS YEW 42" HT., FIELD GROWN, FULL, 500mm O.C. 5c 7 TAXUS MEDIA HICKSII, MAL HICKS YEW 42" HT., FIELD GROWN, FULL, 500mm O.C. 5c 7 TAXUS MEDIA HICKSII, MAL HICKS YEW 42" HT., FIELD GROWN, FULL, 500mm O.C. 5c 7 TAXUS MEDIA HICKSII, MAL HICKS YEW 42" HT., FIELD GROWN, FULL, 500mm O.C. 5c 7 TAXUS MEDIA HICKSII, MAL HICKS YEW 42" HT., FIELD GROWN, FULL, 500mm O.C. 5c 7 TAXUS MEDIA HICKSII, MAL HICKS YEW 42" HT., FIELD GROWN, FULL, 500mm O.C. 5c 7 TAXUS MEDIA HICKSII, MAL HICKS YEW 42" HT., FIELD GROWN, FULL, 500mm O.C. 5c 7 TAXUS MEDIA HICKSII, MAL HICKS YEW 42" HT., FIELD GROWN, FULL, 500mm O.C. 5c 7 TAXUS MEDIA HICKSII, MAL HICKS YEW 42" HT., FIELD GROWN, FULL, 500mm O.C. 5c 7 TAXUS MEDIA HICKSII, MAL HICKS YEW 42" HT., FIELD GROWN, FULL 500mm O.C. 5c 7 TAXUS MEDIA HICKSII, MAL HICKS YEW 42" HT., FIELD GROWN, FULL 500mm O.C. 5c 7 TAXUS MEDIA HICKSII, MAL HICKS YEW 42" HT., FIELD GROWN, FULL 500mm O.C. 5c 7 TAXUS MEDIA HICKSII, MAL HICKS YEW 42" HT., FIELD GROWN, FULL 500mm O.C. 5c 7 TAXUS MEDIA HICKSII, MAL HICKS YEW 42" HT., FIELD GROWN, FULL 500mm O.C. 5c 7 TAXUS MEDIA HICKSII, MAL HICKS YEW 42" HT., FIELD GROWN, FULL 500mm O.C. 5c 7 TAXUS MEDIA HICKSII, MAL HICKS YEW 42" HT., FIELD GROWN, FULL 500mm O.C. 5c 7 TAXUS MEDIA HICKSII, MAL HICKS YEW 42" HT., F	CD	2	CRATAEGUS DOUGLASII	BLACK HAWTHORN	7 CM CAL	MATCHING, FULL
SITE OF SECULA SECULAR	SHRU	JBS / G	ROUNDCOVERS			
COASTAL STRAWBERRY #I POT 300mm O.C. GS 52 GAULTHERIA SHALLON SALAL #2 POT 300mm O.C. GS 52 GAULTHERIA SHALLON SALAL #2 POT 300mm O.C. GS 53 GAULTHERIA SHALLON SALAL #2 POT 500mm O.C. GS 64 RIBES SANGUINEUM FLOWERING CURRANT #3 POT 600mm O.C. TIM 100 TAXUS MEDIA HICKSII, MAL HICKS YEW #5 POTS 380mm O.C., MALE TX 35 TAXUS MEDIA HICKSII, MAL HICKS YEW #2" HT., FIELD GROWN, FULL 500mm O.C., MALE TO 43 THUJA OCCIDENTALIS SMARAGD EMERALD GREEN CEDAR 2.5M HEIGHT 500mm O.C. GRASS / PERENNIALS GRASS	Aa	120	ARCTOSTAPHYLOS UVA-URSI	KINNIKINNICK	#2 POT	450mm O.C.
SALAL #2 POT 300mm O.C. Pm 44 POLYSTICHUM MINUTUM WESTERN SWORD FERN #2 POT 500mm O.C. Rs 36 RIBES SANGUINEUM FLOWERING CURRANT #3 POT 600mm O.C. Rm 100 TAXUS MEDIA HICKSII, MAL HICKS YEW #5 POTS 380mm O.C., MALE TX 35 TAXUS MEDIA HICKSII, MAL HICKS YEW #5 POTS 380mm O.C., MALE TX 36 TAXUS MEDIA HICKSII, MAL HICKS YEW 42" HT., FIELD GROWN, FULL 500mm O.C., MALE TX 37 THUJA OCCIDENTALIS SMARAGD EMERALD GREEN CEDAR 2.5M HEIGHT 500mm O.C. SRASS / PERENNIALS TX 26 SMILACINA RACEMOSA FALSE SOLOMON'S SEAL #2 POTS 450mm O.C. CLIMBERS TX 26 SCHMATIS ARMANDII EVERGREEN CLEMATIS 1200 O.C. GREEN ROOF TX 30 SEDUM SPECTABILE 'BRILLIANT' 10" O.C.	Bm	99	BUXUS MICROPHYLLA GREEN BEAUTY	GREEN BEAUTY LITTLE LEAF BUXUS	#3 POT	450mm O.C.
AND A POLYSTICHUM MINUTUM WESTERN SWORD FERN #2 POT 500mm O.C. AS 36 RIBES SANGUINEUM FLOWERING CURRANT #3 POT 600mm O.C. TIT 100 TAXUS MEDIA HICKSII, MAL HICKS YEW #5 POTS 380mm O.C., MALE TX 35 TAXUS MEDIA HICKSII, MAL HICKS YEW 42" HT., FIELD GROWN, FULL, 500mm O.C., MALE TX 36 TAXUS MEDIA HICKSII, MAL HICKS YEW 42" HT., FIELD GROWN, FULL, 500mm O.C., MALE TX 26 SMILACINA RACEMOSA FALSE SOLOMON'S SEAL #2 POTS 450mm O.C. CLIMBERS TX 26 SMILACINA RACEMOSA FALSE SOLOMON'S SEAL #2 POTS 450mm O.C. CLIMBERS TX 37 TAYLOR MEDIA HICKSII, MAL HICKS YEW 42" HT., FIELD GROWN, FULL, 500mm O.C. CLIMBERS TX 26 SMILACINA RACEMOSA FALSE SOLOMON'S SEAL #2 POTS 450mm O.C. CLIMBERS TX 26 SMILACINA RACEMOSA FALSE SOLOMON'S SEAL #2 POTS 450mm O.C. CLIMBERS TX 37 TAYLOR MEDIA HICKSII, MAL HICKS YEW 42" HT., FIELD GROWN, FULL, 500mm O.C. CLIMBERS TX 26 SMILACINA RACEMOSA FALSE SOLOMON'S SEAL #2 POTS 450mm O.C. CLIMBERS TX 26 SMILACINA RACEMOSA FALSE SOLOMON'S SEAL #2 POTS 450mm O.C. CLIMBERS TX 26 SMILACINA RACEMOSA FALSE SOLOMON'S SEAL #2 POTS 450mm O.C. CLIMBERS TX 26 SMILACINA RACEMOSA FALSE SOLOMON'S SEAL #2 POTS 450mm O.C. CLIMBERS TX 26 SMILACINA RACEMOSA FALSE SOLOMON'S SEAL #2 POTS 450mm O.C. CLIMBERS TX 26 SMILACINA RACEMOSA FALSE SOLOMON'S SEAL #2 POTS 450mm O.C. CLIMBERS TX 26 SMILACINA RACEMOSA FALSE SOLOMON'S SEAL #2 POTS 450mm O.C. CLIMBERS TX 26 SMILACINA RACEMOSA FALSE SOLOMON'S SEAL #2 POTS 450mm O.C. CLIMBERS TX 26 SMILACINA RACEMOSA FALSE SOLOMON'S SEAL #2 POTS 450mm O.C. TX 27 SMILACINA RACEMOSA FALSE SOLOMON'S SEAL #2 POTS 450mm O.C. CLIMBERS TX 27 SMILACINA RACEMOSA FALSE SOLOMON'S SEAL #2 POTS 450mm O.C. TX 27 SMILACINA RACEMOSA FALSE SOLOMON'S SEAL #2 POTS 450mm O.C. TX 27 SMILACINA RACEMOSA FALSE SOLOMON'S SEAL #2 POTS 450mm O.C. TX 27 SMILACINA RACEMOSA FALSE SOLOMON'S SEAL #2 POTS 450mm O.C. TX 28 SMILACINA RACEMOSA FALSE SOLOMON'S SEAL #2 POTS 500mm O.C. TX 28 SMILACINA RACEMOSA FALSE SOLOMON'S SEAL #2 POTS 500mm O.C. TX 29 SMILACINA RACEMOSA FALSE SOLOMON'S SEAL	Fc	150	FRAGARIA CHILOENSIS	COASTAL STRAWBERRY	#I POT	300mm O.C.
RS 36 RIBES SANGUINEUM FLOWERING CURRANT #3 POT 600mm O.C. TIT 100 TAXUS MEDIA HICKSII, MAL HICKS YEW #5 POTS 380mm O.C., MALE TX 35 TAXUS MEDIA HICKSII, MAL HICKS YEW 42" HT., FIELD GROWN, FULL 500mm O.C., MALE TO 43 THUJA OCCIDENTALIS SMARAGD EMERALD GREEN CEDAR 2.5M HEIGHT 500mm O.C. GRASS / PERENNIALS TY 26 SMILACINA RACEMOSA FALSE SOLOMON'S SEAL #2 POTS 450mm O.C. CLUMBERS TRACE OF SECURIAR SAMANDII EVERGREEN CLEMATIS 1200 O.C. GREEN ROOF THE TAX SHARAGD TO SOLOMON'S SEAL #2 POTS 450mm O.C. STATE OF SECURIAR SAMANDII EVERGREEN CLEMATIS 1200 O.C. THE TAX SHARAGD TO SOLOMON'S SEAL #2 POTS 450mm O.C. THE TAX SHARAGD TO SOLO	Gs	52	GAULTHERIA SHALLON	SALAL	#2 POT	300mm O.C.
TITI 100 TAXUS MEDIA HICKSII, MAL HICKS YEW #5 POTS 380mm O.C., MALE TIX 35 TAXUS MEDIA HICKSII, MAL HICKS YEW 42" HT., FIELD GROWN, FULL 500mm O.C., MALE TIX 35 TAXUS MEDIA HICKSII, MAL HICKS YEW 42" HT., FIELD GROWN, FULL 500mm O.C., MALE TO 43 THUJA OCCIDENTALIS SMARAGD EMERALD GREEN CEDAR 2.5M HEIGHT 500mm O.C. GRASS / PERENNIALS GRASS /	Pm	44	POLYSTICHUM MINUTUM	WESTERN SWORD FERN	#2 POT	500mm O.C.
TX 35 TAXUS MEDIA HICKSI, MAL HICKS YEW 42" HT., FIELD GROWN, FULL, 500mm O.C., MALE TO 43 THUJA OCCIDENTALIS SMARAGD EMERALD GREEN CEDAR 2.5M HEIGHT 500mm O.C. GRASS / PERENNIALS ST 26 SMILACINA RACEMOSA FALSE SOLOMON'S SEAL #2 POTS 450mm O.C. CLUMBERS ST 24 CLEMATIS ARMANDII EVERGREEN CLEMATIS 1200 O.C. GREEN ROOF ST 2450 SEDUM ACRE 8" O.C. 8b 850 SEDUM SPECTABILE 'BRILLIANT' 10" O.C.	Rs	36	RIBES SANGUINEUM	FLOWERING CURRANT	#3 POT	600mm O.C.
TO 43 THUJA OCCIDENTALIS SMARAGD EMERALD GREEN CEDAR 2.5M HEIGHT 500mm O.C. SGRASS / PERENNIALS	Tm	100	TAXUS MEDIA HICKSII, MAL	HICKS YEW	#5 POTS	380mm O.C., MALE
GRASS / PERENNIALS ir 26 SMILACINA RACEMOSA FALSE SOLOMON'S SEAL #2 POTS 450mm O.C. CLIMBERS ia 46 CLEMATIS ARMANDII EVERGREEN CLEMATIS 1200 O.C. GREEN ROOF ia 2450 SEDUM ACRE 8" O.C. ib 850 SEDUM SPECTABILE 'BRILLIANT' 10" O.C.	Tx	35	TAXUS MEDIA HICKSII, MAL	HICKS YEW	42" HT., FIELD GROWN, FUL	L, 500mm O.C., MALE
FALSE SOLOMON'S SEAL #2 POTS 450mm O.C.	То	43	THUJA OCCIDENTALIS SMARAGD	EMERALD GREEN CEDAR	2.5M HEIGHT	500mm O.C.
CLIMBERS 2a 46 CLEMATIS ARMANDII EVERGREEN CLEMATIS I 200 O.C. GREEN ROOF 2a 2450 SEDUM ACRE 8" O.C. 3b 850 SEDUM SPECTABILE 'BRILLIANT' 10" O.C.	GRA:	SS / PEF	RENNIALS			
Ea 46 CLEMATIS ARMANDII EVERGREEN CLEMATIS I 200 O.C. GREEN ROOF 1200 O.C. 8° O.C. 1200 O.C. 10° O.C.	sr	26	SMILACINA RACEMOSA	FALSE SOLOMON'S SEAL	#2 POTS	450mm O.C.
SPEEN ROOF	СЦМ	BERS				
32 2450 SEDUM ACRE 8" O.C. 35 850 SEDUM SPECTABILE 'BRILLIANT' 10" O.C.	ca	46	CLEMATIS ARMANDII	EVERGREEN CLEMATIS		1200 O.C.
850 SEDUM SPECTABILE 'BRILLIANT' 10" O.C.	GREE	N RO	OF			
	sa	2450	SEDUM ACRE			8" O.C.
f 2450 SEDUM FLORIFERUM 'WEINHENSTEPHANER GOLD' 8" O.C.	sb	850	SEDUM SPECTABILE 'BRILLIANT'			10" O.C.
	sf	2450	SEDUM FLORIFERUM 'WEINHENSTEPHANER	GOLD'		8" O.C.

PLANTING: GENERAL NOTES

I. ALL PLANT MATERIAL SHALL CONFORM TO THE STANDARD SPECIFIED IN THE CURRENT EDITION OF THE CANADIAN LANDSCAPE STANDARD. THIS STANDARD IS PUBLISHED JOINTLY BY THE CANADIAN SOCIETY OF LANDSCAPE ARCHITECTS (CSLA) AND THE CANADIAN NURSERY LANDSCAPE ASSOCIATION (CNIA).

2. SEARCH AREA FOR ALL PLANT MATERIAL SHALL BE: PACIFIC NORTHWEST INCLUDING BRITISH COLUMBIA. WASHINGTON, AND OREGON.

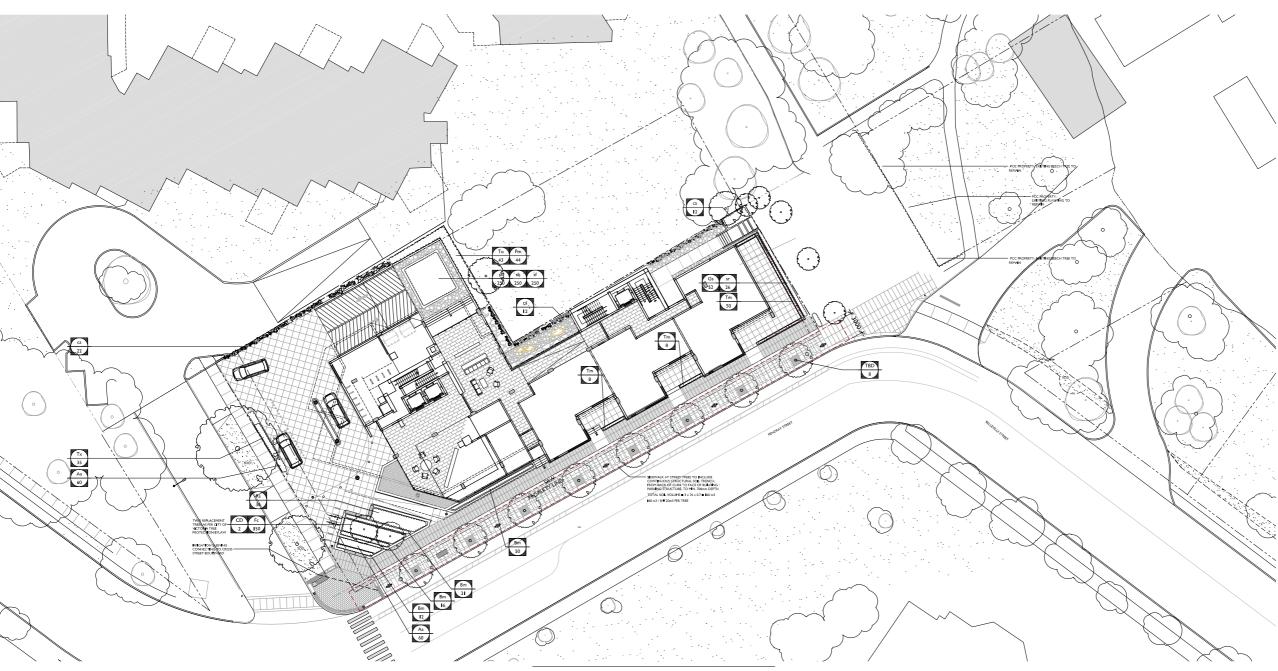3. PLANT MATERIAL SIZES SPECIFIED ARE THE MINIMUM ACCEPTABLE SIZES TO BE SUPPLIED TO THIS PROJECT. 4. ALL PLANT MATERIAL SHALL BE WELL-ESTABLISHED AND UNIFORM IN SHAPE AND SIZE. TREES SHALL BE IN GOOD HEALTH AND VIGOR WITH NO VISIBLE SIGNS OF DISEASE, INSECT PESTS, DAMAGE, OR OTHER

DISFIGUREMENTS.

5. ALL PLANT MATERIAL SHALL BE NURSERY GROWN UNLESS OTHERWISE NOTED. ONLY CERTIHED S.O.D.

NURSERY STOCK WILL BE ACCEPTED.

6. THE CONTRACTOR SHALL PROVIDE A GROWING MEDIUM ANALYSIS FOR REVIEW BY THE CONSULTANT - AS

PER SPECIFICATIONS - PRIOR TO THE START OF CONSTRUCTION, GROWING MEDIUM SUPPLIED TO THE SITE OR

INSTALLED ON SITE PRIOR TO CONSULTANT APPROVAL SHALL BE REJECTED AT NO COST TO THE OWNER.

7. THE CONTRACTOR SHALL CONFIRM PLANT QUANTITIES ON THE DRAWINGS CORRESPOND TO THOSE

NUMBER OF CONTRACTOR SHALL CONFIRM PLANT QUANTITIES ON THE DRAWINGS CORRESPOND TO THOSE INDICATED ON THE PLANT LIST. ANY DISCREPANCIES ARE TO BE VERIFIED BY THE CONSULTANT FOR REVIEW AND RESPONSE.

AND RESPONSE.

8. PLANT LIST TO BE READ IN CONJUCTION WITH SPECIFICATIONS FOR COMPLIANCE.

9. PRIOR TO THE START OF CONSTRUCTION, THE CONTRACTOR SHALL CONFIRM THE AVAILABILITY OF THE PLANT MATERIAL SPECIFIED AS PER SPECIFICATIONS, ALLOWING FOR ANY AND ALL REQUIRED APPROVALS. PLANT SUBSTITUTIONS NOT CONFIRMED AND A PROVADE BY THE CONSULTANT WILL BE REJECTED.

10. PROVIDE IRRIGATION TO ALL PLANT MATERIAL AS SHOWN ON LANDSCAPE DRAWINGS AND PLANS. PLANTING BENEATH PATIOS AND VERHANGS SHALL BE IRRIGATED ON SEPARATELY VALVED IRRIGATION SYSTEM, THROUGH HEATED GARAGE, WHICH CAN OPERATE DURING WINTER MONTHS.

11. IRRIGATION MUST MEET THE STANDARDS FOR IRRIGATION INSTALLATION SET OUT IN THE CITY OF MICHOLOGY.

VICTORIA SUPPLEMENTARY SPECIFICATIONS FOR STREET TREES AND IRRIGATION, SCHEDULE C, TO VICTORIA

SUBDIVISION AND DEVELOPMENT SERVICING BYLAW

SUBDIVISION AND DEVELOPMENT SERVICING BYLAW.

12. THE PARKS DIVISION MUST INSPECT THE IRRIGATION SYSTEM PRIOR TO BACKFILLING AND AGAIN WHEN THE SYSTEM IS FUNCTIONING.

13. PUBLIC REALM IMPROVEMENTS, INCLUDING STREET TREES, STREET-SIDE ORNAMENTAL GRASSES, SOD, AND PLAZA PLANTING ARE TO BE IRRIGATED BY AN AUTOMATIC IRRIGATION SYSTEM, FROM A DESIGNATED CITY WATER SOURCE. AN IRRIGATION SYSTEM WITH A SEPARATE WATER SERVICE AND DOUBLE CHECK VALVE, FOR TREE WATERING RINGS ONLY, SHALL BE ADDED FOR THE PROPOSED BOULEVARD TREES ALONG BELLEVILLE ST.

14. AN "AS BUILT" PLAN MUST BE SUBMITTED TO THE PARKS DIVISION AFTER INSTALLATION.

15. SIDEWALK AT STREET TREES TO INCLUDE CONTINUOUS STRUCTURAL SOIL TRENCH, FROM BACK OF CURB TO FACE OF BUILDING / PARKING STRUCTURE. TO MIN, 700mm DEPTH.

16. TREES TO BE PROCURED AND PLANTED BY APPLICANT.

16. TREES TO BE PROCURED AND PLANTED BY APPLICANT.
17. TREES INDEPTIFIED AS 'REPLACEMENT TREES' AS PER CITY OF VICTORIA TREE PROTECTION BYLAW SHALL
MEET CITY OF VICTORIA TREE REPLACEMENT GUIDELINES, INCLUDING:

SHALL BE IN GOOD HEALTH AND VIGOUR WITH NO VISIBLE SIGNS OF DISEASE, INSECT PESTS, DAMAGE, OR OTHER DISFIGUREMENTS, AND SHALL COMPLY WITH THE LATEST VERSION OF THE 'CANADIAN LANDSCAPE STANDARDS' PUBLISHED BY THE CANADIAN SOCIETY OF LANDSCAPE ARCHITECTS AND CANADIAN NUSERY LANDSCAPE ASSOCIATION.

STREET TREE INSPECTION NOTES:

THE PROPOSED BOULEVARD TREES MUST COMPLY TO CITY OF VICTORIA SUPPLEMENTARY SPECIFICATIONS FOR STREET TREES AND IRRIGATION SCHEDULE C, BYLAW 12-042, SUBDMISION BYLAW AND THE CURRENT VERSION OF THE CANADIAN LANDSCAPE STANDARD. PLANTING DETAILS CAN BE FOUND IN SCHEDULE B3-4. THE FOLLOWING TREE INSPECTIONS BY PARKS STAFF ARE REQUIRED BY SCHEDULE C. TO SCHEDULE AN INSPECTION PLEASE CONTACT ROB HUGHES, rhughes@victoria.ca AND ALSO COPY treepermits@victoria.ca 48 HOURS PRIOR TO THE REQUIRED INSPECTION TIME.

TREE PLANTING INSPECTIONS:

EXCAVATED TREE PITS, SOIL CELLS, ROOT BARRIERS

TREES PRIOR TO PLANTING. (PARKS STAFF CAN INSPECT TREES PRIOR TO SHIPPING AT LOCAL NURSERIES. PHOTOS CAN BE PROVIDED FROM UP-ISLAND AND MAINLAND NURSERIES. TREE MUST MEET THE SPEC UPON DELIVERY.)

COMPLETED PLANTING - TREE PLANTING, GRATE/GUARD, STAKES, ETC.

IRRIGATION INSPECTION NOTES:

IRRIGATION SYSTEMS ON CITY PROPERTY SHALL COMPLY TO CITY OF VICTORIA SUPPLEMENTARY SPECIFICATIONS FOR STREET TREES AND IRRIGATION SCHEDULE C, BYLAW 12-042, SUBDIVISION BYLAW. IRRIGATION DRAWINGS MUST BE SUBMITTED TO PARKS DIVISION FOR REVIEW AND APPROVAL 30 DAYS PRIOR TO INSTALLATION WORK. THE FOLLOWING IRRIGATION AND SLEEVING INSPECTIONS BY PARKS STAFF ARE REQUIRED BY SCHEDULE C. TO SCHEDULE AN INSPECTION PLEASE CONTACT CHUCK BASS, CASS@\(\)CASS@\(\)COS COPY Treepermits@\(\)KOTALA AND KYLE MCMORRAN \(\)kmcmorran@\(\)victoria.ca AND KYLE MCMORRAN \(\)kmcmorran@\(\)victoria.ca AND THE REQUIRED INSPECTION TIME.

IRRIGATION INSPECTION REQUIREMENTS:

- THE IRRIGATION SYSTEM AND SLEEVING INSPECTION REQUIREMENTS CAN BE FOUND IN

- THE IRRIGATION SYSTEM AND SLEEVING INSPECTION REQUIREMENTS CAN BE FOUND IN SCHEDULE C OF THE WICTORIA SUBDIVISION AND DEVELOPMENT SERVICING BYLAW NO. 12-042. IRRIGATION SLEEVING PRIOR TO BACKFILLING OPEN TRENCH MAIN LINE AND PRESSURE TEST OPEN TRENCH LATERAL LINE IRRIGATION SYSTEM, CONTROLLER, COVERAGE TEST, BACKFLOW PREVENTER ASSEMBLY TEST REPORT REQUIRED, BACKFLOW ASSEMBLY IS TO HAVE AN INSPECTION TAG COMPLETE AND ATTACHED.
- PLEASE NOTE: PARKS IS NOW REQUESTING THAT 100mm SDR 28 PIPE BE USED FOR IRRIGATION SLEEVING UNDER HARD SURFACES. INSTALLATIONS WHERE A 90-DEGREE BEND IS REQUIRED SHOULD BE INSTALLED USING 100mm SDR 28 GSX (22.5 DEGREE) LONG SWEEPS. PLEASE INSTALL AT

257 BELLEVILLE STREET

> VICTORIA. BRITISH COLUMBIA.

no.	issued for	date
	Development Permit	Nov 15/10
	Revised Development Permit	Feb 04/11
	Revised Development Permit	Feb 16/11
	Revised Development Permit	Apr 29/11
	Issued for Costing	Nov 07/11
	Re-issued for Development Permit	Dec 05/12
	Re-issued for Development Permit	Nov 26/20
	Re-issued for Development Permit-	lune 03/21
	For Coordination	July 30/21
	Re-issued for Development Permit	Dec 06/21
	Re-issued for Development Permit	Jul 10/23

consultar





CALGARY EDMONTO www.mtalink.com 301, 215 - 10th Ave 5W

p 403.264.8700 f 403.264.8029

marshall tittemore architects Creating memorable place

PLANTING PLAN

GROUND FLOOR

checked

1:200





VICTORIA, BRITISH COLUMBIA.

PFS STUDIO 1777 West 3th August 1912 Various of 18C V6 504.736.5388 of 186 (64.65).

301, 215 - 10th Ave 5W Calgary Alberta T2R 0A4 p 403.264.8700 f 403.264.8029

drawing title

PLANTING PLAN -ROOF LEVELS

1:200

ACER RUBRUM 'BOWHALL' BOWHALL UPRIGHT RED MAPLE

ACER RUBRUM 'RED SUNSET' RED SUNSET RED MAPLE

STYRAX JAPONICA -JAPANESE SNOWBALL


TAXUS MEDIA 'HICKSII' -HICK'S YEW

BUXUS JAPONICUM -

'GREEN BEAUTY' BOXWOOD

STIPA TENNUISIMA -MEXICAN FEATHER GRASS


SHRUBS / GROUNDCOVERS

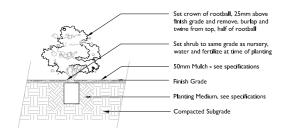


SHRUB PLANTING ON GRADE

L3.1 SCALE: 1:25

SIM L3.2

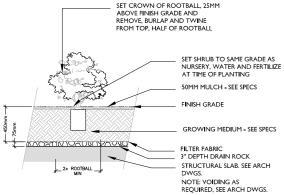

SHRUB PLANTING ON SLAB L3.I SCALE: 1:25

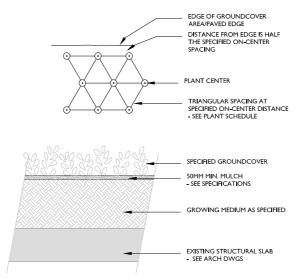


GROUNDCOVER ON SLAB L3.I SCALE: I:20

PREPARATION NOTES:

- CONTAINER GROWN:
 REMOVE COMPLETELY FROM CONTAINER
- 2. BURLAP AND ROPE: REMOVE TOP 1/3 OF COVERING

3. WIRE AND BURLAP:


REMOVE TOP ½ OF WIRE, ROPE AND
BURLAP COVERING WITHOUT
DAMAGING ROOTBALL. REMOVE ALL
TWINE.

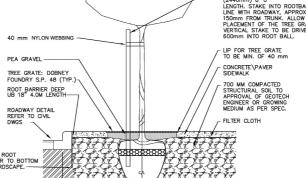


ALL TREES SHALL MEET OR EXCEED THE CITY OF VICTORIA TREE SPECIFICATIONS

CITY OF VICTORIA TREE PLANTING IN BOULEVARD DETAIL SD P5


COMPACTED SUBGRA TO 98% S.P.D.

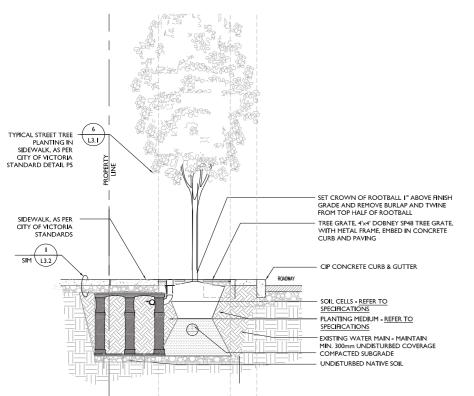

TYPICAL STREET TREE PLANTING W/ TREE GRATE AND STRUCTURAL SOIL L3.I SCALE: I:25

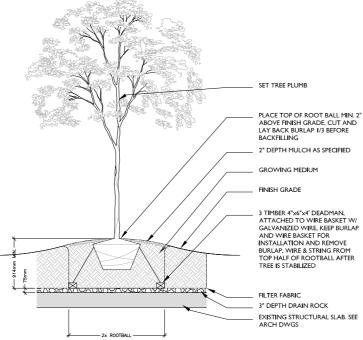

DECIDUOUS TREE PLANTING ON SLAB L3.1 SCALE: 1:25

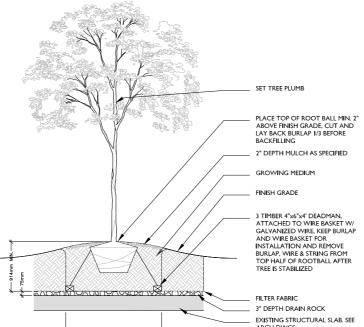

RUDBECKIA 'GOLDSTURM' -















257 BELLEVILLE STREET

VICTORIA, BRITISH COLUMBIA.

no.	issued for	date
	Development Permit	Nov 15/10
	Revised Development Permit	Feb 04/11
	Revised Development Permit	Feb 16/11
	Revised Development Permit	Apr 29/11
	Issued for Costing	Nov 07/11
	Re-issued for Development Permit	Dec 05/12
	Re-issued for Development Permit	Nov 26/20
	Re-issued for Development Permit	June 03/21
	For Coordination	July 30/21
	Re-issued for Development Permit	Dec 06/21
	Re-issued for Development Permit	Jul 10/23



WPFS STUDIO WARCOVER BC VI GOLFFE GOLFFF GOLFFE GOLFFF GOLFFE G



301, 215 - 10th Ave 5W


marshall tittemore architects

drawing title

PLANTING DETAILS


L3.1

AS NOTED checked 08005

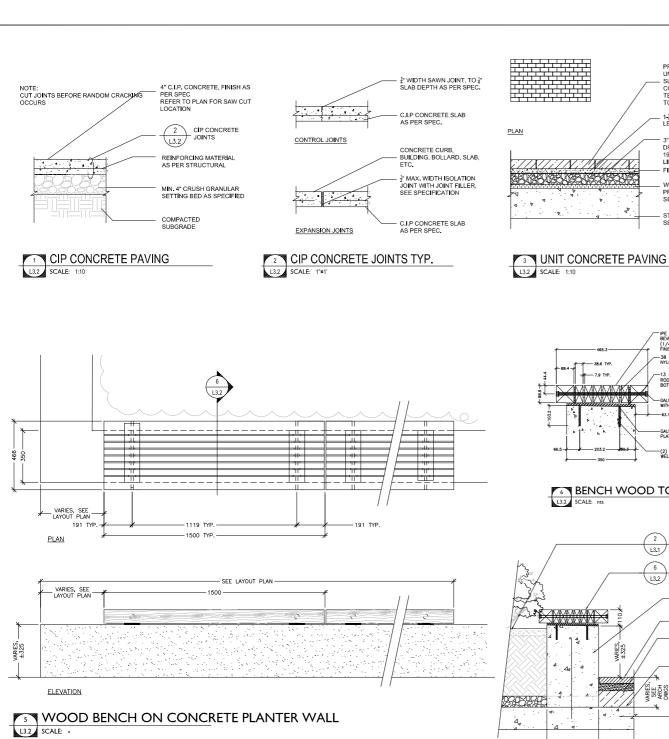

7 WOOD SCREEN

L3.2 SCALE: -

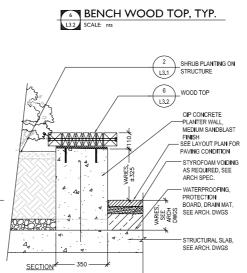

STEEL ROD BOLTED TO WELDED BRACKET

BOLT FITS WITHIN STEEL PLATE ON TUBE

- IPE 2X4 BEAMS

PRECAST CONCRETE UNIT HYDROPRESSED SLAB PAVERS.

COLOUR: CHARCOAL, TEXADA FINISH REFER TO LAYOUT PLAN

DRAINAGE COURSE 19MM Ø CLEAR LIMESTONE

WATERPROOFING AND PROTECTION BOARD -SEE ARCH DWGS


STRUCTURAL SLAB SEE ARCH DWGS

-38 (1-1/2") x 9 (1/3") THICK NYLON SPACER


GALV. STEEL PLATE WITH UPSTAND PLATES, AS DETAILED


(2) 4 x 1/2" DIA. REIN. RODS, WELDED TO PLATE AS DIM.


FILTER BLANKET

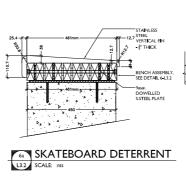

UPSTAND PLATE

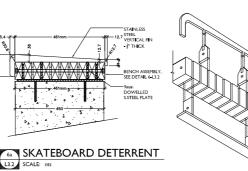

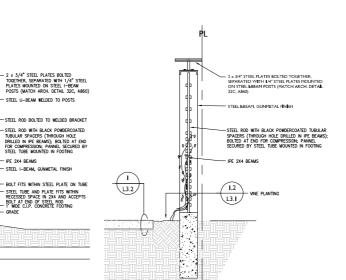

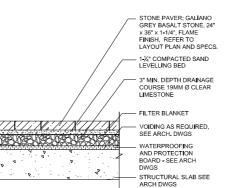

STONE PAVING ON STRUCTURE



EXAMPLE



BIKE RACK - EXAMPLE



BOLLARD LIGHT - EXAMPLE



WOOD TOP BENCH - EXAMPLE



WOOD SCREEN - EXAMPLE

VICTORIA, BRITISH COLUMBIA.

257 BELLEVILLE

STREET

no.	issued for	date
	Development Permit	Nov 15/10
	Revised Development Permit	Feb 04/11
	Revised Development Permit	Feb 16/11
	Revised Development Permit	Apr 29/11
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	Re-issued for Development Permit	Dec 06/21
	Re-issued for Development Permit	Jul 10/23







301, 215 - 10th Ave 5W Calgary Alberta T2R 6A4 p 403,264,8700 f 403,264,8029

marshall tittemore architects


drawing title

LANDSCAPE SECTIONS and DETAILS


L3.2 checked 08005




SECTION KEY

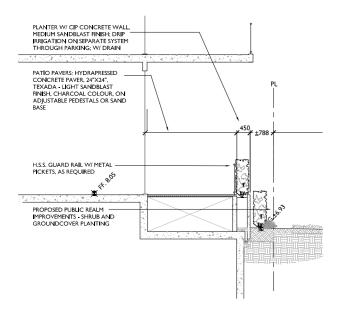


SECTION 2 - AT PUBLIC R.O.W., NORTH-WEST 3.3 SCALE: 1:50

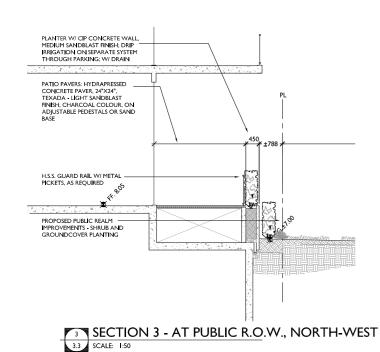

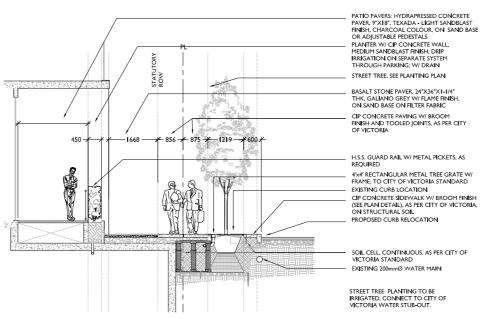

SECTION I - AT PENDRAY STREET - STREET TREE & GRATE
33 SCALE 1:50

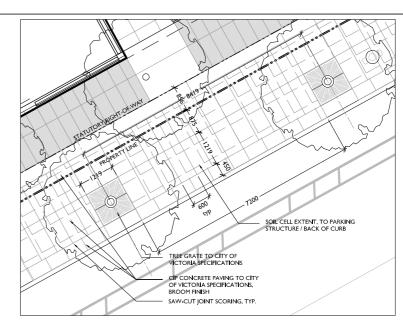


PLAN DETAIL- PENDRAY STREET SIDEWALK PAVING 3.3 SCALE: 1:50

PLAN DETAIL DELETED

PLAN DETAIL DELETED

PLAN DETAIL DELETED

PLAN DETAIL - PUBLIC R.O.W., NW (N.I.C.)

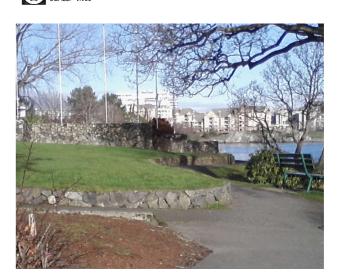

PRECEDENT: CENTENNIAL PARK - LOW WALL W/ STONE FACING

VICTORIA, BRITISH COLUMBIA.

257 BELLEVILLE

STREET

Deve Revised Revised	elopr	velop	Permi			Nov	date
Revised	De	velop				Nov	15/10
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Revised	1 De			re	rmit	Feb	04/11
		velop	ment	Pe	rmit	Feb	16/1
Revised	d De	velop	ment	Pe	rmit	Apr	29/1
Is	sue	for	Costi	ng		Nov	07/1
-issued	for	Deve	lopme	nt	Permit	Dec	05/12
-issued	for	Deve	lopme	nt	Permit	Nov	26/20
-issued	for	Deve	lopme	nt	Permit	June	03/2
F	or C	oordi	nation	1		July	30/2
-issued	for	Deve	lopme	nt	Permit	Dec	06/2
-issued	for	Deve	lopme	ent	Permit	Jul	10/23
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marshall tittemore architects

LANDSCAPE SECTIONS and DETAILS

L3.3 checked

08005