


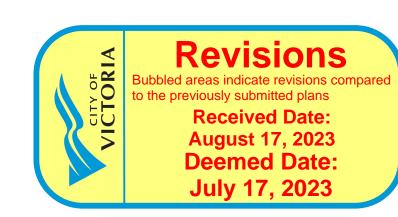

# Urban Design Architecture Interior Design

REISSUED FOR DEVELOPMENT PERMIT APRIL 11, 2022





# architectural

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### landscan

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**Building Sections** 

# 257 BELLEVILLE STREET

VICTORIA, BRITISH COLUMBIA

Prepared for the City of Victoria on behalf of ADZ Properties Ltd.

Client

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CONT'D

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**DRAWING REFERENCE SYMBOLS:** SHEET NUMBER WHERE LOCATED A0.0 **ELEVATION NUMBER** SHEET NUMBER WHERE LOCATED A0.0 SECTION NUMBER SHEET NUMBER WHERE LOCATED **ELEVATION NUMBER** INTERIOR ELEVATION NUMBER SHEET NUMBER WHERE LOCATED INTERIOR ELEVATION NUMBER **ELEVATION NUMBER** SHEET NUMBER WHERE LOCATED 1 TITLE - DRAWING TITLE A0.0 SCALE DRAWING SCALE SHEET NUMBER WHERE LOCATED 1- TITLE - DRAWING TITLE A00 SCALE - DRAWING SCALE SHEET NUMBER WHERE LOCATED SHEET NUMBER REFERENCED FROM TITLE -VHEIGHT**→** OBIECT HEIGHT FROM A GIVEN ELEVATION SLOPE UP -SLOPE DIRECTION SLOPE INCRIMENT C1 Q00 AFE HEIGHT ABOVE FINISHED FLOOR 000 A SUB KEYNOTE REFERNECE KEYNOTE REFERENCE NUMBER

> DOOR TYPE (P1) INTERIOR WALL ASSEMBLY (E1) EXTERIOR WALL ASSEMBLY 0000 ROOM NAME (R1) ROOF ASSEMBLY (F1) FLOOR ASSEMBLY 0000 AFF CEILING HEIGHT EL 0000.00 SPOT ELEVATION W1 WINDOW TYPE EXIST'G ELEVATION **—·———** 45 MINUTE FIRE RATING — · · · — · · — 1.5 HOUR FIRE RATING

SYMBOL LEGEND

**DIMENSION NOTES:** 

• ALL WALL DIMENSIONS ARE TO FACE OF CONCRETE OR FACE OF STUD UNLESS OTHERWISE NOTED. • CLEAR DIMENSIONS ARE FROM FINISH SURFACE TO FINISH

• INTERIOR DOOR ROUGH OPENINGS ARE EITHER TO BE CENTRED IN WALL BETWEEN ADJOINING WALLS OR 150mm FROM AN ADJOINING WALL AS SHOWN ON FLOOR PLANS UNLESS NOTED OTHERWISE.

# **EXTERIOR WALL ASSEMBLY SCHEDULE**

**EXTERIOR WALL ABOVE GRADE:** 

 EXTERIOR FINISH - CLADDING TBD 50MM (R10) RIGID INSULATION ON 100 MM Z-GIRTS

 15.9 MM EXTERIOR SHEATHING 152MM STEEL STUDS C/W RSI 3.5 (R20) BATT INSULATION VAPOUR BARRIER GYPSUM WALL BOARD

PAINT FINISH

THE USE OF HIGHLY CONDUCTIVE METAL FRAMING IS OFFSET THROUGH THE USE OF A CONTINUOUS LAYER OF RIGID INSULATION OVER THE MAIN MEMBERS. FOUNDATION WALLS INCLUDE THE CONTINUATION OF RIGID INSULATION FROM THI

**FOUNDATION WALL BELOW GRADE:** 

 DRAINAGE LAYER BENTONITE LAYER (IF REQUIRED) FOUNDATION WATERPROOFING CONCRETE FOUNDATION WALL

# WINDOWS

CLEAR ANODIZED ALUMINUM WINDOW-WALL SYSTEM. THE INTERIOR FRAMES MAY BE WOOD CLAD WITH MILLED WOOD SILLS. THE FLANGE SIDE OF EACH WINDOW IS TO CONFORM TO A PRECISE SEQUENCE OF MEMBRANE INSTALLATION. THE VAPOUR BARRIERS, AND AIR BARRIERS MUST TIE INTO THE ROUGH OPENING OF ALL WINDOW SYSTEMS AT THE WINDOW PLANE

THE GLAZING DOUBLE GLAZED WITH A LOW- E COATING ON SURFACE 3 FOR THE SEALED UNIT. CONSIDER GLAZING AND FRAMES OF THE HIGHEST AFFORDABLE INSULATING VALUE AND THERMAL PERFORMANCE. AN ADDITIONAL TINT IS RECOMMENDED ON THE GLASS TO REDUCE SOLAR HEAT GAIN.

DEVICES MAY BE USED ON THE EAST AND WEST FACADES IF REQUIRED AS WELL.

FINALLY, THE SLENDER MASSING AND STEPPING ALLOWS FOR INCREASED DAYLIGHT

HORIZONTAL SOLAR SHADING DEVICES AND OVERHANGS MAY BE USED TO REDUCE SOLAR GAIN EXPOSURE ON THE SOUTH FAÇADE. ADDITIONAL, VERTICAL SHADING

**ROOF ASSEMBLY** 

THE CURRENT ASSEMBLY CONTEMPLATES THE FOLLOWING OPTIONS: OPTION #1 - ROOFS AND DECKS

 BALLAST - GRAVEL, DECKING, OR CONCRETE PAVERS FILTER CLOTH

 DRAINAGE MAT PROTECTION BOARD • 150MM (R 30) RIGID INSULATION SLOPED TO DRAIN

 WATERPROOF PROOFING MEMBRANE (AIR/VAPOUR BARRIER) CONCRETE STRUCTURE RESILIENT CHANNELS

ACOUSTIC INSULATION

 GYPSUM WALL BOARD **OPTION #2 - ROOFS AND DECKS** 

 CONCRETE PAVERS SBS ROOFING BASE SHEET FIBER BOARD

> • 150MM (R 30) RIGID INSULATION SLOPED TO DRAIN PROTECTION BOARD • SELF ADHERING AIR / VAPOUR BARRIER MEMBRANE CONCRETE STRUCTURE

 RESILIENT CHANNELS ACOUSTIC INSULATION

TYPICAL ROOF AT LANDSCAPE

 PLANTING SOIL (DEPTH VARIES) FILTER FABRIC

 DRAINAGE MAT 150MM (R 30) RIGID INSULATION SLOPED TO DRAIN WATERPROOF PROOFING MEMBRANE (AIR/VAPOUR BARRIER) • CONCRETE STRUCTURE

GENERAL NOTES AND **ASSEMBLIES** 

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POR, DS project no. 20.118

**257 BELLEVILLE STREET** 

**VICTORIA, BRITISH COLUMBIA** 

issued for **DEVELOPMENT PERMIT** OCT 23/2012 **DP ADDITIONAL ITEMS** DEC 05/2012 DEVELOPMENT PERMIT MAR 16/2020 REISSUED DEVELOPMENT PERMIT REISSUED DEVELOPMENT PERMIT REISSUED DEVELOPMENT PERMIT

consultant

alan lowe architect inc.



t. 403.264.8700 f. 403.264.8029

> Urban Design Architecture Interior Design drawing title

A0.01

sheet



**VIEW FROM BELLEVILLE STREET** 



**VIEW FROM INNER HARBOR** 




**VIEW FROM QUEBEC STREET** 



VIEW FROM PENDRAY & QUEBEC STREET

VICTORIA, BRITISH COLUMBIA

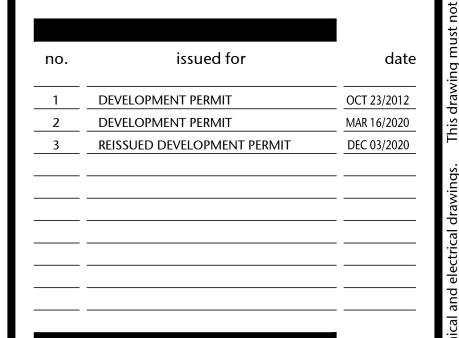



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PERSPECTIVES

A0.02

drawn DL

AS SHOWN

project no.
20 118

drawing title

# MARCH SHADOW STUDIES

JUNE SHADOW STUDIES

MARCH 21ST 2011 - 10.00am

MARCH 21ST 2011 - 12.00pm



MARCH 21ST 2011 - 2.00pm

JUNE 21ST 2011 - 10.00am



JUNE 21ST 2011 - 12.00pm



JUNE 21ST 2011 - 2.00pm

# SEPTEMBER SHADOW STUDIES



SEPTEMBER 21ST 2011 - 10.00am



SEPTEMBER 21ST 2011 - 12.00pm



SEPTEMBER 21ST 2011 - 2.00pm

# **DECEMBER SHADOW STUDIES**



DECEMBER 21ST 2011 - 10.00am




DECEMBER 21ST 2011 - 12.00pm



DECEMBER 21ST 2011 - 2.00pm



VICTORIA, BRITISH COLUMBIA

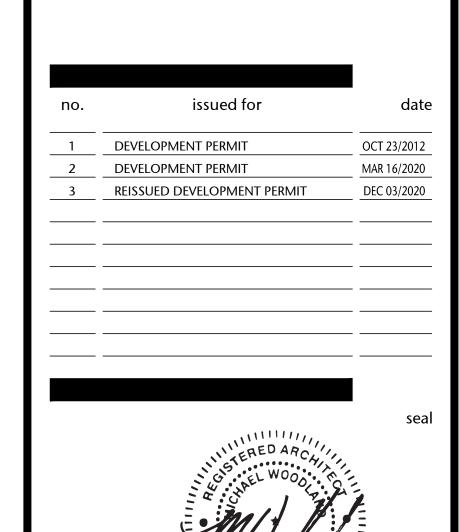

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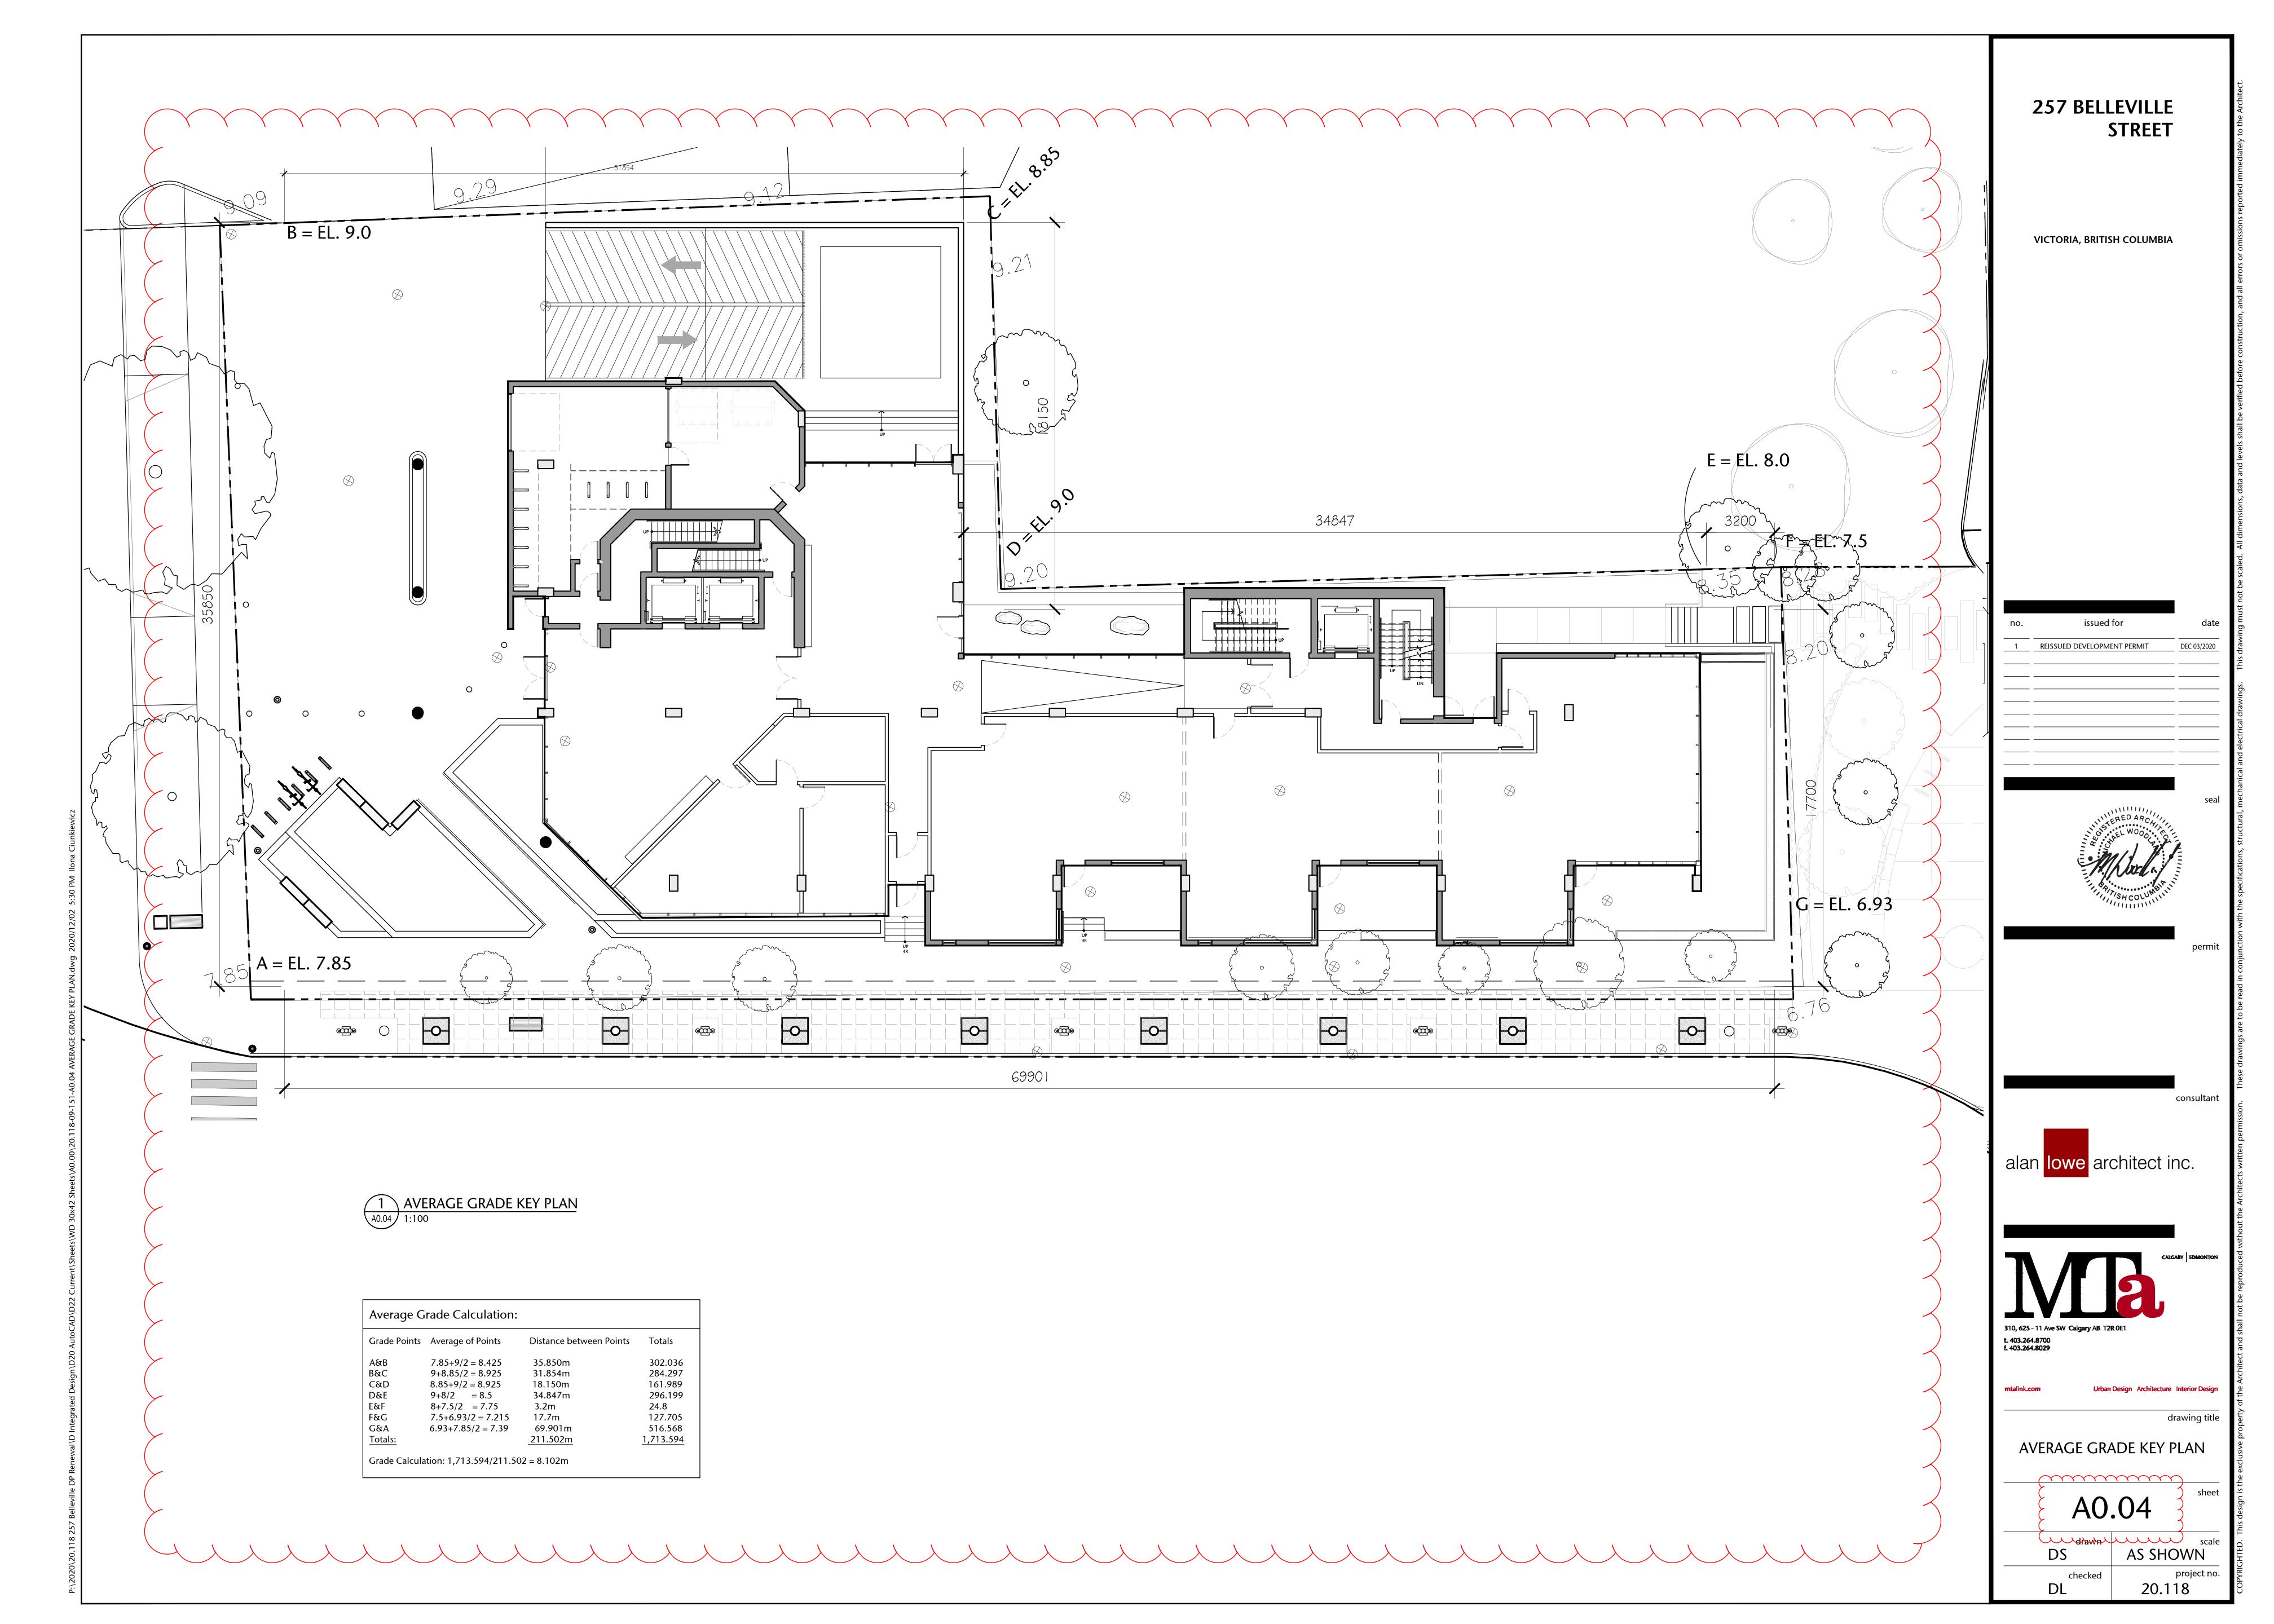
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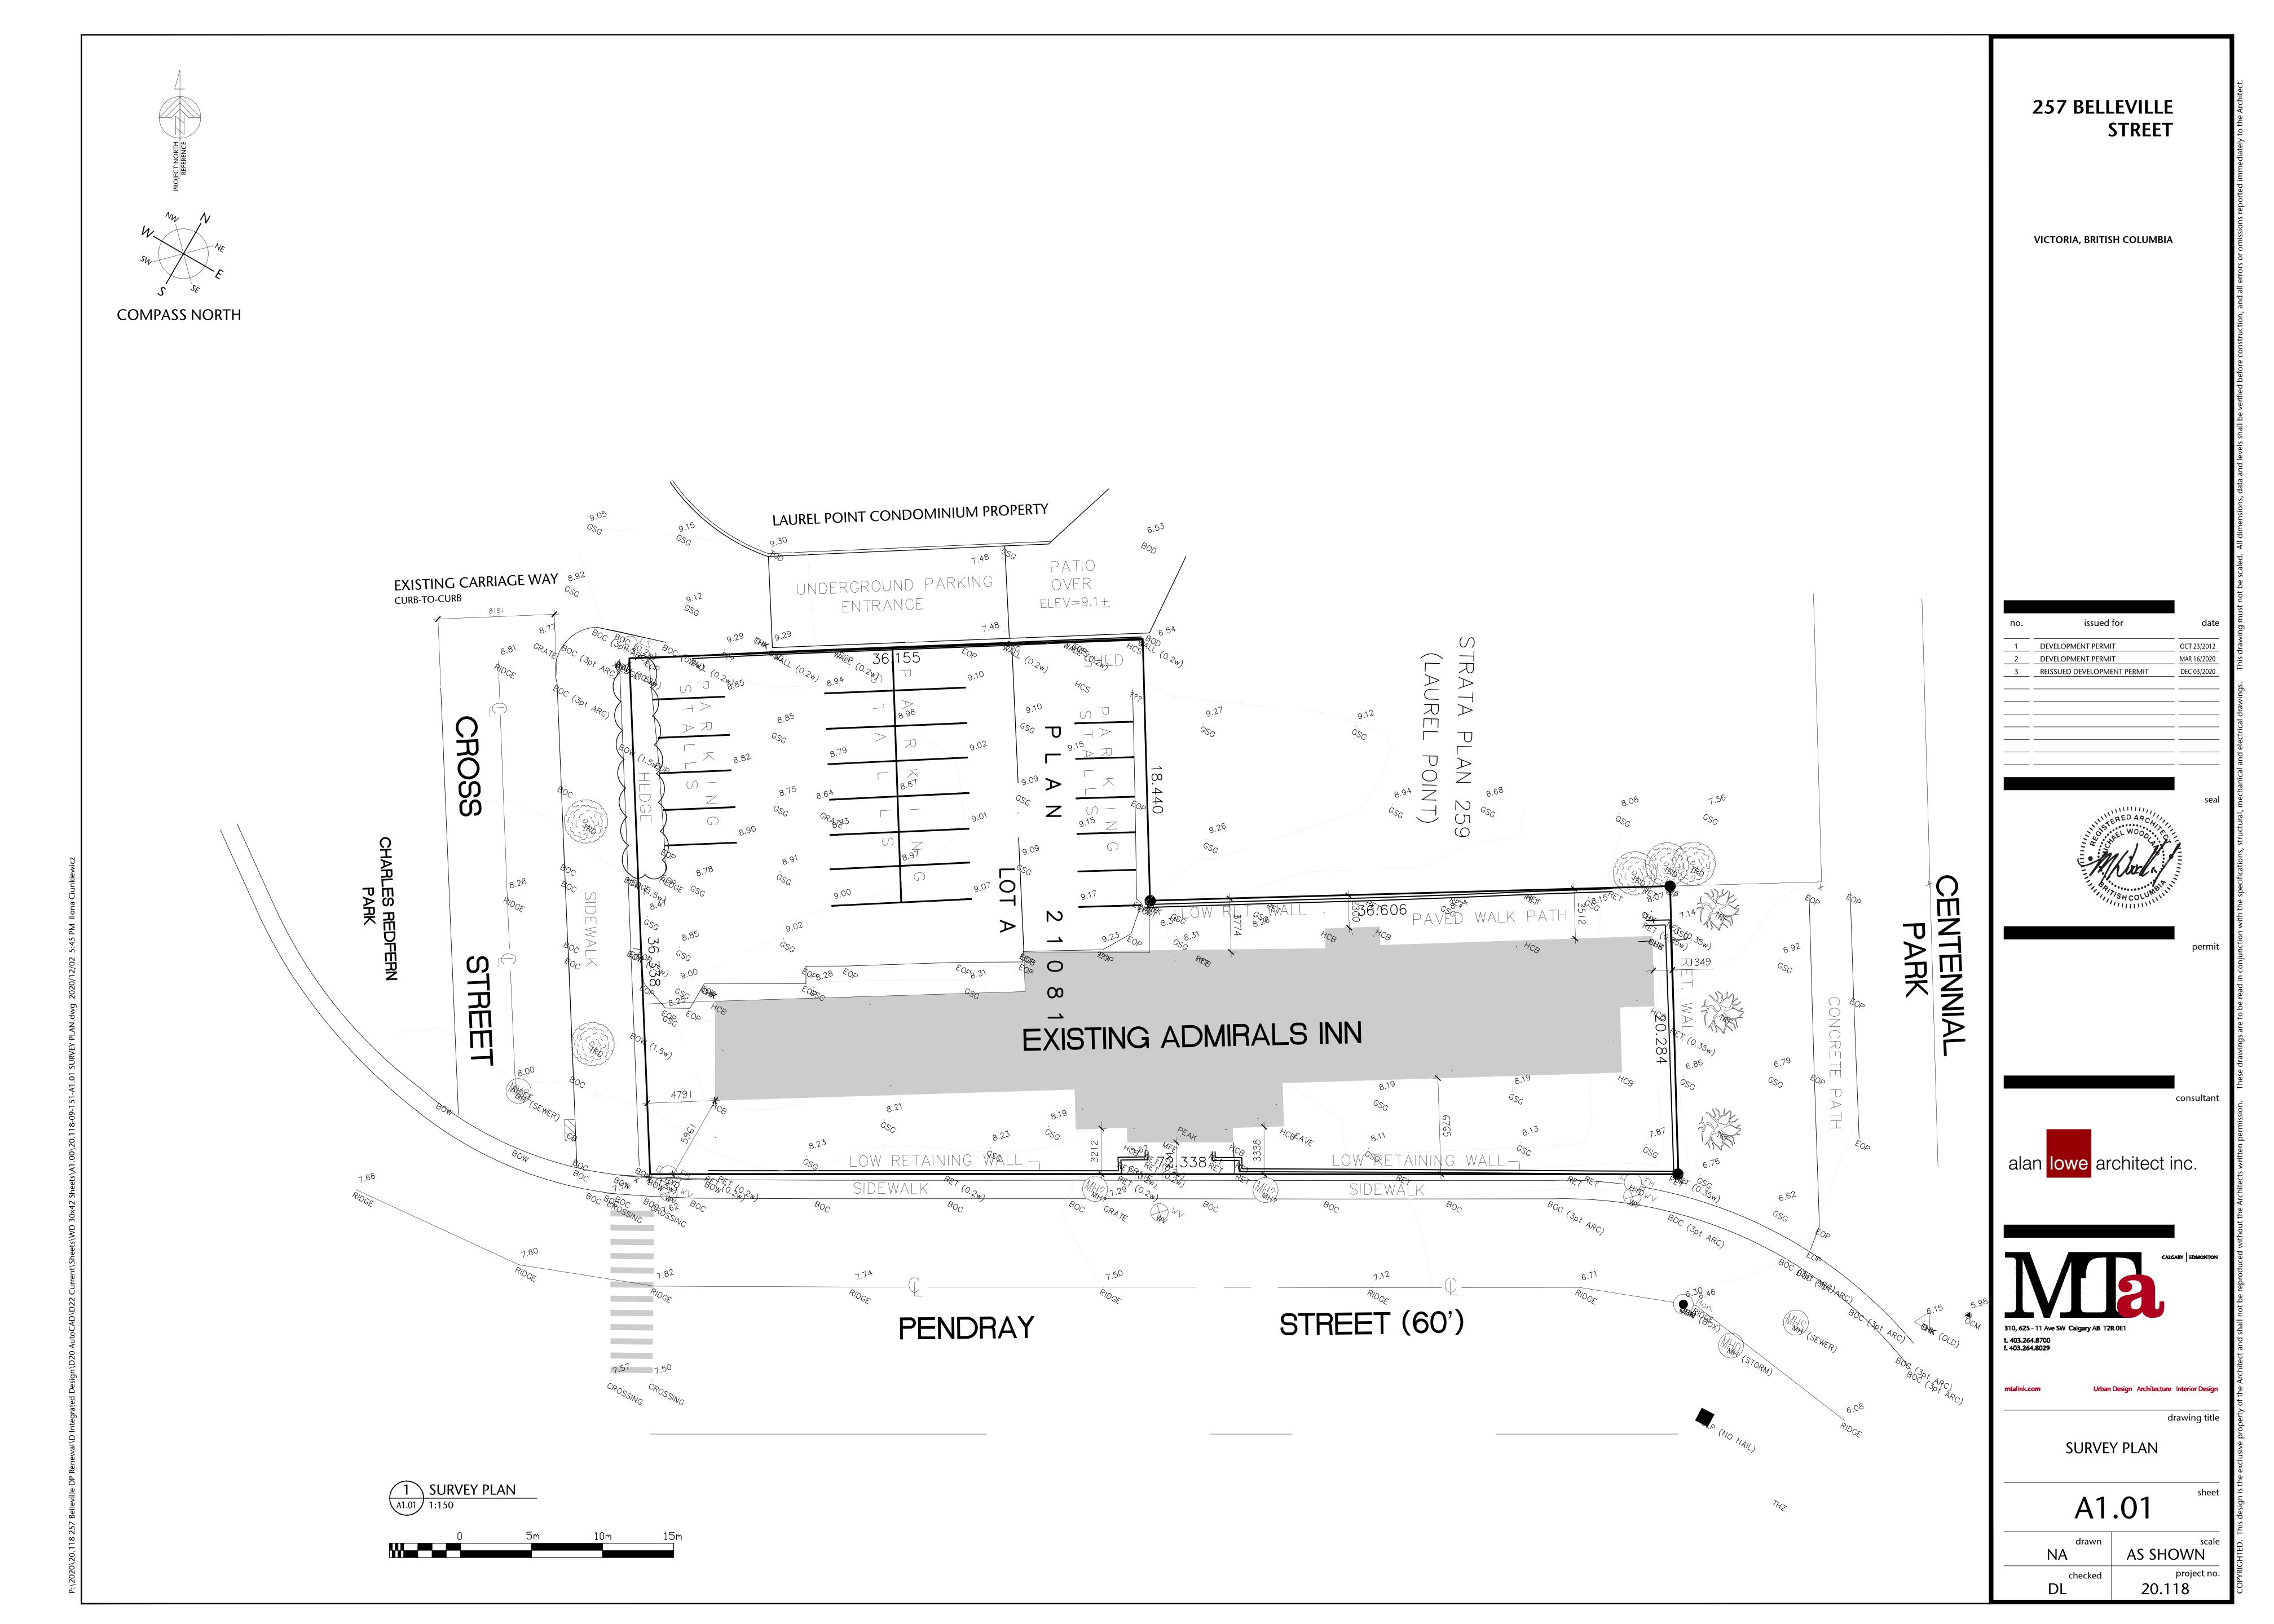
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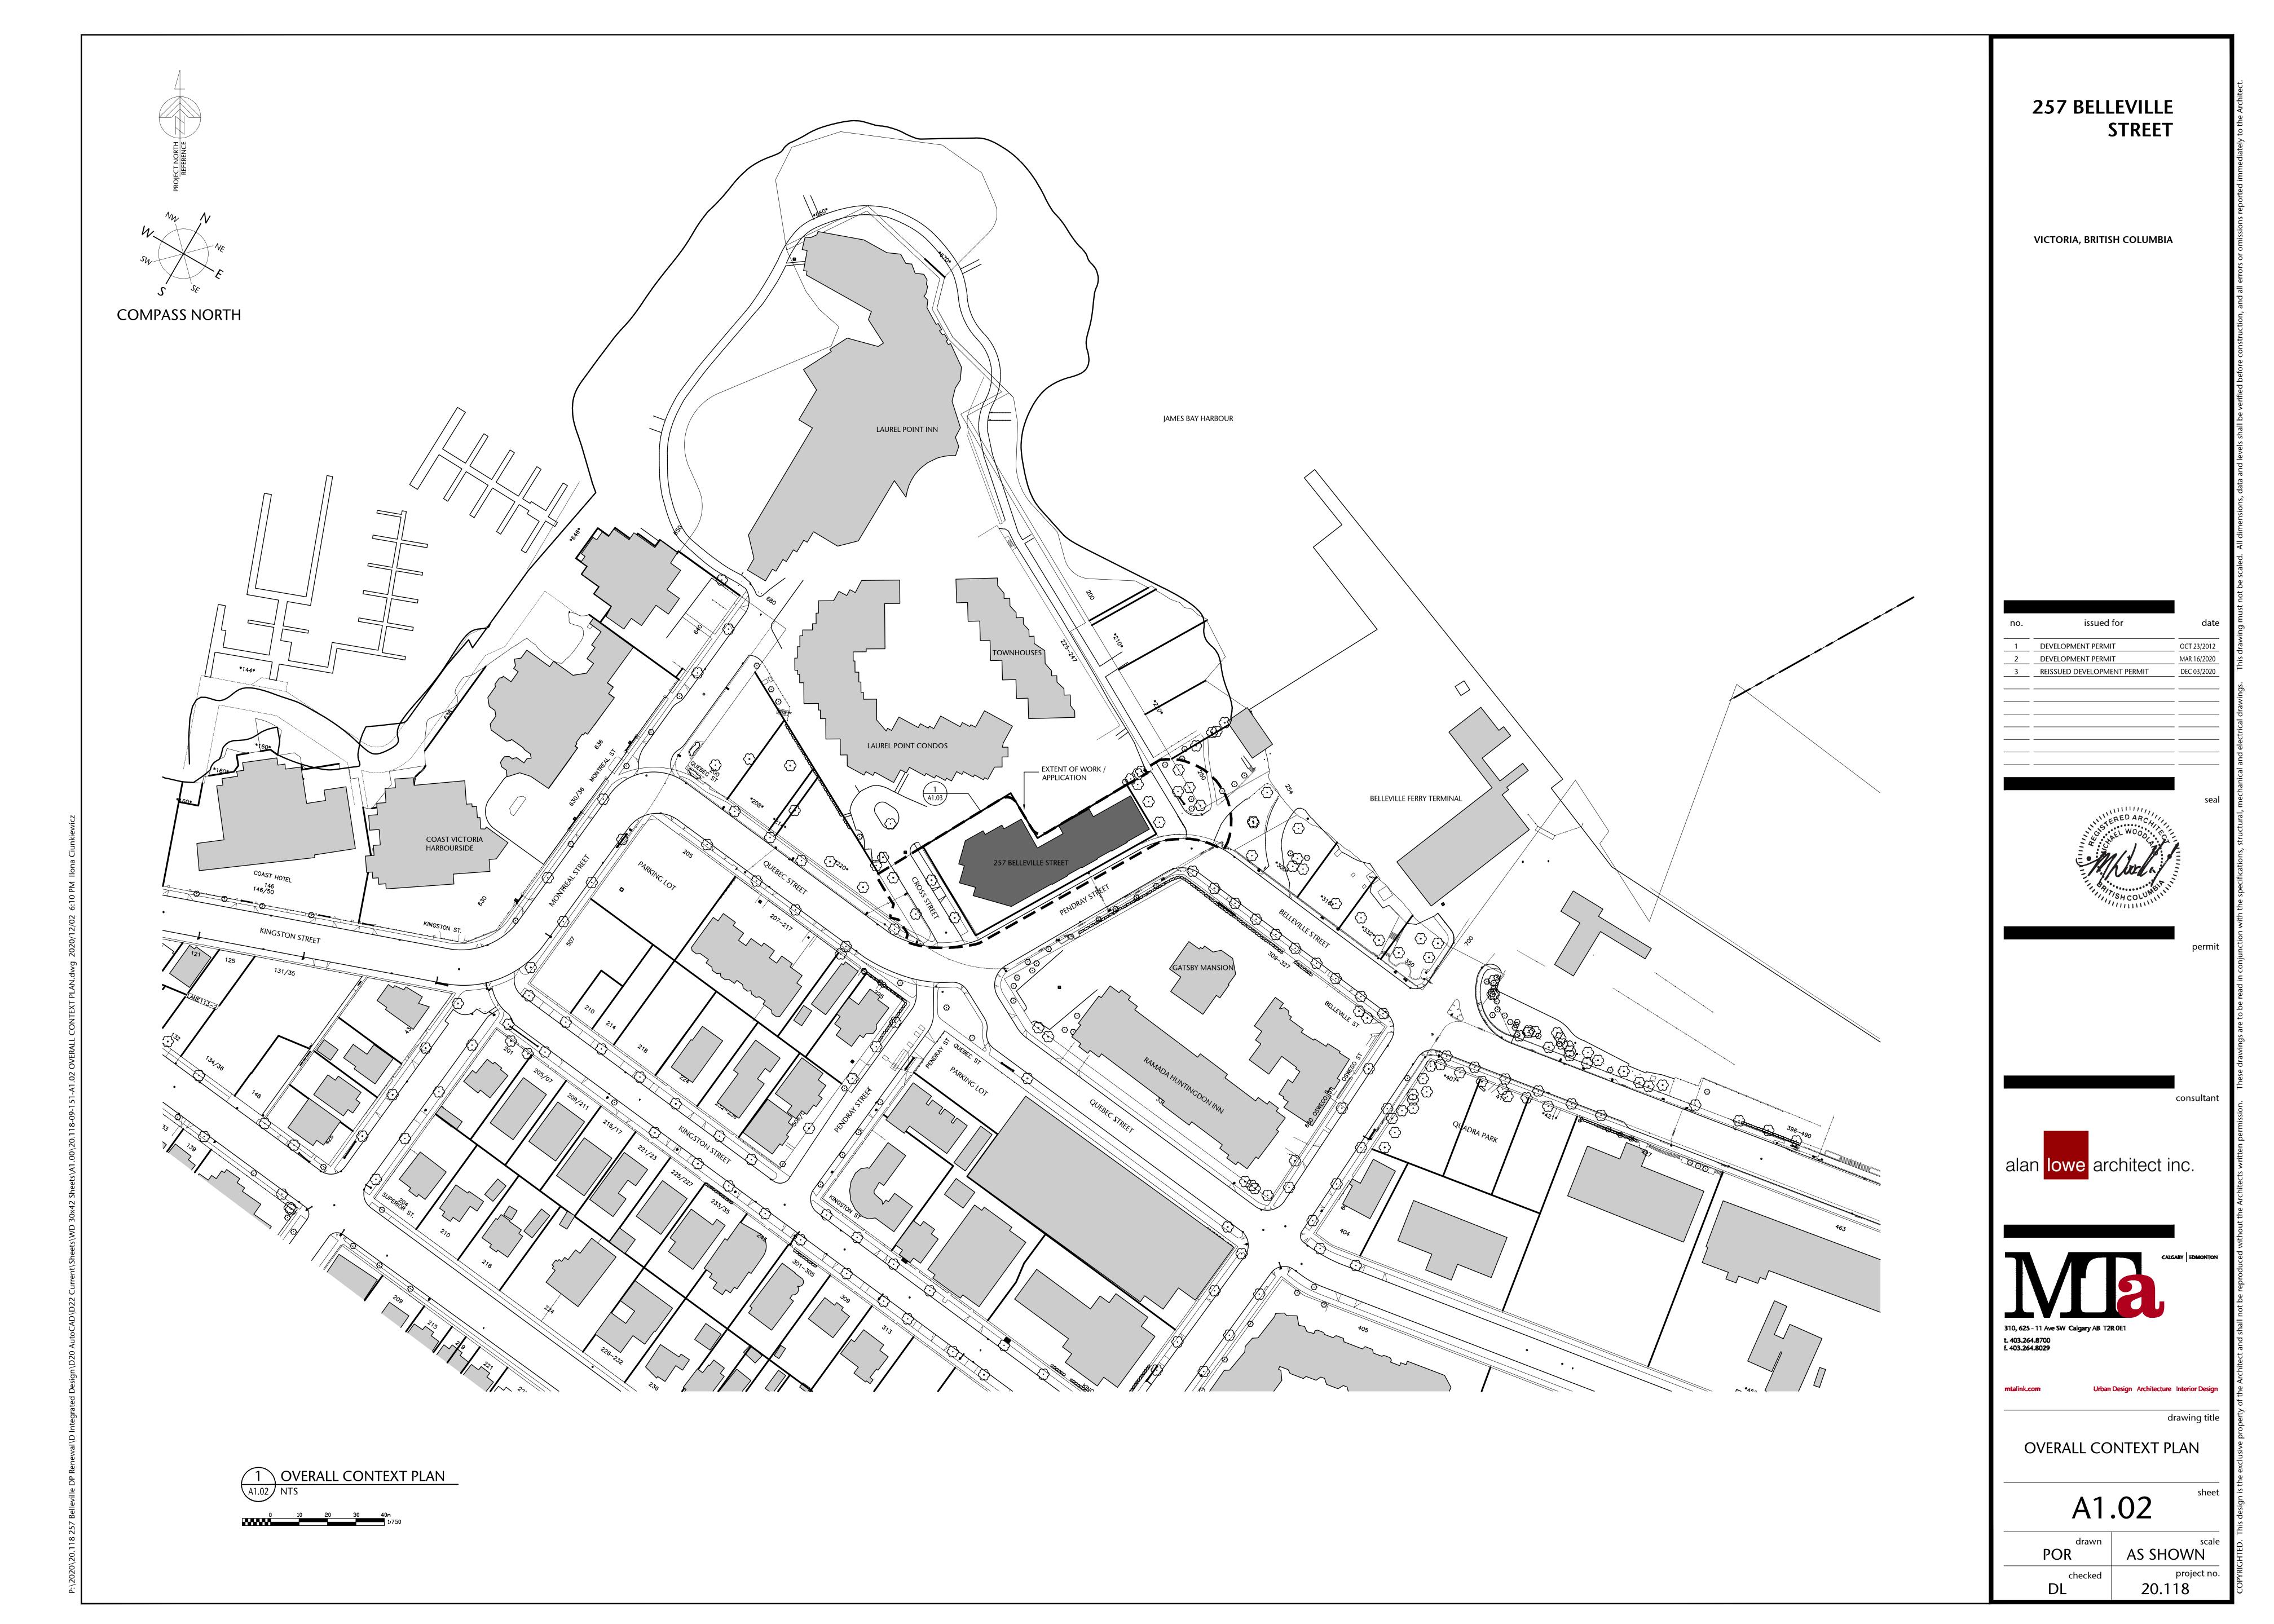
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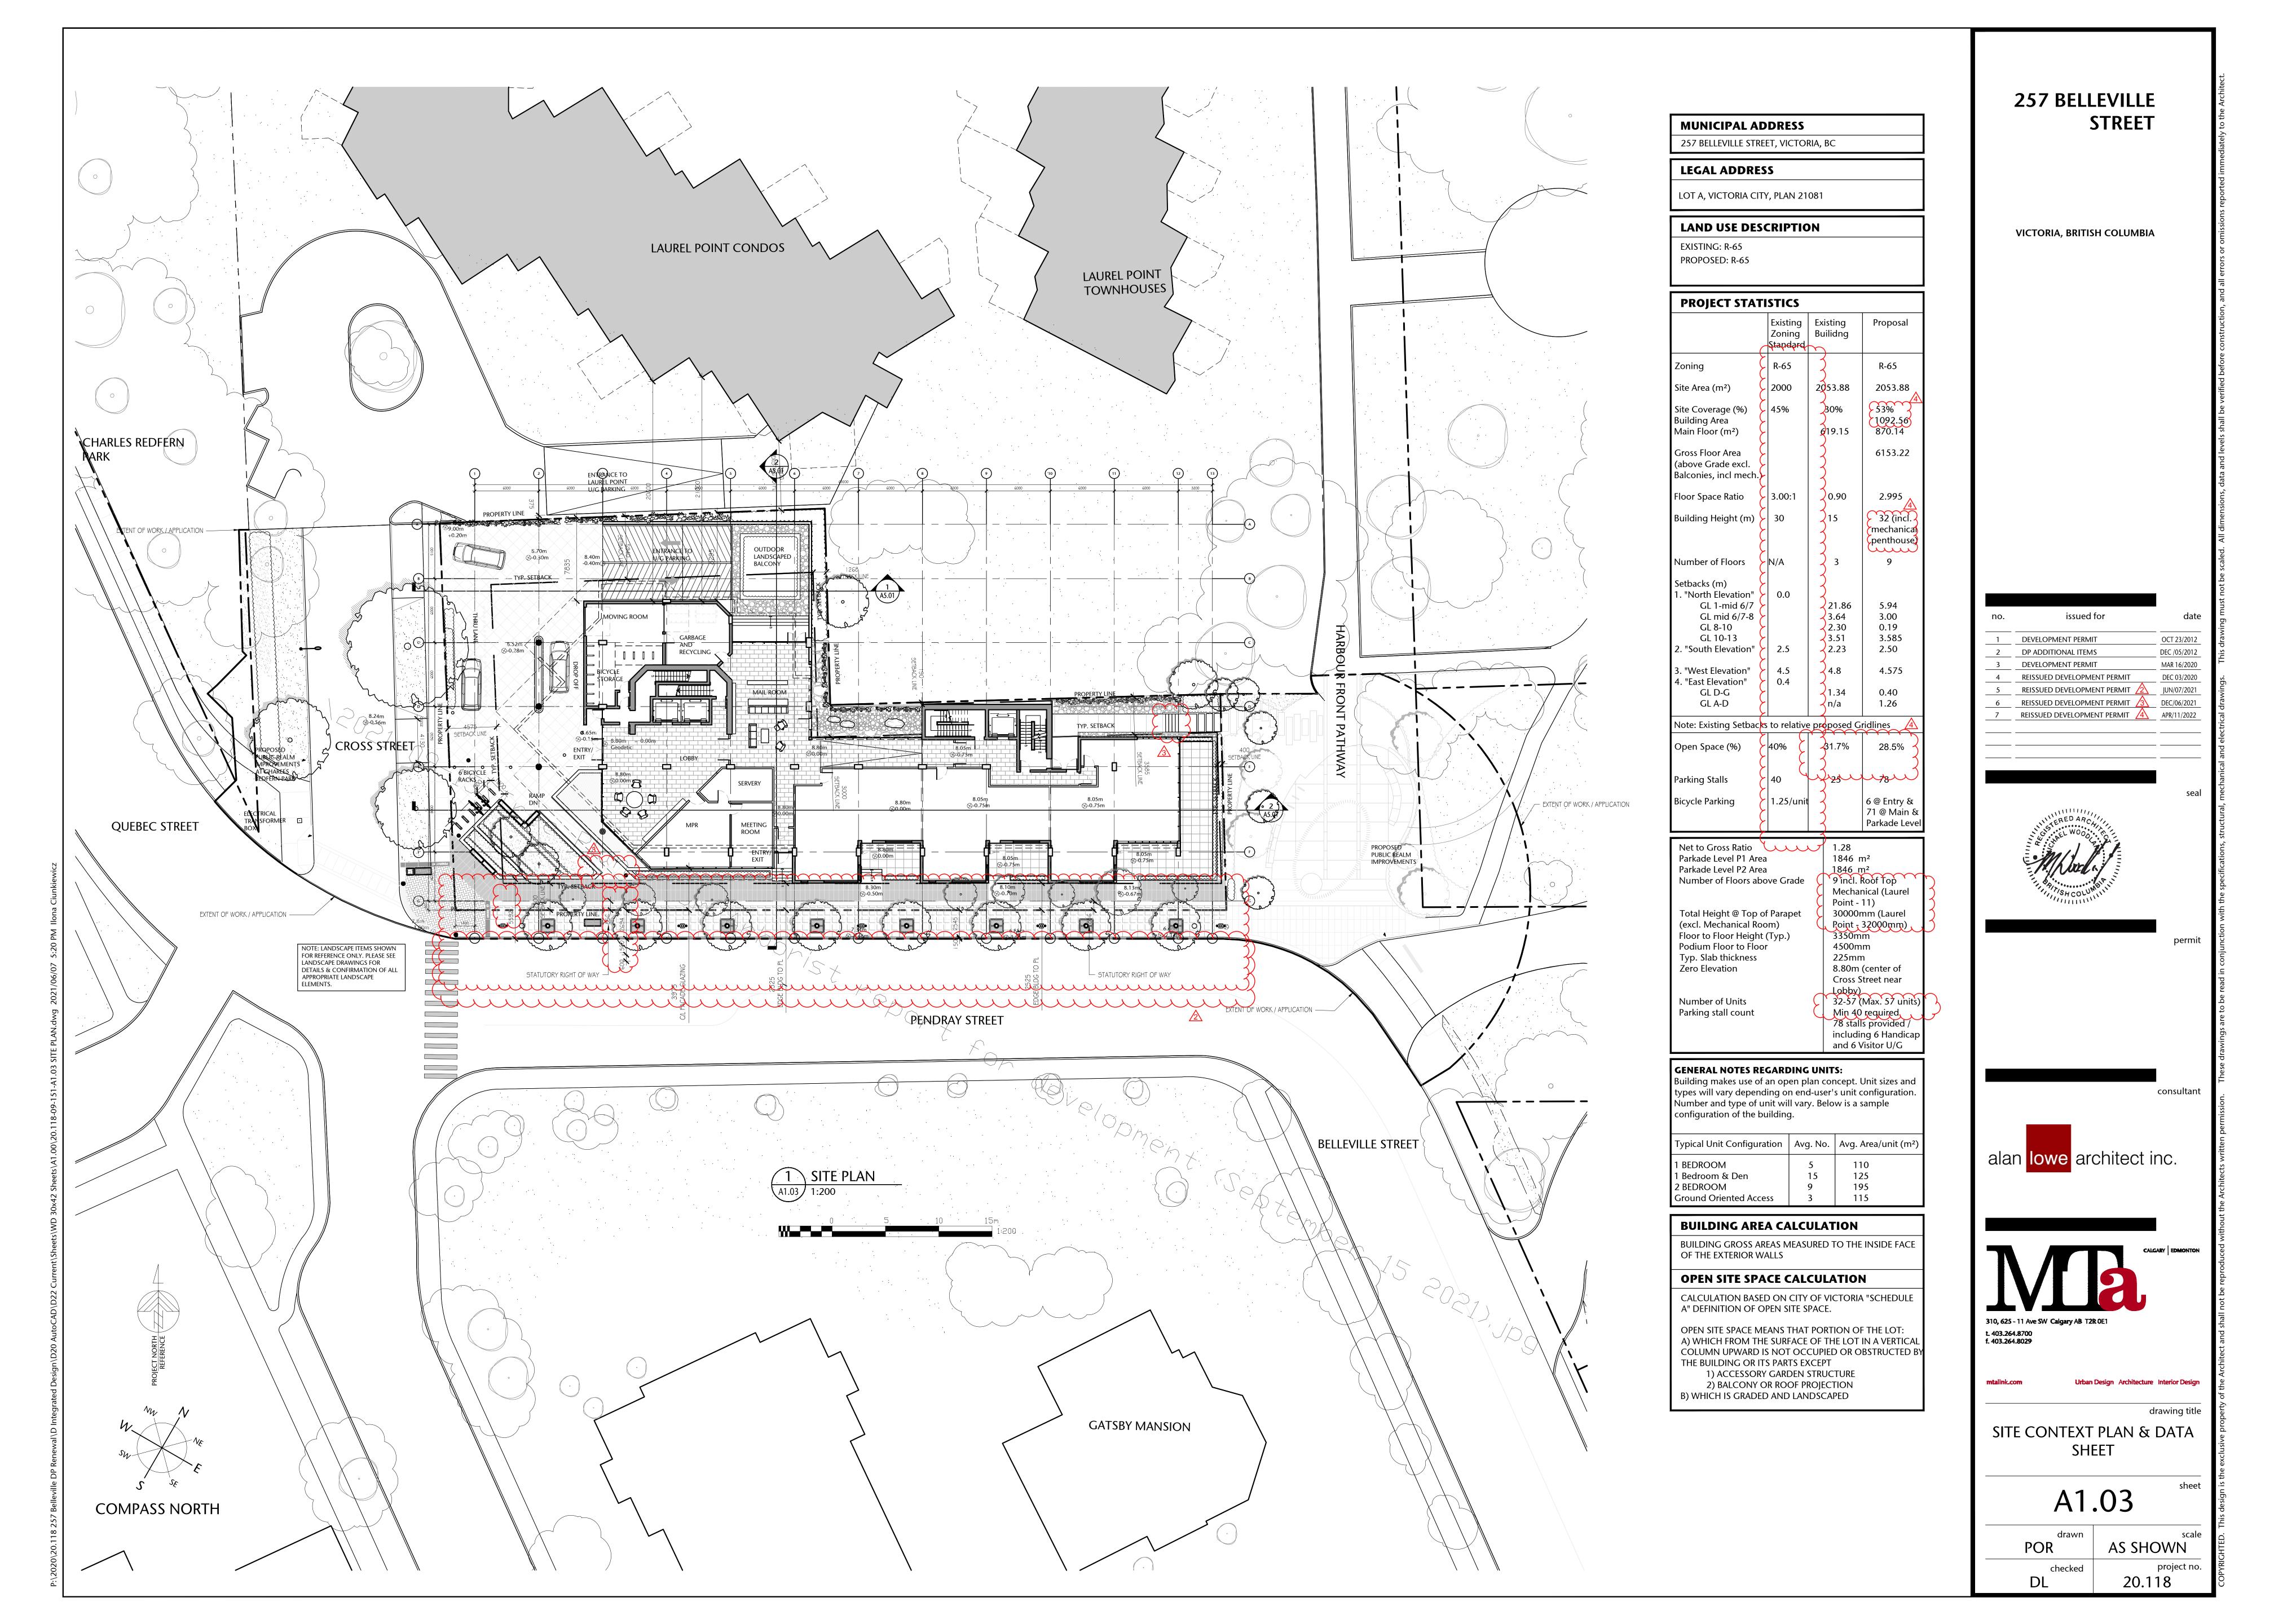
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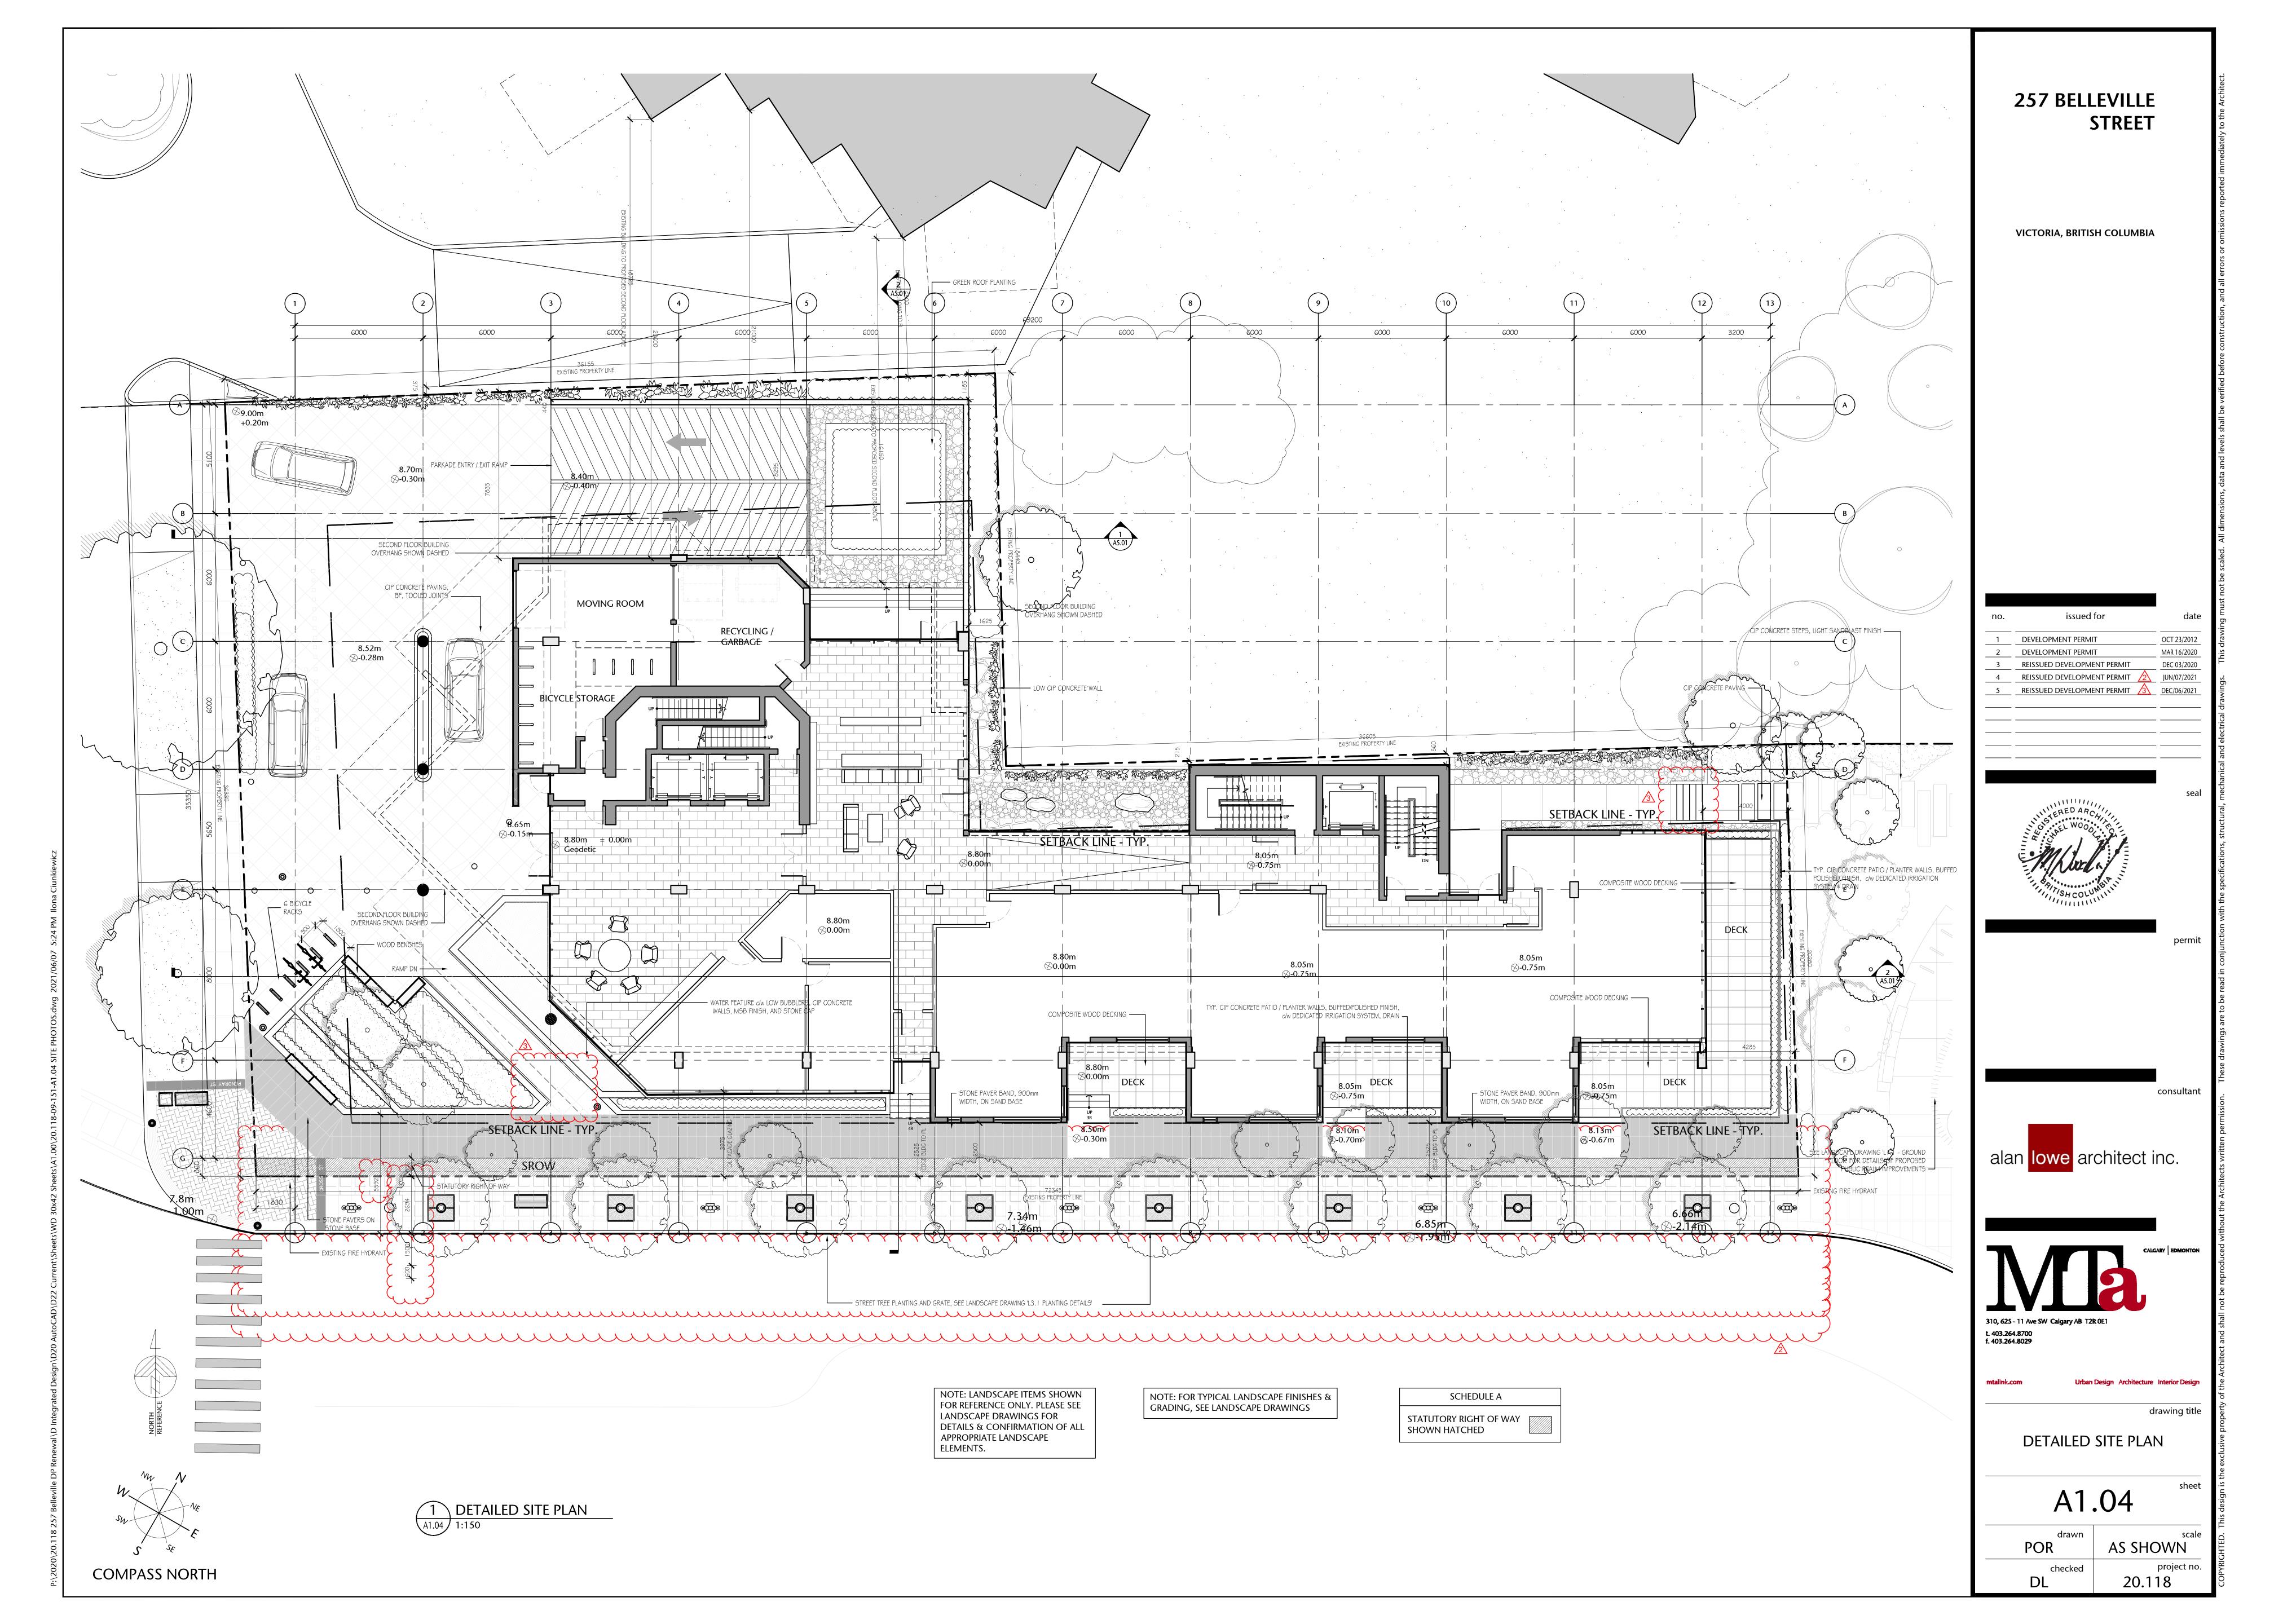
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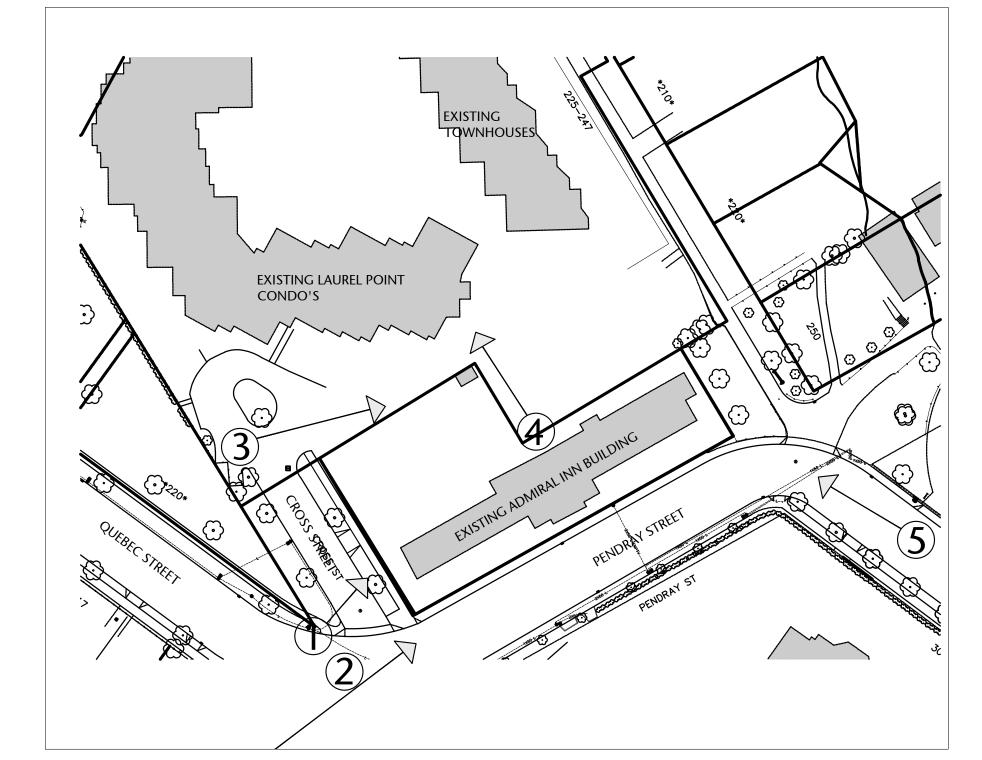


PHOTO LOCATION PLAN

NTS



1 QUEBEC STREET LOOKING EAST DOWN PENDRAY STREET

PENDRAY STREET LOOKING NORTH - EXISTING ADMIRAL'S INN BUILDING



3 VIEW LOOKING SOUTH DOWN CROSS STREET

NTS



4 LOOKING NORTH AT ADJACENT LAUREL POINT CONDO'S



5 VIEW LOOKING NORTH UP BELLEVILLE STREET - EXISTING ADMIRAL'S INN BUILDING

# 257 BELLEVILLE STREET

VICTORIA, BRITISH COLUMBIA





alan lowe architect inc.




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SITE PHOTOS

A1.05

drawn NTS

checked proje

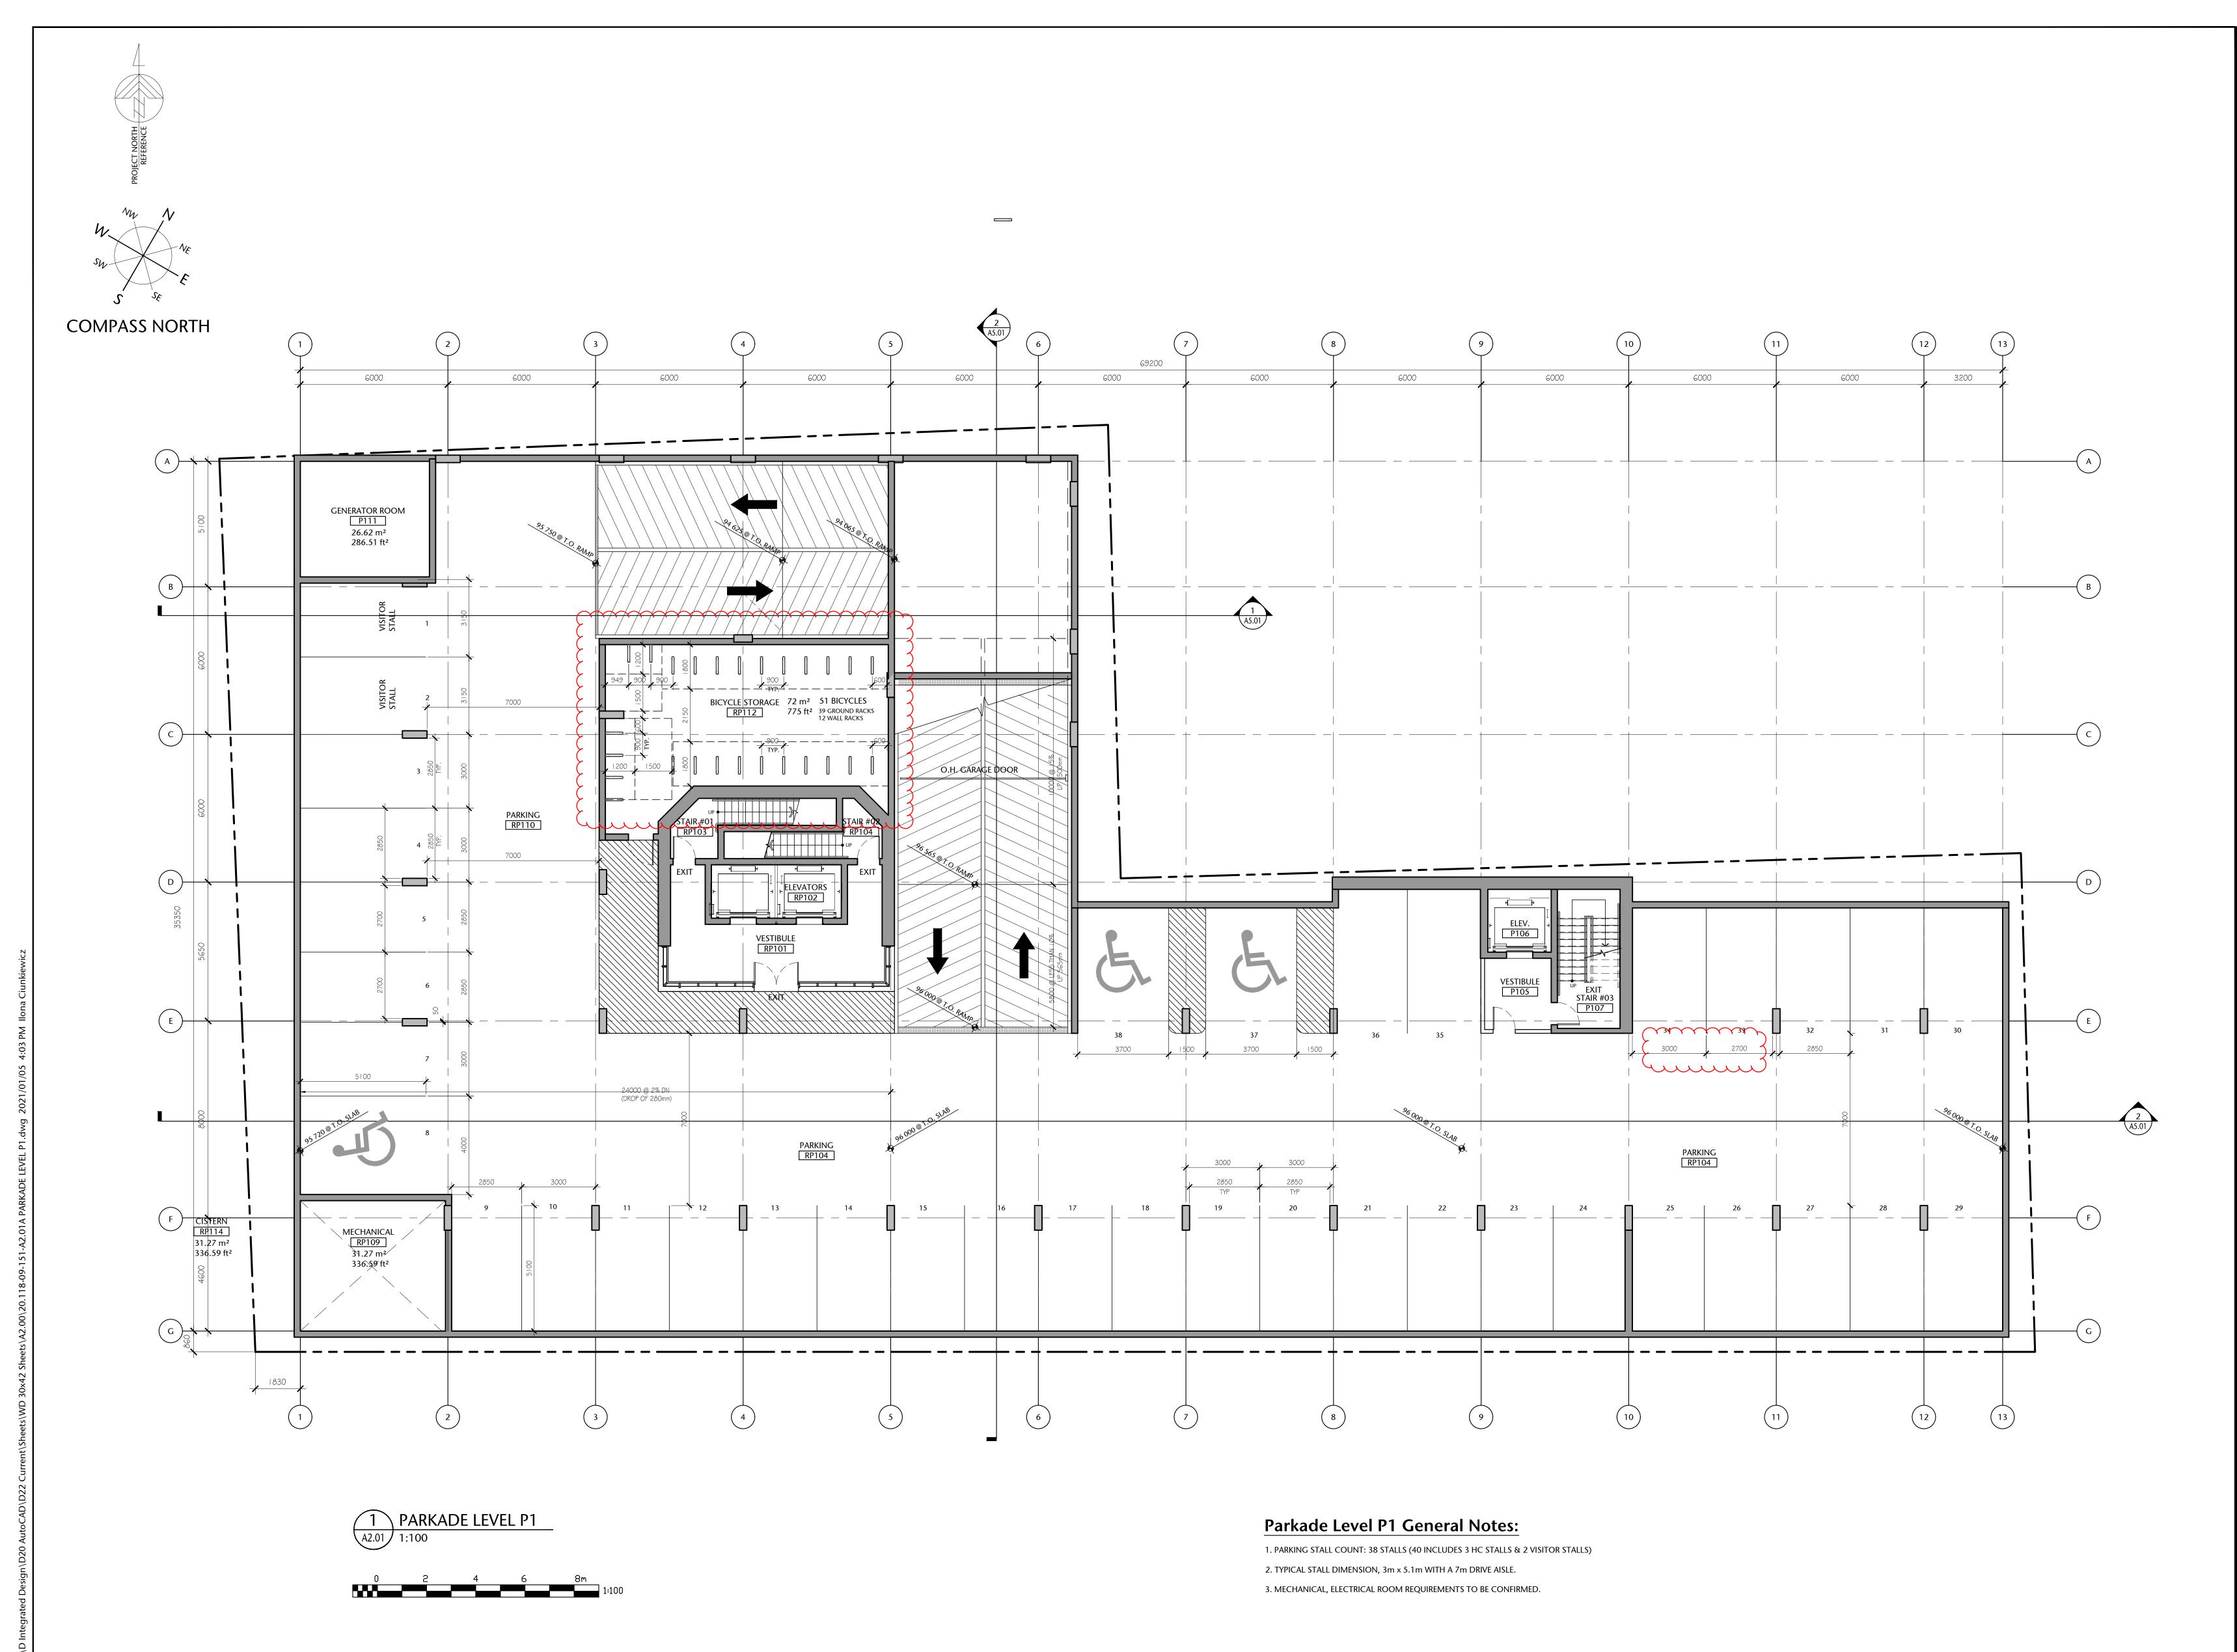

VICTORIA, BRITISH COLUMBIA

issued for	date
DEVELOPMENT PERMIT	OCT 23/2012
DP ADDITIONAL ITEMS	DEC 05/2012
DP ADDITIONAL ITEMS	DEC 12/2012
DEVELOPMENT PERMIT	MAR 16/2020
REISSUED DEVELOPMENT PERMIT	DEC 03/2020
	DEVELOPMENT PERMIT  DP ADDITIONAL ITEMS  DP ADDITIONAL ITEMS  DEVELOPMENT PERMIT



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Urban Design Architect


drawing title

PARKADE LEVEL P1

A2.01A

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checked project no.
20.118



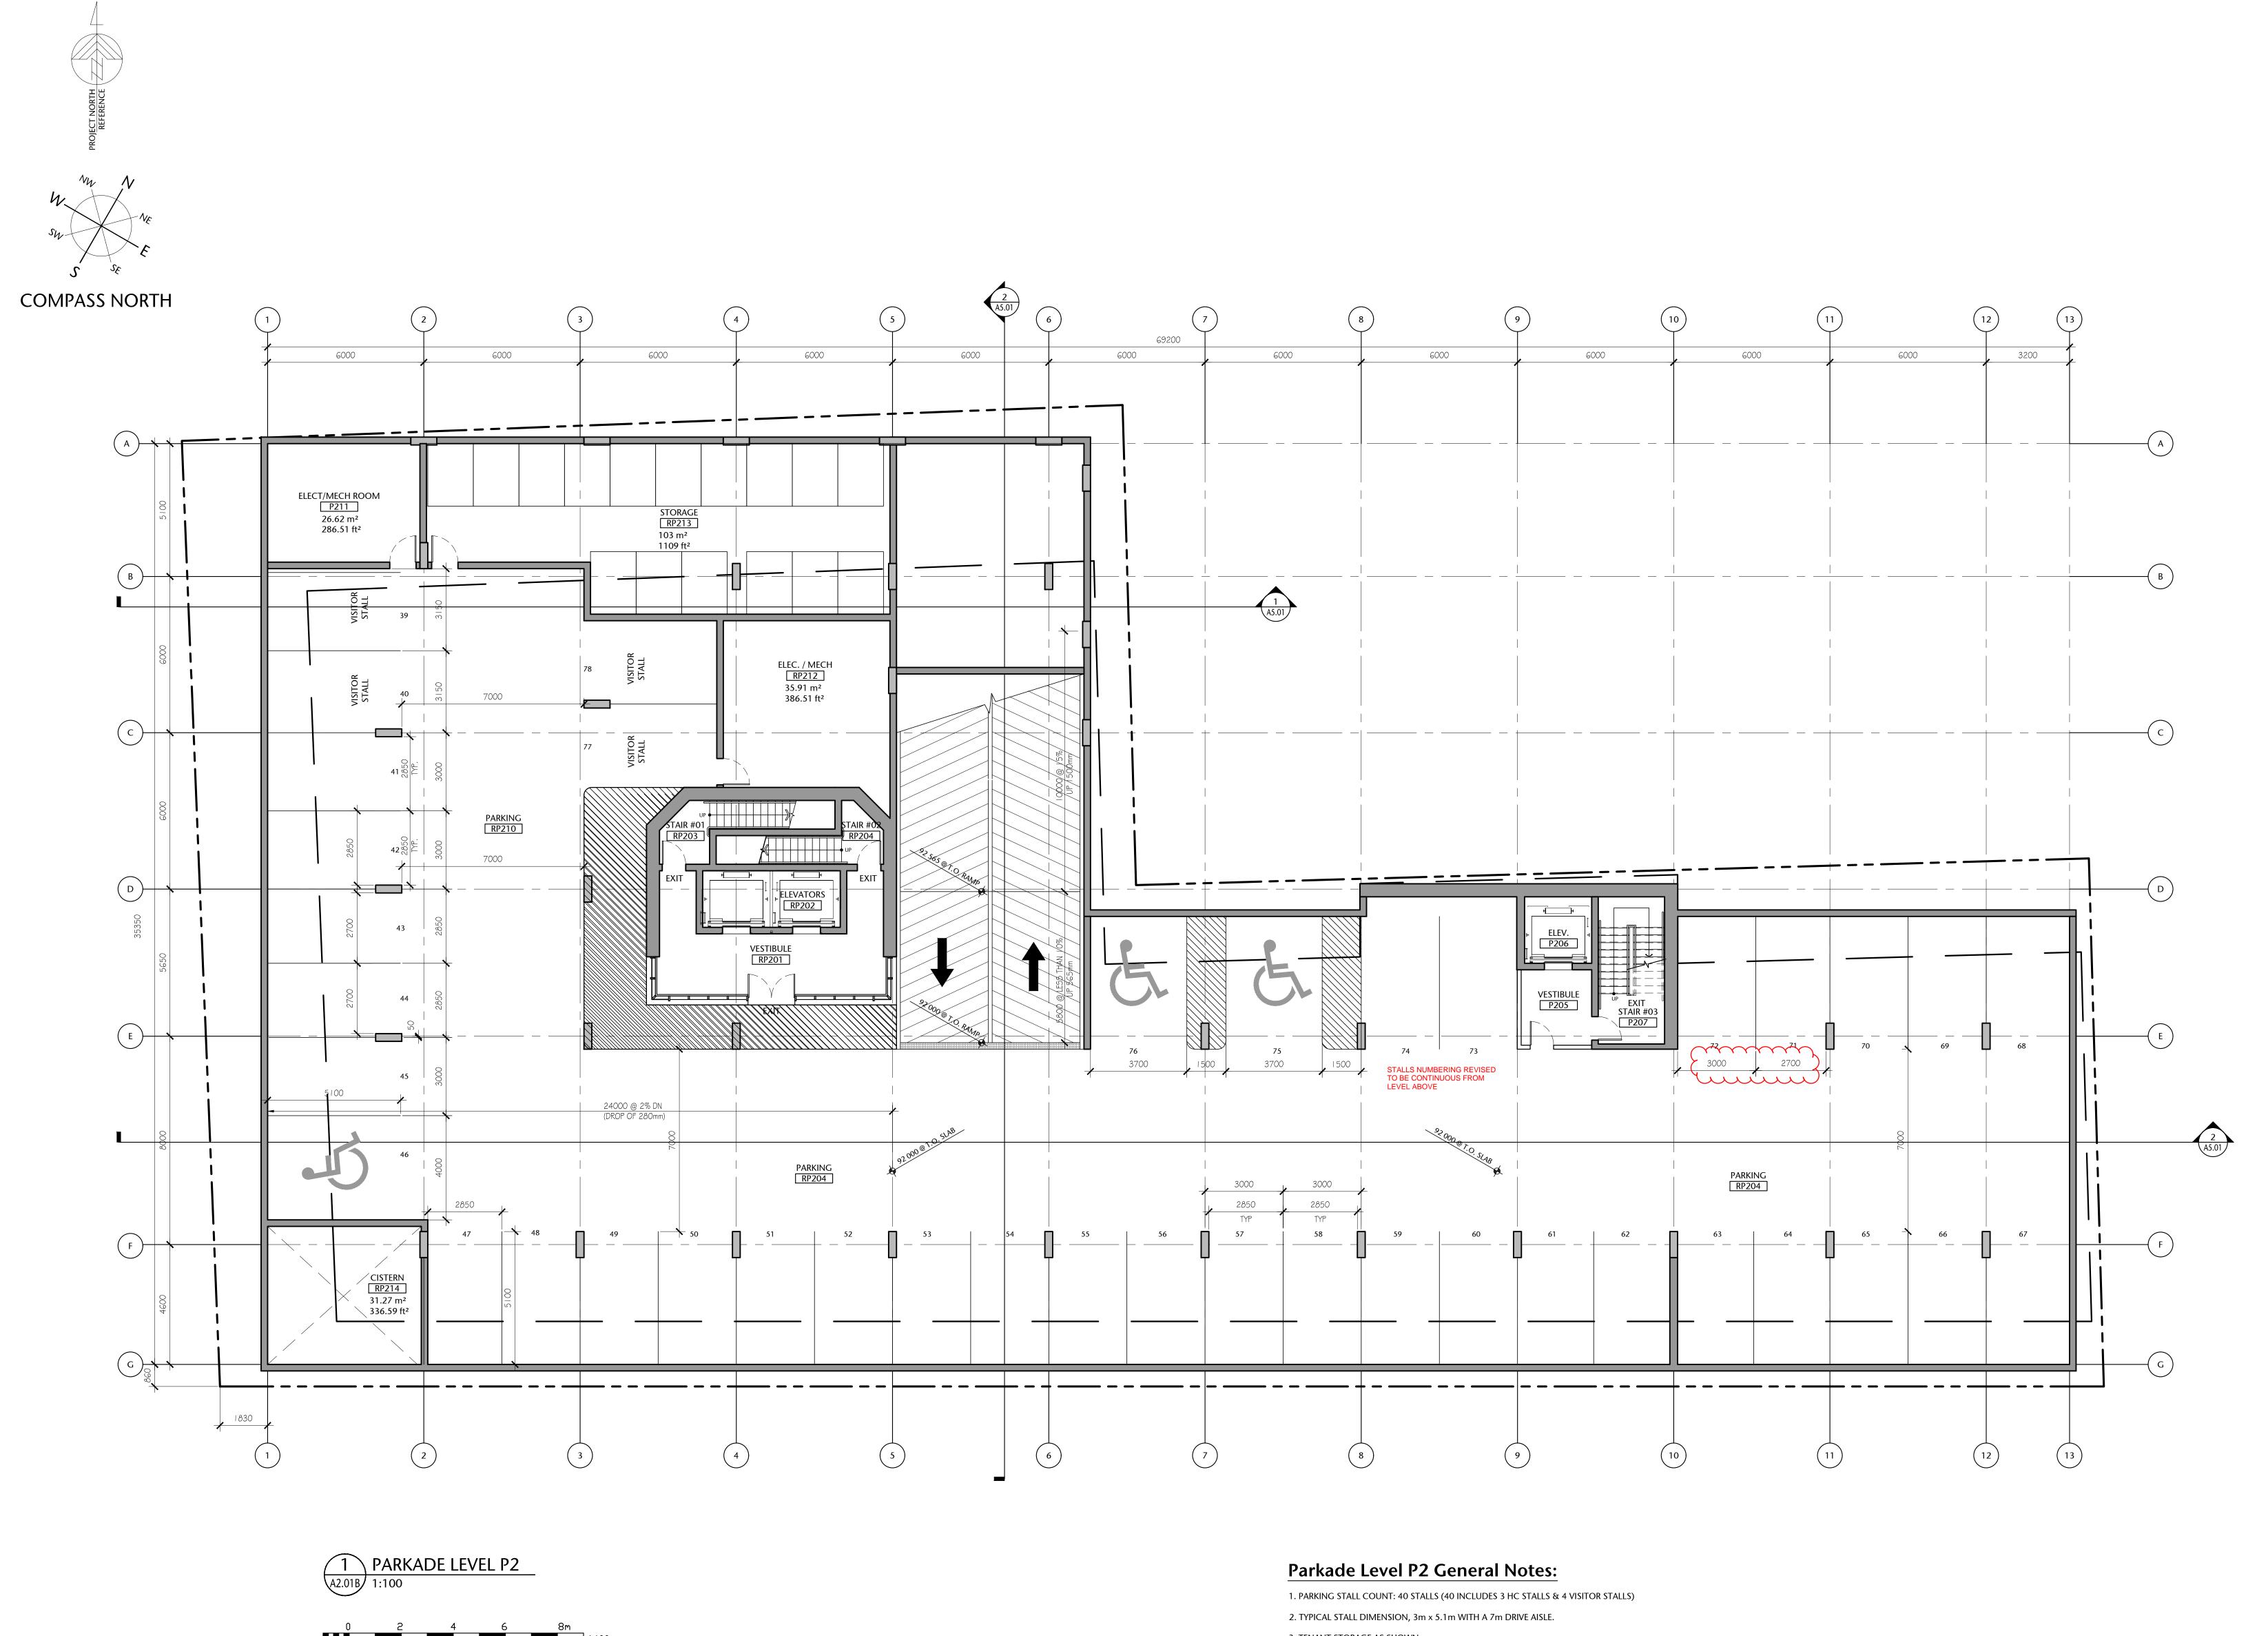

3. TENANT STORAGE AS SHOWN. MECHANICAL, ELECTRICAL ROOM REQUIREMENTS TO BE CONFIRMED.

**257 BELLEVILLE STREET** 

VICTORIA, BRITISH COLUMBIA

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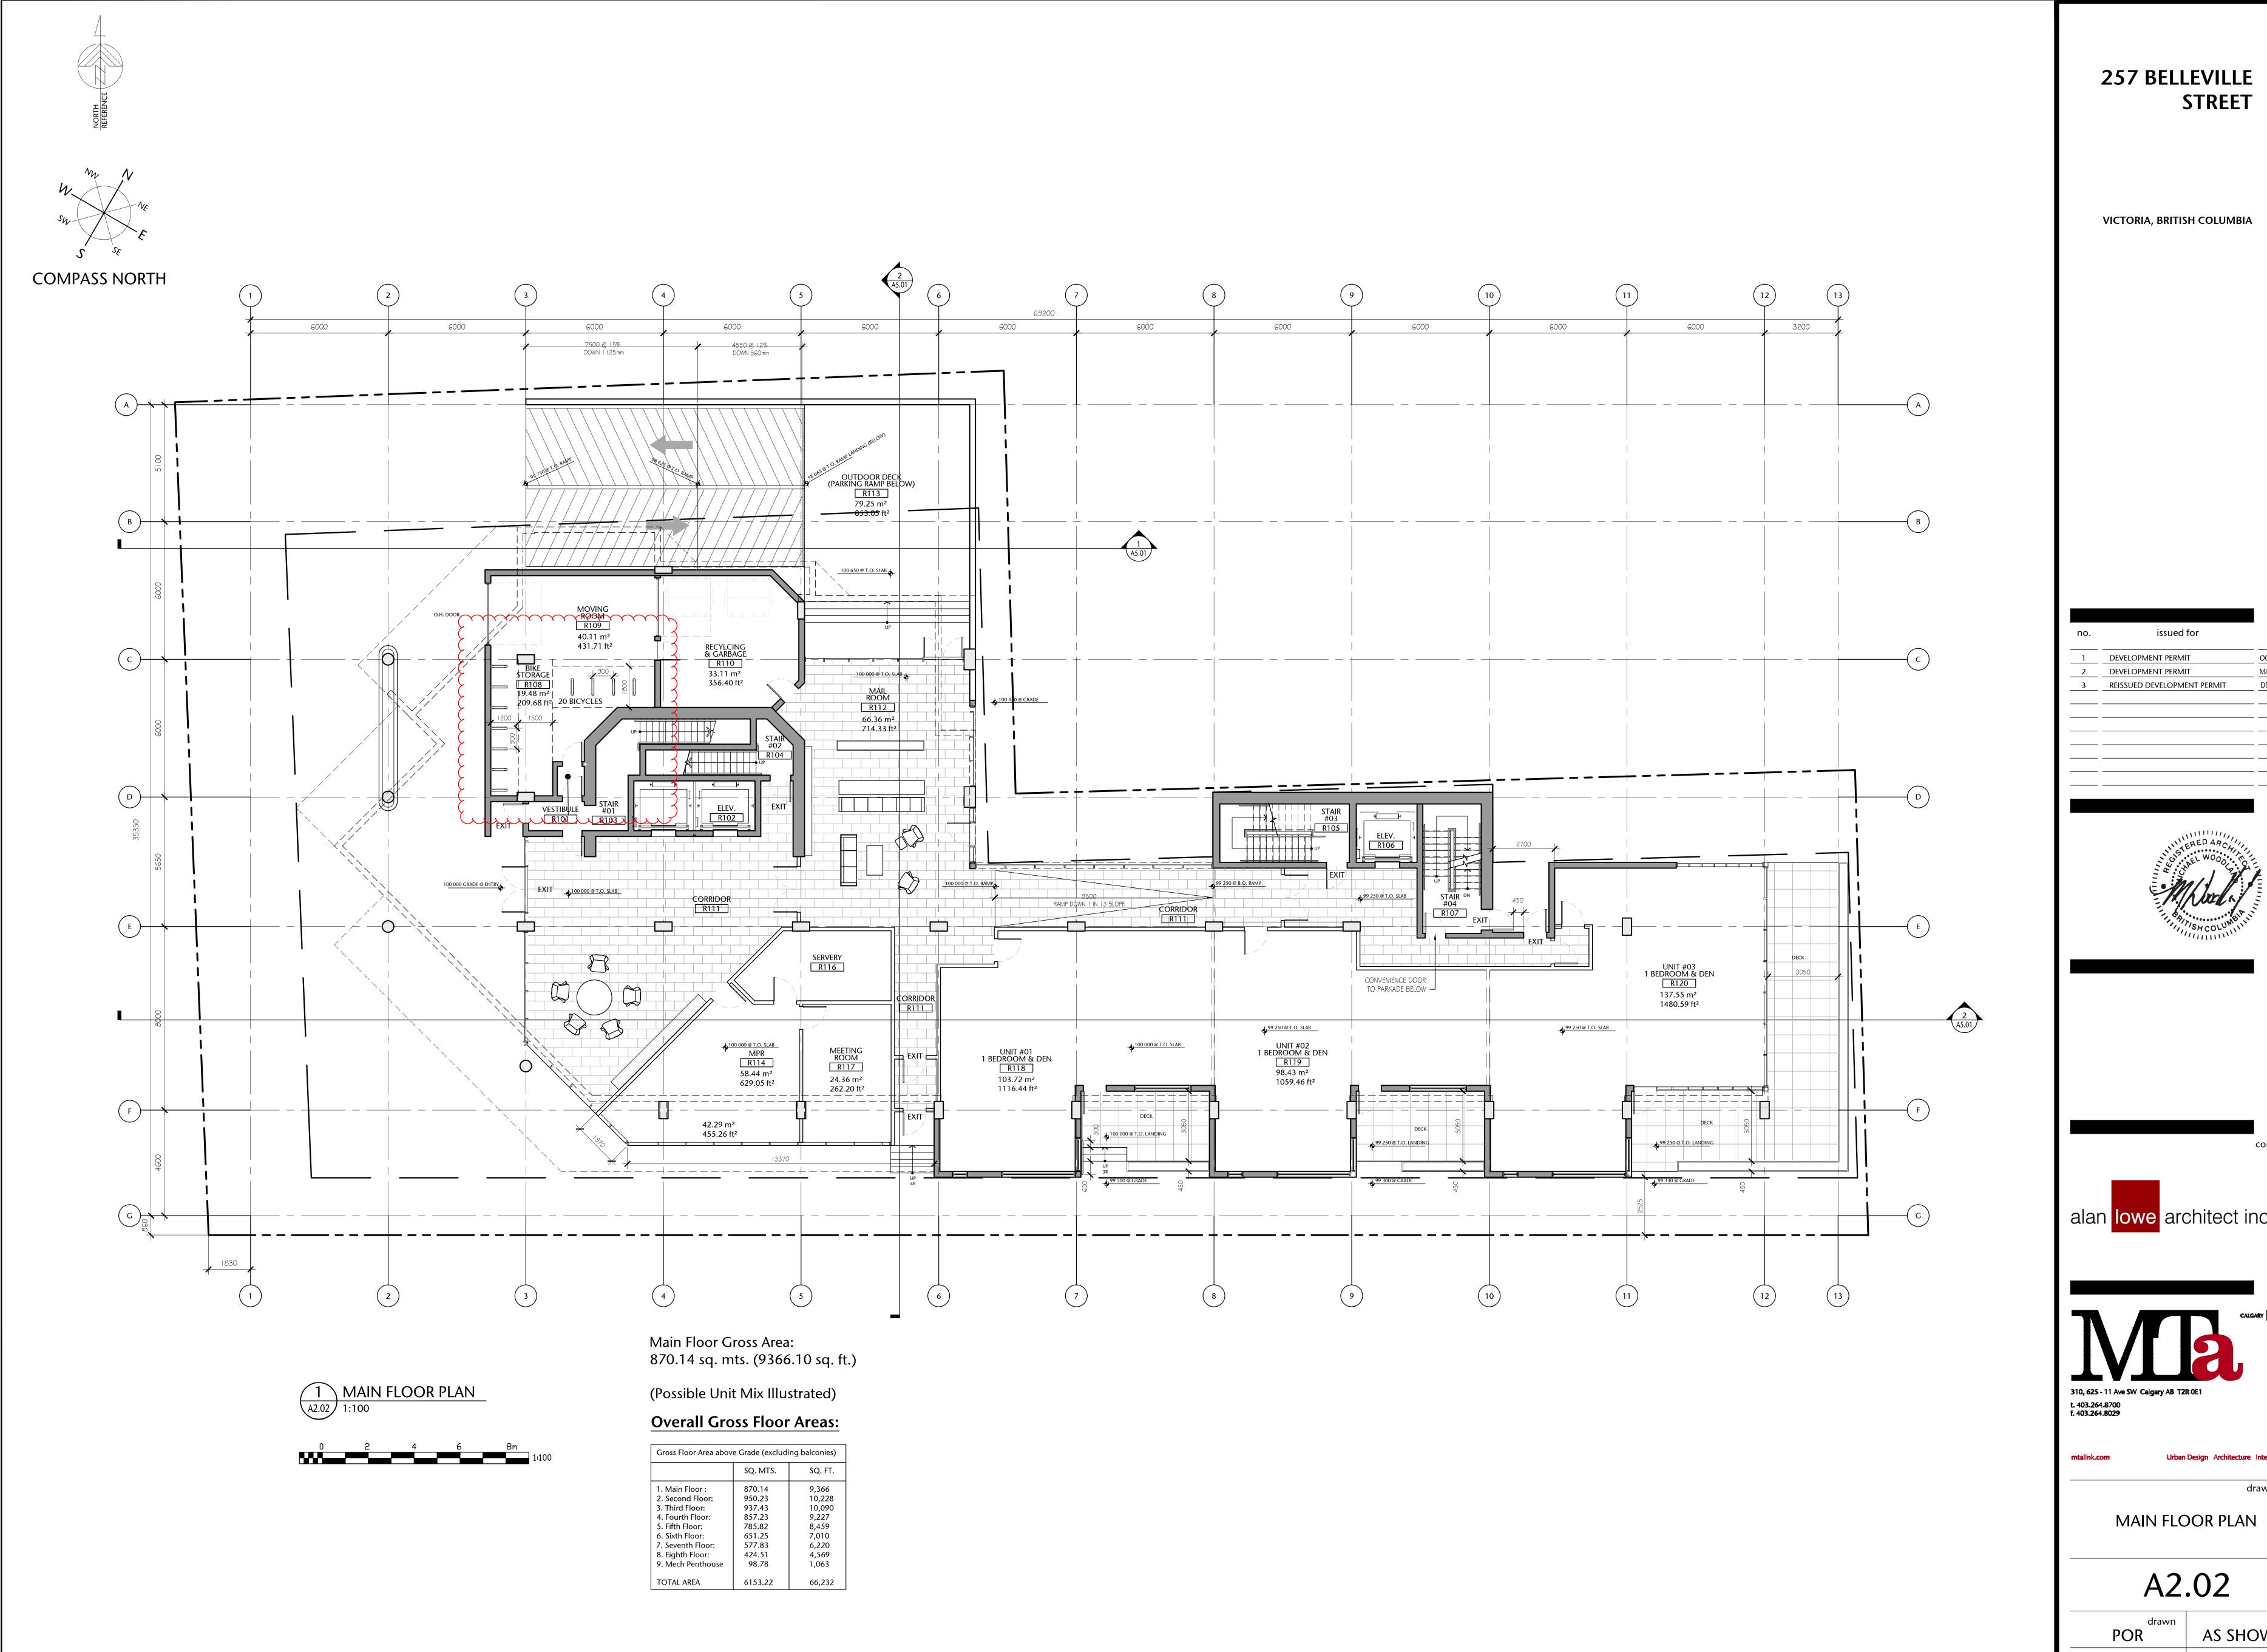
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PARKADE LEVEL P2

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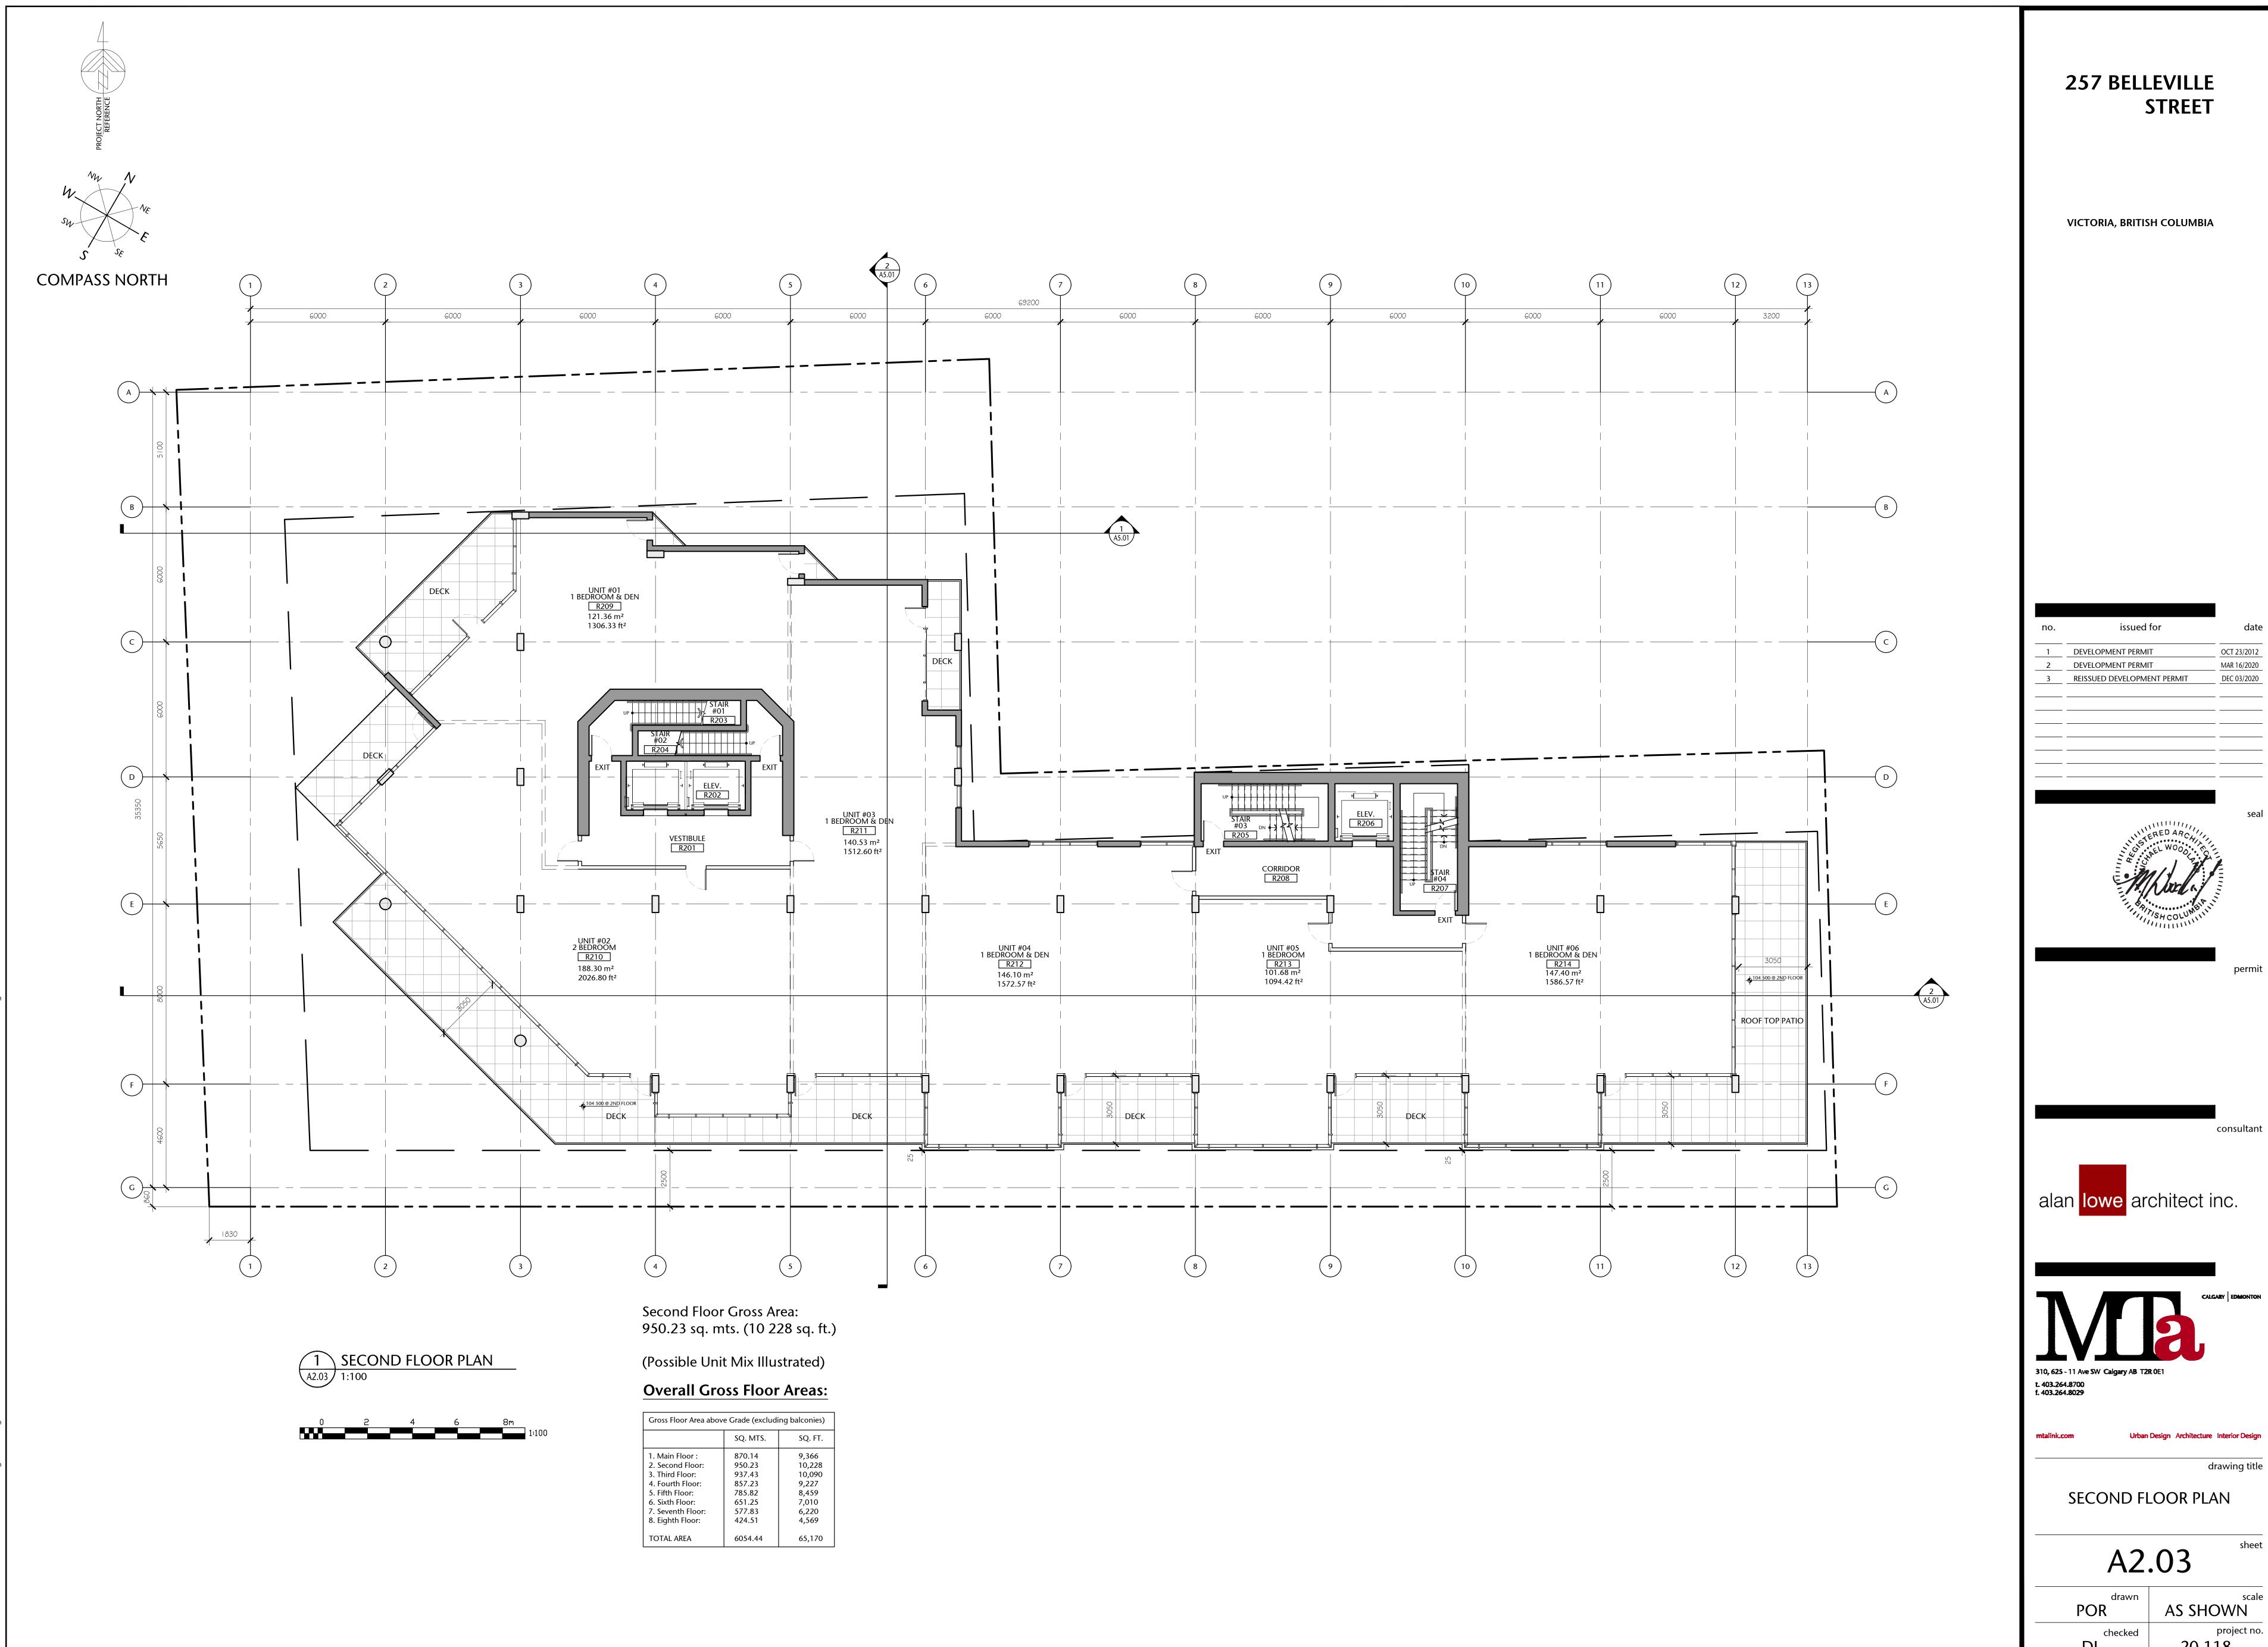





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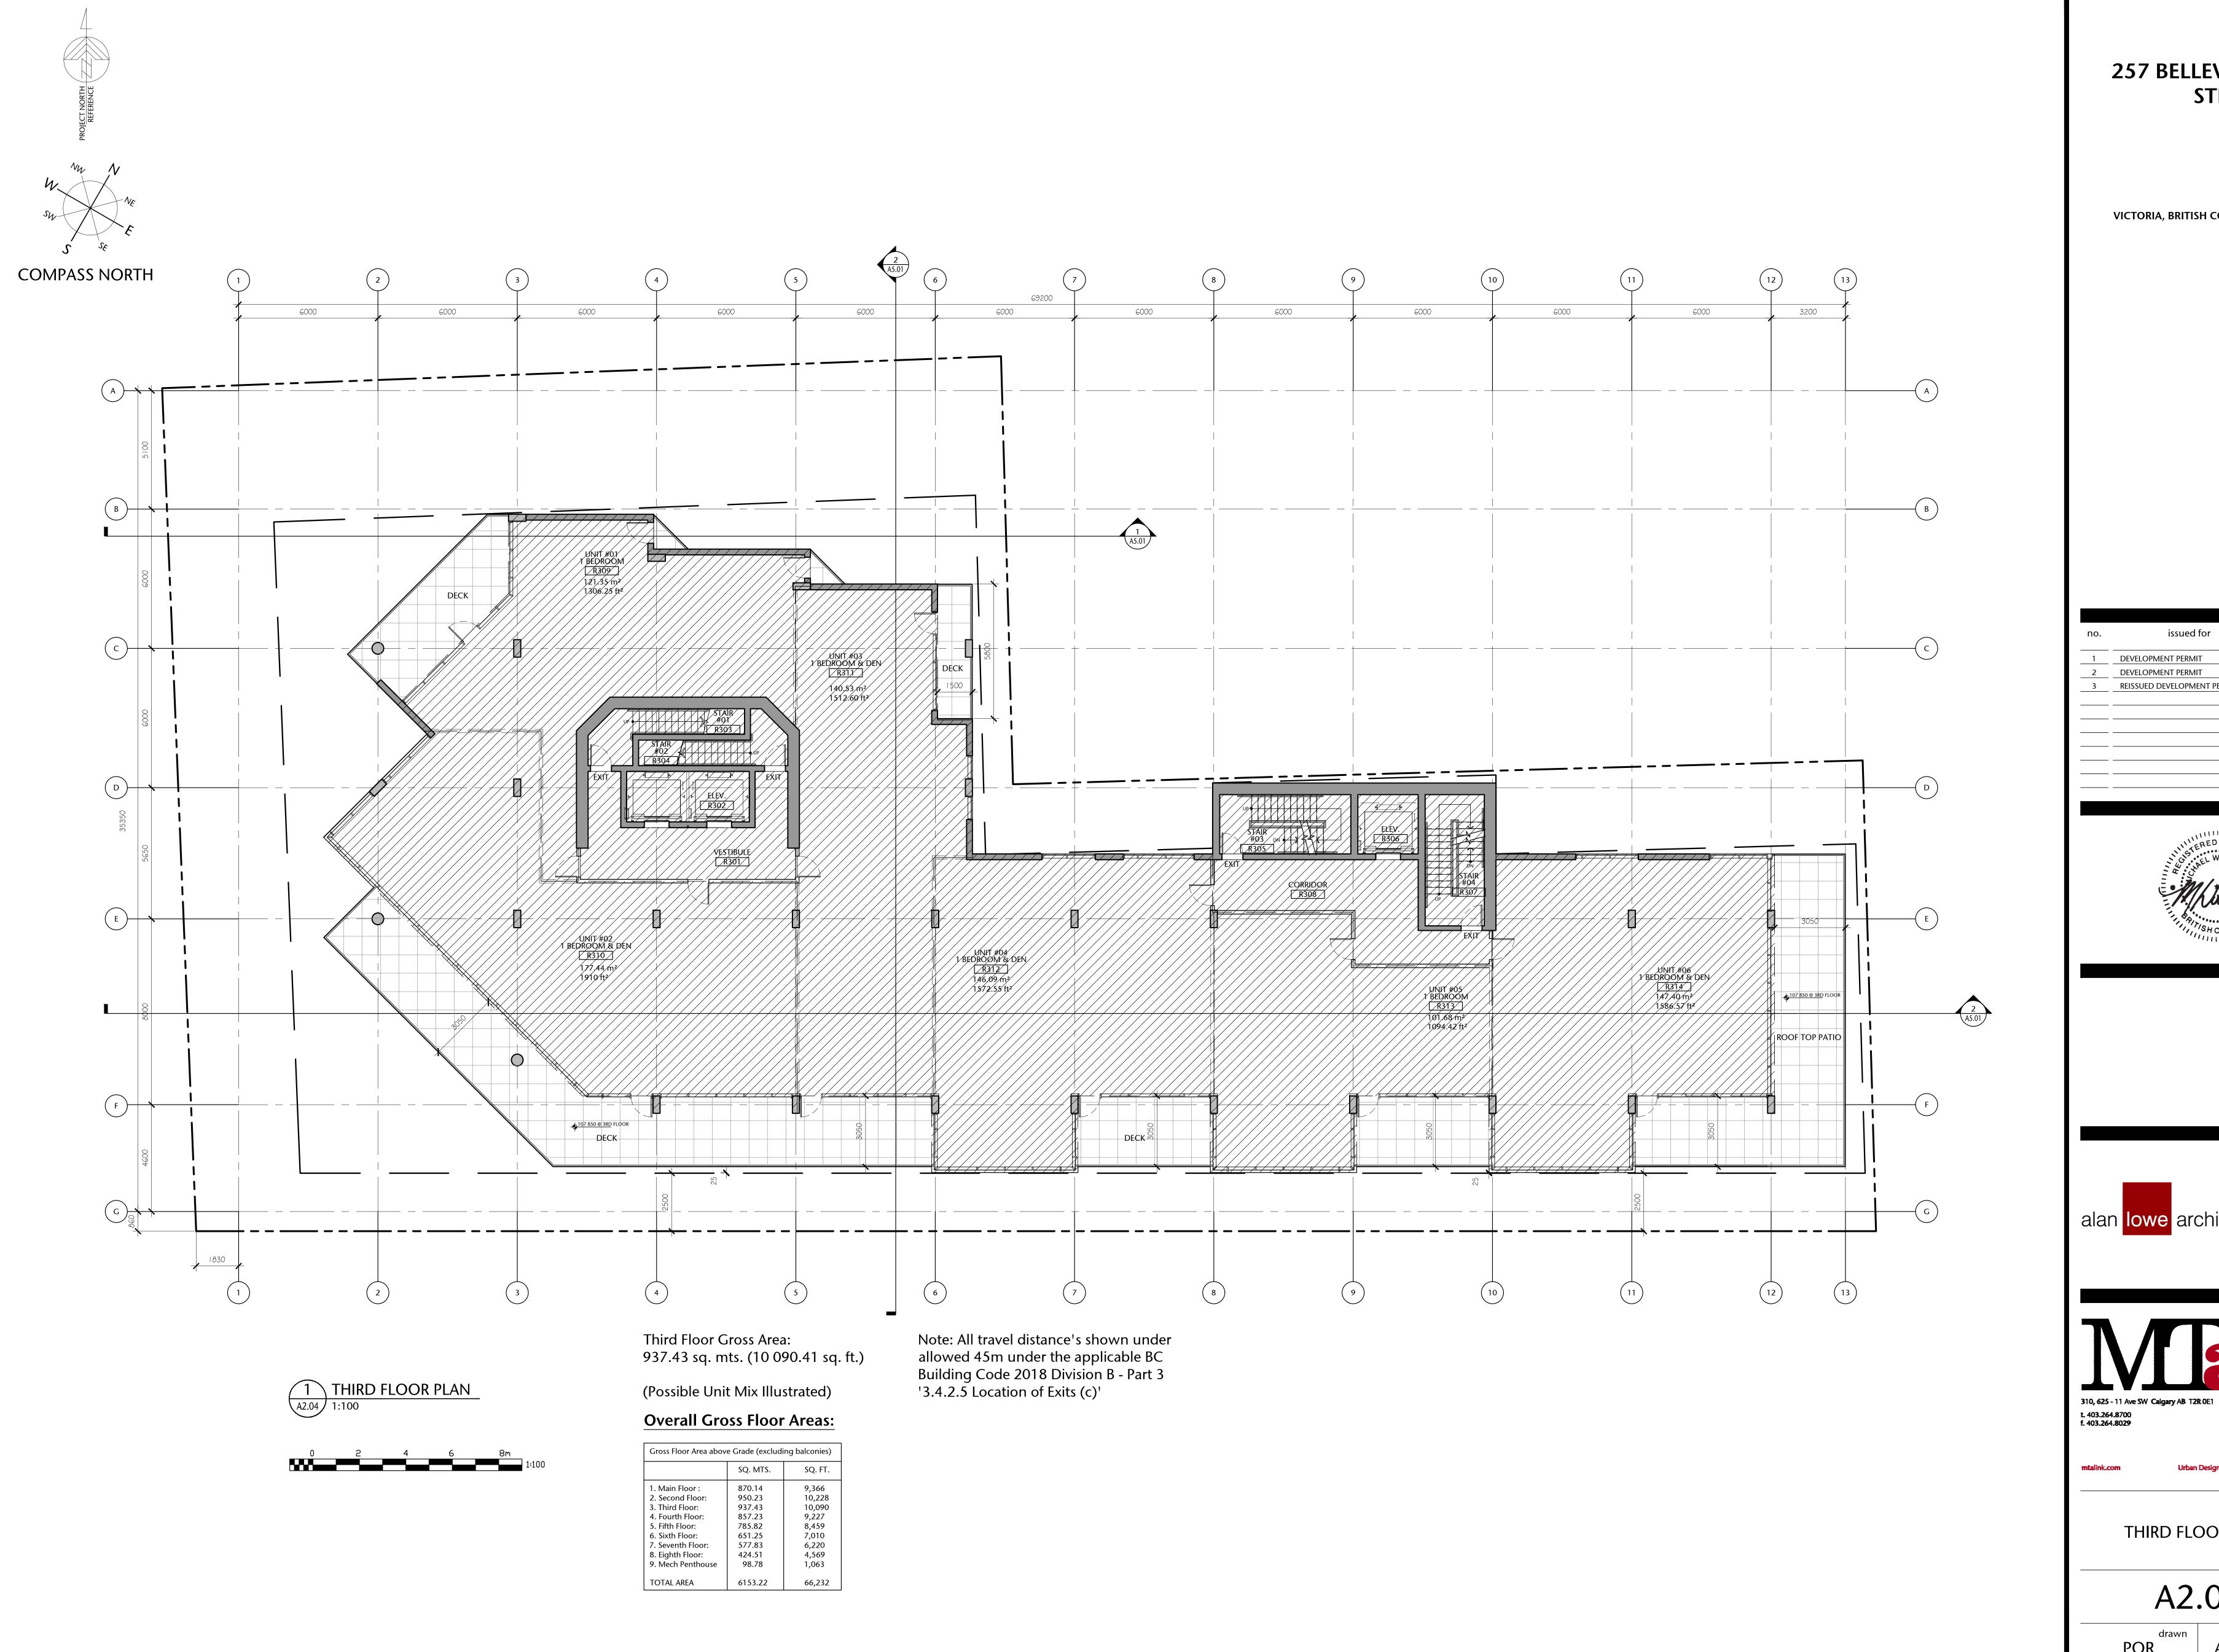
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**AS SHOWN** project no.



OCT 23/2012



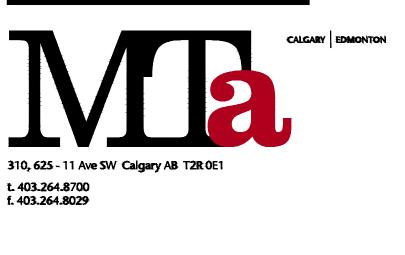

VICTORIA, BRITISH COLUMBIA

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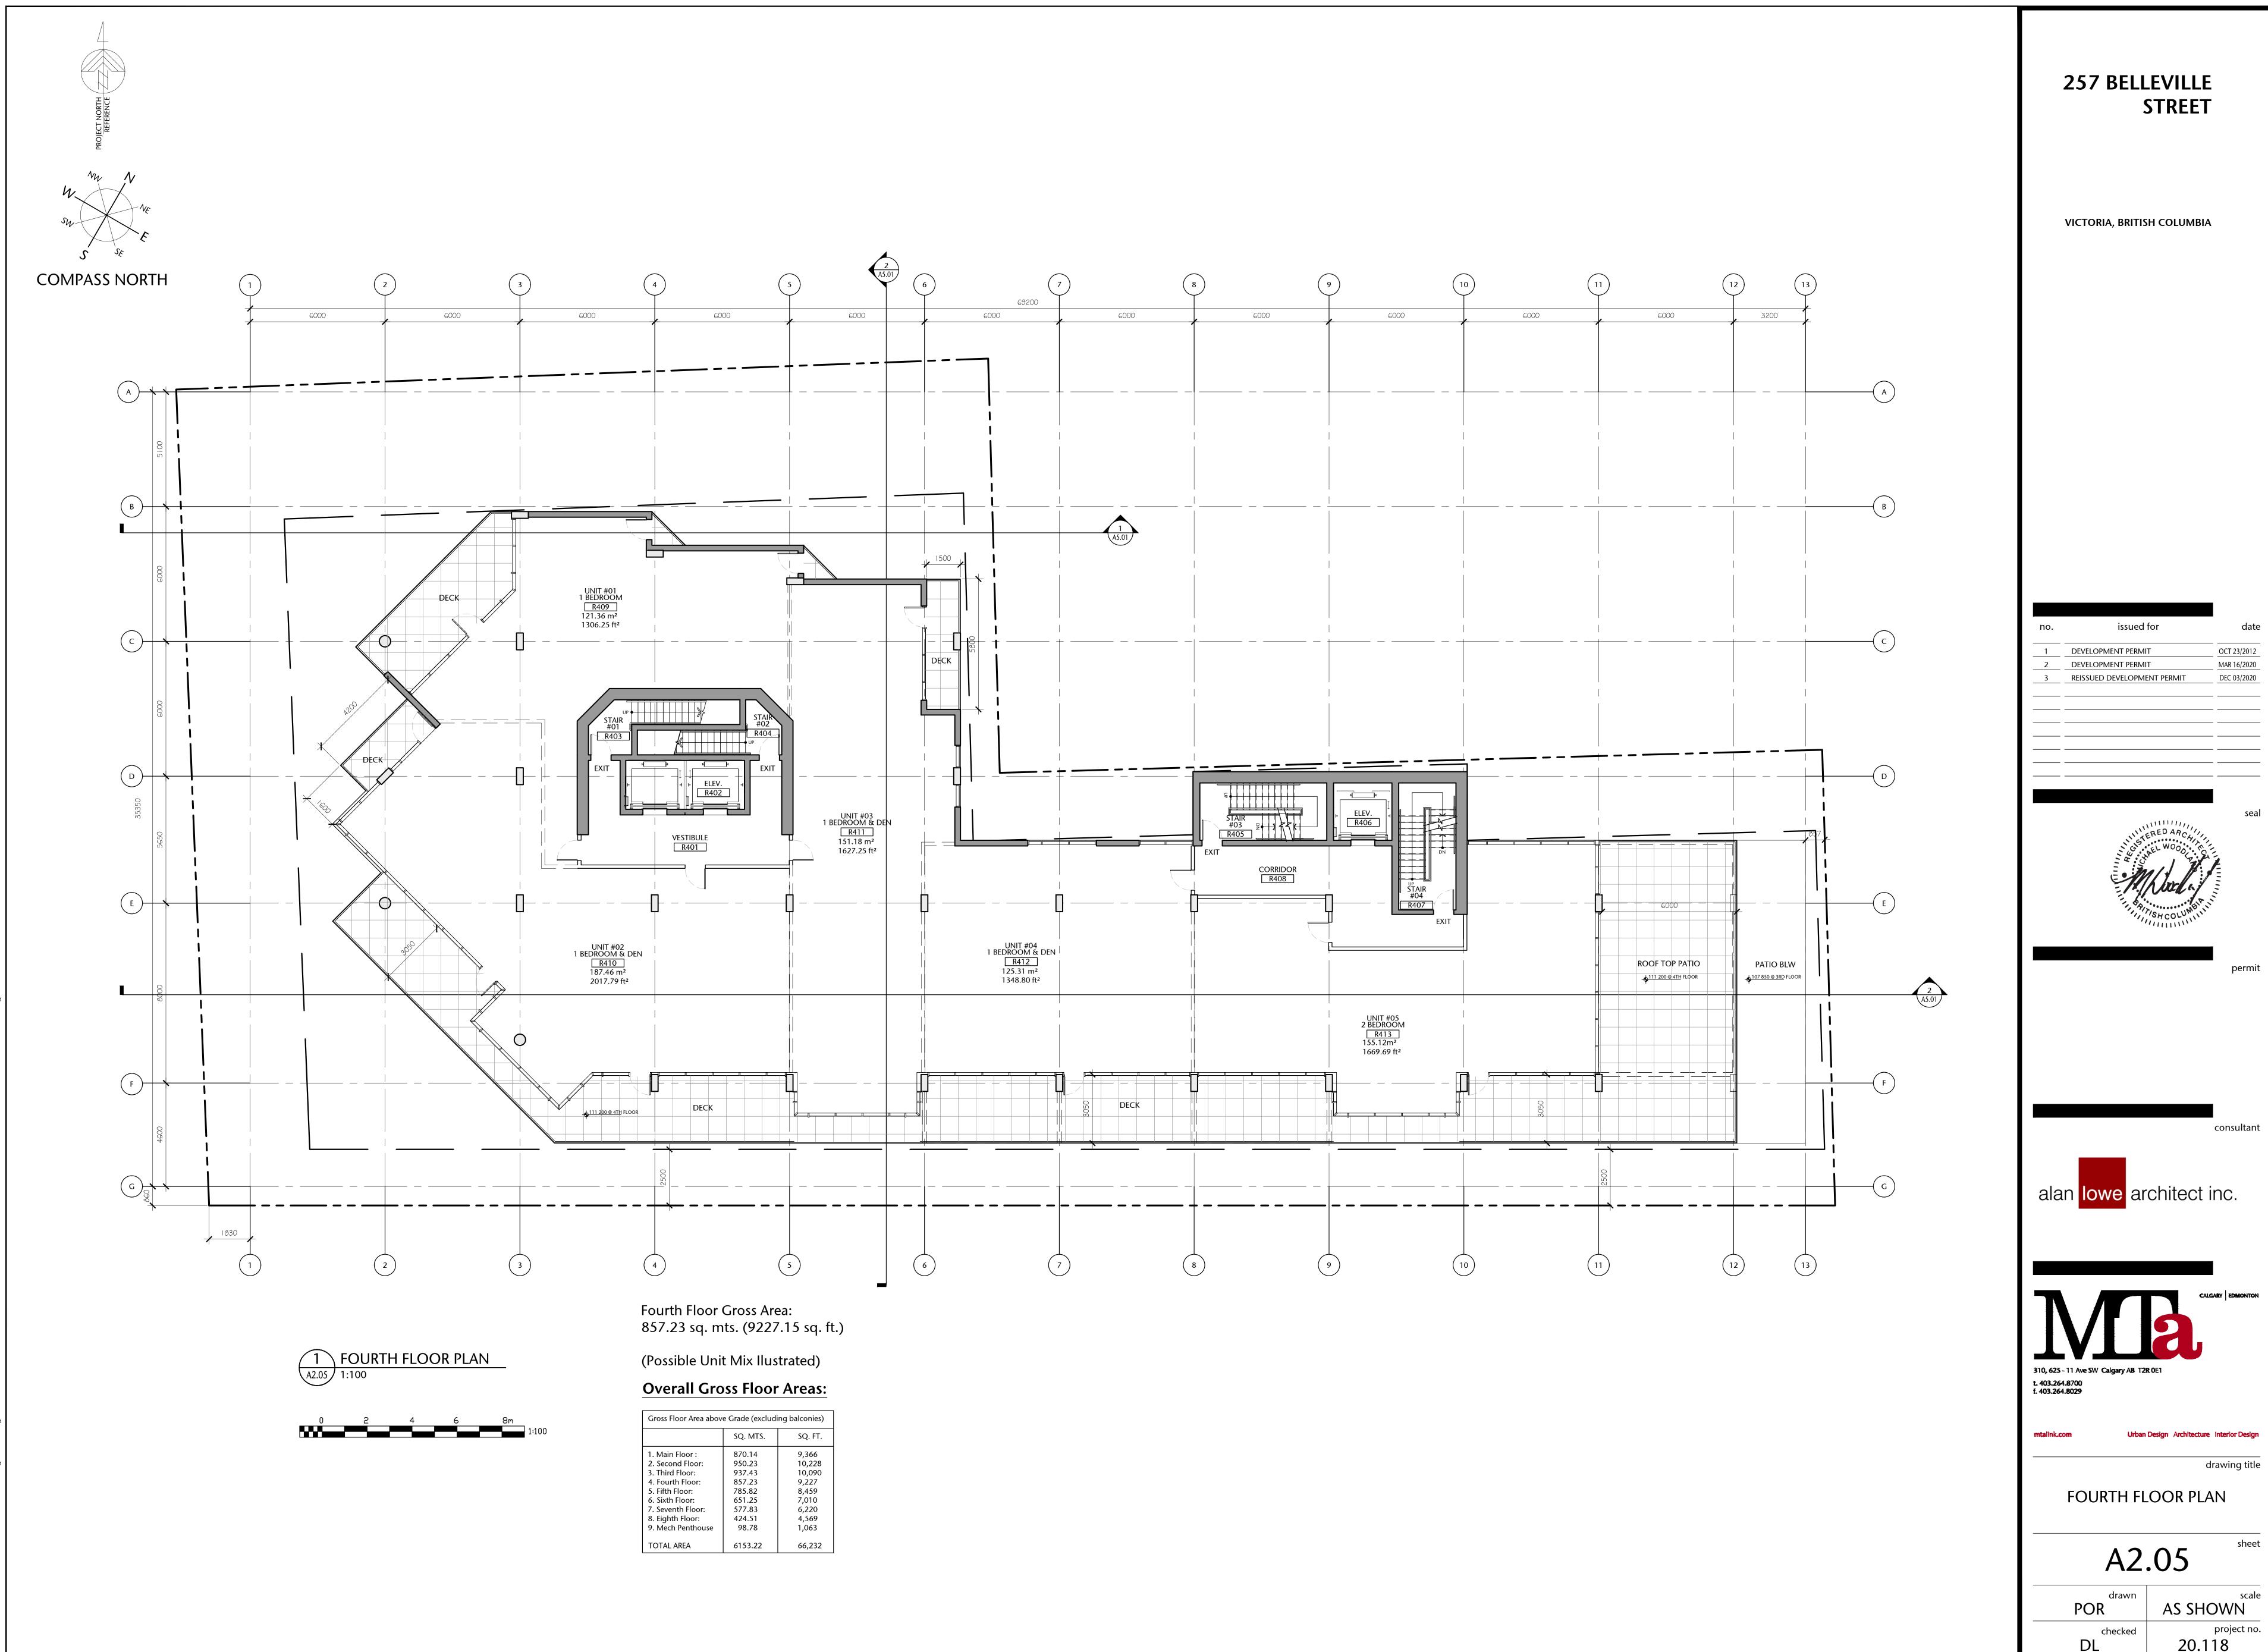


drawing title

THIRD FLOOR PLAN


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OCT 23/2012 MAR 16/2020 DEC 03/2020





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OCT 23/2012 DEVELOPMENT PERMIT MAR 16/2020 DEC 03/2020 DEVELOPMENT PERMIT REISSUED DEVELOPMENT PERMIT

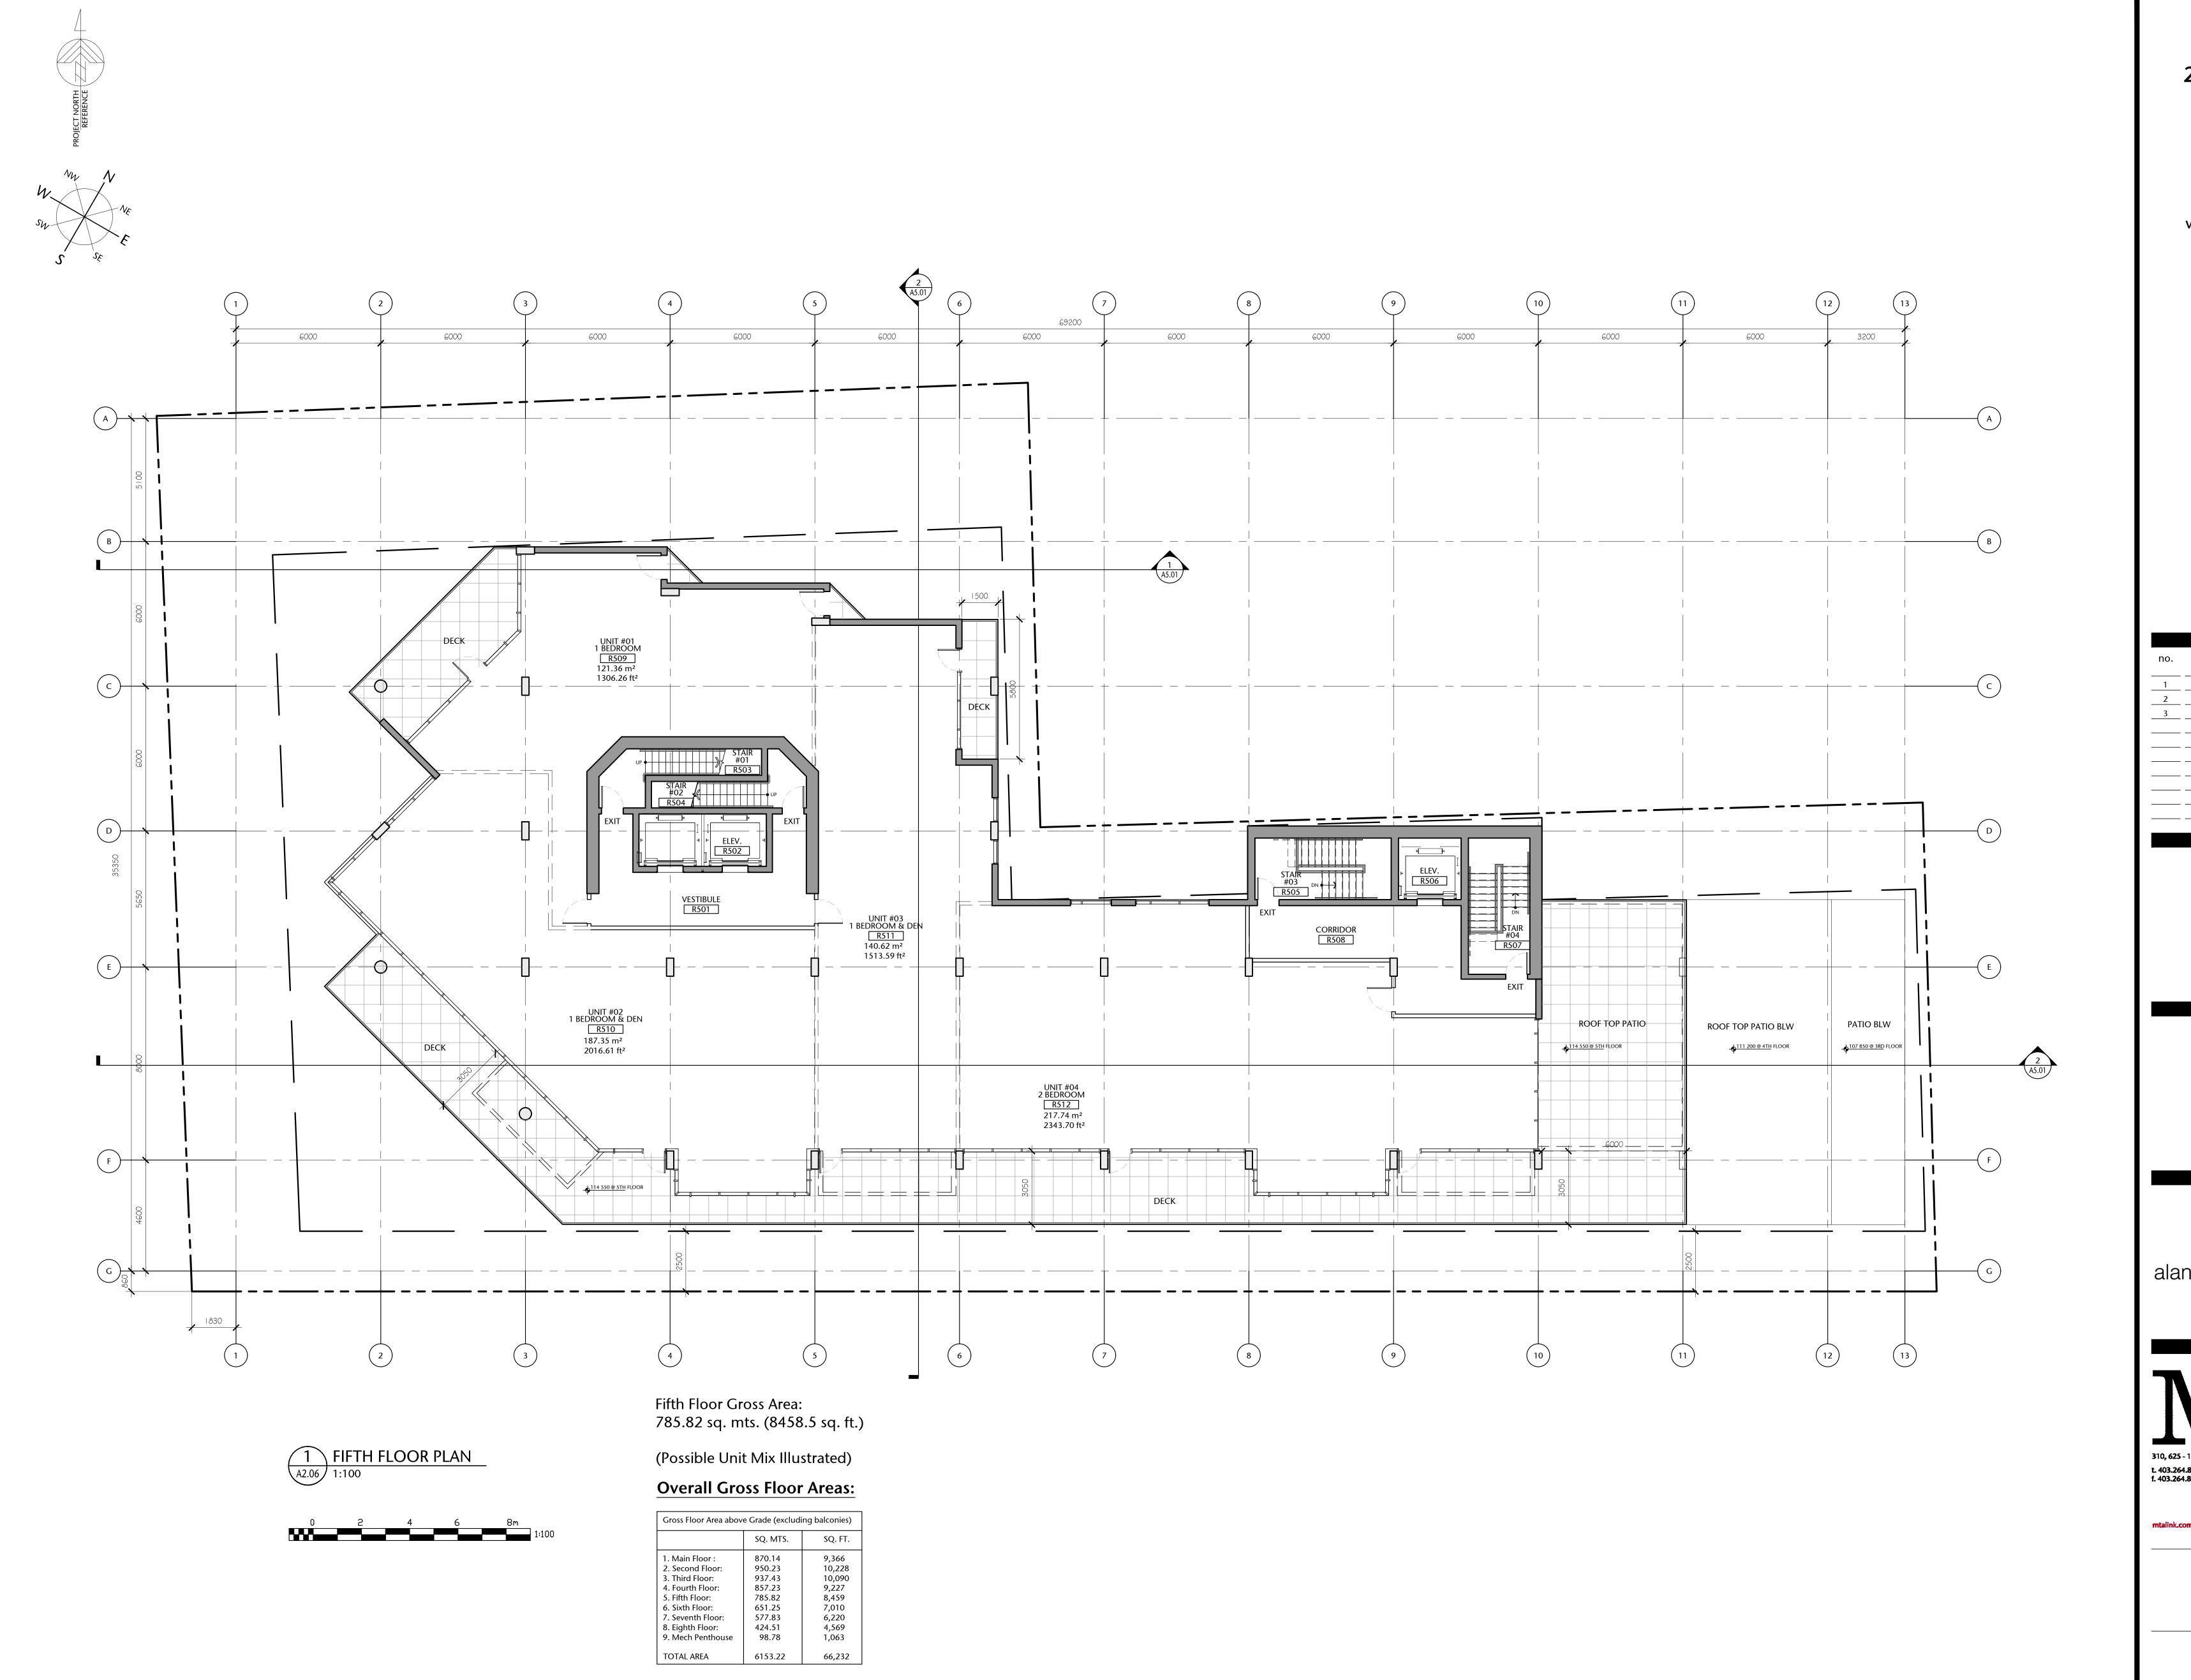

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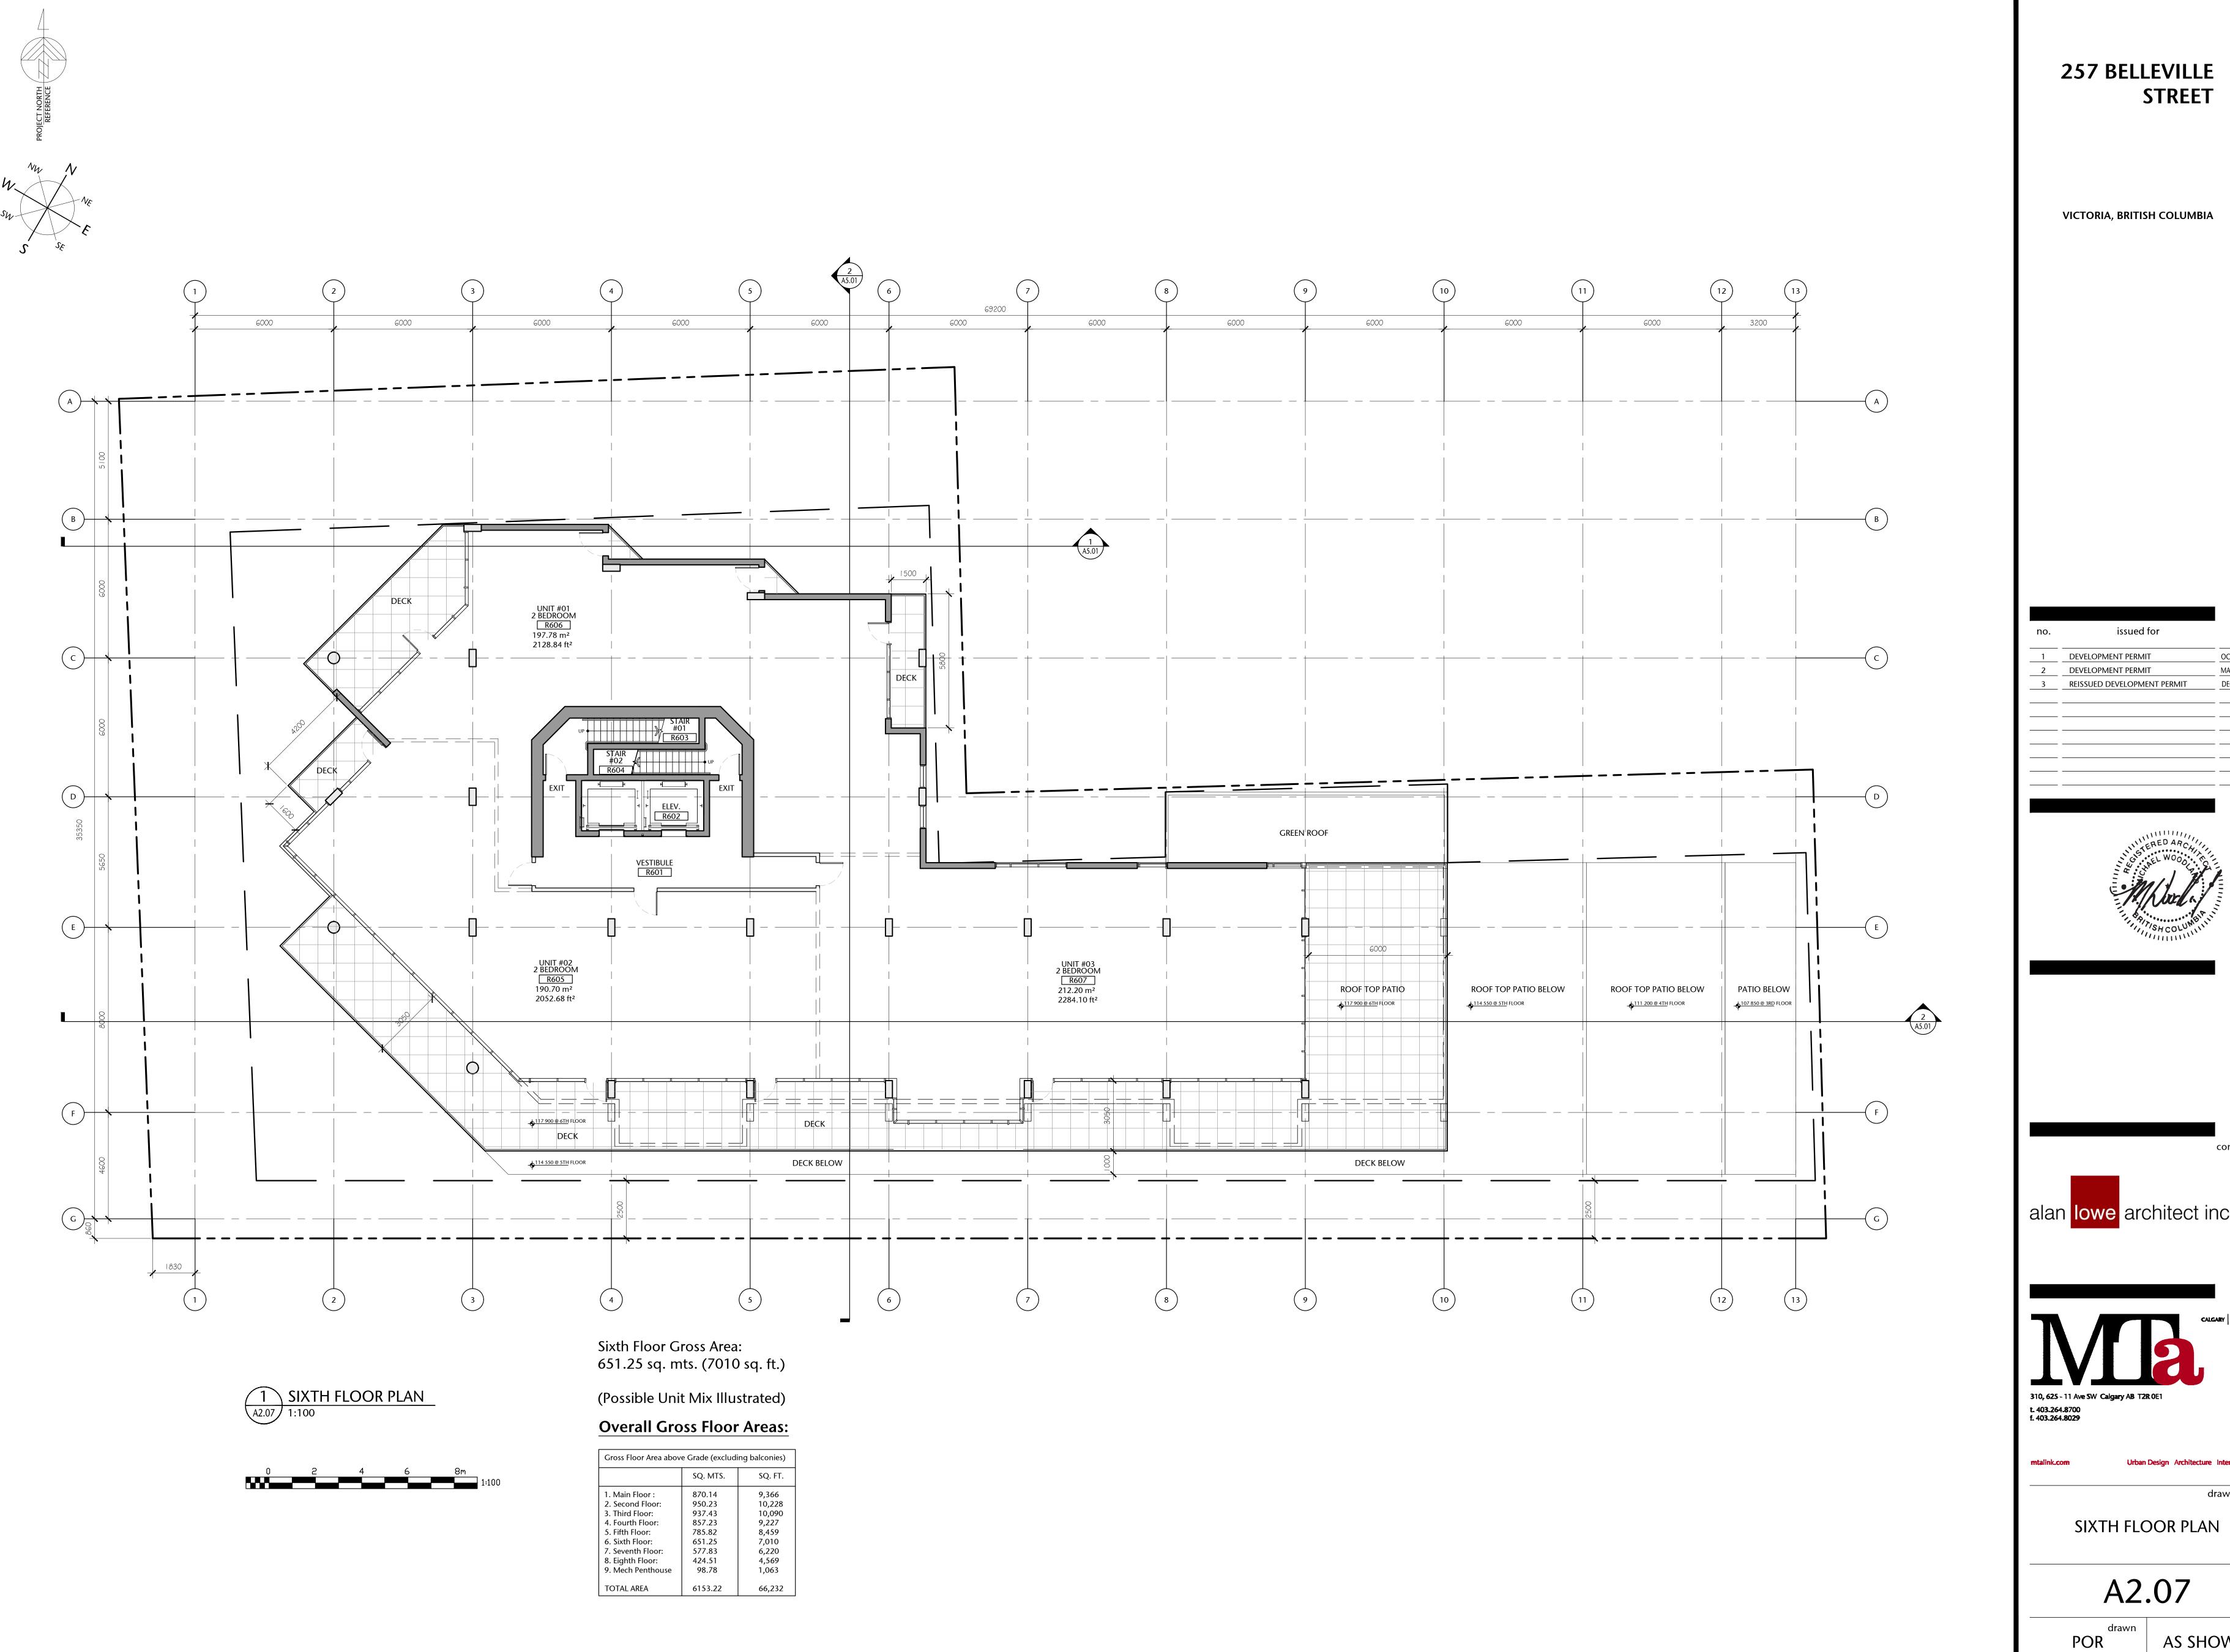
Urban Design Architecture Interior Design

drawing title

FIFTH FLOOR PLAN

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**AS SHOWN** 




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consultant


alan lowe architect inc.



Urban Design Architecture Interior Design

drawing title
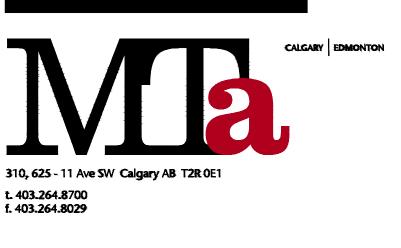
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VICTORIA, BRITISH COLUMBIA

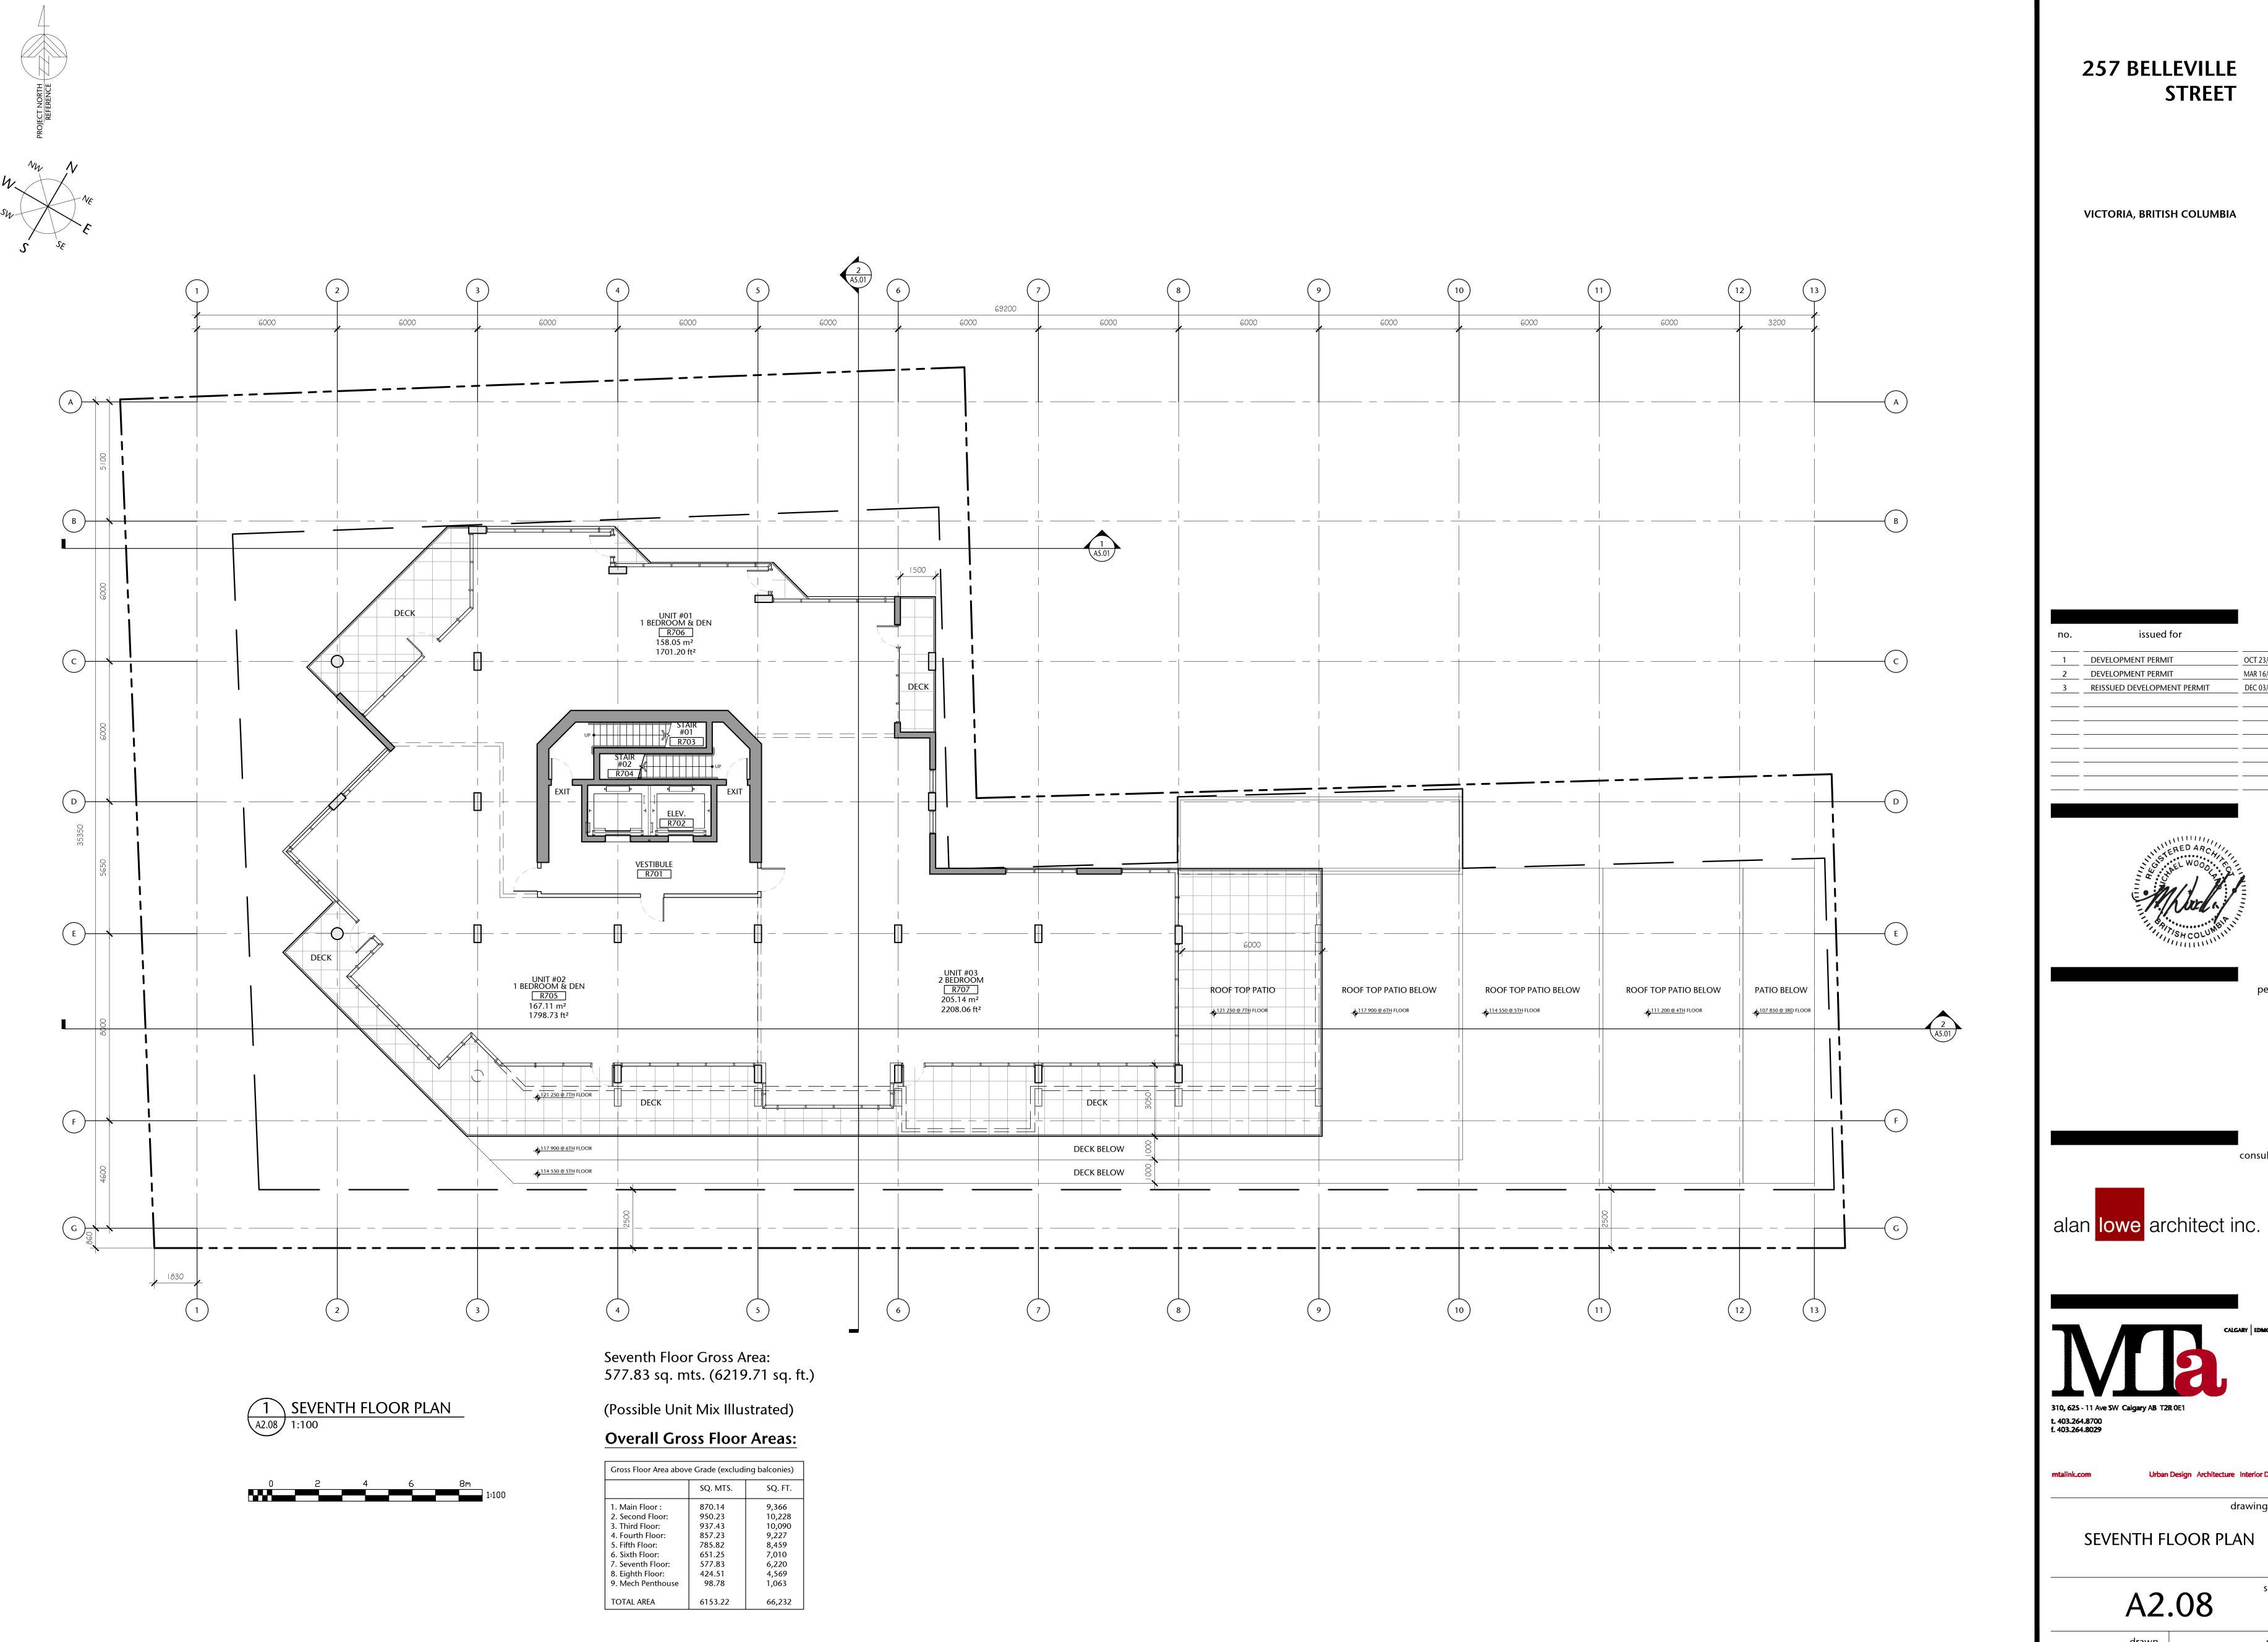OCT 23/2012 DEVELOPMENT PERMIT MAR 16/2020 DEC 03/2020 DEVELOPMENT PERMIT REISSUED DEVELOPMENT PERMIT






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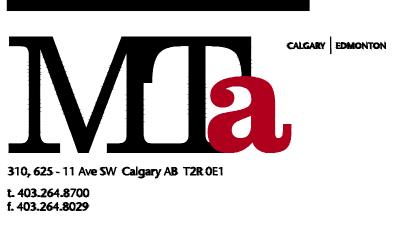
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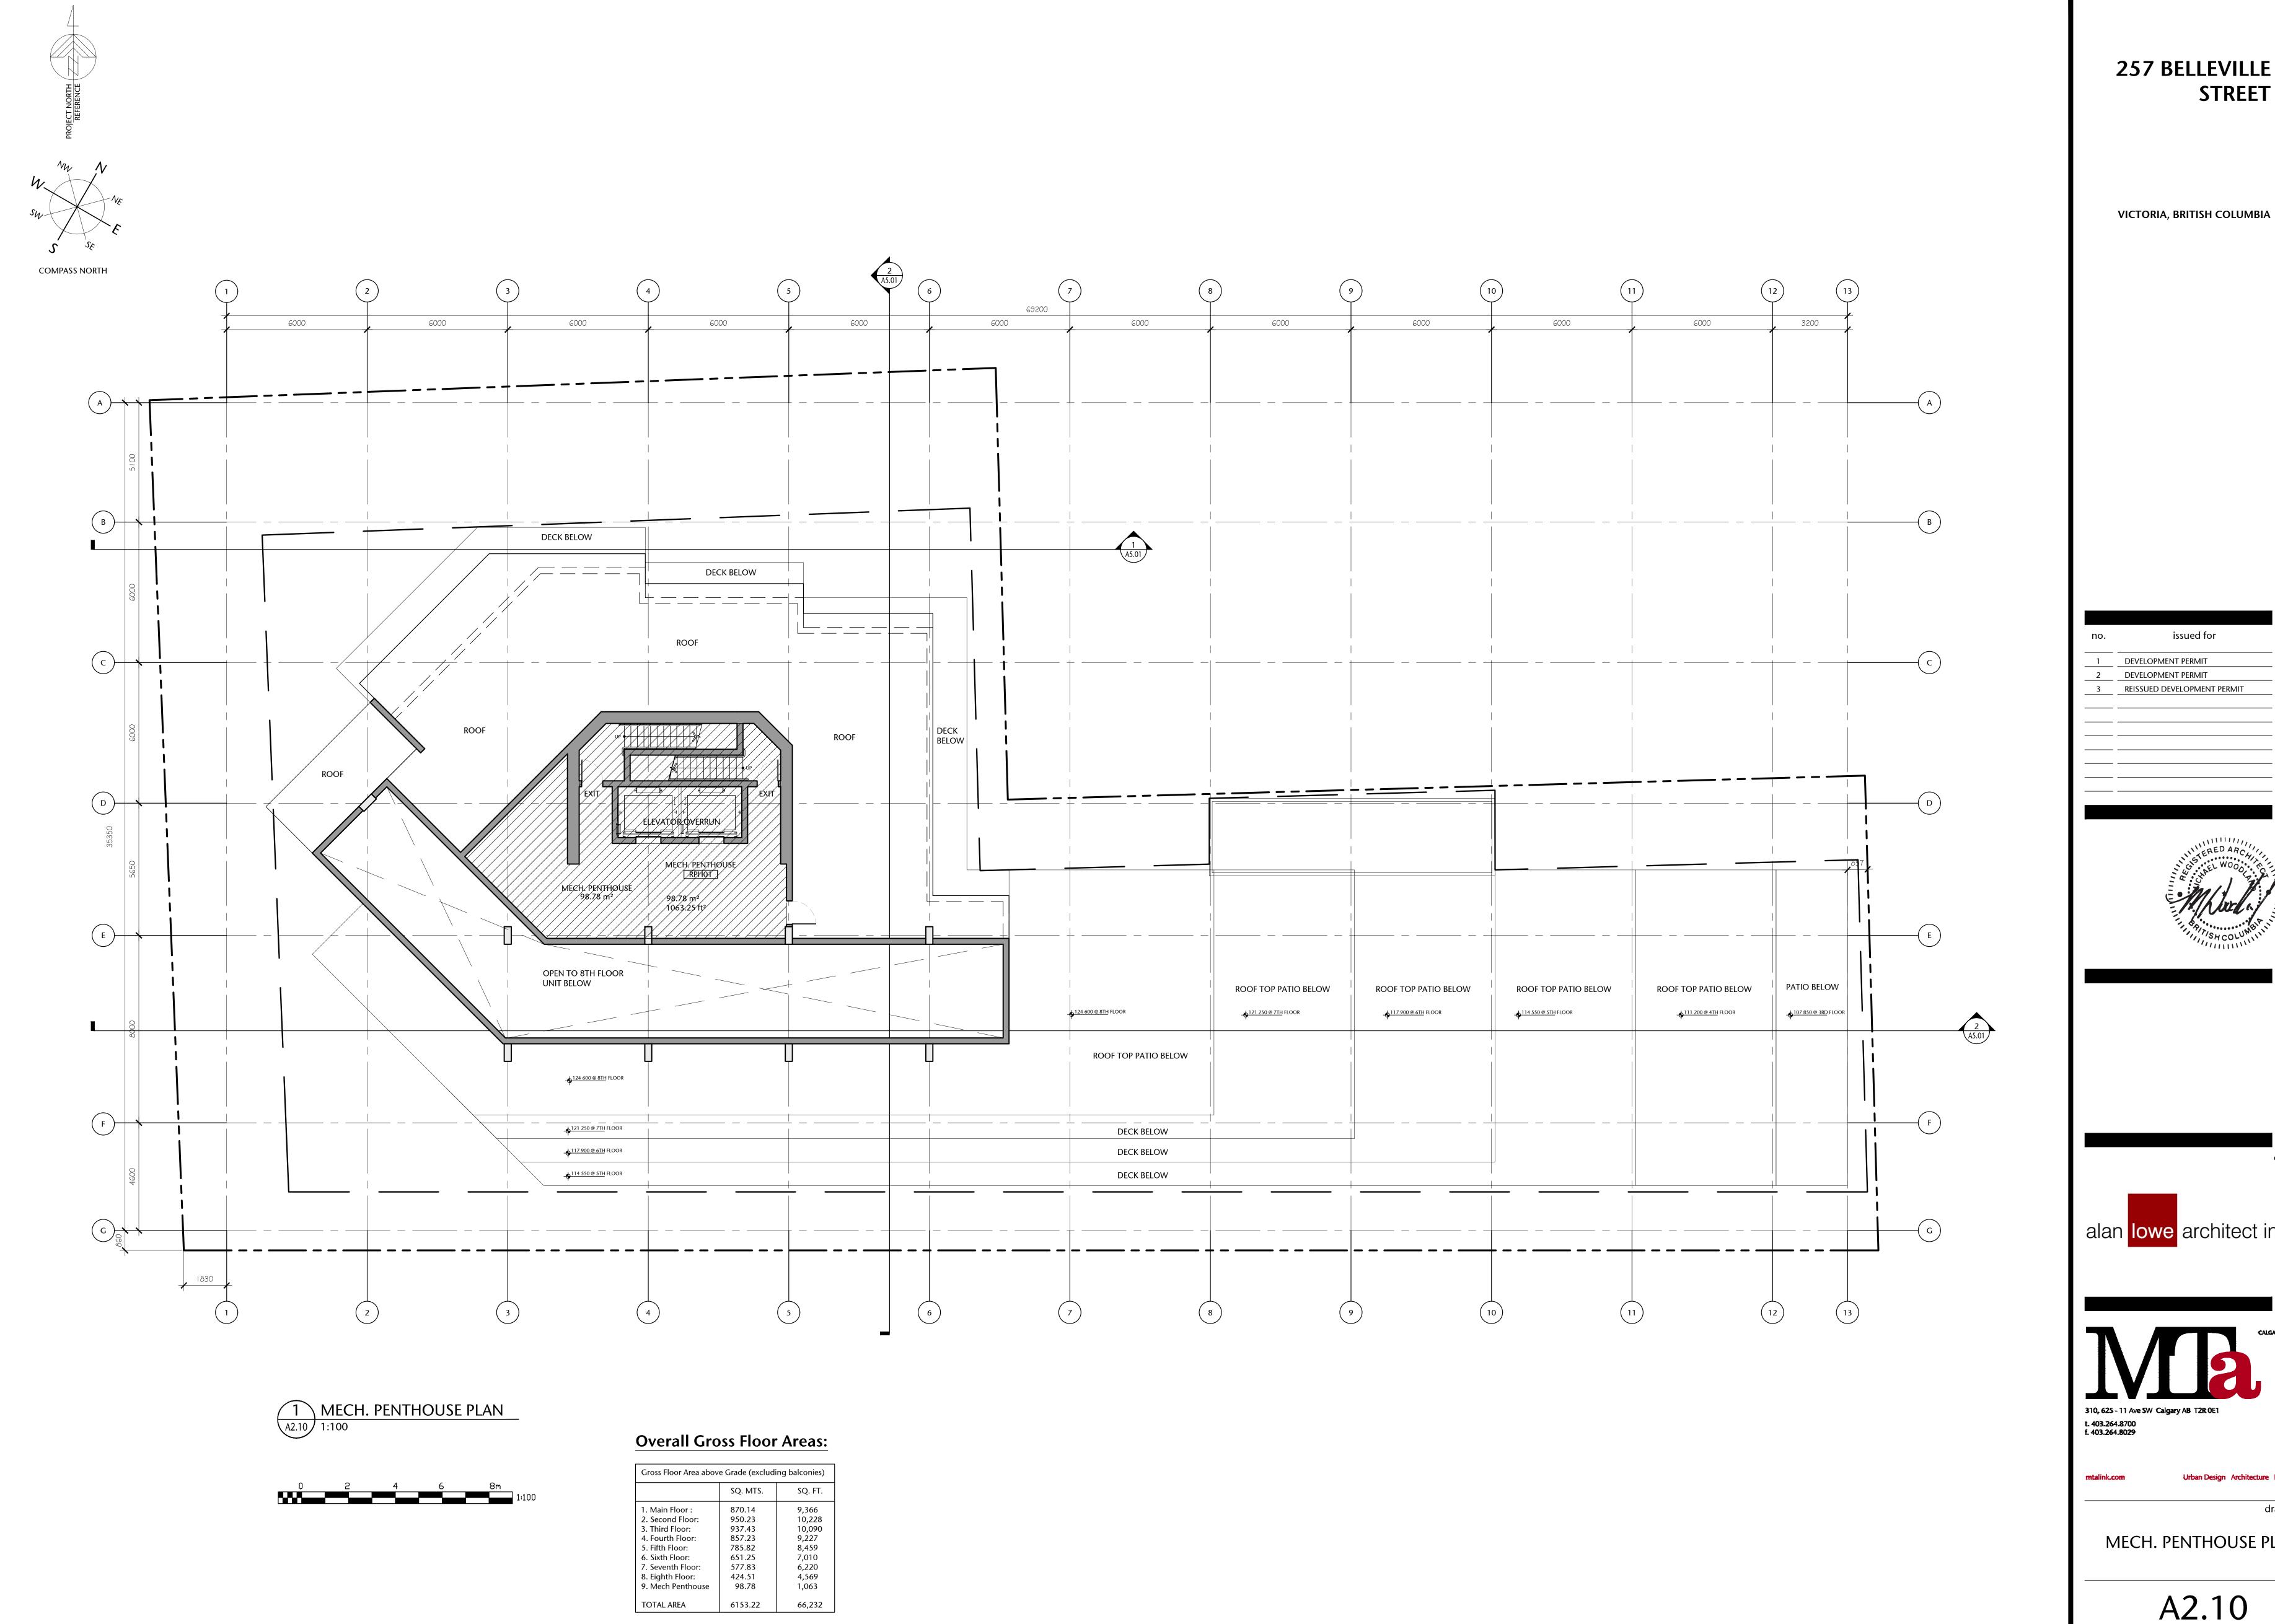
A2.08

**AS SHOWN** project no.



OCT 23/2012 MAR 16/2020 DEC 03/2020

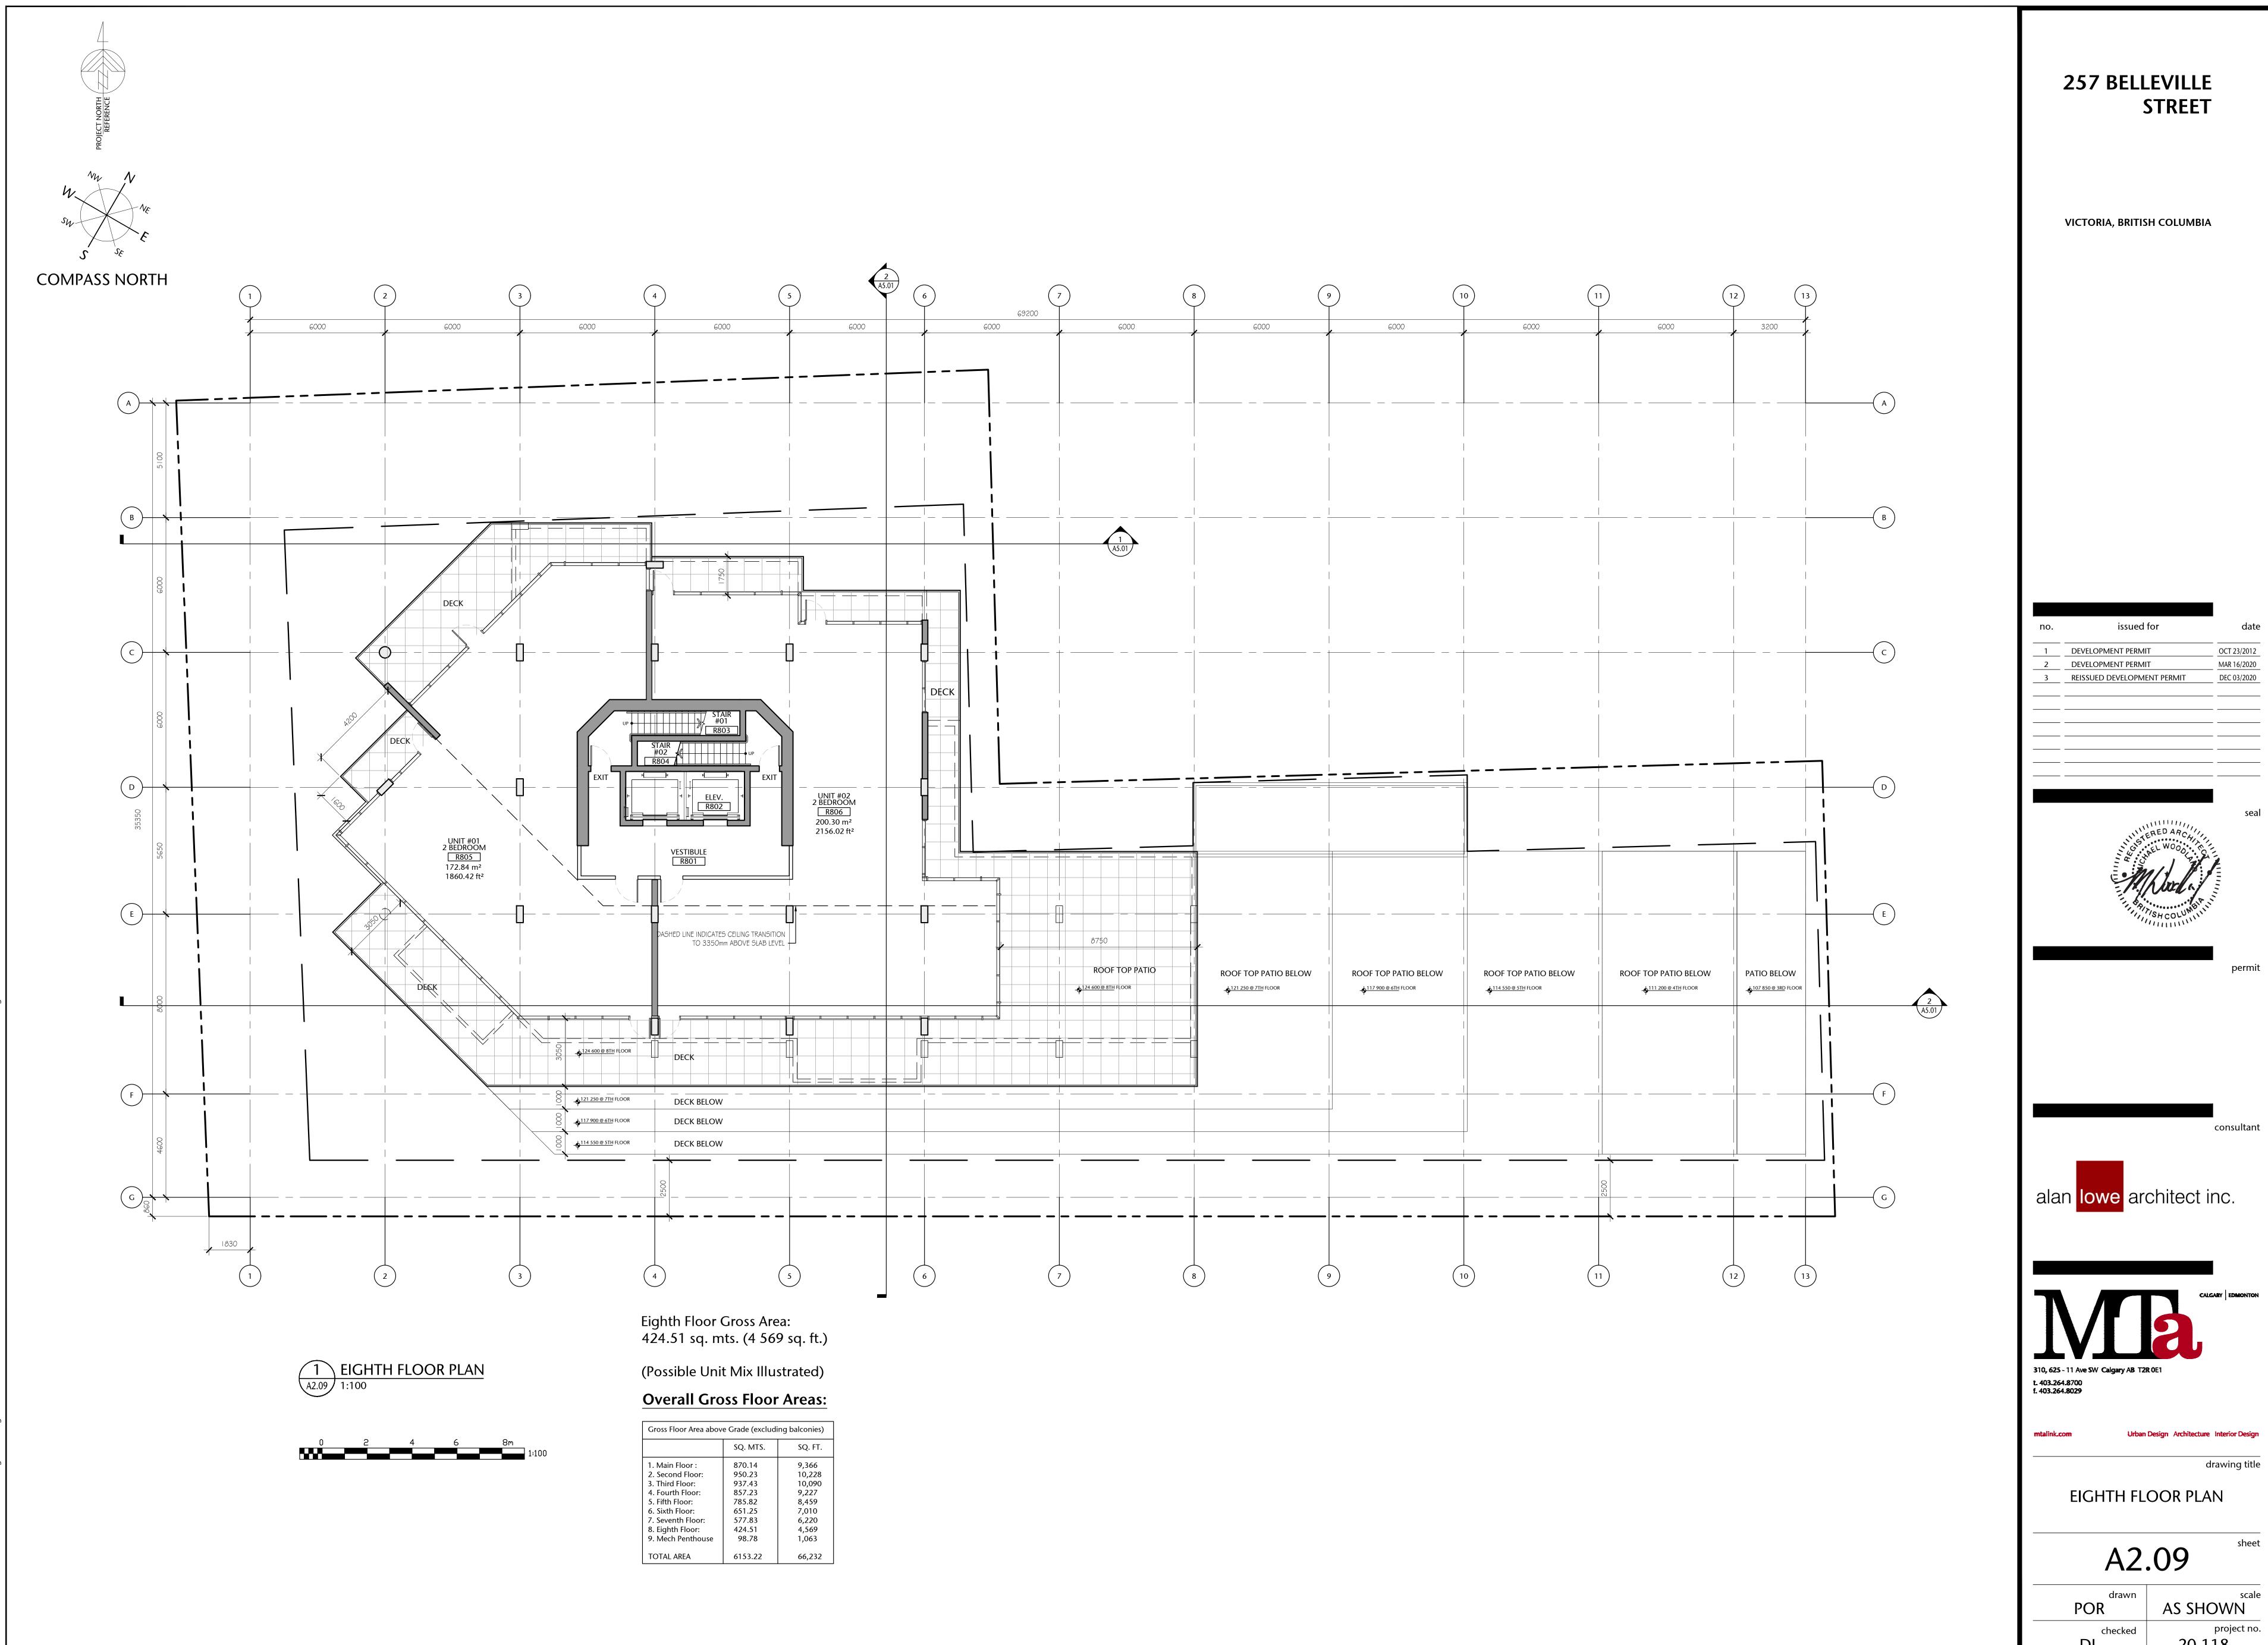



OCT 23/2012 MAR 16/2020 DEC 03/2020 REISSUED DEVELOPMENT PERMIT



consultant

drawing title

alan lowe architect inc.




Urban Design Architecture Interior Design

MECH. PENTHOUSE PLAN

A2.10

**AS SHOWN** project no.

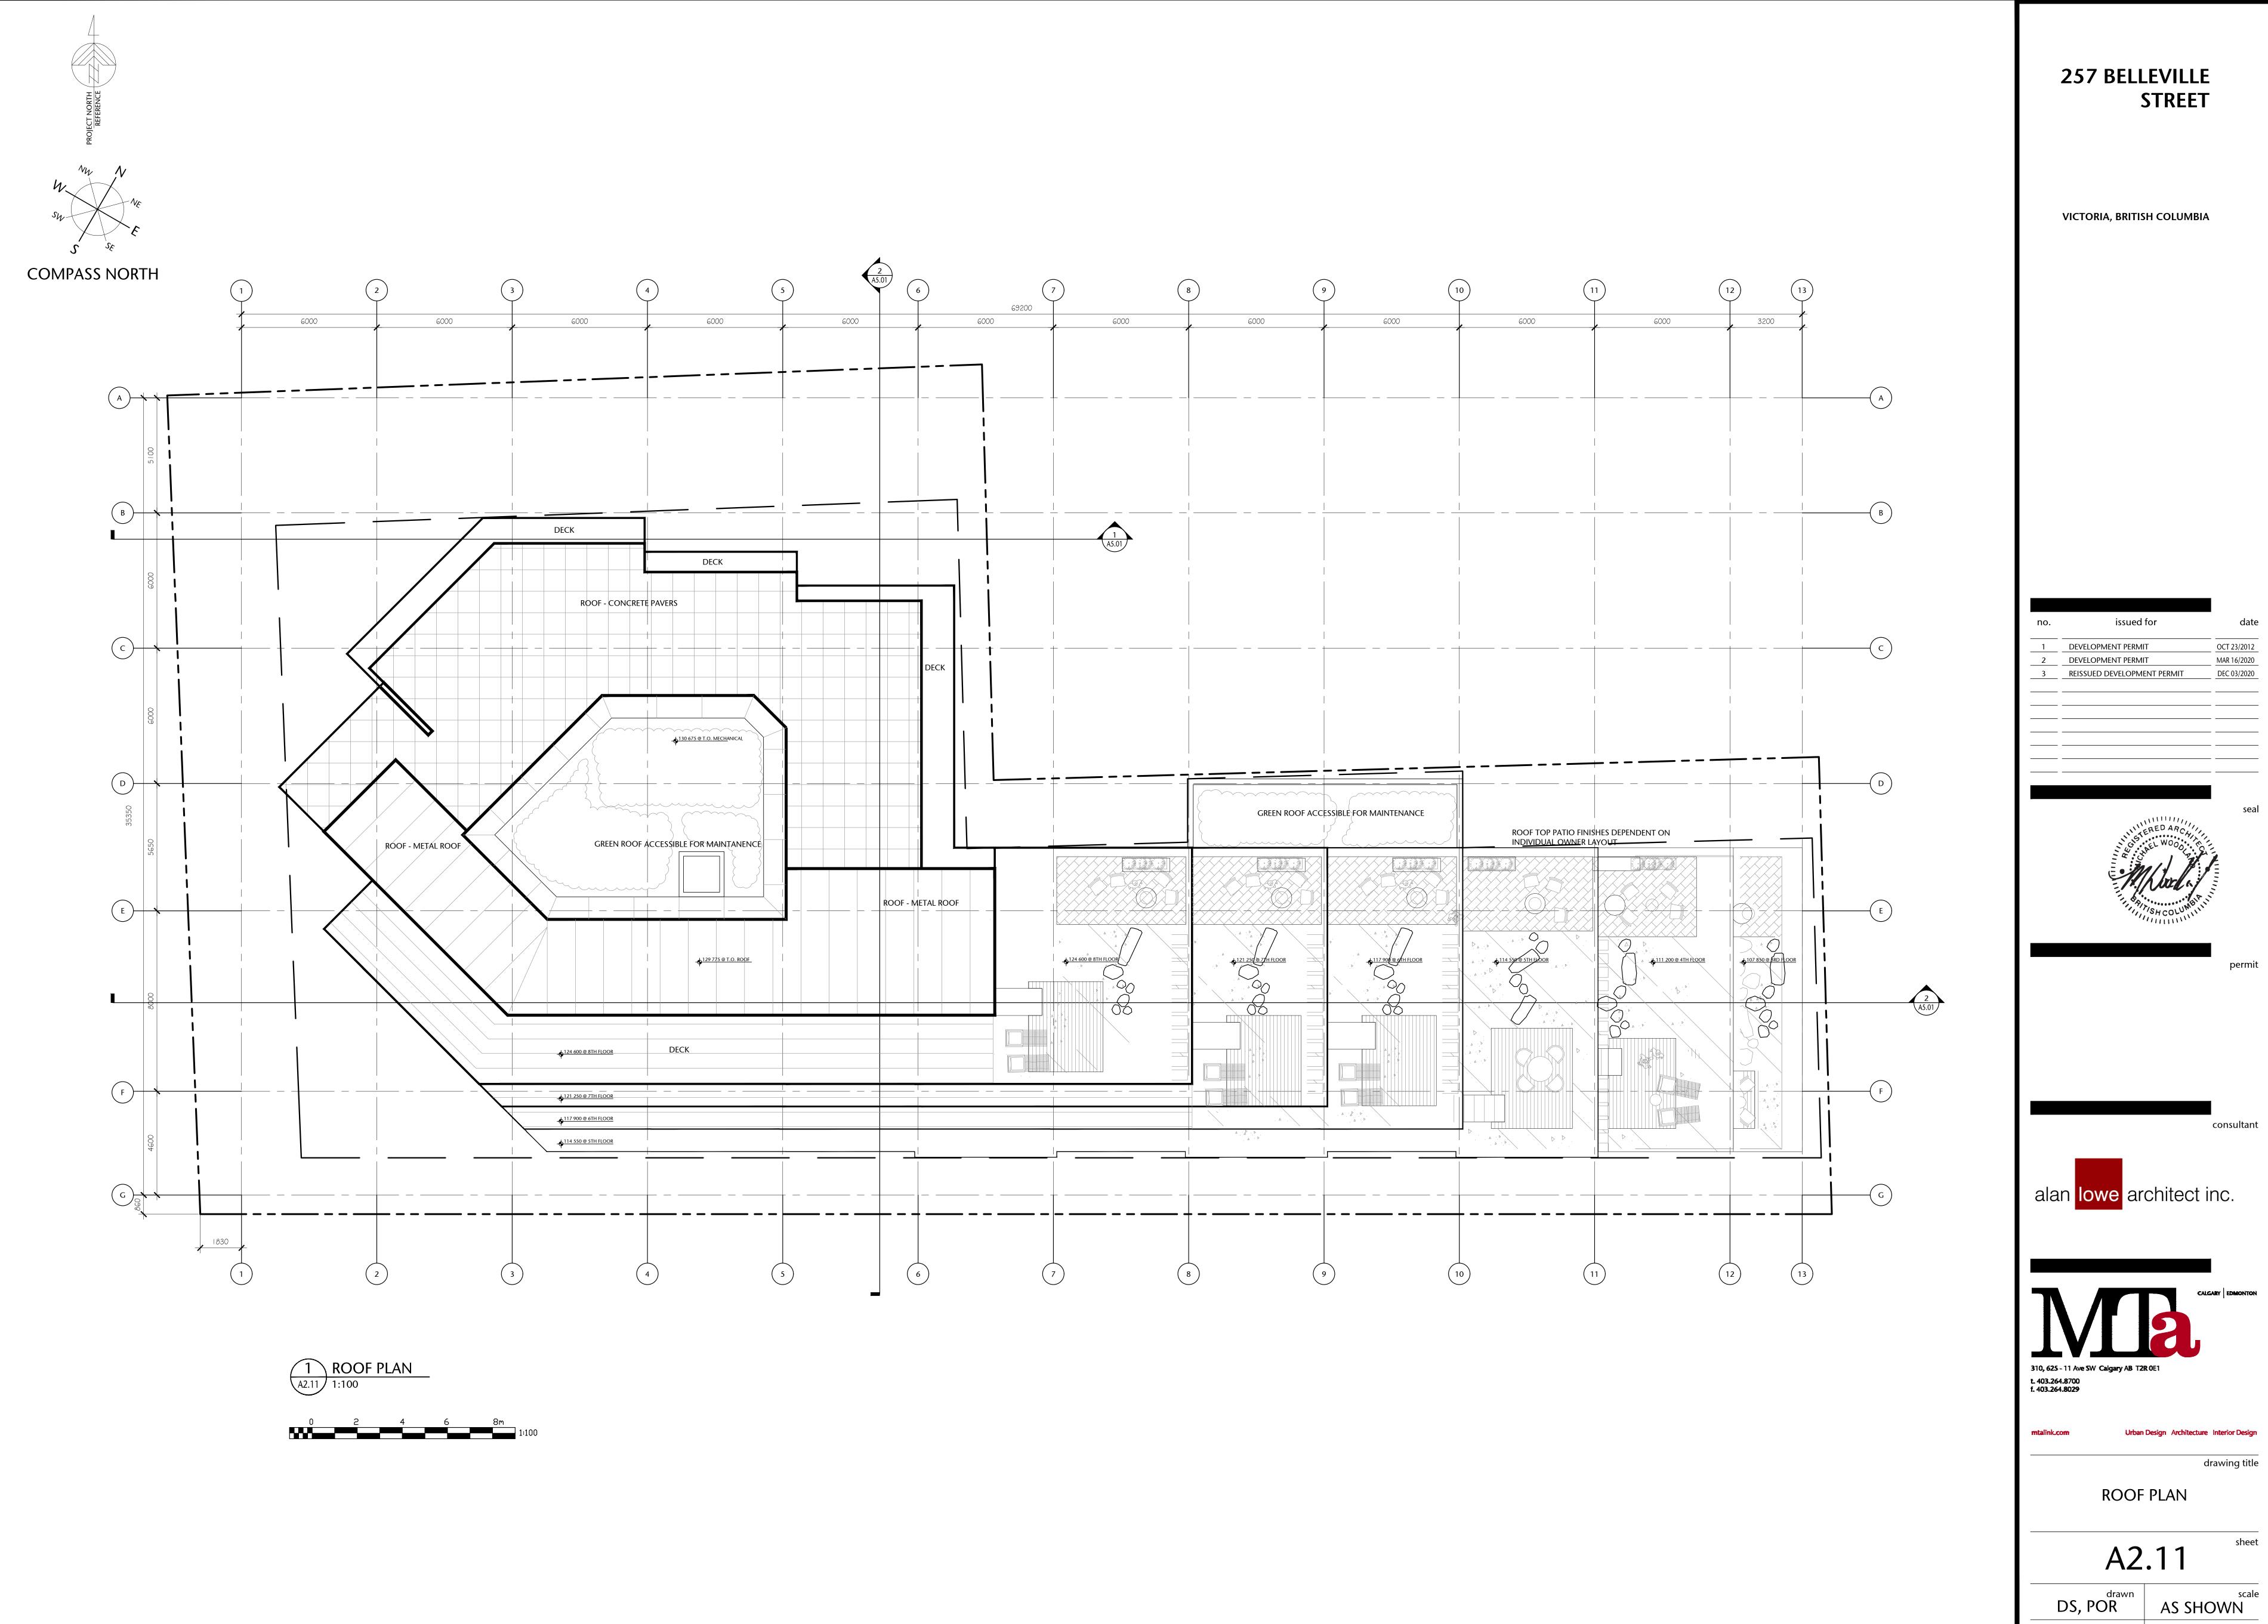


OCT 23/2012 MAR 16/2020 DEC 03/2020 REISSUED DEVELOPMENT PERMIT


consultant





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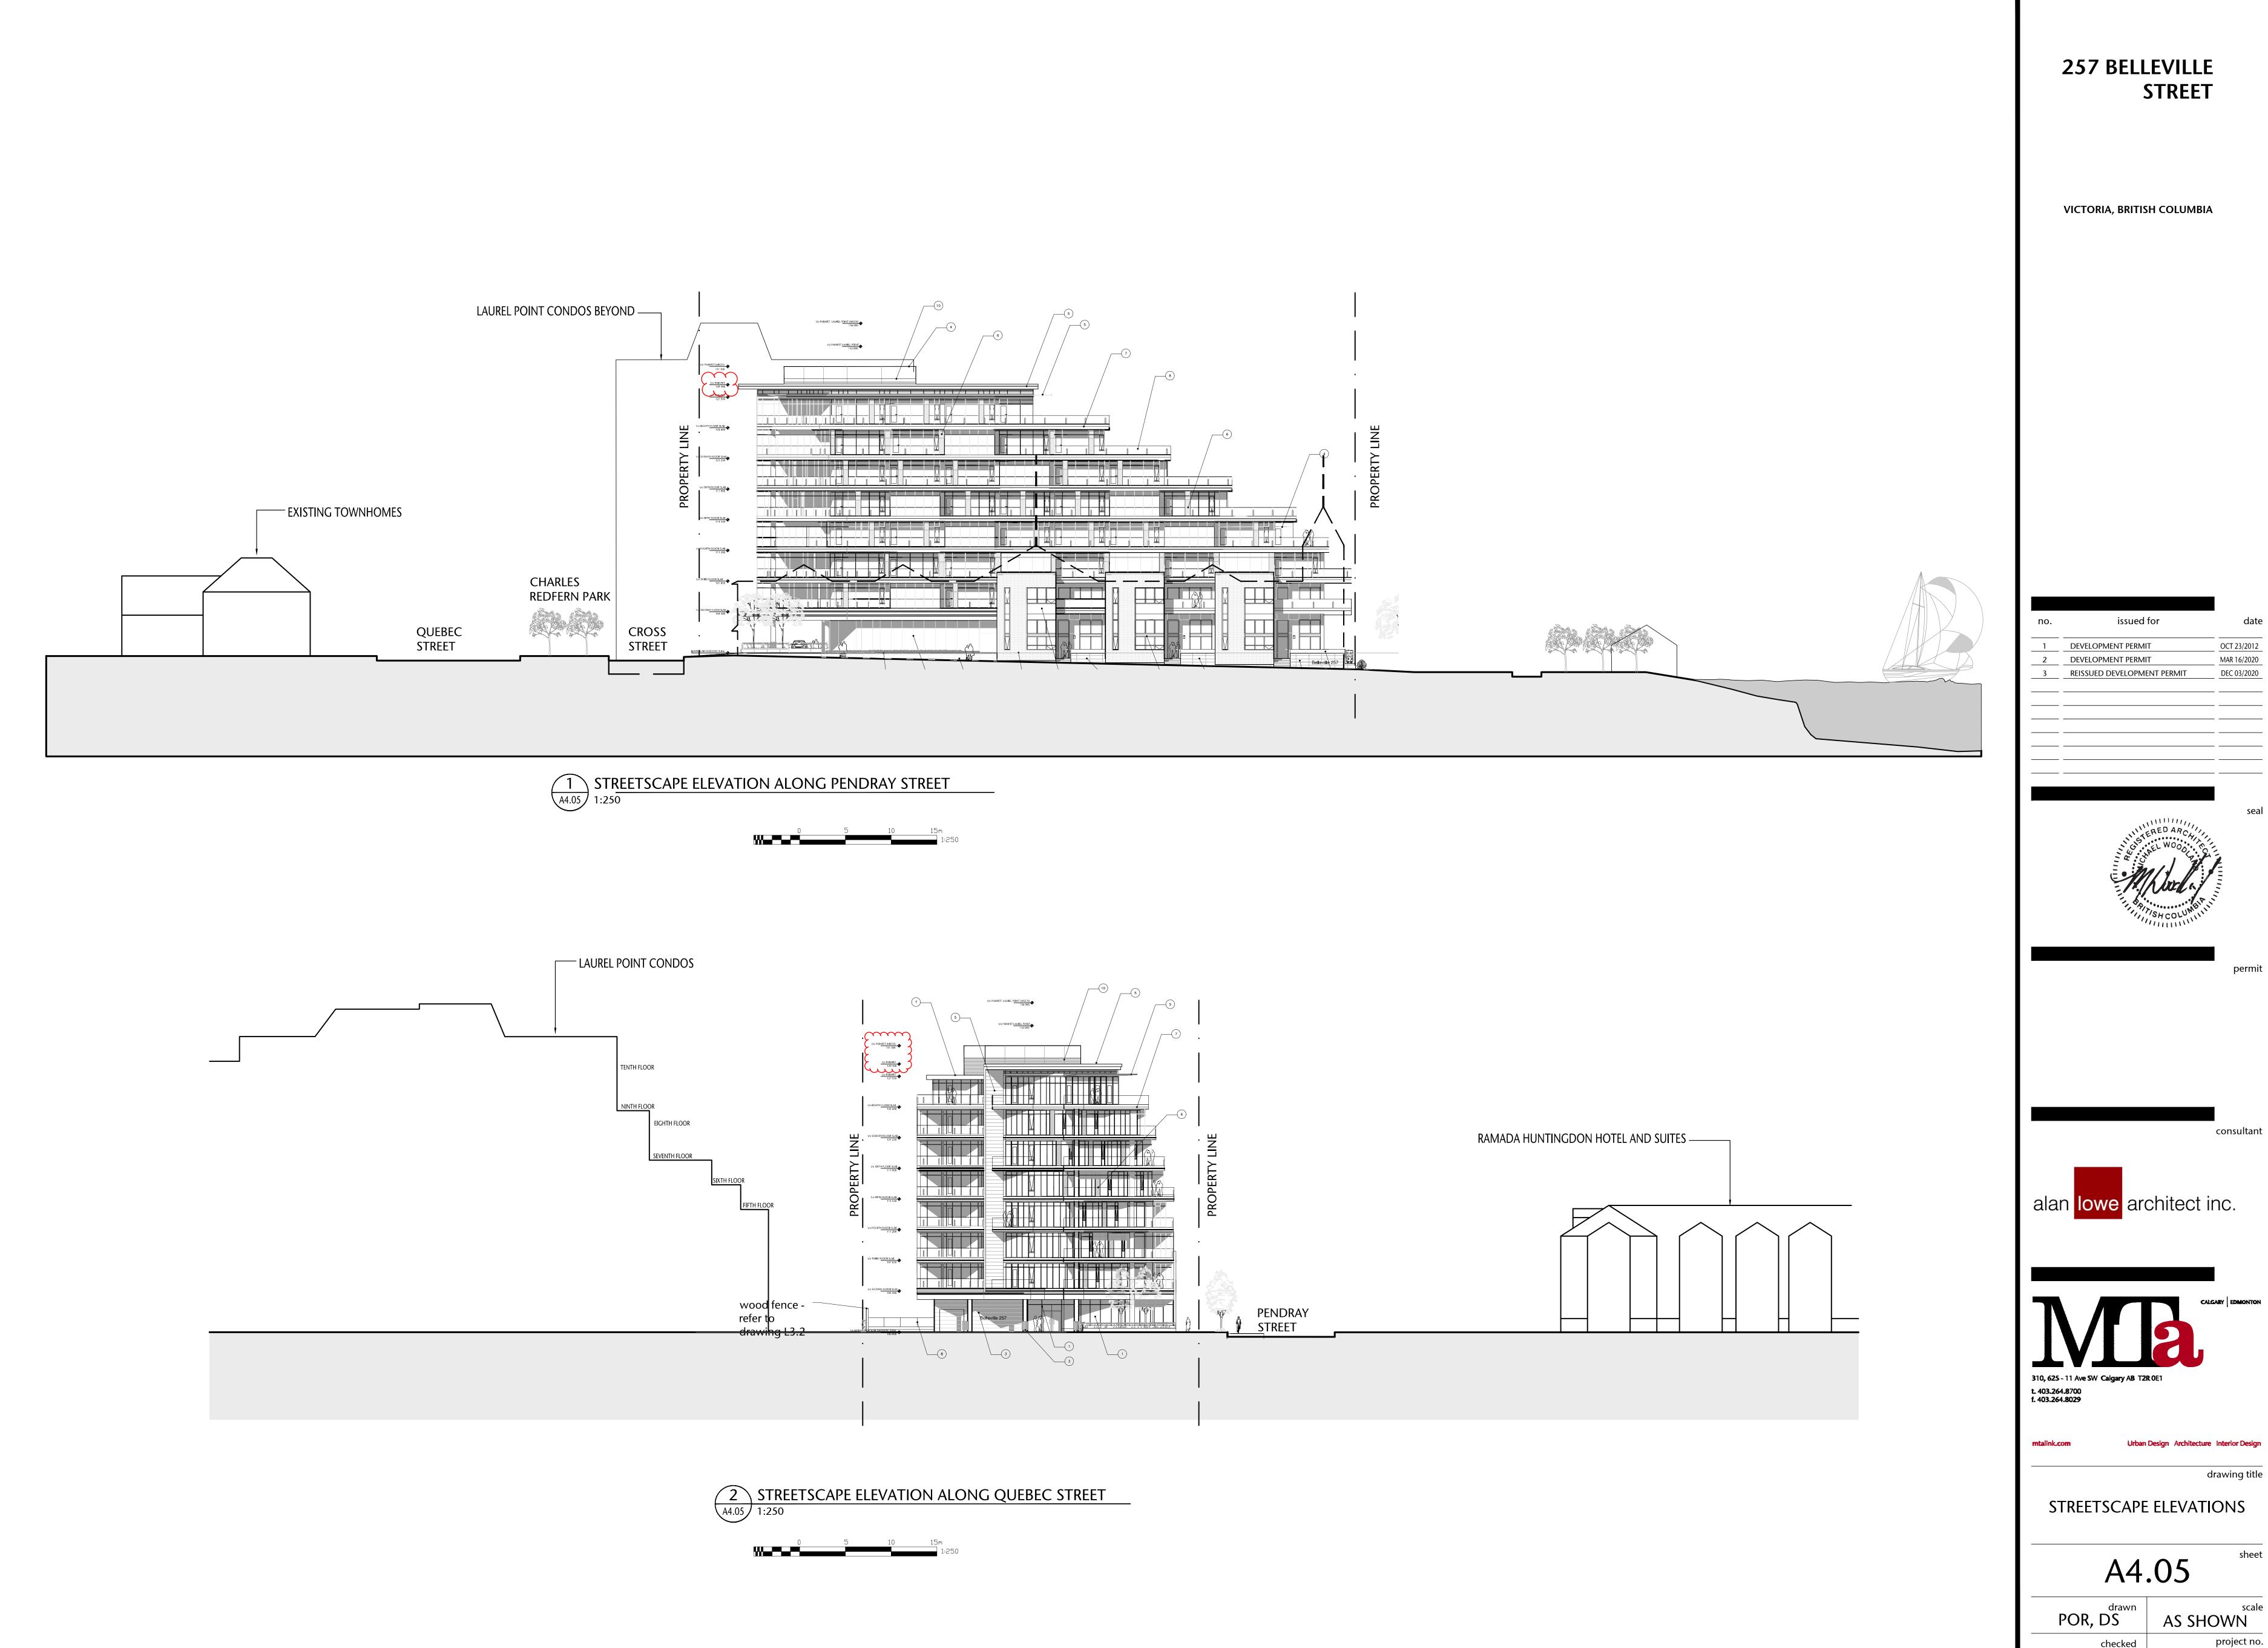
**ROOF PLAN** 



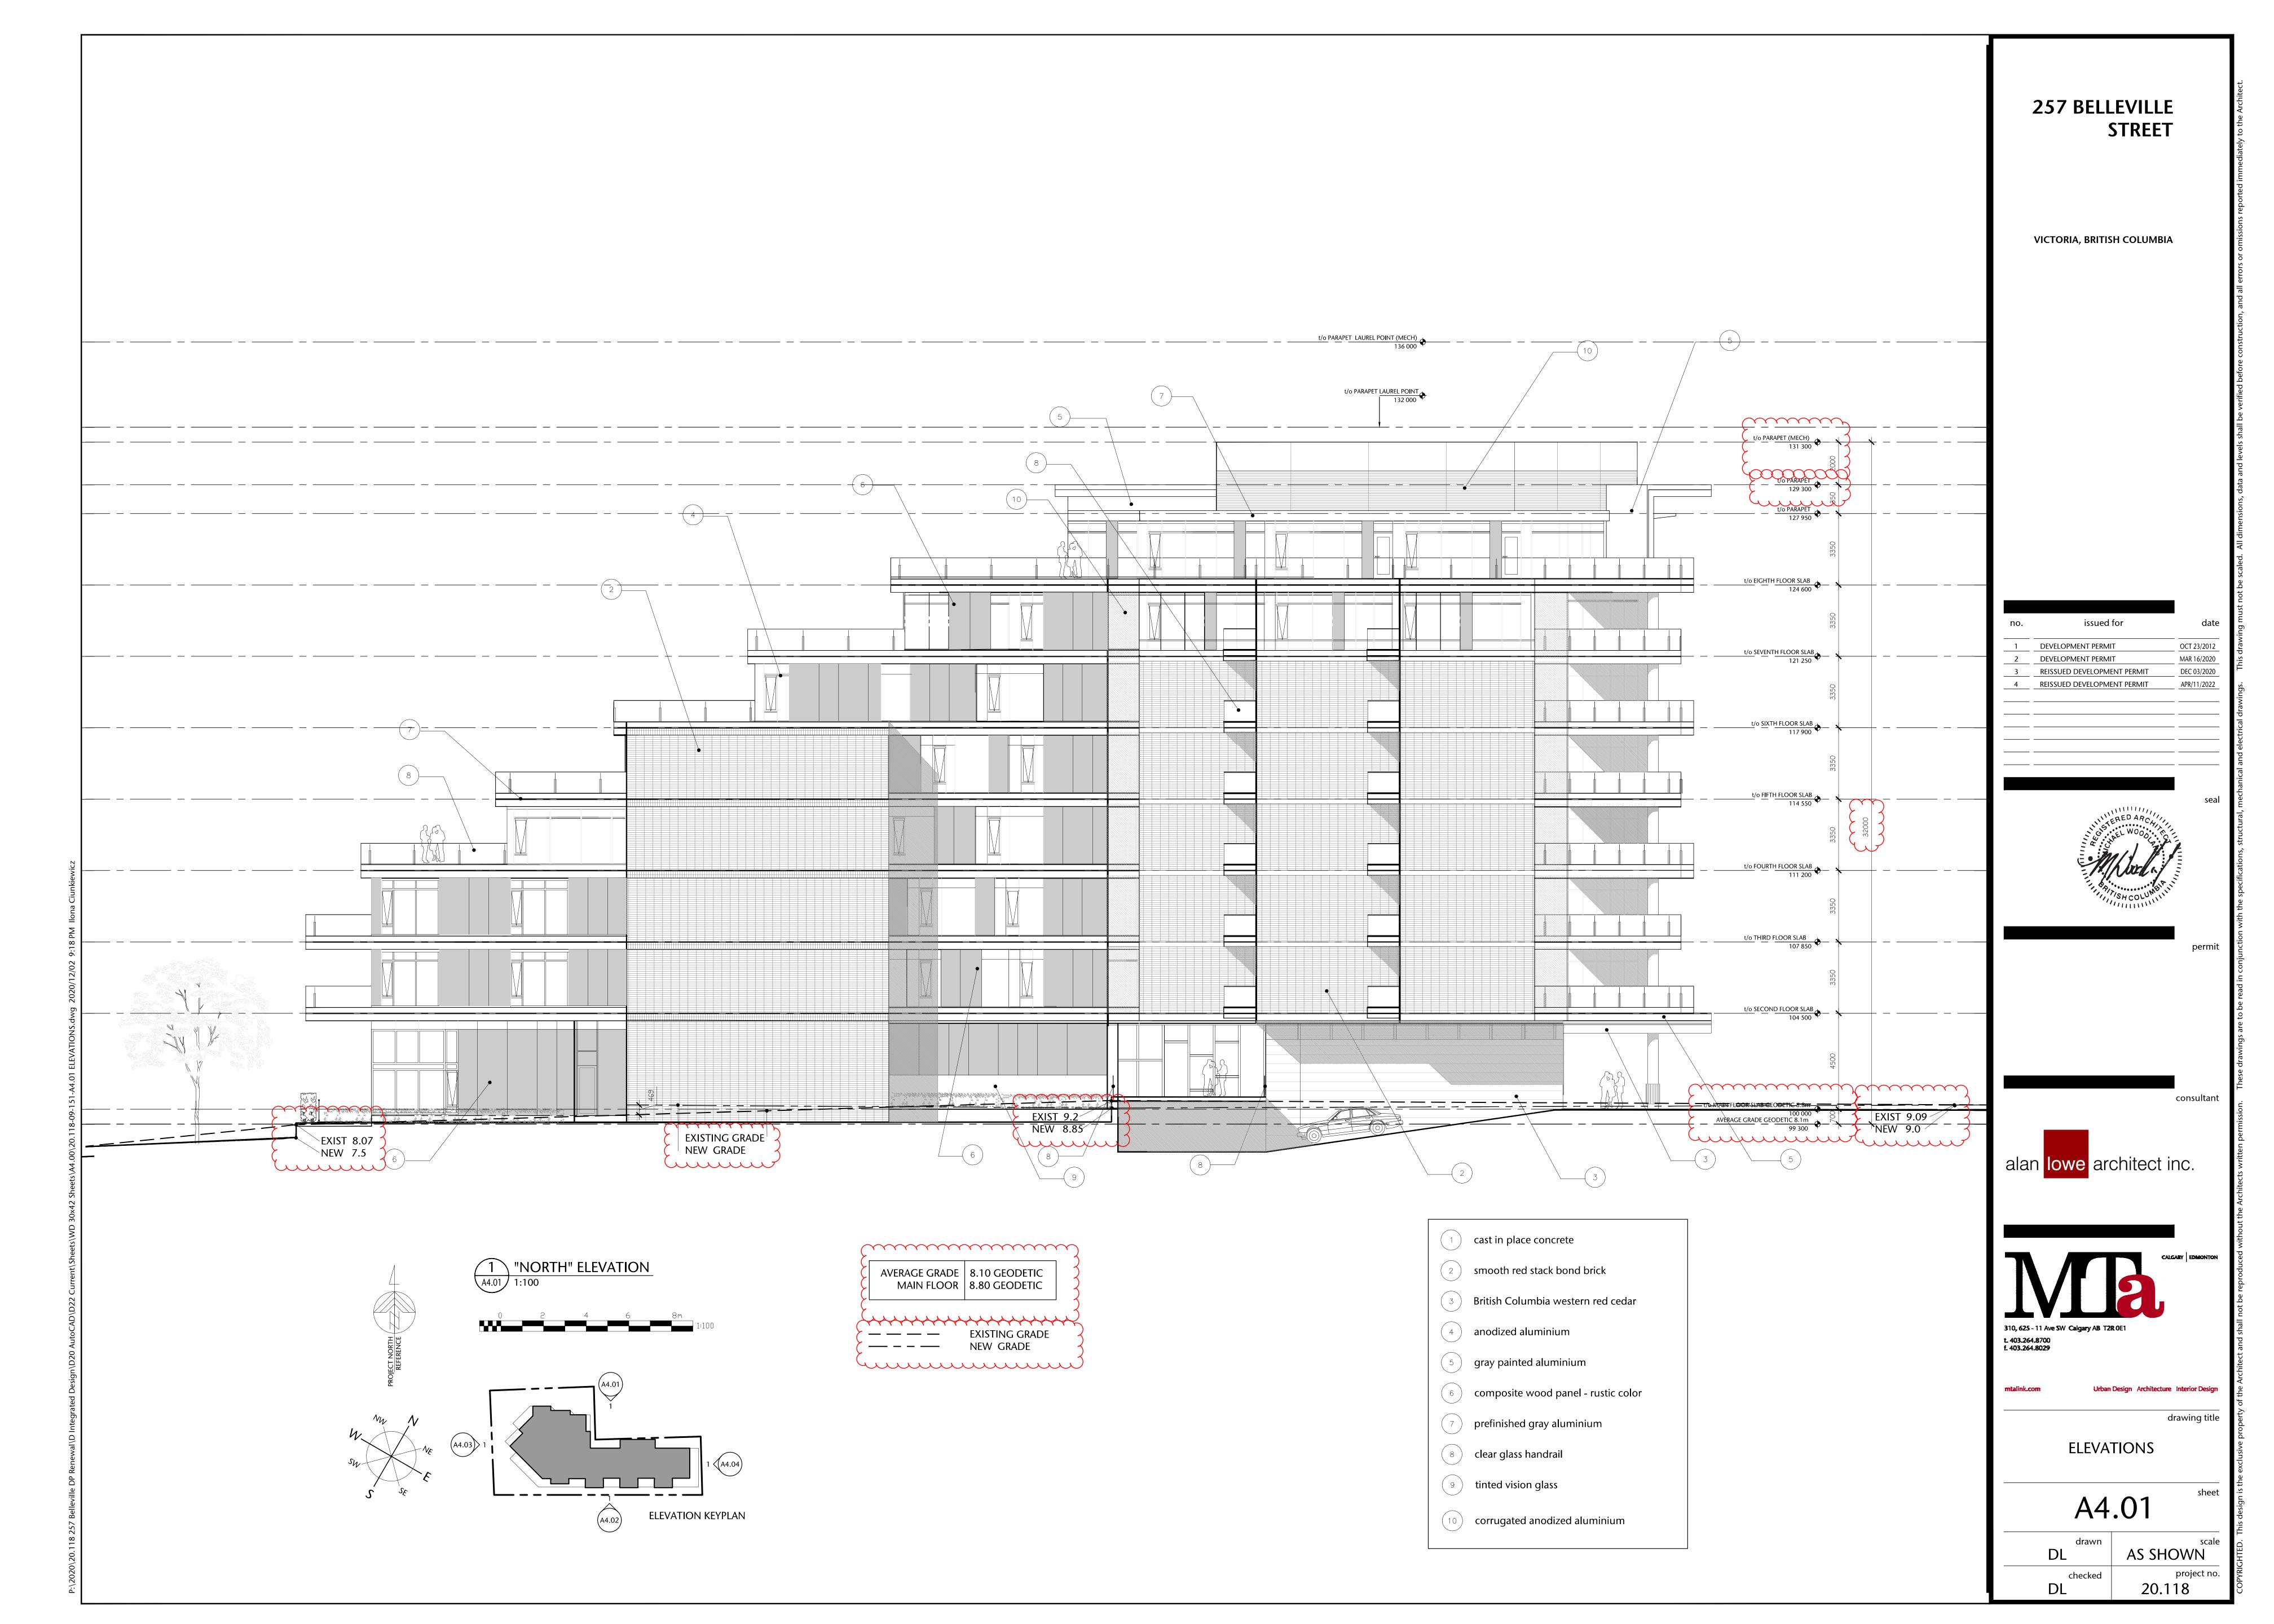

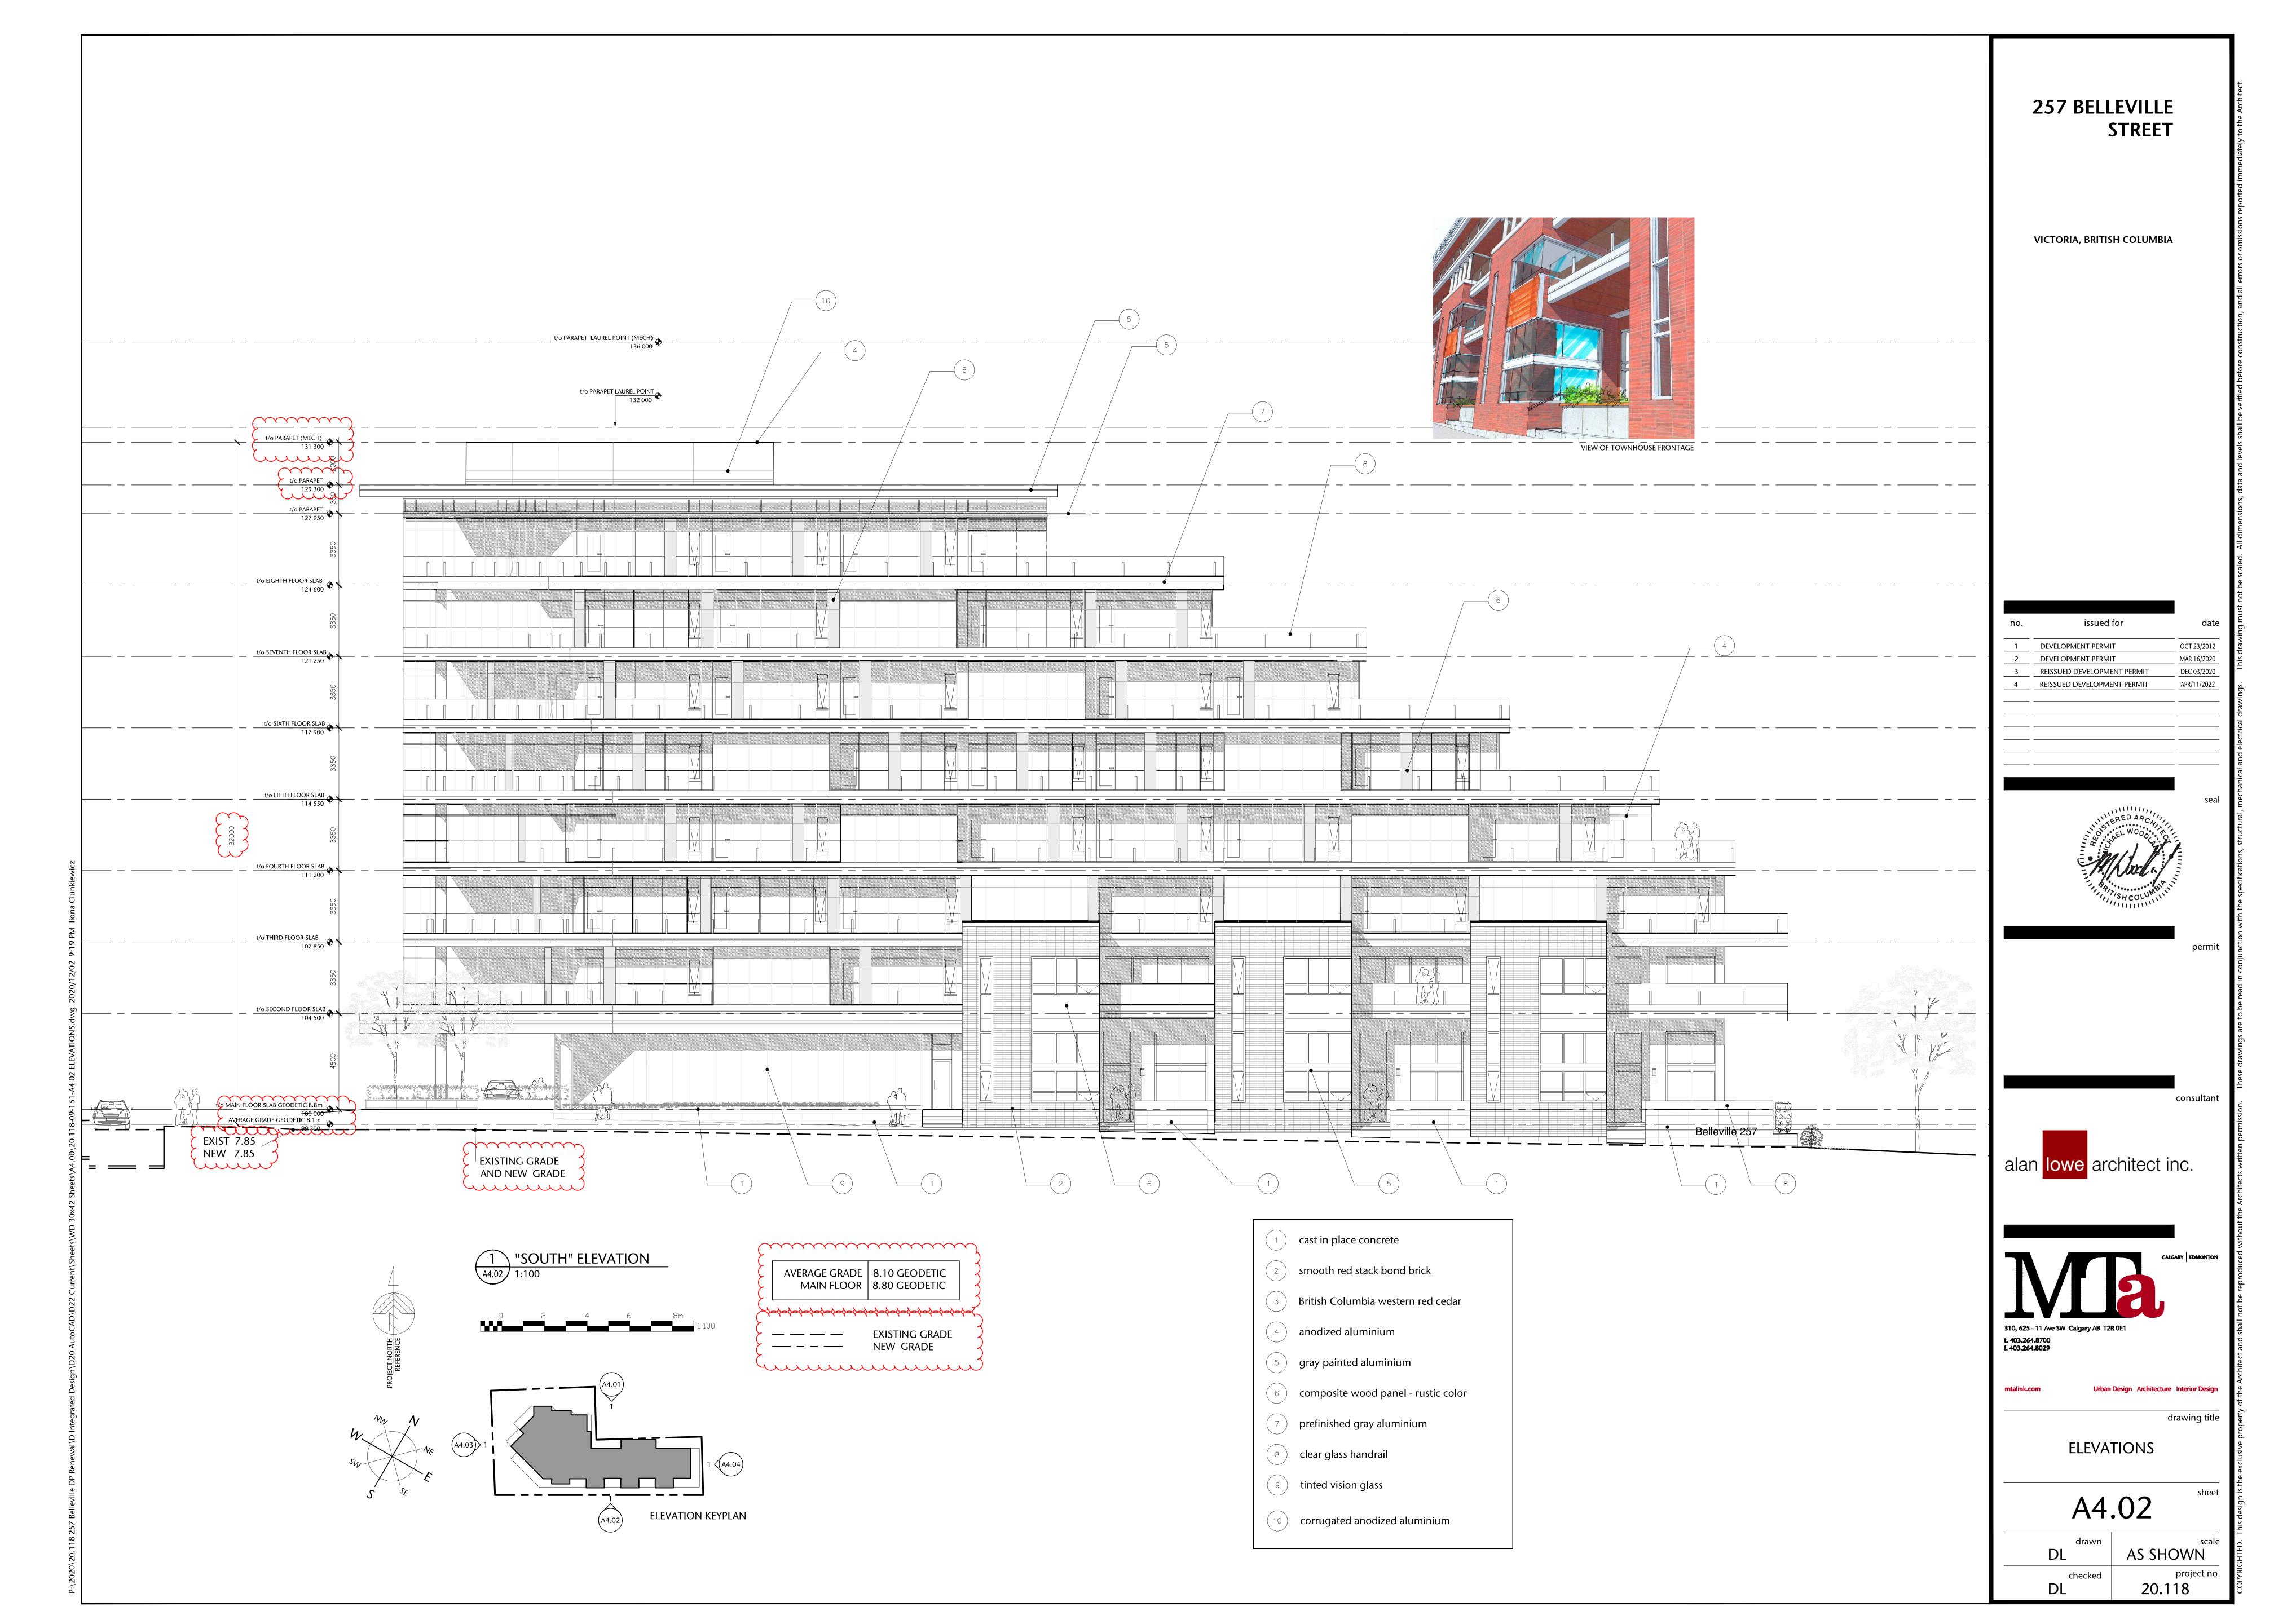

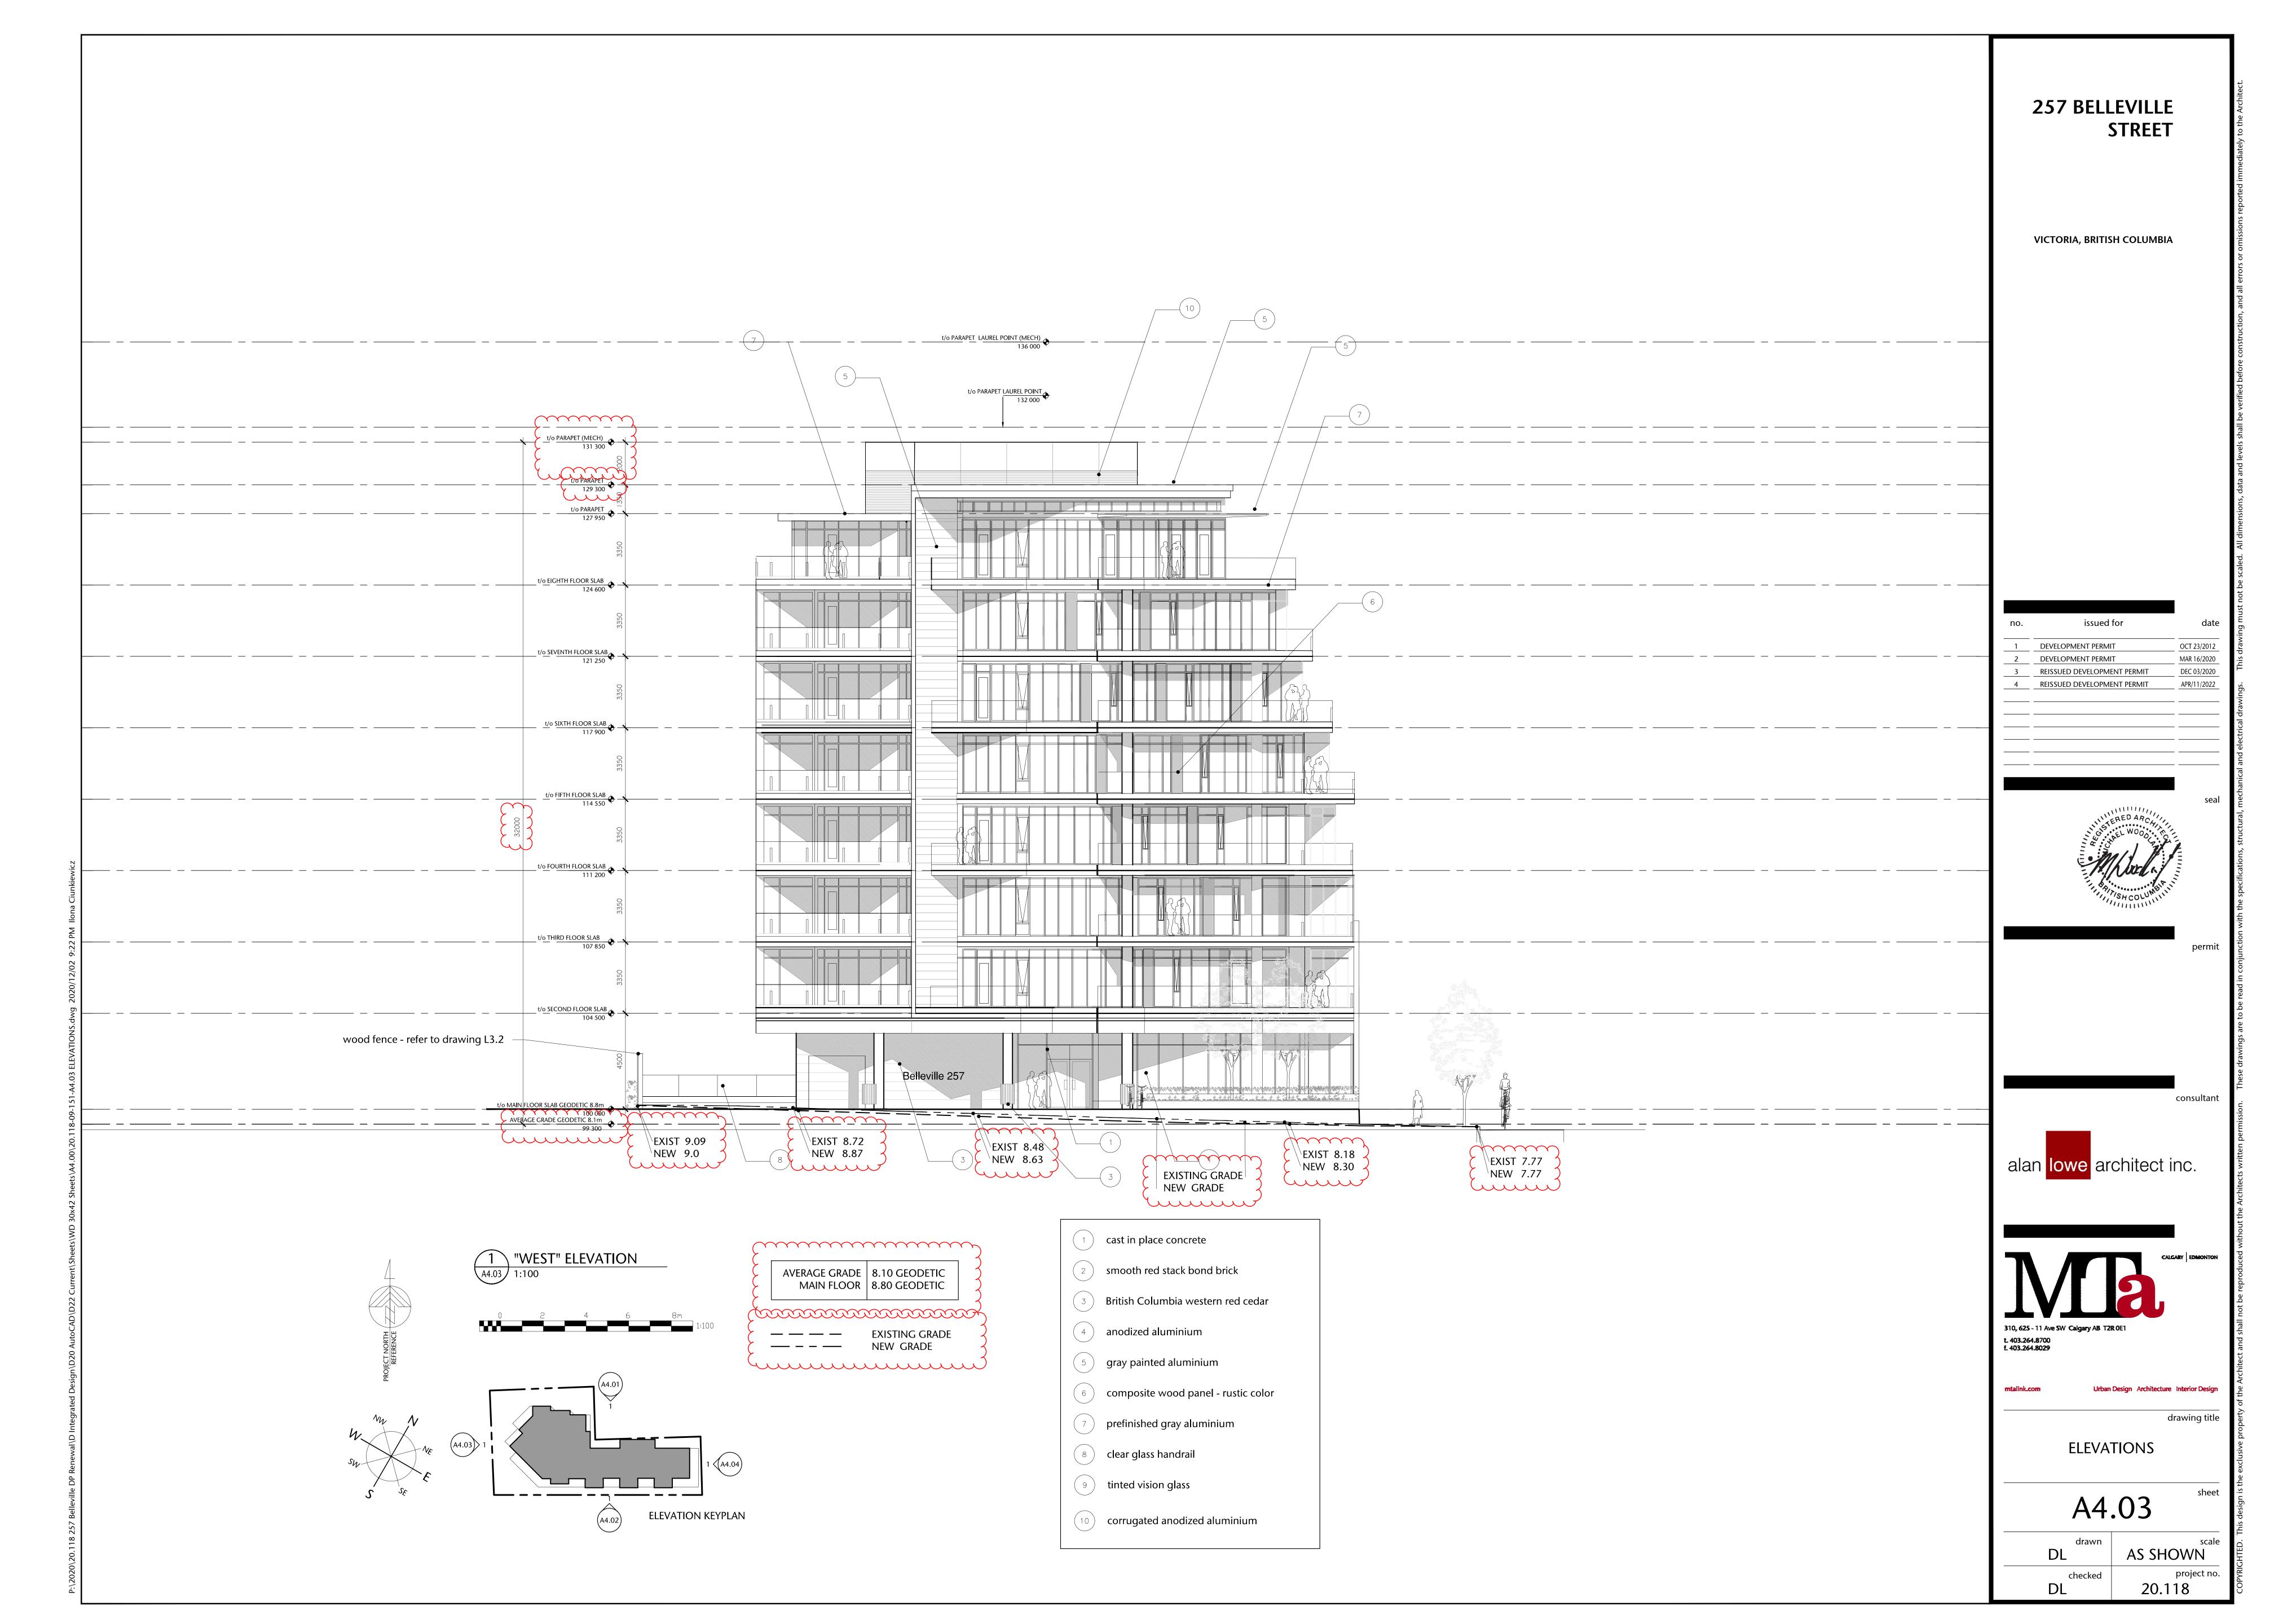

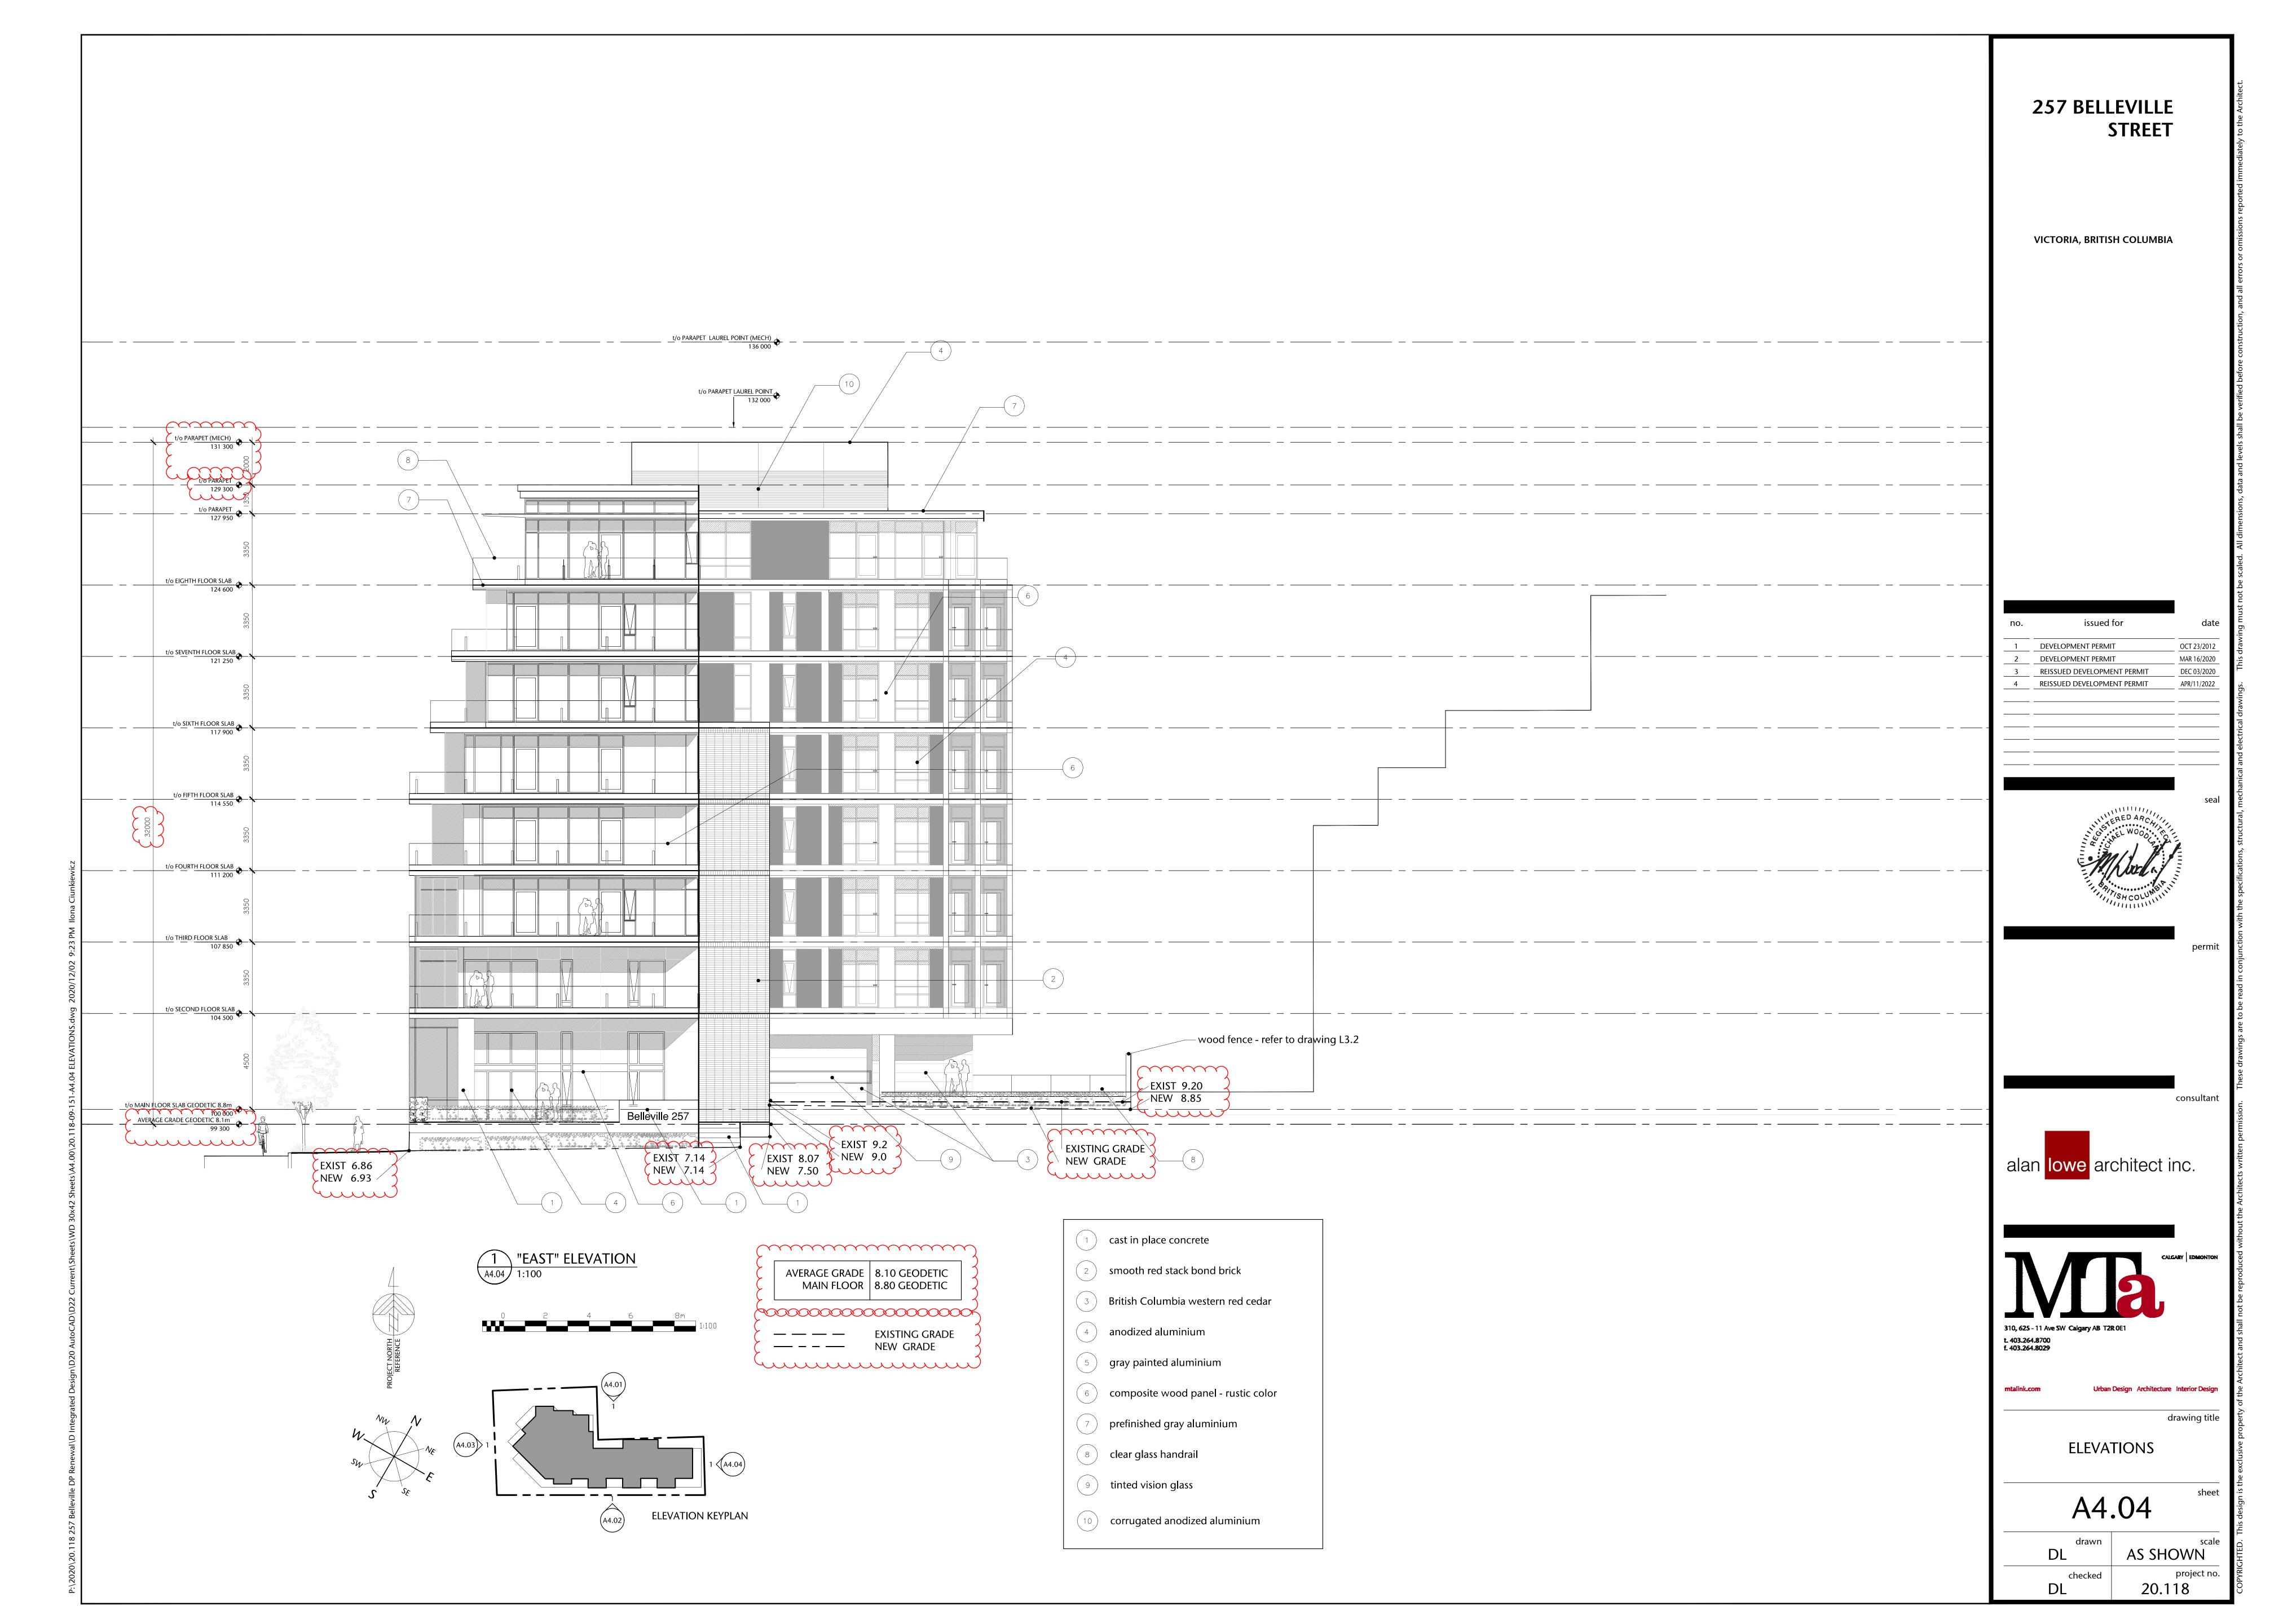


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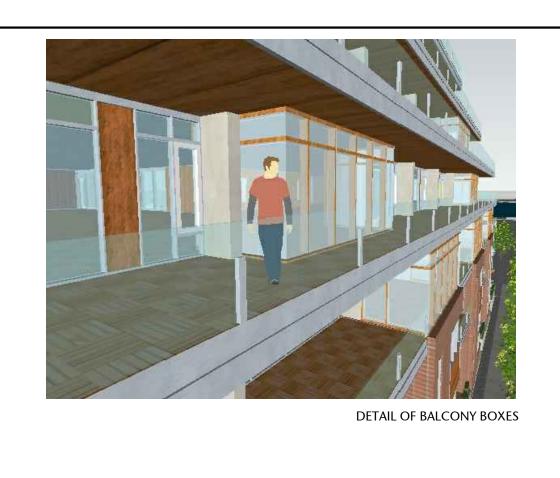





STREETSCAPE ELEVATIONS

AS SHOWN



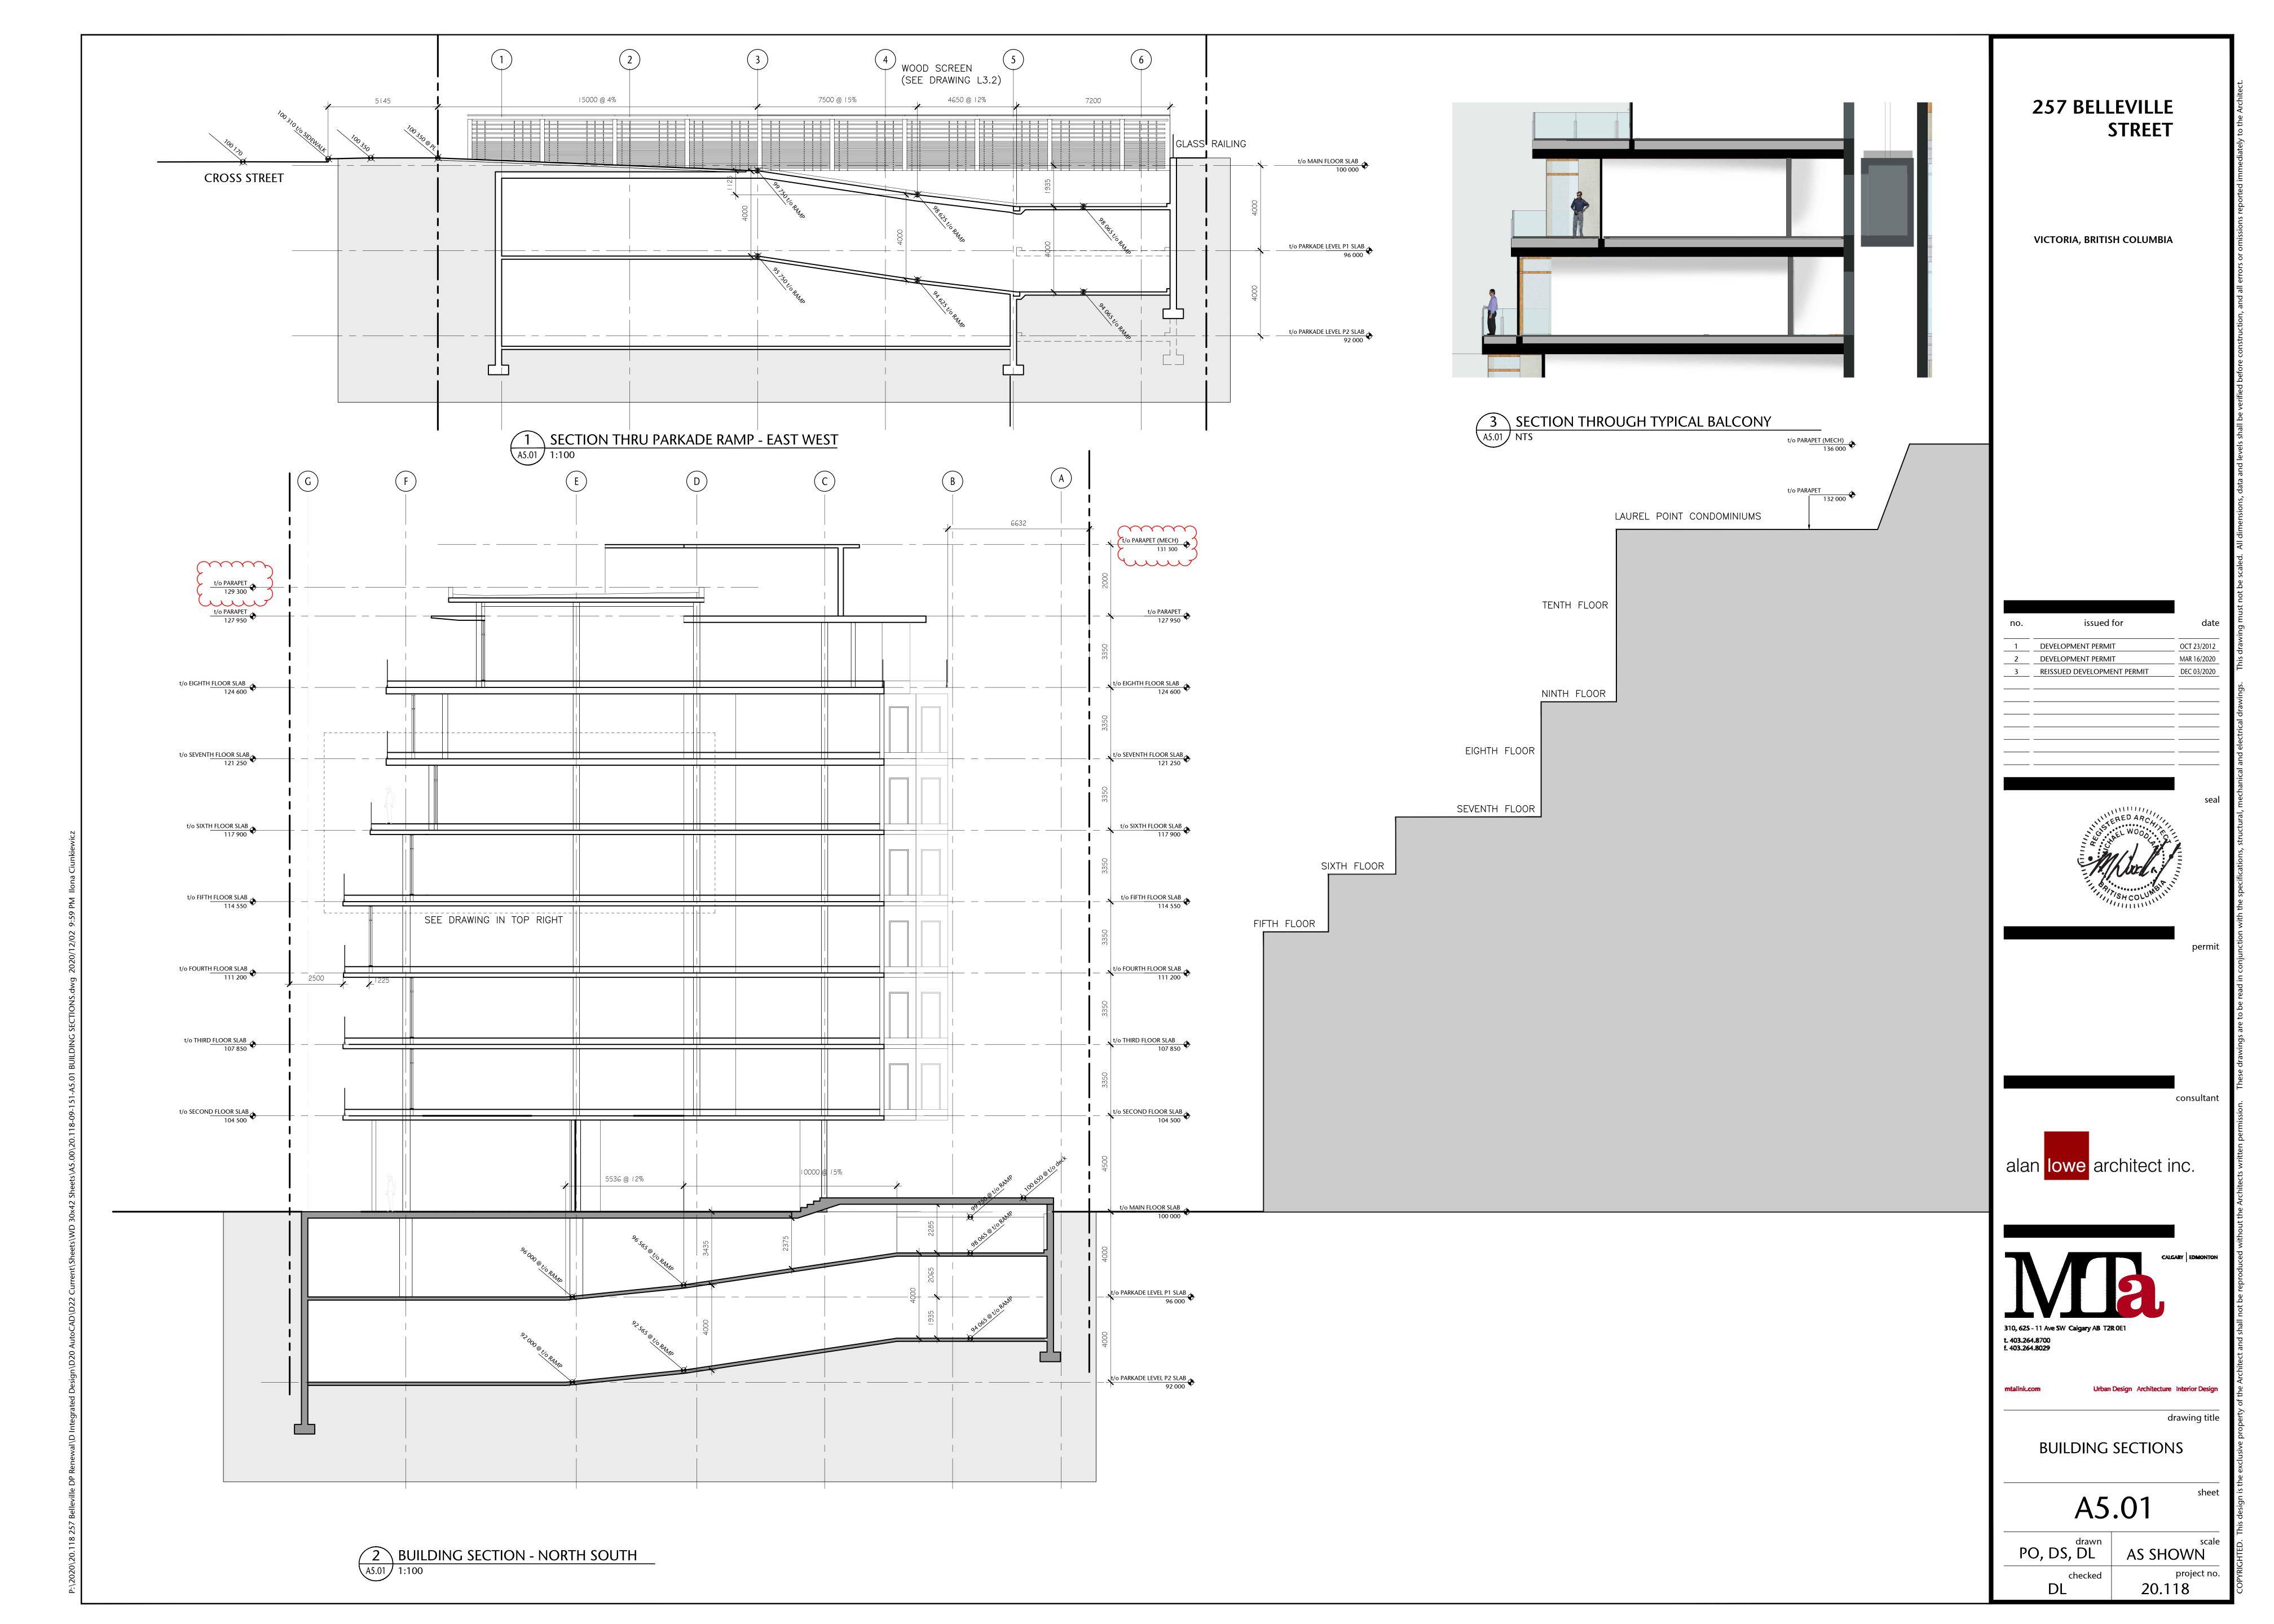


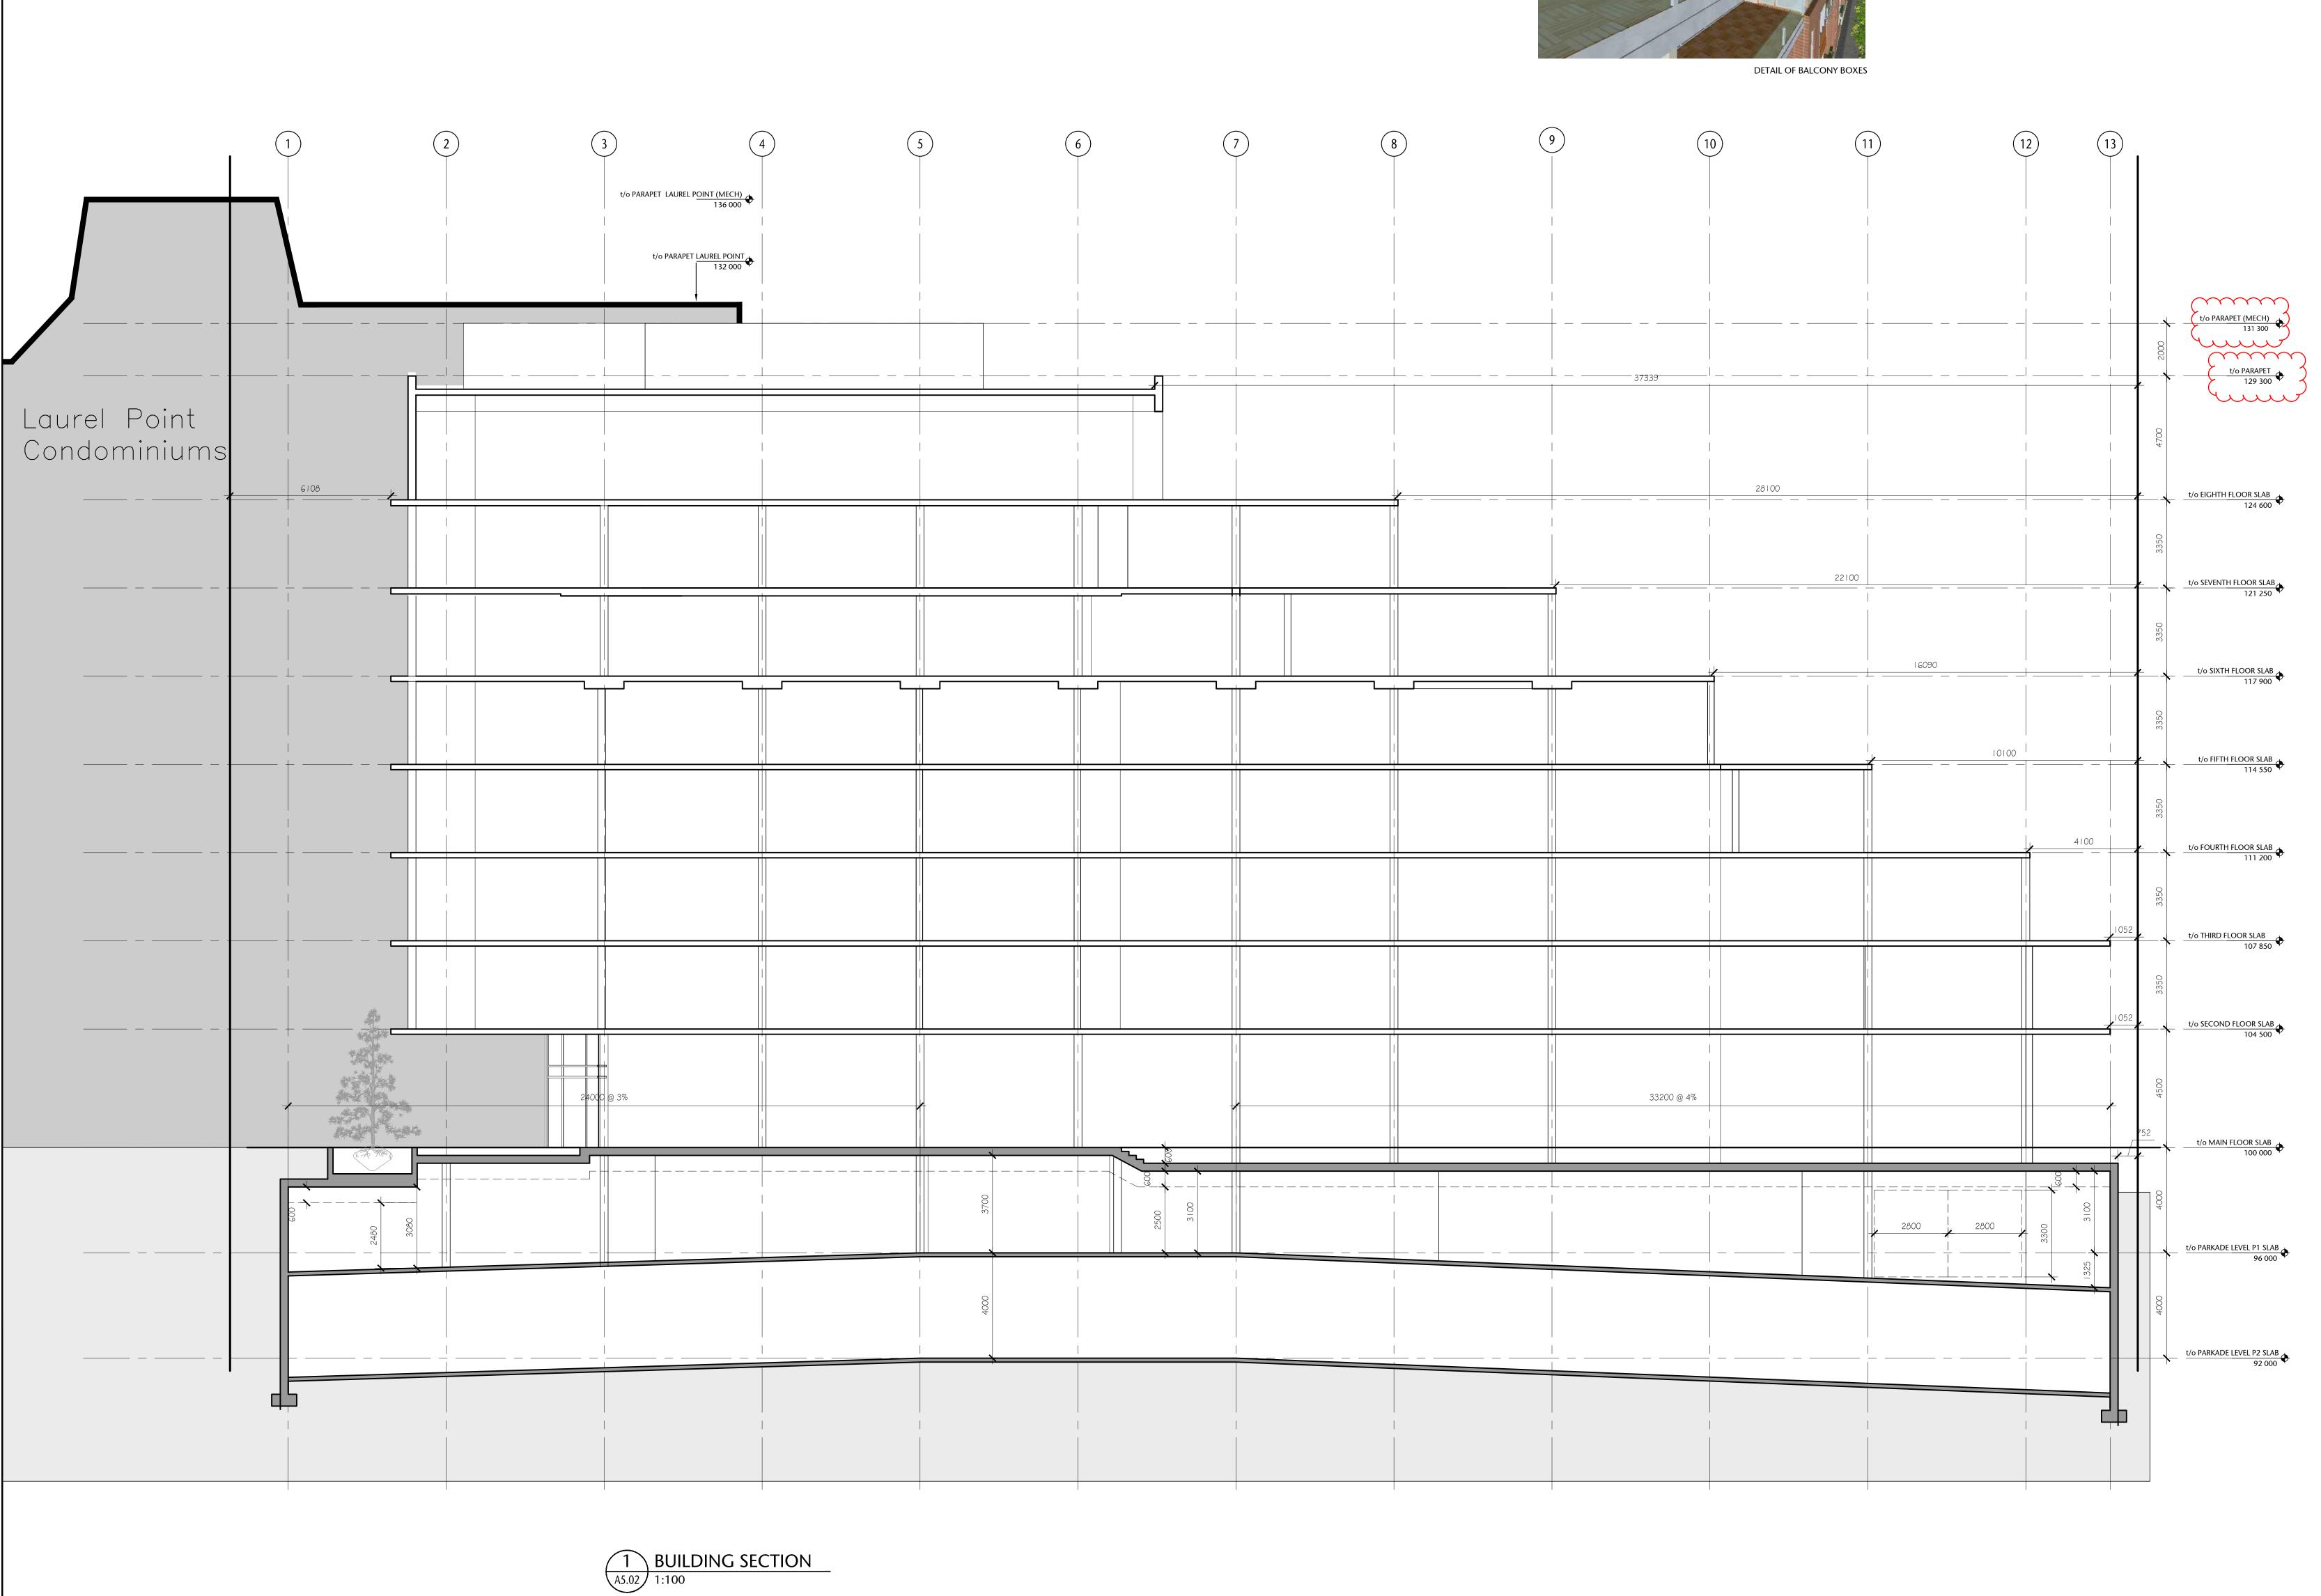



VICTORIA, BRITISH COLUMBIA

no.	issued for	date
1	DEVELOPMENT PERMIT	OCT 23/2012
2	DEVELOPMENT PERMIT	MAR 16/2020
3	REISSUED DEVELOPMENT PERMIT	DEC 03/2020
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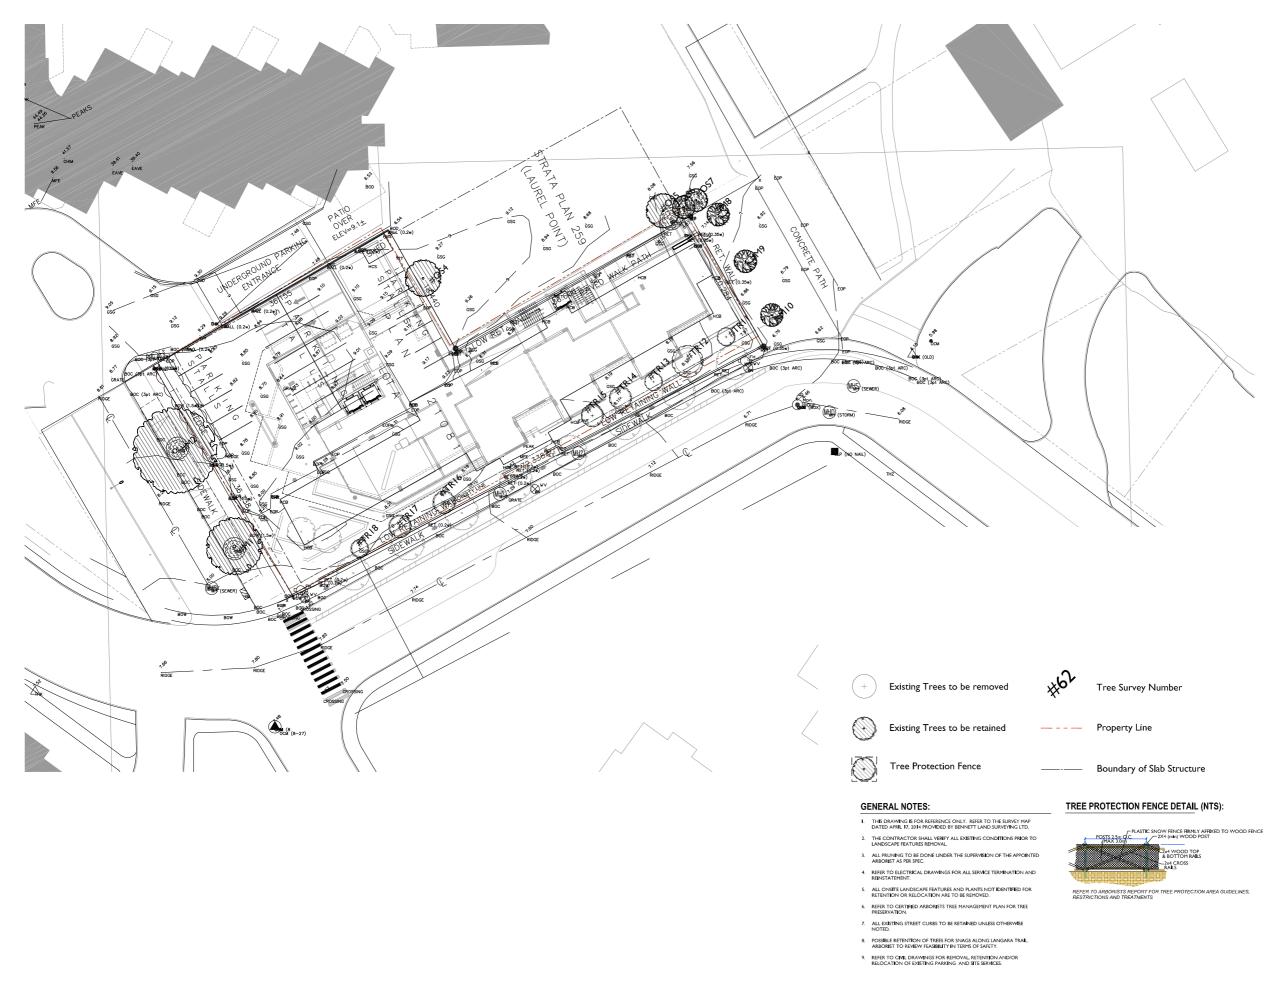
alan lowe architect inc.

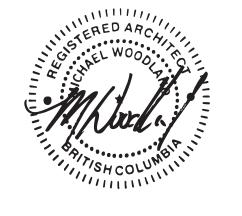


drawing title **BUILDING SECTIONS** 

A5.02

PO, DS, DL AS SHOWN scale



VICTORIA, BRITISH COLUMBIA.

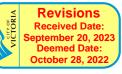

no.	issued for date
1 —	Development Permit Nov 15/10
	Revised Development Permit Feb 04/11
	Revised Development Permit Feb 16/11
	Revised Development Permit Apr 29/11
	Issued for Costing Nov 07/11
	Re-issued for Development Permit Dec 05/12
	Re-issued for Development Permit Nov 26/20
	Re-issued for Development PermitJune 03/21
	For Coordination July 30/21
	Re-issued for Development Permit Dec 06/21
	Re-issued for Development Permit Jul 10/23



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drawing

TREE MANAGEMENT PLAN

1:200


LO. I

checked

PROJECT NORTH

scale

heet scale

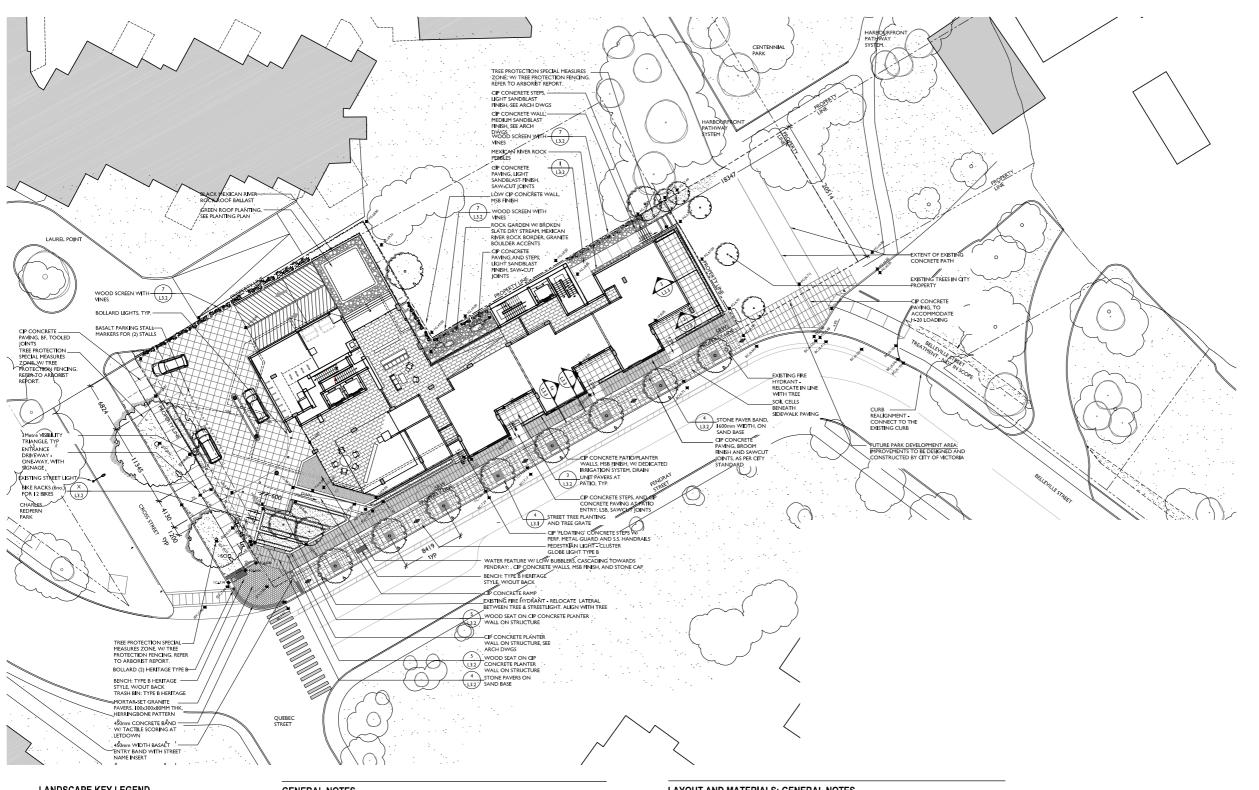

### LANDSCAPE KEY LEGEND

POOL BOTTOM WATER LEVEL TOP OF STA**I**R BOTTOM OF STAIL TOP OF WALL BOTTOM OF WALI TOP OF CURB

BOTTOM OF CURB AREA DRAIN PROPOSED SPOT ELEVATION (FINISHED GRADE)

PROPOSED TREE

EXISTING TREE TO BE REMOVED



PLANT SPECIES PLANT QUANTITY



DETAIL NUMBER SET SHEET NO.

SET SHEET NO.

### **GENERAL NOTES**

1. PROVIDE A DEQUATE SUB-SURFACE DRAINAGE IN ALL LAWN AND PLANTING AREAS.

2. SEE CMIL. AND ARCHITECTURAL DRAWINGS FOR GRADING.

3. ENSURE POSITIVE DRAINAGE.

4. STREETSCAPE TO APPROVIAL OF ENGINEERING SERVICES, ALL STREET TREES TO HAVE 8' WIDE 18' DEPTH 'DEEP ROOT ROOT BARRIER, OR RESAPPROVED EQUIVALENT, AT ALL SIDEWAIL LOCATIONS.

5. ALL STREET TREE SPECIES AND SPACING TO CONFORM TO CITY OF WICTORIA STANDARD SPACING AND CLEARANCE.

6. INALL TREE LOCATIONS TO BE DETERMINED TO THE SATISFACTION OF ENGINEERING SERVICES.

7. ANA AUTOMATIC IRRIGATION SYSTEM SHALL BE PROVIDED FOR ALL FANT MATERIAL, INCLUDING STREETLEVEL PLANTINGS AND GREEN ROOF PLANTINGS. HOSSEINS AND LEE PROVIDED IN ALL PRIVATE COUNTY AND AND PATIO AREAS RIGGATION SYSTEM DESIGN AND INSTALLATION SHALL BE IN ACCORDANCE WITH THE RRIGATION INDUSTRY OF BC STANDARDS AND GUIDELINES. SYSTEM DENOM AND INSTALLABORED STATEMENT OF GUIDELINES.

8. ALL PLANT MATERIAL TO BCLNA AND BCSLA STANDARDS.

9. ROOT BARRIERS TO BE 'DEEP ROOT', 'ROOT SOLUTIONS' OR EQUAL

### IRRIGATION: GENERAL NOTES

I. ALL LANDSCAPE BRIGATION SHALL CONFORM TO IABC STANDARDS.
2. LANDSCAPE DRIPLINE SHALL BE LOOPED UNLESS OTHERWISE SPECIFIED.
3. ALL BRIGATION WORK SHALL BE DONE BY A SUITBAIL PERPERIENCED AND QUALIFIED BRIGATION CONTRACTOR
ADEQUATE FOR THE SCOPE OF WORK. THE CONTRACTOR SHALL BE A MEMBER IN GOOD STANDING OF THE BRIGATION
INDUSTRY ASSOCIATION OF BC. AND HAVE MET THE QUALIFICATION STANDARDS CURRENTLY APPLIED TO
CONTRACTORS BY THAT ORGANIZATION.
4. UNLESS OTHERWISE SPECIFIED OR INDICATED ON THE DRAWMINGS, ALL LANDSCAPE BRIGATION EQUIPMENT SHALL BE
SUPPLIED BY A SINGLE MANUFACTURER. ANY SUBSTITUTIONS WITHOUT THE PRIOR APPROVAL OF THE CONSULTANT WILL BE
REIECTED.

### LAYOUT AND MATERIALS: GENERAL NOTES

I. DO NOT SCALE DRAWINGS. LAYOUT AS PER DIMENSIONS NOTED ON LANDSCAPE PLANS. REPORT ANY DISCREPANCIES TO THE CONSULTANT FOR REVIEW AND RESPONSE. L LAYOUT, AND MATERIALS DRAWINGS ARE TO BE READ IN CONJUNCTION WITH LANDSCAPE SPECIFICATIONS FOR

Z LATOUT AND MATERIALD DRAWINGS ARE TO BE READ IN CONJUNCTION WITH LANDSCAPE SPECIFICATIONS FOR COMPLIANCE. 3. LANDSCAPE DRAWINGS ARE TO BE READ IN CONJUNCTION WITH ARCHITECTURAL AND ENGINEERING DRAWINGS, REPORT ANY DISCREPANCIES TO THE CONSULTANT FOR REVIEW AND RESPONSE. 4. VERIET ALL DIMENSIONS WITH FIELD CONDITIONS, REPORT ANY DISCREPANCIES TO THE CONSULTANT FOR REVIEW AND

4. VEREY ALL DIMENSIONS WITH HELD CONDITIONS, REPORT AND DELETANCES TO THE CONSCIENT FOR NATIONAL REPORTS.

5. LIGHTING INFORMATION REFERENCED ON LANDSCAPE DRAWINGS IS TO BE READ IN CONJUNCTION WITH ELECTRICAL ENGINEERS DRAWINGS, REPORT ANY DISCREPANCIES TO THE CONSULTANT FOR REVIEW AND RESPONSE.

6. CHITCH ON DIGHTING ARE INDICATED FOR REFERENCE ONLY, REFER TO ENG. DRAWINGS FOR LOCATIONS, DETAILS, AND TO PROPER ONLY THE PROPERTY OF THE CONSULTANT FOR REPORTS.

7. REFERENCE ONLY, ENGINEERS DRAWINGS FOR LYOUT OF ROOAD CURBS AND CUTTERS AND PEDESTRAIN, LET-DOWNS.

8. REFER TO ENGINEERING DRAWINGS FOR DETAILS, SUBGRADE, AND REINFORCING OF ALL PAVED SURFACES IN ROADWAYS.

### **GRADING: GENERAL NOTES**

I. CONFIRM ALL EXISTING GRADES PRIOR TO CONSTRUCTION AND REPORT ANY DISCREPANCIES TO THE CONSULTANT TEAM FOR REVIEW AND RESPONSE.

2. UNIESS OTHERWISE NOTED, ALL DRAINS LOCATED IN LAWN OR PLANTED AREA ARE TO BE COMPLETE WITH INSPECTION

CHAMBER SANGE ISANGUET.

CHAMBER AND CLEANOUT.

3. PROVIDE POSTITE DRAINAGE THROUGHOUT - AWAY FROM BUILDINGS AND TO DRAINAGE STRUCTURES, UNLESS OTHERWISE NOTED, PROVIDE A MINIMUM SLOPE OF 28: ON ALL HARD AND SOFT LANDSACPE SURFACES.

4. UNLESS OTHERWISE NOTED PROVIDE A MAXIMUM SLOPE OF 41 (25%) AT ALL SOFT LANDSCAPE AREAS. REPORT ANY DISCRETANGES TO THE CONSULTANT TEAM FOR REMEW AND RESPONSE.

5. ALL GRADING INFORMATION TO BE COORDINATED WITH ARCHITECTURAL DRAWINGS TO ENSURE ADEQUATE SOIL DEPTHS AND POSTITUE DRAINAGE.

257 BELLEVILLE STREET

VICTORIA. BRITISH COLUMBIA.

issued for Revised Development Permit Feb 04/1
Revised Development Permit Feb 16/1 Revised Development Permit Apr 29/1
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Re-issued for Development Permit Dec 05/12 Re-issued for Development Permit Nov 26/2 Re-issued for Development PermitJune 03/2 For Coordination July 30/2
Re-issued for Development Permit Dec 06/2 Re-issued for Development Permit Jul 10/2

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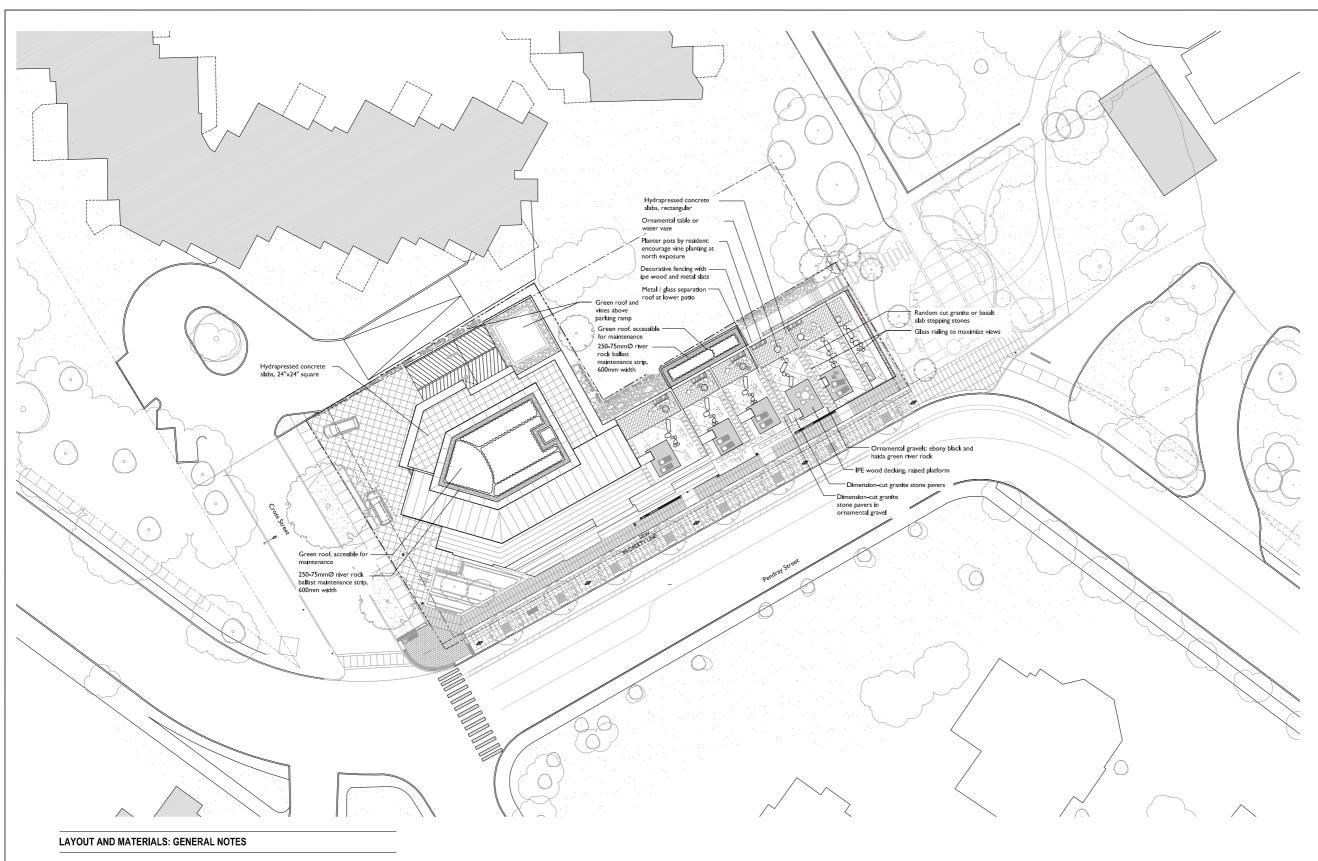
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LANDSCAPE PLAN -**GROUND FLOOR** 

checked

1:200

1 PROIECT



I. DO NOT SCALE DRAWINGS. LAYOUT AS PER DIMENSIONS NOTED ON LANDSCAPE PLANS. REPORT ANY DISCREPANCIES TO THE CONSULTANT FOR REVIEW AND RESPONSE.

2. LAYOUT AND MATERIALS DRAWINGS ARE TO BE READ IN CONJUNCTION WITH LANDSCAPE SPECIFICATIONS FOR COMPRIANCE.

3. LANDSCAPE DRAWINGS ARE TO BE READ IN CONJUNCTION WITH ARCHTECTURAL AND ENGINEERING DRAWINGS. REPORT ANY DISCREPANCIES TO THE CONSULTANT FOR REVIEW AND RESPONSE.

4. YEBRIY ALL DIMENSIONS WITH HELD CONDITIONS. REPORT ANY DISCREPANCIES TO THE CONSULTANT FOR REVIEW AND RESPONSE.

5. LIGHTING INFORMATION REFERENCED ON LANDSCAPE DRAWINGS IS TO BE READ IN CONJUNCTION WITH ELECTRICAL ENGINEERS DRAWINGS. REPORT ANY DISCREPANCIES TO THE CONSULTANT FOR REVIEW AND RESPONSE.

6. UTILITY AND LIGHTING ARE INDICATED FOR REFERENCE ONLY, REFER TO ENG. DRAWINGS FOR LOCATIONS, DETAILS, AND SPECIFICATIONS.

7. REFERENCE CIMIL ENGINEERS DRAWINGS FOR LAYOUT OF ROAD CURBS AND GUTTERS AND PEDESTRAIN LET-DOWNS.

8. REFER TO ENGINEERING DRAWINGS FOR DETAILS, SUBGRADE, AND RENFORCING OF ALL PAYED SURFACES IN ROADWAYS.

### IRRIGATION: GENERAL NOTES

I. ALL LANDSCAPE BRIGATION SHALL CONFORM TO IABC STANDARDS.

2. LANDSCAPE DRIPLINE SHALL BE LOOPED UNLESS OTHERWISE SPECIFIED.

3. ALL BRIGATION WORK SHALL BE DONE BY A SUITABLY EXPERIENCED AND QUALIFIED REGATION CONTRACTOR ADEQUATE FOR THE SCOPE OF WORK. THE CONTRACTOR SHALL BE A MEMBER IN GOOD STANDING OF THE IRRIGATION INDUSTRY ASSOCIATION OF B.C. AND HAVE MET THE QUALIFICATION STANDARDS CURRENTLY APPLIED TO CONTRACTORS BY THAT ORGANIZATION.

4. UNLESS OTHERWISE SPECIFIED OR INDICATED ON THE DRAWNINGS, ALL LANDSCAPE BRIGATION EQUIPMENT SHALL BE SUPPLED BY A SINGLE MANUFACTURER. ANY SUBSTITUTIONS WITHOUT THE PRIOR APPROVAL OF THE CONSULTANT WILL BE SEIGHTED.

REJECTED.
5. GREEN ROOF PLANTING IS TO BE FULLY IRRIGATED.



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VICTORIA, BRITISH COLUMBIA.

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Re-issued for Development Permit Dec 06/2 pment Permit Jul 10/2

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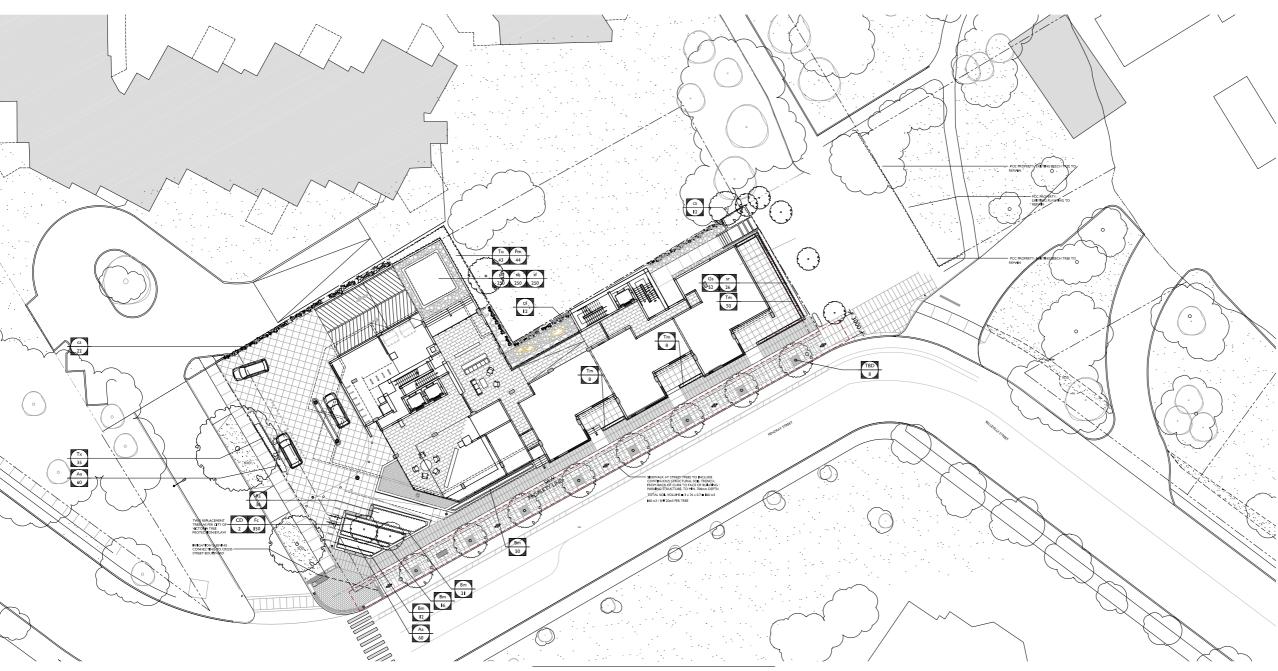
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LANDSCAPE PLAN -**ROOF LEVELS** 

MD 1:200 08005 project no. checked



SET 26 SMILACINA RACEMOSA  SITE 26 SMILACINA RACEMOSA  FALSE SOLOMON'S SEAL  FASS J SEDUM ACRE  SECURI SECURIA SECURIALIS SEDUM ACRE  FASS SEDUM SPECTABILE 'BRILLIANT'  FOR ASSON SEDUM SPECTABILE 'BRILLIANT'  FOR ASSON SEAL STRAWBERRY  #1 POT 300mm O.C.  430 POT 450mm O.C.  440 POLYSTICHUM MINUTUM  FLOWERING CURRANT  #2 POT 500mm O.C.  50	PLAN	ANT SCHEDULE				
TBD 8 BOULEVARD TREE SPECIES TO BE DETERMINED AT BUILDING PERMIT STAGE MEDIUM  CD 2 CRATAEGUS DOUGLASII BLACK HAWTHORN 7 CM CAL MATCHING, FULL  SHRUBS / GROUNDCOVERS  A 120 ARCTOSTAPHYLOS UVA-JURSI KINNIKINNICK #2 POT 450mm O.C.  BM 99 BUXUS MICROPHYLLA GREEN BEAUTY GREEN BEAUTY LITTLE LEAF BUXUS #3 POT 450mm O.C.  CF 150 FRAGARIA CHILOENSIS COASTAL STRAWBERRY #1 POT 300mm O.C.  CG 52 GAULTHERIA SHALLON SALAL #2 POT 300mm O.C.  CM 44 POLYSTICHUM MINUTUM WESTERN SWORD FERN #2 POT 500mm O.C.  CM 46 POLYSTICHUM MINUTUM FLOWERING CURRANT #3 POT 600mm O.C.  CM 100 TAXUS MEDIA HICKSII, MAL HICKS YEW #5 POTS 380mm O.C., MALE  TAX 35 TAXUS MEDIA HICKSII, MAL HICKS YEW #2" HT., FIELD GROWN, FULL 500mm O.C.  GRASS / PERENNIALS  FALSE SOLOMON'S SEAL #2 POTS 450mm O.C.  CLIMBERS  CA 46 CLEMATIS ARMANDII EVERGREEN CLEMATIS 1200 O.C.  CLIMBERS  CA 55 SEDUM SPECTABILE 'BRILLIANT' 100" O.C.  CLIMBERS  CA 2450 SEDUM SPECTABILE 'BRILLIANT' 100" O.C.	KEY	QTY	BOTANICAL NAME	COMMON NAME	SIZE	DESCRIPTION
SHRUBS / GROUNDCOVERS  ABA 120 ARCTOSTAPHYLOS UVA-URSI KINNIKINNICK #2 POT 450mm O.C.  ABA 120 ARCTOSTAPHYLOS UVA-URSI KINNIKINNICK #2 POT 450mm O.C.  ABA 120 ARCTOSTAPHYLOS UVA-URSI KINNIKINNICK #2 POT 450mm O.C.  ABA 120 ARCTOSTAPHYLOS UVA-URSI KINNIKINNICK #2 POT 450mm O.C.  ABA 120 ARCTOSTAPHYLOS UVA-URSI KINNIKINNICK #2 POT 450mm O.C.  ABA 120 ARCTOSTAPHYLOS UVA-URSI KINNIKINNICK #2 POT 450mm O.C.  ABA 120 ARCTOSTAPHYLOS UVA-URSI KINNIKINNICK #2 POT 300mm O.C.  ABA 120 ARCTOSTAPHYLOS UVA-URSI KINNIKI	TREE	s				
SHRUBS / GROUNDCOVERS  Aa 120 ARCTOSTAPHYLOS UVA-URSI KINNIKINNICK #2 POT 450mm O.C.  Am 99 BUXUS MICROPHYLLA GREEN BEAUTY GREEN BEAUTY LITTLE LEAF BUXUS #3 POT 450mm O.C.  CC 150 FRAGARIA CHILOENSIS COASTAL STRAWBERRY #1 POT 300mm O.C.  AS 52 GAULTHERIA SHALLON SALAL #2 POT 300mm O.C.  AND 44 POLYSTICHUM MINUTUM WESTERN SWORD FERN #2 POT 500mm O.C.  AS 36 RIBES SANGUINEUM FLOWERING CURRANT #3 POT 600mm O.C.  AS 36 RIBES SANGUINEUM FLOWERING CURRANT #3 POT 600mm O.C.  AND 100 TAXUS MEDIA HICKSII, MAL HICKS YEW #5 POTS 380mm O.C., MALE  AND 35 TAXUS MEDIA HICKSII, MAL HICKS YEW 42" HT., FIELD GROWN, FULL 500mm O.C., MALE  AND 37 THUJA OCCIDENTALIS SMARAGD EMERALD GREEN CEDAR 2.5M HEIGHT 500mm O.C.  CLIMBERS  CC 26 SMILACINA RACEMOSA FALSE SOLOMON'S SEAL #2 POTS 450mm O.C.  CLIMBERS  CC 26 SMILACINA RACEMOSA FALSE SOLOMON'S SEAL #2 POTS 450mm O.C.  CLIMBERS  CC 26 SECUM ACRE  CC 27 SECUM ACRE  CC 28 SECUM ACRE  CC 28 SECUM SPECTABILE 'BRILLIANT'  10° O.C.	TBD	8 BOULEVARD TREE SPECIES TO BE DETERMINED AT BUILDING PERMIT STAGE MEDIUM				
AA 120 ARCTOSTAPHYLOS UVA-URSI KINNIKINNICK #2 POT 450mm O.C. 3m 99 BUXUS MICROPHYLLA GREEN BEAUTY GREEN BEAUTY LITTLE LEAF BUXUS #3 POT 450mm O.C. 5c 150 FRAGARIA CHILOENSIS COASTAL STRAWBERRY #1 POT 300mm O.C. 5c 52 GAULTHERIA SHALLON SALAL #2 POT 300mm O.C. 5c 54 GAULTHERIA SHALLON SALAL #2 POT 500mm O.C. 5c 55 52 GAULTHERIA SHALLON SALAL #2 POT 500mm O.C. 5c 56 52 GAULTHERIA SHALLON SALAL #2 POT 500mm O.C. 5c 55 52 GAULTHERIA SHALLON SALAL #2 POT 500mm O.C. 5c 65 52 GAULTHERIA SHALLON SALAL #2 POT 500mm O.C. 5c 66 S 53 TAXUS MEDIA HICKSII, MAL HICKS YEW #3 POT 600mm O.C. 5c 66 STALL	CD	2	CRATAEGUS DOUGLASII	BLACK HAWTHORN	7 CM CAL	MATCHING, FULL
SITE OF SECULA SECULAR	SHRU	JBS / G	ROUNDCOVERS			
COASTAL STRAWBERRY #I POT 300mm O.C.  GS 52 GAULTHERIA SHALLON SALAL #2 POT 300mm O.C.  GS 52 GAULTHERIA SHALLON SALAL #2 POT 300mm O.C.  GS 53 GAULTHERIA SHALLON SALAL #2 POT 500mm O.C.  GS 64 RIBES SANGUINEUM FLOWERING CURRANT #3 POT 600mm O.C.  TIM 100 TAXUS MEDIA HICKSII, MAL HICKS YEW #5 POTS 380mm O.C., MALE  TX 35 TAXUS MEDIA HICKSII, MAL HICKS YEW #2" HT., FIELD GROWN, FULL 500mm O.C., MALE  TO 43 THUJA OCCIDENTALIS SMARAGD EMERALD GREEN CEDAR 2.5M HEIGHT 500mm O.C.  GRASS / PERENNIALS  GRASS	Aa	120	ARCTOSTAPHYLOS UVA-URSI	KINNIKINNICK	#2 POT	450mm O.C.
SALAL #2 POT 300mm O.C. Pm 44 POLYSTICHUM MINUTUM WESTERN SWORD FERN #2 POT 500mm O.C. Rs 36 RIBES SANGUINEUM FLOWERING CURRANT #3 POT 600mm O.C. Rm 100 TAXUS MEDIA HICKSII, MAL HICKS YEW #5 POTS 380mm O.C., MALE TX 35 TAXUS MEDIA HICKSII, MAL HICKS YEW #5 POTS 380mm O.C., MALE TX 36 TAXUS MEDIA HICKSII, MAL HICKS YEW 42" HT., FIELD GROWN, FULL 500mm O.C., MALE TX 37 THUJA OCCIDENTALIS SMARAGD EMERALD GREEN CEDAR 2.5M HEIGHT 500mm O.C.  SRASS / PERENNIALS  TX 26 SMILACINA RACEMOSA FALSE SOLOMON'S SEAL #2 POTS 450mm O.C.  CLIMBERS TX 26 SCHMATIS ARMANDII EVERGREEN CLEMATIS 1200 O.C.  GREEN ROOF TX 30 SEDUM SPECTABILE 'BRILLIANT' 10" O.C.	Bm	99	BUXUS MICROPHYLLA GREEN BEAUTY	GREEN BEAUTY LITTLE LEAF BUXUS	#3 POT	450mm O.C.
AND A POLYSTICHUM MINUTUM WESTERN SWORD FERN #2 POT 500mm O.C.  AS 36 RIBES SANGUINEUM FLOWERING CURRANT #3 POT 600mm O.C.  TIT 100 TAXUS MEDIA HICKSII, MAL HICKS YEW #5 POTS 380mm O.C., MALE  TX 35 TAXUS MEDIA HICKSII, MAL HICKS YEW 42" HT., FIELD GROWN, FULL, 500mm O.C., MALE  TX 36 TAXUS MEDIA HICKSII, MAL HICKS YEW 42" HT., FIELD GROWN, FULL, 500mm O.C., MALE  TX 26 SMILACINA RACEMOSA FALSE SOLOMON'S SEAL #2 POTS 450mm O.C.  CLIMBERS  TX 26 SMILACINA RACEMOSA FALSE SOLOMON'S SEAL #2 POTS 450mm O.C.  CLIMBERS  TX 37 TAYLOR MEDIA HICKSII, MAL HICKS YEW 42" HT., FIELD GROWN, FULL, 500mm O.C.  CLIMBERS  TX 26 SMILACINA RACEMOSA FALSE SOLOMON'S SEAL #2 POTS 450mm O.C.  CLIMBERS  TX 26 SMILACINA RACEMOSA FALSE SOLOMON'S SEAL #2 POTS 450mm O.C.  CLIMBERS  TX 37 TAYLOR MEDIA HICKSII, MAL HICKS YEW 42" HT., FIELD GROWN, FULL, 500mm O.C.  CLIMBERS  TX 26 SMILACINA RACEMOSA FALSE SOLOMON'S SEAL #2 POTS 450mm O.C.  CLIMBERS  TX 26 SMILACINA RACEMOSA FALSE SOLOMON'S SEAL #2 POTS 450mm O.C.  CLIMBERS  TX 26 SMILACINA RACEMOSA FALSE SOLOMON'S SEAL #2 POTS 450mm O.C.  CLIMBERS  TX 26 SMILACINA RACEMOSA FALSE SOLOMON'S SEAL #2 POTS 450mm O.C.  CLIMBERS  TX 26 SMILACINA RACEMOSA FALSE SOLOMON'S SEAL #2 POTS 450mm O.C.  CLIMBERS  TX 26 SMILACINA RACEMOSA FALSE SOLOMON'S SEAL #2 POTS 450mm O.C.  CLIMBERS  TX 26 SMILACINA RACEMOSA FALSE SOLOMON'S SEAL #2 POTS 450mm O.C.  CLIMBERS  TX 26 SMILACINA RACEMOSA FALSE SOLOMON'S SEAL #2 POTS 450mm O.C.  CLIMBERS TX 26 SMILACINA RACEMOSA FALSE SOLOMON'S SEAL #2 POTS 450mm O.C.  TX 27 SMILACINA RACEMOSA FALSE SOLOMON'S SEAL #2 POTS 450mm O.C.  CLIMBERS TX 27 SMILACINA RACEMOSA FALSE SOLOMON'S SEAL #2 POTS 450mm O.C.  TX 27 SMILACINA RACEMOSA FALSE SOLOMON'S SEAL #2 POTS 450mm O.C.  TX 27 SMILACINA RACEMOSA FALSE SOLOMON'S SEAL #2 POTS 450mm O.C.  TX 27 SMILACINA RACEMOSA FALSE SOLOMON'S SEAL #2 POTS 450mm O.C.  TX 28 SMILACINA RACEMOSA FALSE SOLOMON'S SEAL #2 POTS 500mm O.C.  TX 28 SMILACINA RACEMOSA FALSE SOLOMON'S SEAL #2 POTS 500mm O.C.  TX 29 SMILACINA RACEMOSA FALSE SOLOMON'S SEAL #	Fc	150	FRAGARIA CHILOENSIS	COASTAL STRAWBERRY	#I POT	300mm O.C.
RS 36 RIBES SANGUINEUM FLOWERING CURRANT #3 POT 600mm O.C. TIT 100 TAXUS MEDIA HICKSII, MAL HICKS YEW #5 POTS 380mm O.C., MALE TX 35 TAXUS MEDIA HICKSII, MAL HICKS YEW 42" HT., FIELD GROWN, FULL 500mm O.C., MALE TO 43 THUJA OCCIDENTALIS SMARAGD EMERALD GREEN CEDAR 2.5M HEIGHT 500mm O.C.  GRASS / PERENNIALS  TY 26 SMILACINA RACEMOSA FALSE SOLOMON'S SEAL #2 POTS 450mm O.C.  CLUMBERS  TRACE OF SECURIAR SAMANDII EVERGREEN CLEMATIS 1200 O.C.  GREEN ROOF  THE TAX SHARAGD TO SOLOMON'S SEAL #2 POTS 450mm O.C.  STATE OF SECURIAR SAMANDII EVERGREEN CLEMATIS 1200 O.C.  THE TAX SHARAGD TO SOLOMON'S SEAL #2 POTS 450mm O.C.  THE TAX SHARAGD TO SOLO	Gs	52	GAULTHERIA SHALLON	SALAL	#2 POT	300mm O.C.
TITI 100 TAXUS MEDIA HICKSII, MAL HICKS YEW #5 POTS 380mm O.C., MALE TIX 35 TAXUS MEDIA HICKSII, MAL HICKS YEW 42" HT., FIELD GROWN, FULL 500mm O.C., MALE TIX 35 TAXUS MEDIA HICKSII, MAL HICKS YEW 42" HT., FIELD GROWN, FULL 500mm O.C., MALE TO 43 THUJA OCCIDENTALIS SMARAGD EMERALD GREEN CEDAR 2.5M HEIGHT 500mm O.C.  GRASS / PERENNIALS  GRASS /	Pm	44	POLYSTICHUM MINUTUM	WESTERN SWORD FERN	#2 POT	500mm O.C.
TX       35       TAXUS MEDIA HICKSI, MAL       HICKS YEW       42" HT., FIELD GROWN, FULL, 500mm O.C., MALE         TO       43       THUJA OCCIDENTALIS SMARAGD       EMERALD GREEN CEDAR       2.5M HEIGHT       500mm O.C.         GRASS / PERENNIALS         ST       26       SMILACINA RACEMOSA       FALSE SOLOMON'S SEAL       #2 POTS       450mm O.C.         CLUMBERS         ST       24       CLEMATIS ARMANDII       EVERGREEN CLEMATIS       1200 O.C.         GREEN ROOF         ST       2450       SEDUM ACRE       8" O.C.         6b       850       SEDUM SPECTABILE 'BRILLIANT'       10" O.C.	Rs	36	RIBES SANGUINEUM	FLOWERING CURRANT	#3 POT	600mm O.C.
TO 43 THUJA OCCIDENTALIS SMARAGD EMERALD GREEN CEDAR 2.5M HEIGHT 500mm O.C.    SGRASS / PERENNIALS	Tm	100	TAXUS MEDIA HICKSII, MAL	HICKS YEW	#5 POTS	380mm O.C., MALE
GRASS / PERENNIALS  ir 26 SMILACINA RACEMOSA FALSE SOLOMON'S SEAL #2 POTS 450mm O.C.  CLIMBERS  ia 46 CLEMATIS ARMANDII EVERGREEN CLEMATIS 1200 O.C.  GREEN ROOF  ia 2450 SEDUM ACRE 8" O.C.  ib 850 SEDUM SPECTABILE 'BRILLIANT' 10" O.C.	Tx	35	TAXUS MEDIA HICKSII, MAL	HICKS YEW	42" HT., FIELD GROWN, FUL	L, 500mm O.C., MALE
FALSE SOLOMON'S SEAL #2 POTS   450mm O.C.	То	43	THUJA OCCIDENTALIS SMARAGD	EMERALD GREEN CEDAR	2.5M HEIGHT	500mm O.C.
CLIMBERS       2a     46     CLEMATIS ARMANDII     EVERGREEN CLEMATIS     I 200 O.C.       GREEN ROOF       2a     2450     SEDUM ACRE     8" O.C.       3b     850     SEDUM SPECTABILE 'BRILLIANT'     10" O.C.	GRA:	SS / PEF	RENNIALS			
Ea         46         CLEMATIS ARMANDII         EVERGREEN CLEMATIS         I 200 O.C.           GREEN ROOF           1200 O.C.         8° O.C.           1200 O.C.         10° O.C.	sr	26	SMILACINA RACEMOSA	FALSE SOLOMON'S SEAL	#2 POTS	450mm O.C.
SPEEN ROOF	СЦМ	BERS				
32       2450 SEDUM ACRE       8" O.C.         35       850 SEDUM SPECTABILE 'BRILLIANT'       10" O.C.	ca	46	CLEMATIS ARMANDII	EVERGREEN CLEMATIS		1200 O.C.
850 SEDUM SPECTABILE 'BRILLIANT' 10" O.C.	GREE	N RO	OF			
	sa	2450	SEDUM ACRE			8" O.C.
f 2450 SEDUM FLORIFERUM 'WEINHENSTEPHANER GOLD' 8" O.C.	sb	850	SEDUM SPECTABILE 'BRILLIANT'			10" O.C.
	sf	2450	SEDUM FLORIFERUM 'WEINHENSTEPHANER	GOLD'		8" O.C.

### **PLANTING: GENERAL NOTES**

I. ALL PLANT MATERIAL SHALL CONFORM TO THE STANDARD SPECIFIED IN THE CURRENT EDITION OF THE CANADIAN LANDSCAPE STANDARD. THIS STANDARD IS PUBLISHED JOINTLY BY THE CANADIAN SOCIETY OF LANDSCAPE ARCHITECTS (CSLA) AND THE CANADIAN NURSERY LANDSCAPE ASSOCIATION (CNLA).

2. SEARCH AREA FOR ALL PLANT MATERIAL SHALL BE: PACIFIC NORTHWEST INCLUDING BRITISH COLUMBIA. WASHINGTON, AND OREGON.

3. PLANT MATERIAL SIZES SPECIFIED ARE THE MINIMUM ACCEPTABLE SIZES TO BE SUPPLIED TO THIS PROJECT. 4. ALL PLANT MATERIAL SHALL BE WELL-ESTABLISHED AND UNIFORM IN SHAPE AND SIZE. TREES SHALL BE IN GOOD HEALTH AND VIGOR WITH NO VISIBLE SIGNS OF DISEASE, INSECT PESTS, DAMAGE, OR OTHER

DISFIGUREMENTS.

5. ALL PLANT MATERIAL SHALL BE NURSERY GROWN UNLESS OTHERWISE NOTED. ONLY CERTIHED S.O.D.

NURSERY STOCK WILL BE ACCEPTED.

6. THE CONTRACTOR SHALL PROVIDE A GROWING MEDIUM ANALYSIS FOR REVIEW BY THE CONSULTANT - AS

PER SPECIFICATIONS - PRIOR TO THE START OF CONSTRUCTION, GROWING MEDIUM SUPPLIED TO THE SITE OR

INSTALLED ON SITE PRIOR TO CONSULTANT APPROVAL SHALL BE REJECTED AT NO COST TO THE OWNER.

7. THE CONTRACTOR SHALL CONFIRM PLANT QUANTITIES ON THE DRAWINGS CORRESPOND TO THOSE

NUMBER OF CONTRACTOR SHALL CONFIRM PLANT QUANTITIES ON THE DRAWINGS CORRESPOND TO THOSE INDICATED ON THE PLANT LIST. ANY DISCREPANCIES ARE TO BE VERIFIED BY THE CONSULTANT FOR REVIEW AND RESPONSE.

AND RESPONSE.

8. PLANT LIST TO BE READ IN CONJUCTION WITH SPECIFICATIONS FOR COMPLIANCE.

9. PRIOR TO THE START OF CONSTRUCTION, THE CONTRACTOR SHALL CONFIRM THE AVAILABILITY OF THE PLANT MATERIAL SPECIFIED AS PER SPECIFICATIONS, ALLOWING FOR ANY AND ALL REQUIRED APPROVALS. PLANT SUBSTITUTIONS NOT CONFIRMED AND A PROVADE BY THE CONSULTANT WILL BE REJECTED.

10. PROVIDE IRRIGATION TO ALL PLANT MATERIAL AS SHOWN ON LANDSCAPE DRAWINGS AND PLANS. PLANTING BENEATH PATIOS AND VERHANGS SHALL BE IRRIGATED ON SEPARATELY VALVED IRRIGATION SYSTEM, THROUGH HEATED GARAGE, WHICH CAN OPERATE DURING WINTER MONTHS.

11. IRRIGATION MUST MEET THE STANDARDS FOR IRRIGATION INSTALLATION SET OUT IN THE CITY OF MICHOLOGY.

VICTORIA SUPPLEMENTARY SPECIFICATIONS FOR STREET TREES AND IRRIGATION, SCHEDULE C, TO VICTORIA

SUBDIVISION AND DEVELOPMENT SERVICING BYLAW

SUBDIVISION AND DEVELOPMENT SERVICING BYLAW.

12. THE PARKS DIVISION MUST INSPECT THE IRRIGATION SYSTEM PRIOR TO BACKFILLING AND AGAIN WHEN THE SYSTEM IS FUNCTIONING.

13. PUBLIC REALM IMPROVEMENTS, INCLUDING STREET TREES, STREET-SIDE ORNAMENTAL GRASSES, SOD, AND PLAZA PLANTING ARE TO BE IRRIGATED BY AN AUTOMATIC IRRIGATION SYSTEM, FROM A DESIGNATED CITY WATER SOURCE. AN IRRIGATION SYSTEM WITH A SEPARATE WATER SERVICE AND DOUBLE CHECK VALVE, FOR TREE WATERING RINGS ONLY, SHALL BE ADDED FOR THE PROPOSED BOULEVARD TREES ALONG BELLEVILLE ST.

14. AN "AS BUILT" PLAN MUST BE SUBMITTED TO THE PARKS DIVISION AFTER INSTALLATION.

15. SIDEWALK AT STREET TREES TO INCLUDE CONTINUOUS STRUCTURAL SOIL TRENCH, FROM BACK OF CURB TO FACE OF BUILDING / PARKING STRUCTURE. TO MIN, 700mm DEPTH.

16. TREES TO BE PROCURED AND PLANTED BY APPLICANT.

16. TREES TO BE PROCURED AND PLANTED BY APPLICANT.
17. TREES INDEPTIFIED AS 'REPLACEMENT TREES' AS PER CITY OF VICTORIA TREE PROTECTION BYLAW SHALL
MEET CITY OF VICTORIA TREE REPLACEMENT GUIDELINES, INCLUDING:

SHALL BE IN GOOD HEALTH AND VIGOUR WITH NO VISIBLE SIGNS OF DISEASE, INSECT PESTS, DAMAGE, OR OTHER DISFIGUREMENTS, AND SHALL COMPLY WITH THE LATEST VERSION OF THE 'CANADIAN LANDSCAPE STANDARDS' PUBLISHED BY THE CANADIAN SOCIETY OF LANDSCAPE ARCHITECTS AND CANADIAN NUSERY LANDSCAPE ASSOCIATION.

### STREET TREE INSPECTION NOTES:

THE PROPOSED BOULEVARD TREES MUST COMPLY TO CITY OF VICTORIA SUPPLEMENTARY SPECIFICATIONS FOR STREET TREES AND IRRIGATION SCHEDULE C, BYLAW 12-042, SUBDMISION BYLAW AND THE CURRENT VERSION OF THE CANADIAN LANDSCAPE STANDARD. PLANTING DETAILS CAN BE FOUND IN SCHEDULE B3-4. THE FOLLOWING TREE INSPECTIONS BY PARKS STAFF ARE REQUIRED BY SCHEDULE C. TO SCHEDULE AN INSPECTION PLEASE CONTACT ROB HUGHES, rhughes@victoria.ca AND ALSO COPY treepermits@victoria.ca 48 HOURS PRIOR TO THE REQUIRED INSPECTION TIME.

TREE PLANTING INSPECTIONS:

EXCAVATED TREE PITS, SOIL CELLS, ROOT BARRIERS

TREES PRIOR TO PLANTING. (PARKS STAFF CAN INSPECT TREES PRIOR TO SHIPPING AT LOCAL NURSERIES. PHOTOS CAN BE PROVIDED FROM UP-ISLAND AND MAINLAND NURSERIES. TREE MUST MEET THE SPEC UPON DELIVERY.)

COMPLETED PLANTING - TREE PLANTING, GRATE/GUARD, STAKES, ETC.

### IRRIGATION INSPECTION NOTES:

IRRIGATION SYSTEMS ON CITY PROPERTY SHALL COMPLY TO CITY OF VICTORIA SUPPLEMENTARY SPECIFICATIONS FOR STREET TREES AND IRRIGATION SCHEDULE C, BYLAW 12-042, SUBDIVISION BYLAW. IRRIGATION DRAWINGS MUST BE SUBMITTED TO PARKS DIVISION FOR REVIEW AND APPROVAL 30 DAYS PRIOR TO INSTALLATION WORK. THE FOLLOWING IRRIGATION AND SLEEVING INSPECTIONS BY PARKS STAFF ARE REQUIRED BY SCHEDULE C. TO SCHEDULE AN INSPECTION PLEASE CONTACT CHUCK BASS, CASS@\( \)CASS@\( \)COS COPY Treepermits@\( \)KOTALA AND KYLE MCMORRAN \( \)kmcmorran@\( \)victoria.ca AND KYLE MCMORRAN \( \)kmcmorran@\( \)victoria.ca AND THE REQUIRED INSPECTION TIME.

### IRRIGATION INSPECTION REQUIREMENTS:

- THE IRRIGATION SYSTEM AND SLEEVING INSPECTION REQUIREMENTS CAN BE FOUND IN

- THE IRRIGATION SYSTEM AND SLEEVING INSPECTION REQUIREMENTS CAN BE FOUND IN SCHEDULE C OF THE WICTORIA SUBDIVISION AND DEVELOPMENT SERVICING BYLAW NO. 12-042. IRRIGATION SLEEVING PRIOR TO BACKFILLING OPEN TRENCH MAIN LINE AND PRESSURE TEST OPEN TRENCH LATERAL LINE IRRIGATION SYSTEM, CONTROLLER, COVERAGE TEST, BACKFLOW PREVENTER ASSEMBLY TEST REPORT REQUIRED, BACKFLOW ASSEMBLY IS TO HAVE AN INSPECTION TAG COMPLETE AND ATTACHED.
- PLEASE NOTE: PARKS IS NOW REQUESTING THAT 100mm SDR 28 PIPE BE USED FOR IRRIGATION SLEEVING UNDER HARD SURFACES. INSTALLATIONS WHERE A 90-DEGREE BEND IS REQUIRED SHOULD BE INSTALLED USING 100mm SDR 28 GSX (22.5 DEGREE) LONG SWEEPS. PLEASE INSTALL AT

257 BELLEVILLE STREET

> VICTORIA. BRITISH COLUMBIA.

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	Revised Development Permit	Apr 29/11
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	Re-issued for Development Permit-	lune 03/21
	For Coordination	July 30/21
	Re-issued for Development Permit	Dec 06/21
	Re-issued for Development Permit	Jul 10/23

consultar





CALGARY EDMONTO www.mtalink.com 301, 215 - 10th Ave 5V

p 403.264.8700 f 403.264.8029

marshall tittemore architects Creating memorable place

PLANTING PLAN

**GROUND FLOOR** 

checked

1:200





VICTORIA, BRITISH COLUMBIA.

PFS STUDIO 1777 West 3th August 1912 Various of 18C V6 504.736.5388 of 186 (64.5)6.538

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PLANTING PLAN -ROOF LEVELS

1:200

ACER RUBRUM 'BOWHALL' BOWHALL UPRIGHT RED MAPLE

ACER RUBRUM 'RED SUNSET' RED SUNSET RED MAPLE

STYRAX JAPONICA -JAPANESE SNOWBALL


TAXUS MEDIA 'HICKSII' -HICK'S YEW

BUXUS JAPONICUM -

'GREEN BEAUTY' BOXWOOD

STIPA TENNUISIMA -MEXICAN FEATHER GRASS


SHRUBS / GROUNDCOVERS

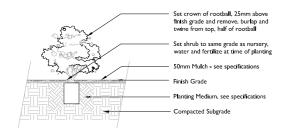


### SHRUB PLANTING ON GRADE

L3.1 SCALE: 1:25

SIM L3.2

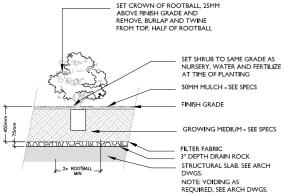

### SHRUB PLANTING ON SLAB L3.I SCALE: 1:25

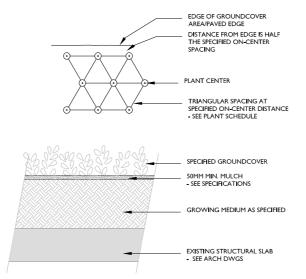


### GROUNDCOVER ON SLAB L3.I SCALE: I:20

PREPARATION NOTES:

- CONTAINER GROWN:
   REMOVE COMPLETELY FROM CONTAINER
- 2. BURLAP AND ROPE: REMOVE TOP 1/3 OF COVERING

3. WIRE AND BURLAP:


REMOVE TOP ½ OF WIRE, ROPE AND
BURLAP COVERING WITHOUT
DAMAGING ROOTBALL. REMOVE ALL
TWINE.

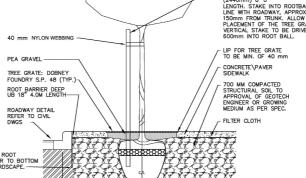


ALL TREES SHALL MEET OR EXCEED THE CITY OF VICTORIA TREE SPECIFICATIONS

## CITY OF VICTORIA TREE PLANTING IN BOULEVARD DETAIL SD P5


COMPACTED SUBGRAD TO 98% S.P.D.

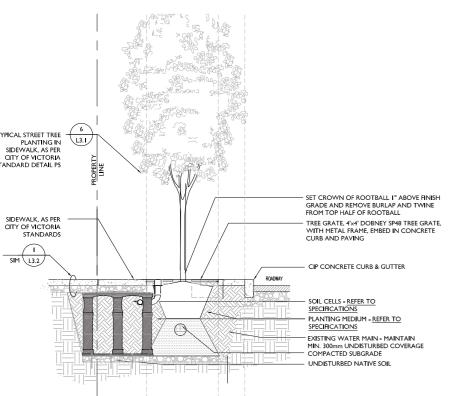

TYPICAL STREET TREE PLANTING W/ TREE GRATE AND STRUCTURAL SOIL L3.I SCALE: I:25

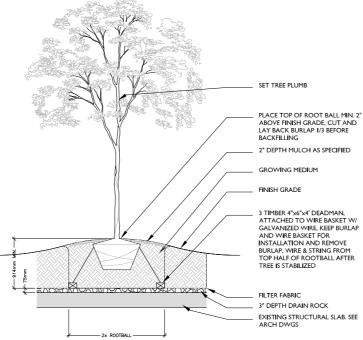

### DECIDUOUS TREE PLANTING ON SLAB L3.1 SCALE: 1:25

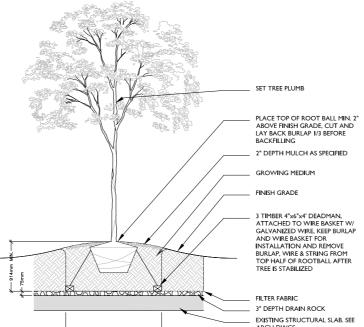

RUDBECKIA 'GOLDSTURM' -















257 BELLEVILLE STREET

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**WPFS** STUDIO WARCOVER BC VI GOLFA Schools



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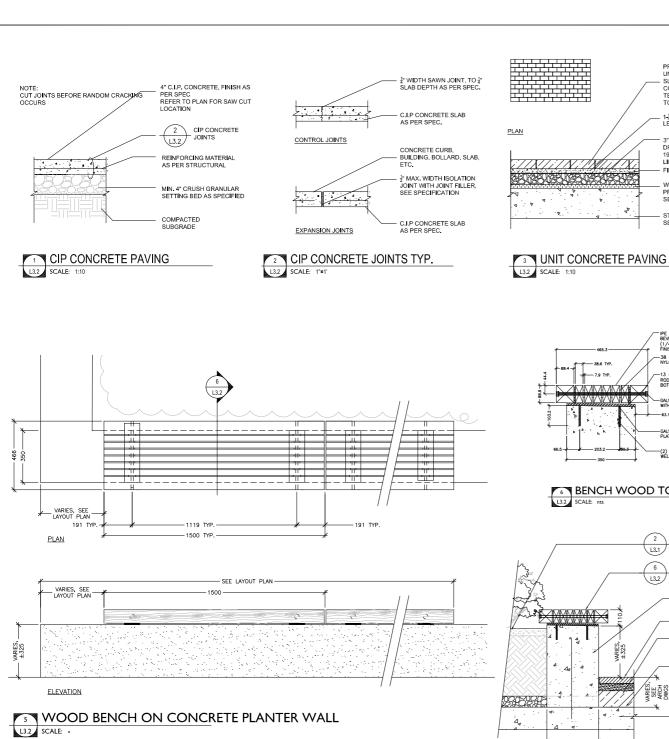
marshall tittemore architects

drawing title

PLANTING DETAILS


L3.1

AS NOTED checked 08005



**7 WOOD SCREEN** 

L3.2 SCALE: -

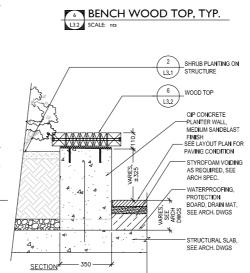


TOGETHER, SEPARATED WITH 1/4" STEEL PLATES MOUNTED ON STEEL I-BEAM POSTS (MATCH ARCH. DETAIL 32C, A860)


STEEL ROD BOLTED TO WELDED BRACKET


— SIEEL ROD WITH BLACK POWDERCOATED TUBULAR SPACERS (THROUGH HOLE DRILLED IN IPE BEAMS); BOLTED AT END FOR COMPRESSION, PANNEL SECURED BY STEEL TUBE MOUNTED IN FOOTING

BOLT FITS WITHIN STEEL PLATE ON TUBE

- IPE 2X4 BEAMS

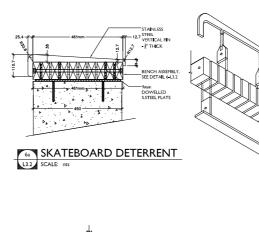

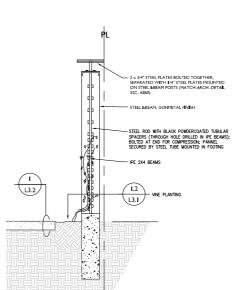

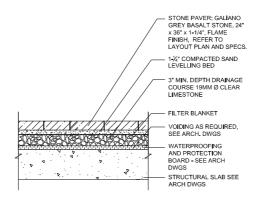

PRECAST CONCRETE UNIT HYDROPRESSED SLAB PAVERS.

COLOUR: CHARCOAL, TEXADA FINISH REFER TO LAYOUT PLAN

DRAINAGE COURSE 19MM Ø CLEAR LIMESTONE

WATERPROOFING AND PROTECTION BOARD -SEE ARCH DWGS


STRUCTURAL SLAB SEE ARCH DWGS

-38 (1-1/2") x 9 (1/3") THICK NYLON SPACER

GALV. STEEL PLATE WITH UPSTAND PLATES, AS DETAILED

(2) 4 x 1/2" DIA. REIN. RODS, WELDED TO PLATE AS DIM.

FILTER BLANKET

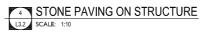

UPSTAND PLATE






BIKE RACK - EXAMPLE



BOLLARD LIGHT - EXAMPLE

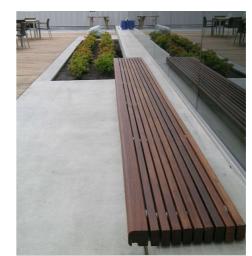

WOOD TOP BENCH - EXAMPLE



WOOD SCREEN - EXAMPLE

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marshall tittemore architects

drawing title


LANDSCAPE SECTIONS and DETAILS

checked 08005


L3.2




# SECTION KEY

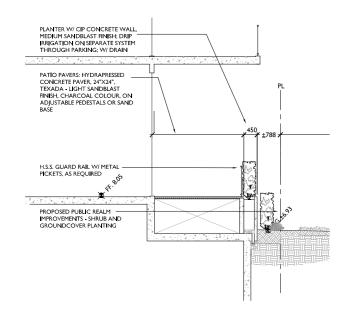

SECTION 2 - AT PUBLIC R.O.W., NORTH-WEST
33 SCALE: 1:50

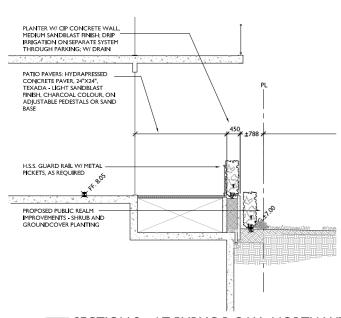

3 SECTION 3 - AT PUBLIC R.O.W., NORTH-WEST 3.3 SCALE: 1:50

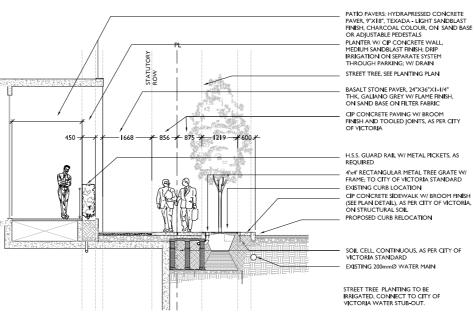

SECTION I - AT PENDRAY STREET - STREET TREE & GRATE
3.3 SCALE: 1:50

TREE GRATE TO CITY OF VICTORIA SPECIFICATIONS,
BROWN HINSH
SAW-CUT JOINT SCORING, TYP.

PLAN DETAIL- PENDRAY STREET SIDEWALK PAVING
3.3 SCALE: 1:50

PLAN DETAIL DELETED

PLAN DETAIL DELETED

PLAN DETAIL - PUBLIC R.O.W., NW (N.I.C.)



PRECEDENT: CENTENNIAL PARK - LOW WALL W/ STONE FACING

257 BELLEVILLE STREET VICTORIA, BRITISH COLUMBIA.



permit

consult

PFS STUDIO 1777 West 3" Autenu PC Kill PFS STUDIO 1777 West 3" Autenu PC Kill PFS STUDIO 1785 MS 1785

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LANDSCAPE SECTIONS and DETAILS

MD drawn 1:200 scale checked name project no.